


REV.	DESCRIPTION	DATE

DATE:	PROJECT NO:	DRAWN:	CHECKED:
07.21.15	3305V	CH	OF

DRAWING TITLE:  
ADA ACCESS  
PLAN


SHEET NO:  
L0.40

GENERAL PATH-OF-TRAVEL NOTES		ACCESSIBILITY & PATH-OF-TRAVEL LEGEND		CONTEXT MAP
NOTES		SYMBOL	DESCRIPTION	
1. SEE CIVIL GRADING PLANS C3.0 & C3.1 FOR MORE INFORMATION			4' WIDE ACCESSIBLE PATH OF TRAVEL	
2. PATH-OF-TRAVEL ACCESS ROUTE SHALL HAVE THE FOLLOWING CHARACTERISTICS: a. FIRM AND STABLE IN MATERIAL b. BARRIER FREE c. LESS THAN 1:20 MAXIMUM SLOPE WITHOUT RAMP d. LESS THAN 1:50 MAXIMUM CROSS SLOPE e. NO ABRUPT CHANGES IN LEVEL f. 48" MIN CLEAR IN WIDTH g. NON-SLIP SURFACE h. ACCESSIBLE PATH SHALL HAVE NO ABRUPT VERTICAL CHANGES EXCEEDING 1/2" AT 1:2 MAXIMUM SLOPE, EXCEPT THAT LEVEL CHANGES DO NOT EXCEED 1/4". i. CONTRACTOR TO VERIFY THAT ALL BARRIERS IN THE PATH OF TRAVEL HAVE BEEN REMOVED OR WILL BE REMOVED IN THIS PROJECT, & THAT PATH OF TRAVEL COMPLIES WITH CBC 1133B.			ADA COMPLIANT SITE ACCESS	
3. CONSTRUCT ALL PAVED AREAS TO DRAIN			ADA COMPLIANT SEATING	
			5'-0" DIA. TURNING RADIUS AT >2% CROSS SLOPE LANDING	

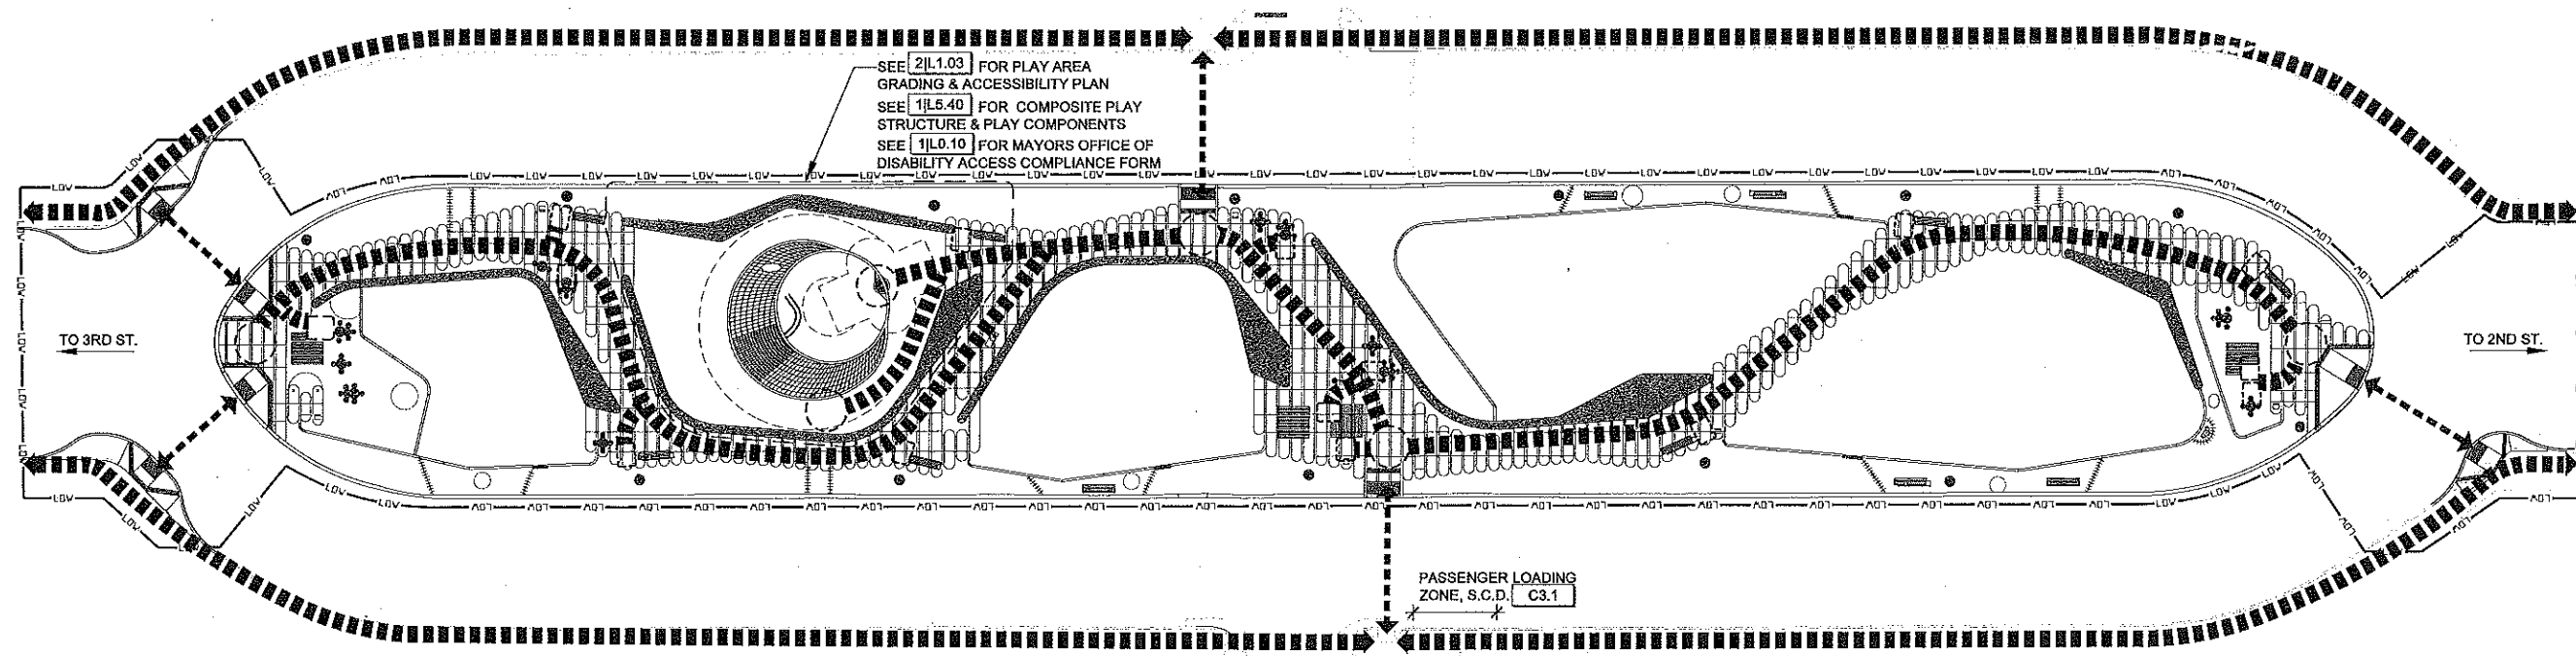

1 ADA ACCESS PLAN  
SEE L0.11 FOR LEGEND

Tuesday, July 7, 2015 8:52:07 PM

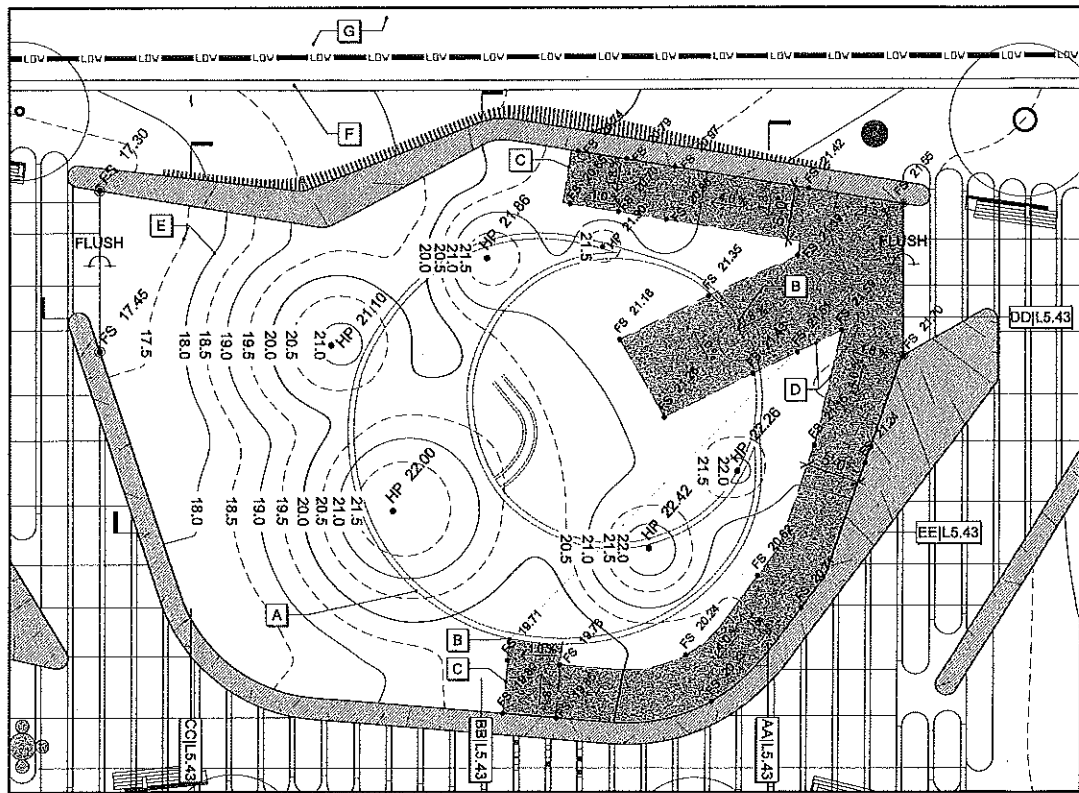


- A COMPOSITE PLAY STRUCTURE, SHOWN AS DASHED FOR CLARITY, SEE 1|L5.40 FOR MORE INFORMATION
- B ACCESSIBLE TRANSFER POINT AT PLAY STRUCTURE
- C GRADE BREAK, >2% CROSS SLOPE GRADING OF PLAY SURFACE
- D 5'-0" WIDE ADA ACCESSIBLE PATH-OF-TRAVEL WITHIN PLAY AREA, SHOWN AS HATCHED. SEE ADA ACCESS PLAN FOR ADA ACCESSIBLE PATH TO /FROM PLAY AREA
- E 6" CONTOURS, TYP
- F ADJACENT (E) CURB
- G ADJACENT (E) AC AT ROADWAY

NOTES:  
1. SEE LANDSCAPE GRADING PLAN L3.10

2 PLAY STRUCTURE ENLARGEMENT GRADING PLAN  
SEE L1.00 FOR ADDITIONAL LEGEND INFORMATION

1/8" = 1'-0"

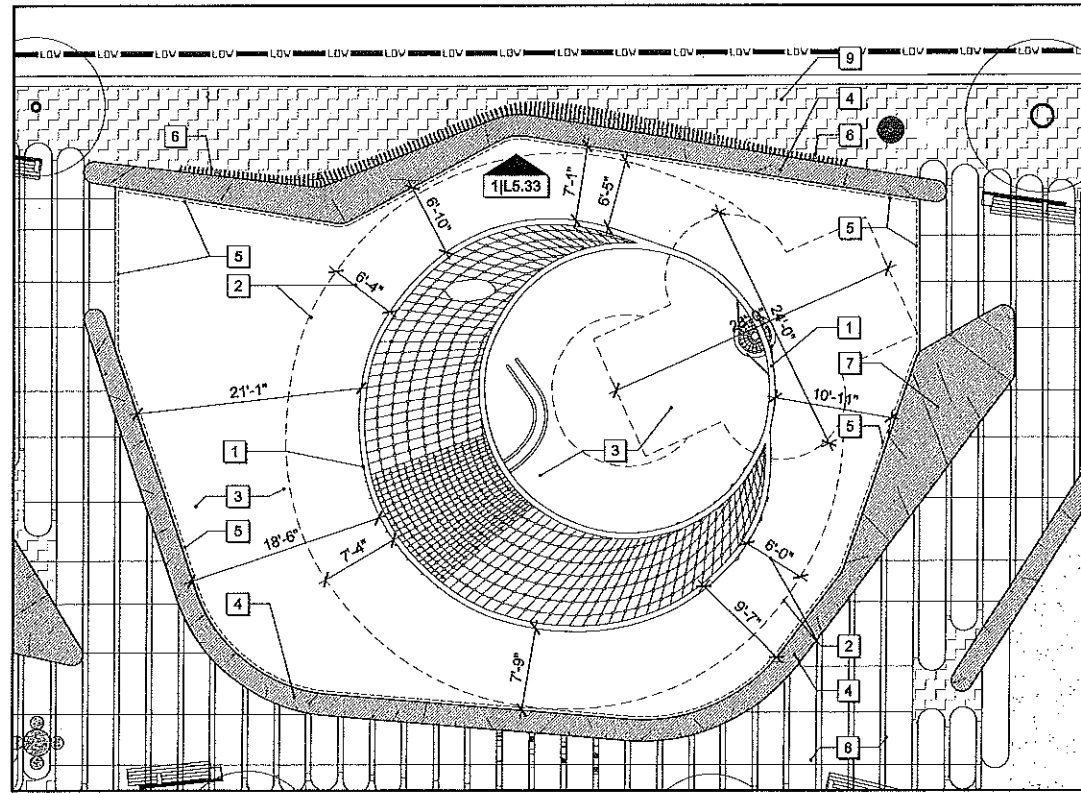

- 1 COMPOSITE PLAY STRUCTURE 1|L5.40
- 2 6' MIN PLAY STRUCTURE SAFETY USE ZONE
- 3 SYNTHETIC TURF 1|L5.42
- 4 CONCRETE PLANTER WALLS 1|L5.20
- 5 SYNTHETIC TURF NAILER BOARD SHOWN AS DASHED LINE AT SUBSURFACE CONCRETE LEDGE OF CONCRETE PLANTER WALLS & EDGE OF PAVING 2|L5.42 4|L5.42
- 6 WOOD BACKREST AT SEAT WALL 1|L5.34 & 1|L5.33
- 7 CONCRETE PLATFORM 2|L5.20
- 8 CONCRETE PAVING 1|L5.10
- 9 PLANTING AREA, SEE PLANTING PLANS L7.02

1 PLAY STRUCTURE ENLARGEMENT MATERIAL & LAYOUT PLAN

1/8" = 1'-0"

# SOUTH PARK

RENOVATION

SAN FRANCISCO, CA



FLETCHER STUDIO  
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Fletcher Studio  
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DATE: PROJECT NO: DRAWN: CHECKED:  
07.01.15 3396V GH DF

DRAWING TITLE:  
PLAY AREA  
MATERIAL,  
LAYOUT &  
GRADING PLAN

SHEET NO: L1.03


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1 WOOD BACKREST AT PLAY AREA


- 1 CONCRETE SEAT WALL 1|L5.20 SIM
- 2 BACK REST AT SEAT WALL 1|L5.34
- 3 ADJACENT FINISHED SURFACE
- 4 ADJACENT CONCRETE PAVING 1|L5.10
- 5 ADJACENT SYNTHETIC TURF 1|L5.42
- 6 ADJACENT PLANTING AREA, SEE PLANTING PLANS
- 7 TREE PLANTING, SEE PLANTING PLANS
- 8 (E) CURB 2|L4.10

NOTES:


- 1. CONTRACTOR TO REVIEW ALIGNMENT & LAYOUT OF BACKREST MEMBERS FOR REVIEW & APPROVAL BY LANDSCAPE ARCHITECT PRIOR TO FINAL INSTALLATION

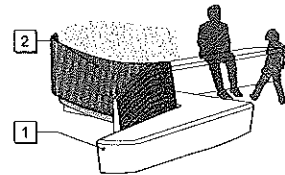

END ELEVATION A

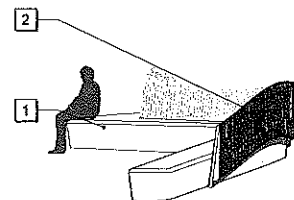

END ELEVATION B

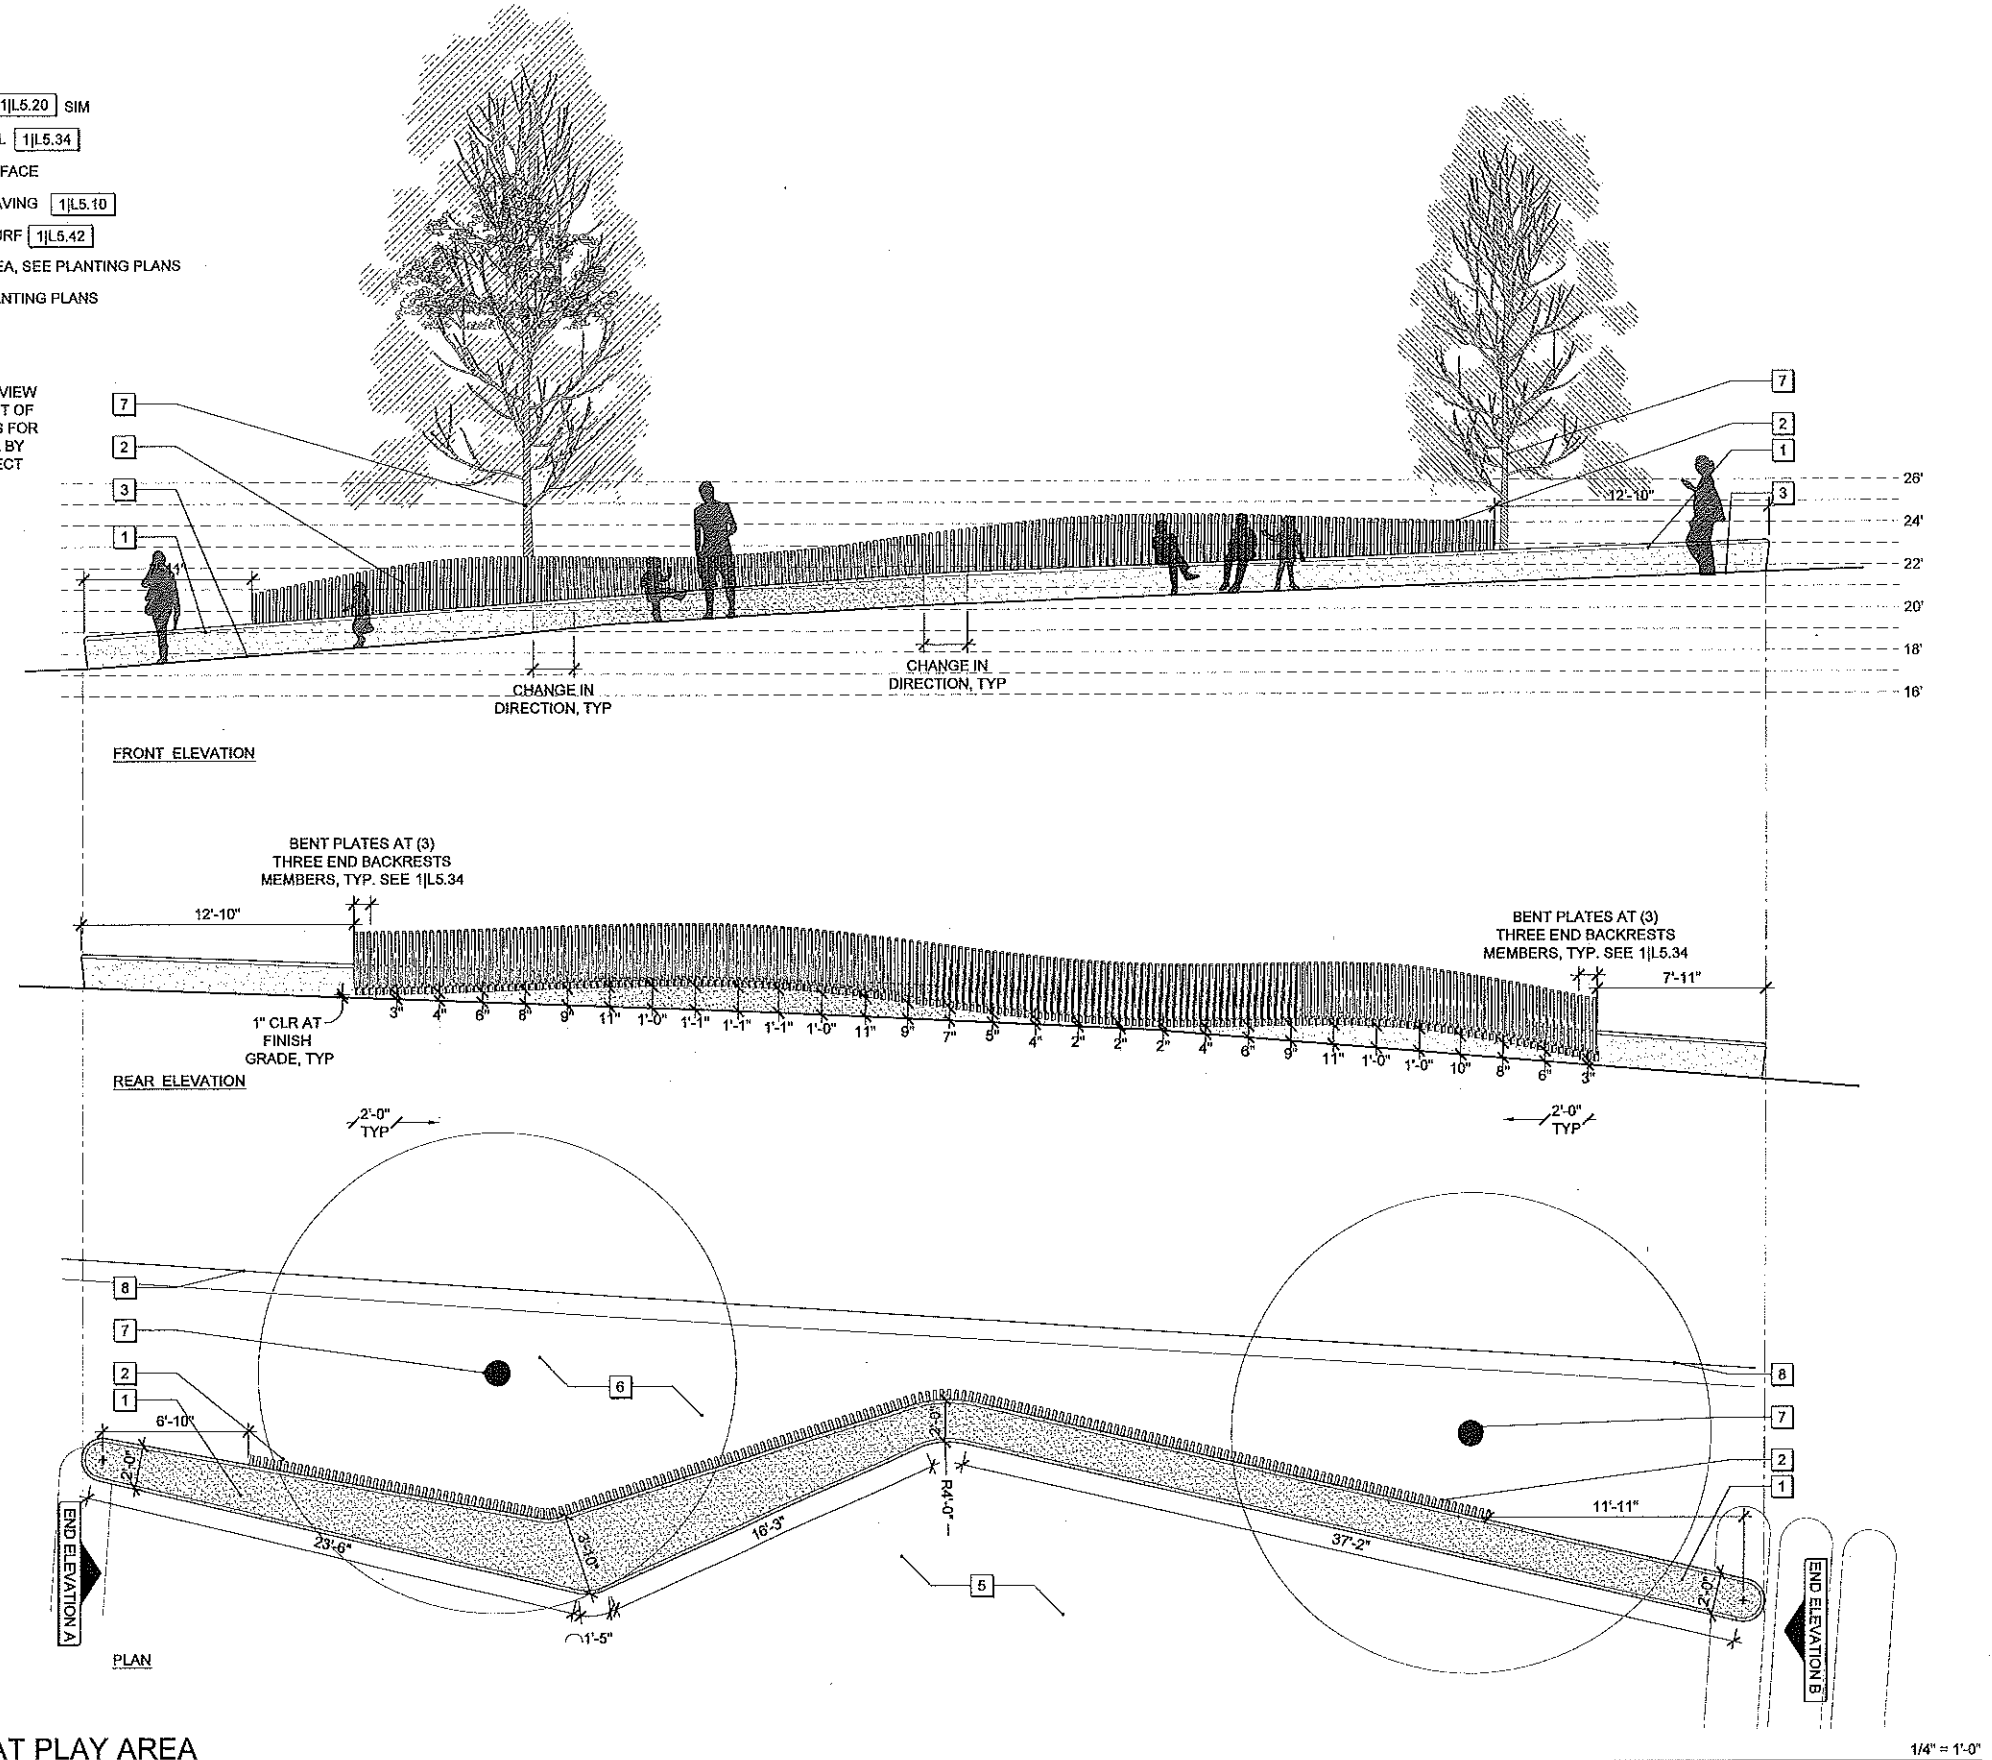

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DATE:	PROJECT NO.:	DRAWN:	CHECKED:
07.01.15	3200V	CH	DF


DRAWING TITLE:  
CONSTRUCTION  
DETAILS -  
WOOD  
BACKREST

SHEET NO:  
L5.33

Tuesday, July 7, 2015 8:57:20 PM

# 1 WOOD BACKREST

3" = 1'-0"

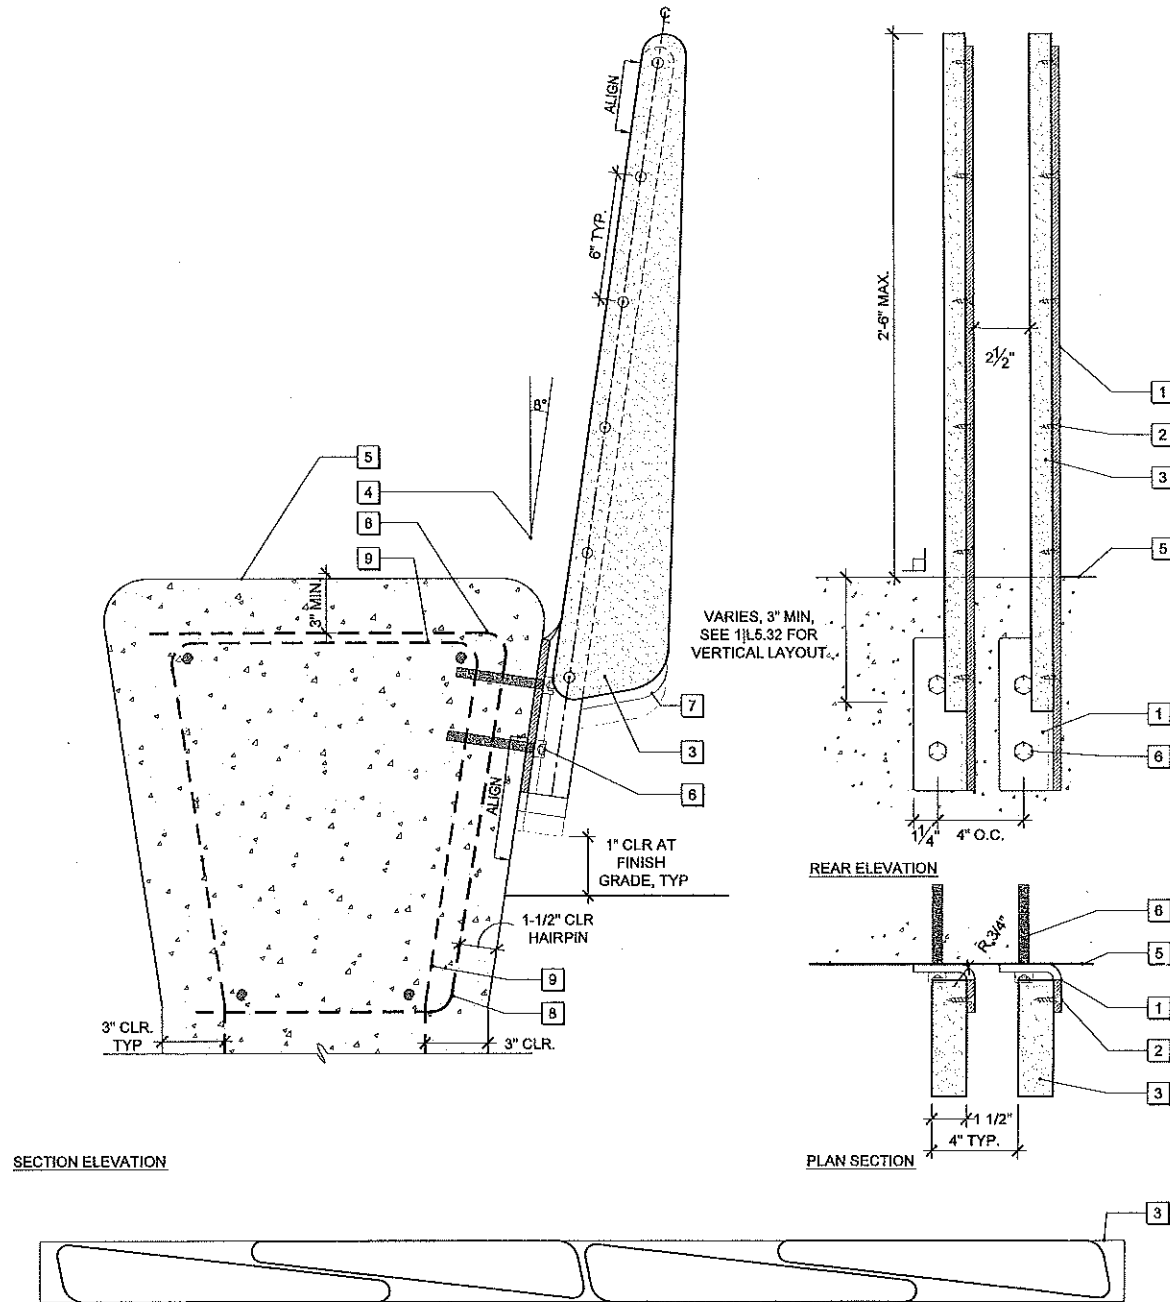

- 1 3/8" HOT-DIPPED GALV BENT PLATE, MIN STEEL YIELD STRENGTH TO BE Fy=60ksi, EASE ALL CORNERS & EDGES TO BE SMOOTH TO THE TOUCH, TYP
- 2 SS SELF-TAPPING HEX HEAD, TAMPER RESISTANT SCREW COUNTER-SUNK @ BENT PLATE
- 3 1"x6" THERMO-TREATED ASH
- 4 BACK ANGLE 8°, TO ALIGN WITH BACK OF SEAT WALL
- 5 CONCRETE SEATWALL 1JL5.20 SIM
- 6 (2) 1/2" DIA. GALV SIMPSON TITEN HD W/ 3-3/4" EMBEDMENT ANCHORS, TYP
- 7 BACK REST, BEYOND
- 8 #4 HAIRPINS AT 4" O.C. ALONG LENGTH OF BACKREST @ SEATWALL
- 9 #4 TIES AT 12" O.C., SEE 1JL5.20
- 10 PREDRILLED HOLES TO ACCOMMODATE 1/2" DIA. SIMPSON TITEN HD


- NOTES:
1. THERMO-TREATED ASH TO BE THERMORY DECKING, DECKING TO BE UN-GROOVED, CONTRACTOR TO CUT JOINT END MATCHING (T&G) FROM ENDS PRIOR TO CUTTING INDIVIDUAL BACKREST PIECES
  2. THERMO-TREATED ASH AVAILABLE FROM BERONIO LUMBER CO. 415.824.4300 OR WWW.BERONIO.COM
  3. CONTRACTOR TO SUBMIT SHOP DRAWINGS FOR REVIEW & APPROVAL BY LANDSCAPE ARCHITECT
  4. CONTRACTOR TO PROVIDE FULL SIZE MOCK OF BACKREST ASSEMBLY: BENT PLATE, WOOD BACKREST, ANCHORS & FASTENERS

BACK REST WOOD

ATTACHMENT AT BENT PLATE

BENT PLATE TYP.

BENT PLATE AT ENDS

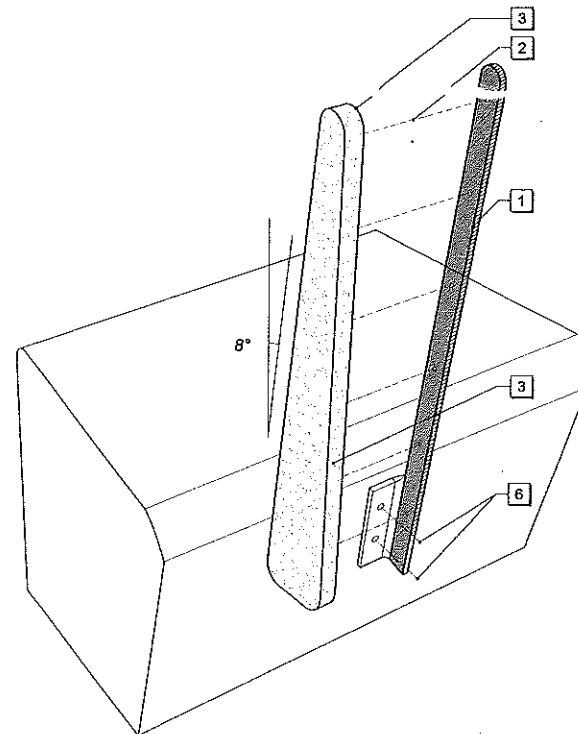


## SOUTH PARK

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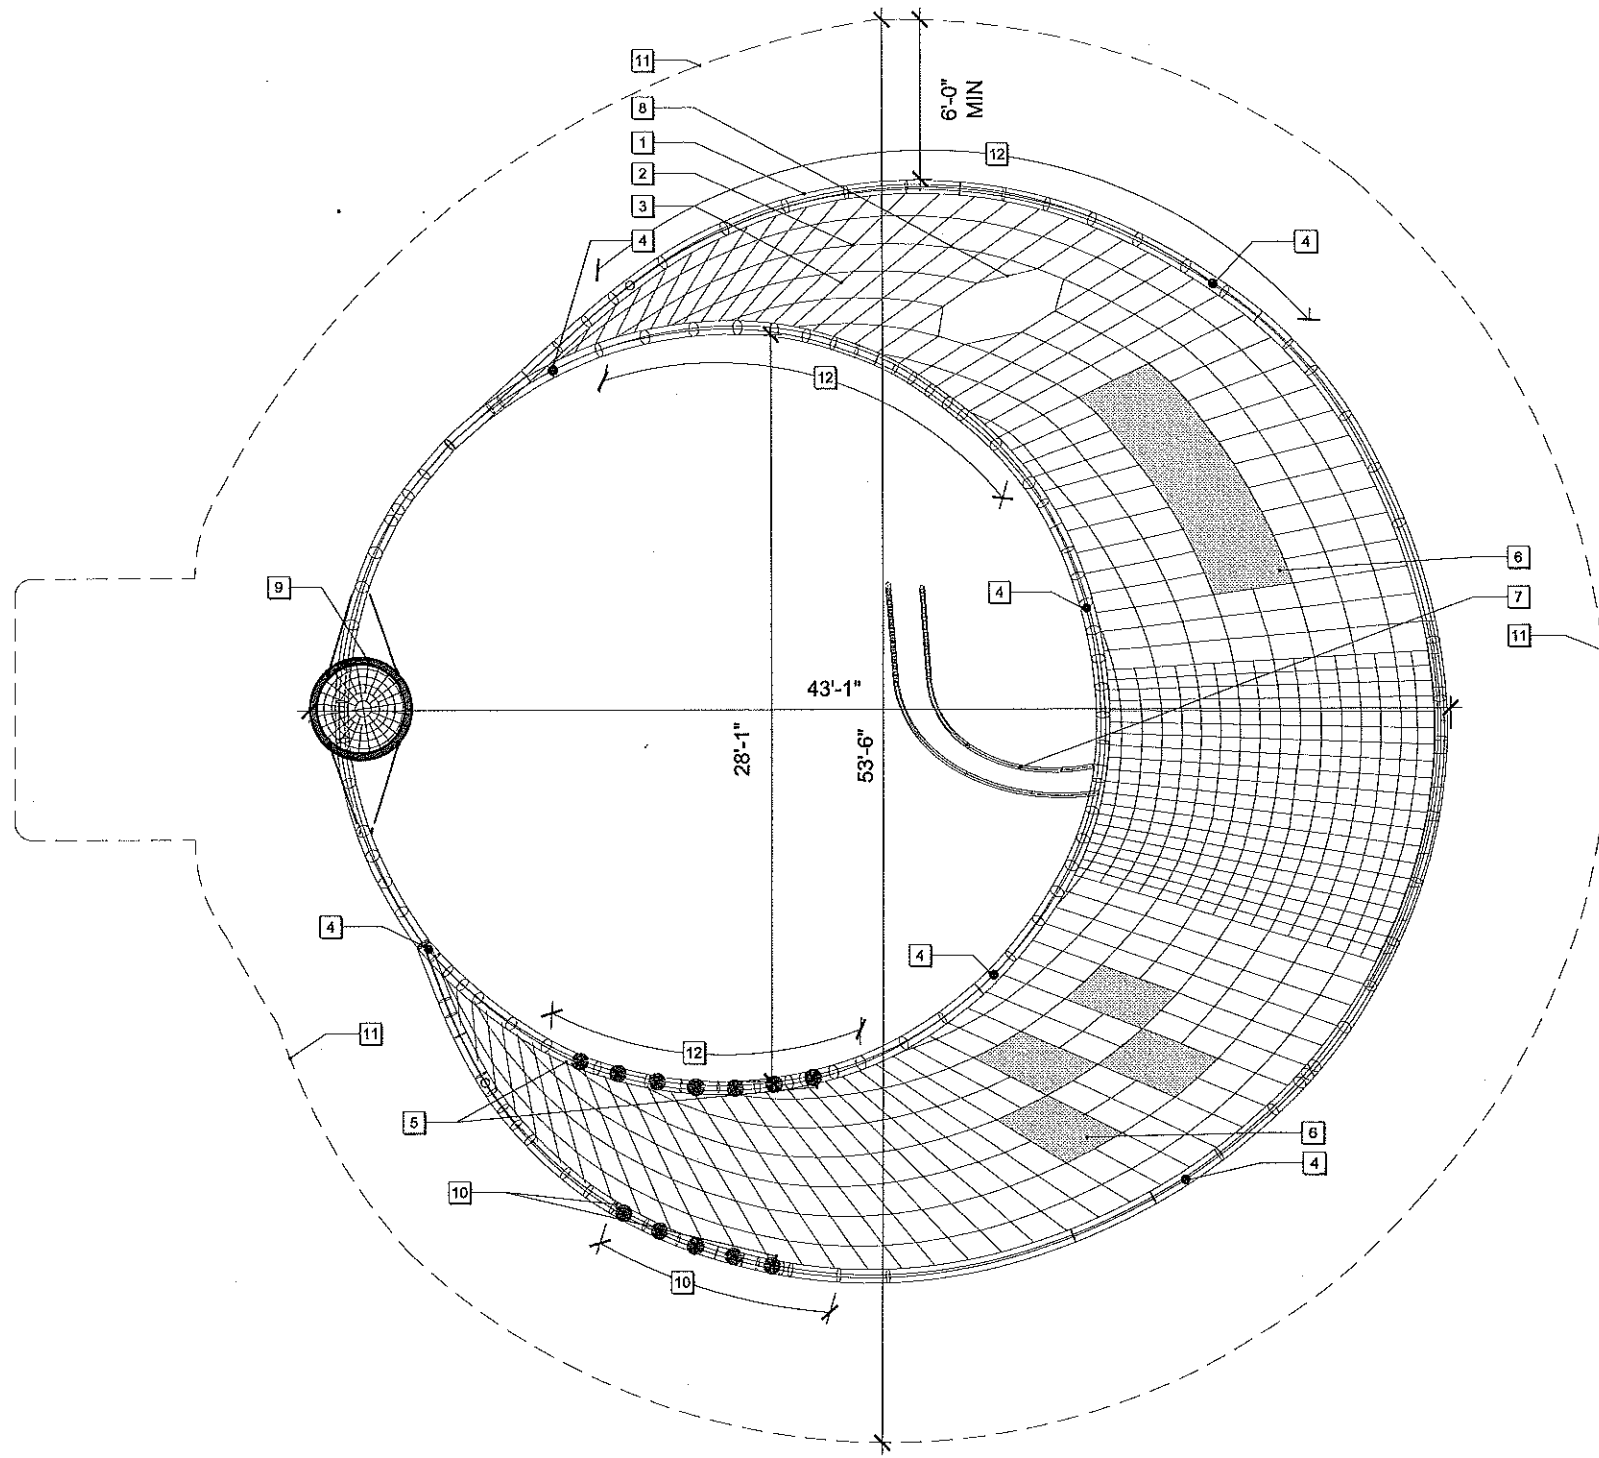
REV.	DESCRIPTION	DATE

DATE	PROJECT NO.	DRAWN	CHECKED
07.01.15	3206V	CH	DF

DRAWING TITLE:  
CONSTRUCTION  
DETAILS -  
WOOD  
BACKREST

SHEET NO.:  
L5.34

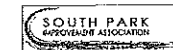
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- |  |                                    |
|--|------------------------------------|
| 1 7" DIA. GALV STRUCTURAL STEEL TUBING                     | 6 FLUBBER PAD 9[L5.41]             |
| 2 NET & HARDWARE CONNECTION 1[L5.41]                       | 7 BANISTER 4[L5.41]                |
| 3 CLIMBING NET: STEEL CABLE WITH POLYESTER FABRIC 1[L5.41] | 8 NET CAVE WITH LADDER 1[L5.41]    |
| 4 CONCRETE FOOTING, ALSO SEE NOTES 3[L5.42]                | 9 HAMMOCK SEAT 6[L5.41]            |
| 5 FLYING DISKS 8[L5.41]                                    | 10 HAND-OVER-HAND RINGS 7[L5.41]   |
|  | 11 PLAY STRUCTURE SAFETY USE ZONE  |
|  | 12 ABOVE-GRADE CONNECTION 5[L5.42] |

NOTES:  
1. SEE 1[L0.10] FOR MAYORS OFFICE OF DISABILITY COMPLIANCE FORM  
2. SEE PLAY ENLARGEMENT PLANS ON 1[L1.03] & 2[L1.03]  
3. PLAY STRUCTURE AVAILABLE FROM MIRACLE PLAY SYSTEMS, CALL 800.879.7730 OR DAVID@MIRACLEPLAYGROUP.COM  
4. CONTRACTOR TO SUBMIT SEISMIC ANCHORAGE & FOUNDATION DETAILS & STRUCTURAL CALCULATIONS STAMPED & SIGNED BY PROFESSIONAL CIVIL OR STRUCTURAL ENGINEER REGISTERED IN THE STATE OF CALIFORNIA FOR REVIEW & APPROVAL.

1 COMPOSITE PLAY STRUCTURE



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LICENSED LANDSCAPE ARCHITECT  
DAVID J. FLETCHER  
JULY 1998  
STATE OF CALIFORNIA

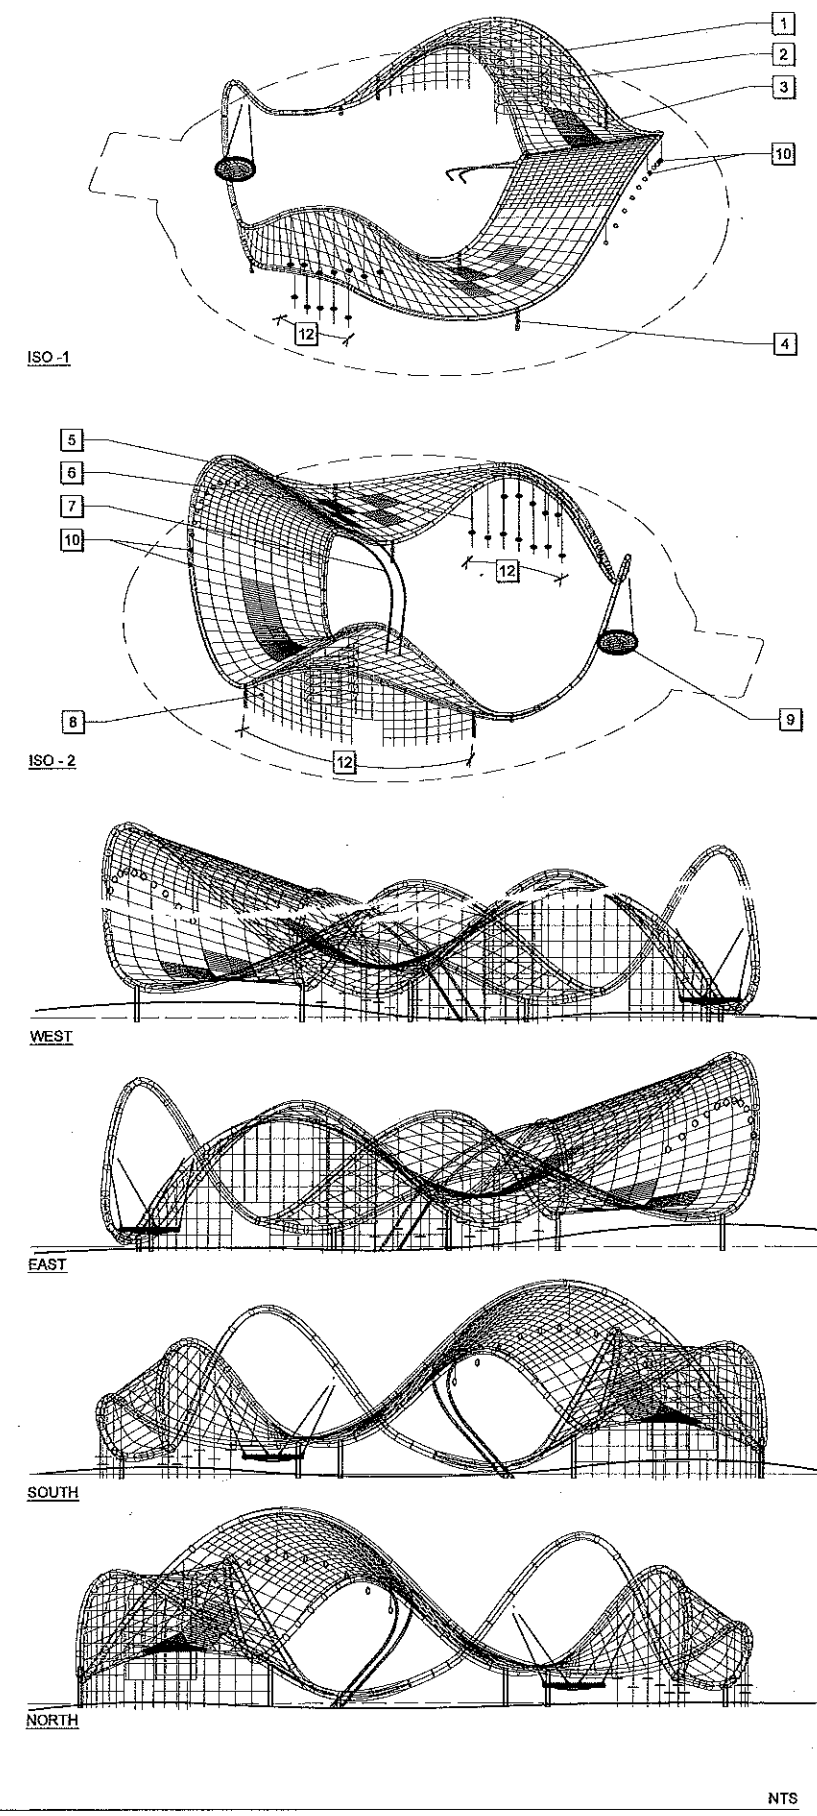BID SET CONSTRUCTION DOCUMENTS


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07.01.15	3006V	GH	DF


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**CONSTRUCTION  
DETAILS - PLAY  
AREA**

SHEET NO:  
**L5.40**


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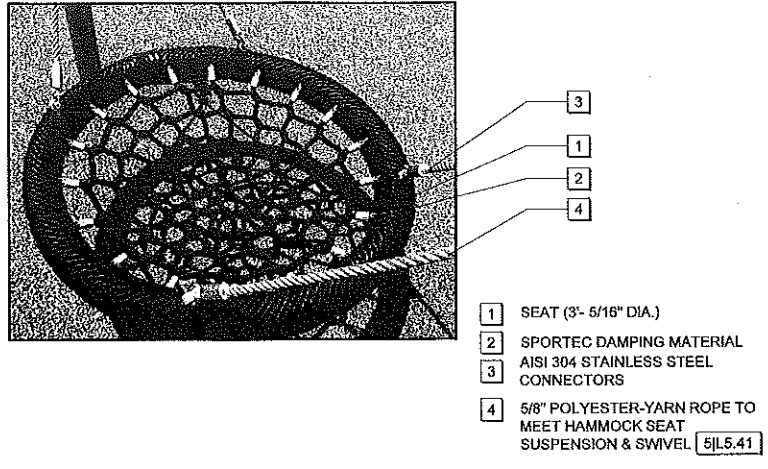
9 FLUBBER PAD 1" = 1'-0"

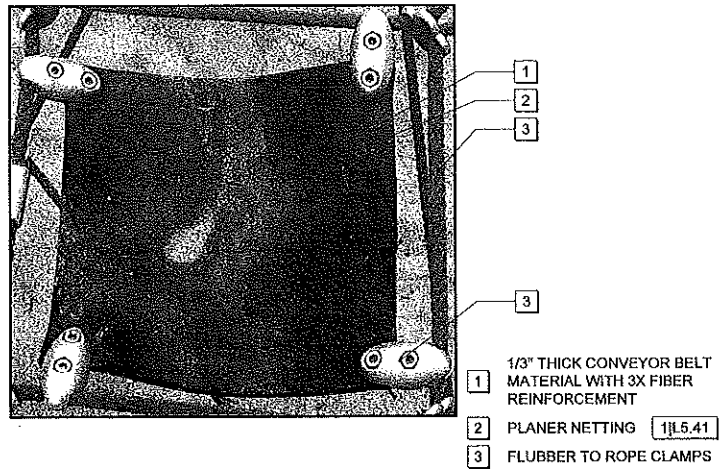


8 FLYING DISKS 1" = 1'-0"

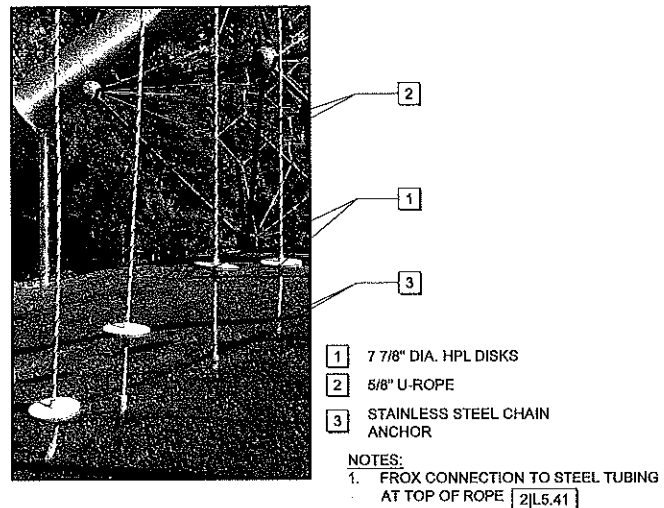


7 HAND-OVER-HAND RINGS 1" = 1'-0"

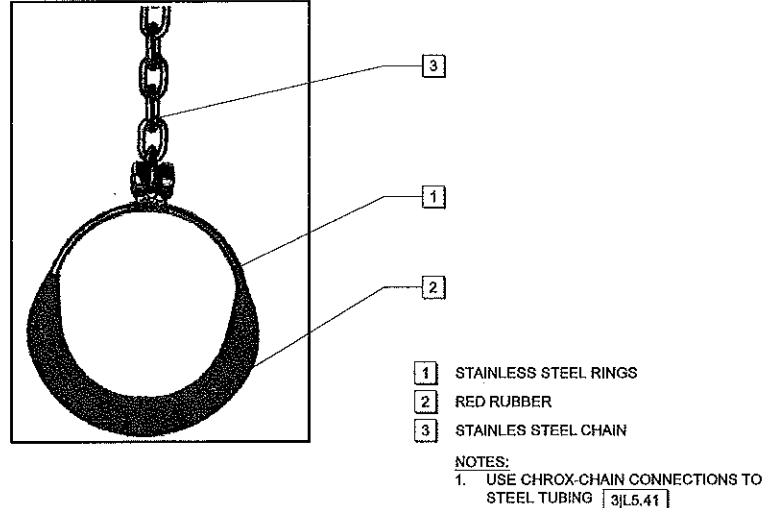


6 HAMMOCK SEAT 1" = 1'-0"

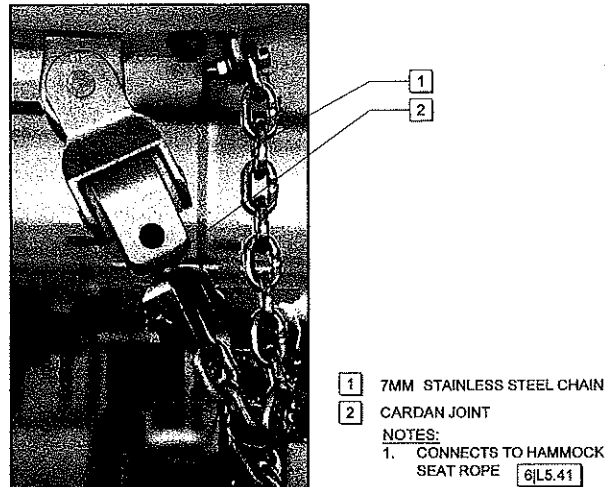


5 HAMMOCK SEAT SUSPENSION & SWIVEL 1" = 1'-0"

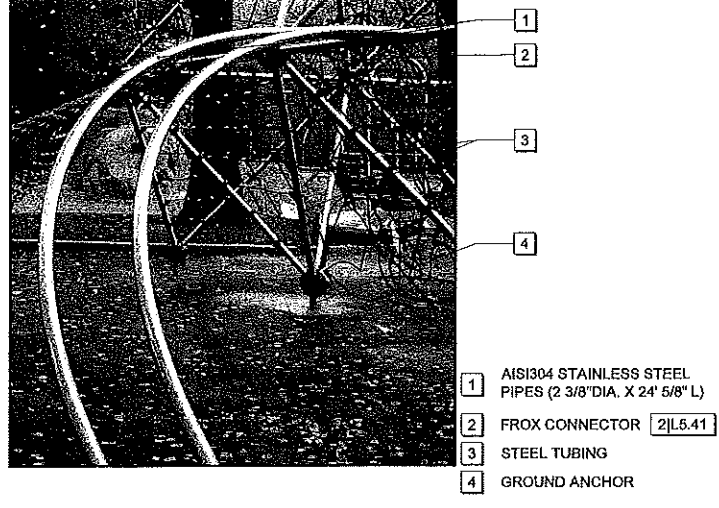


4 BANISTER 1" = 1'-0"

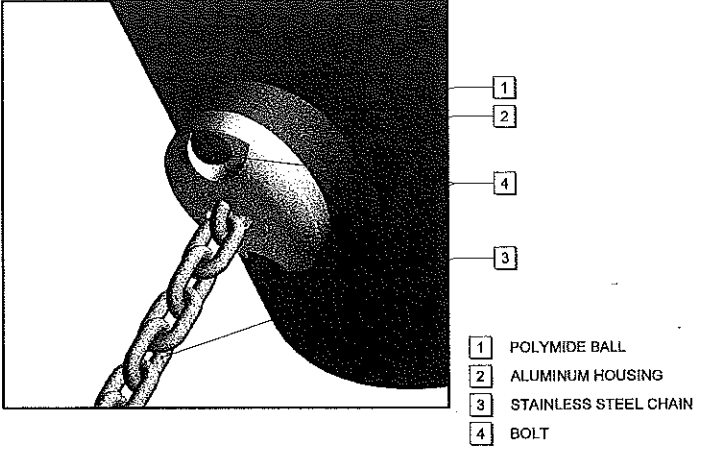

3 CHROX-TO-CHAIN CONNECTIONS 1" = 1'-0"

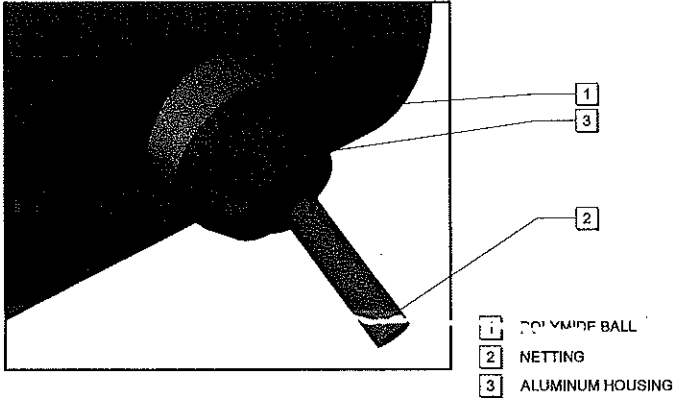

2 FROX-TO-TUBE CONNECTIONS 1" = 1'-0"

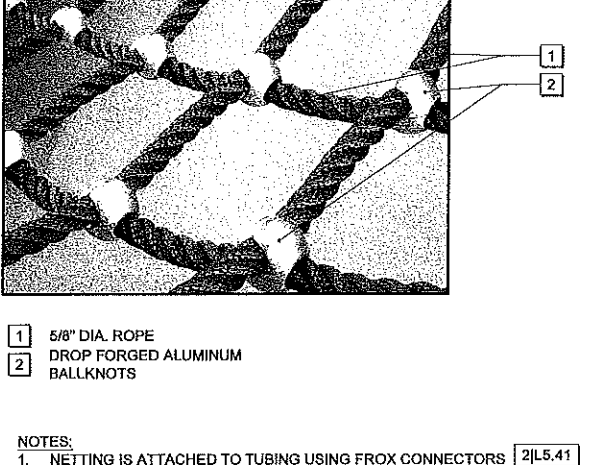

1 NET & HARDWARE 1" = 1'-0"

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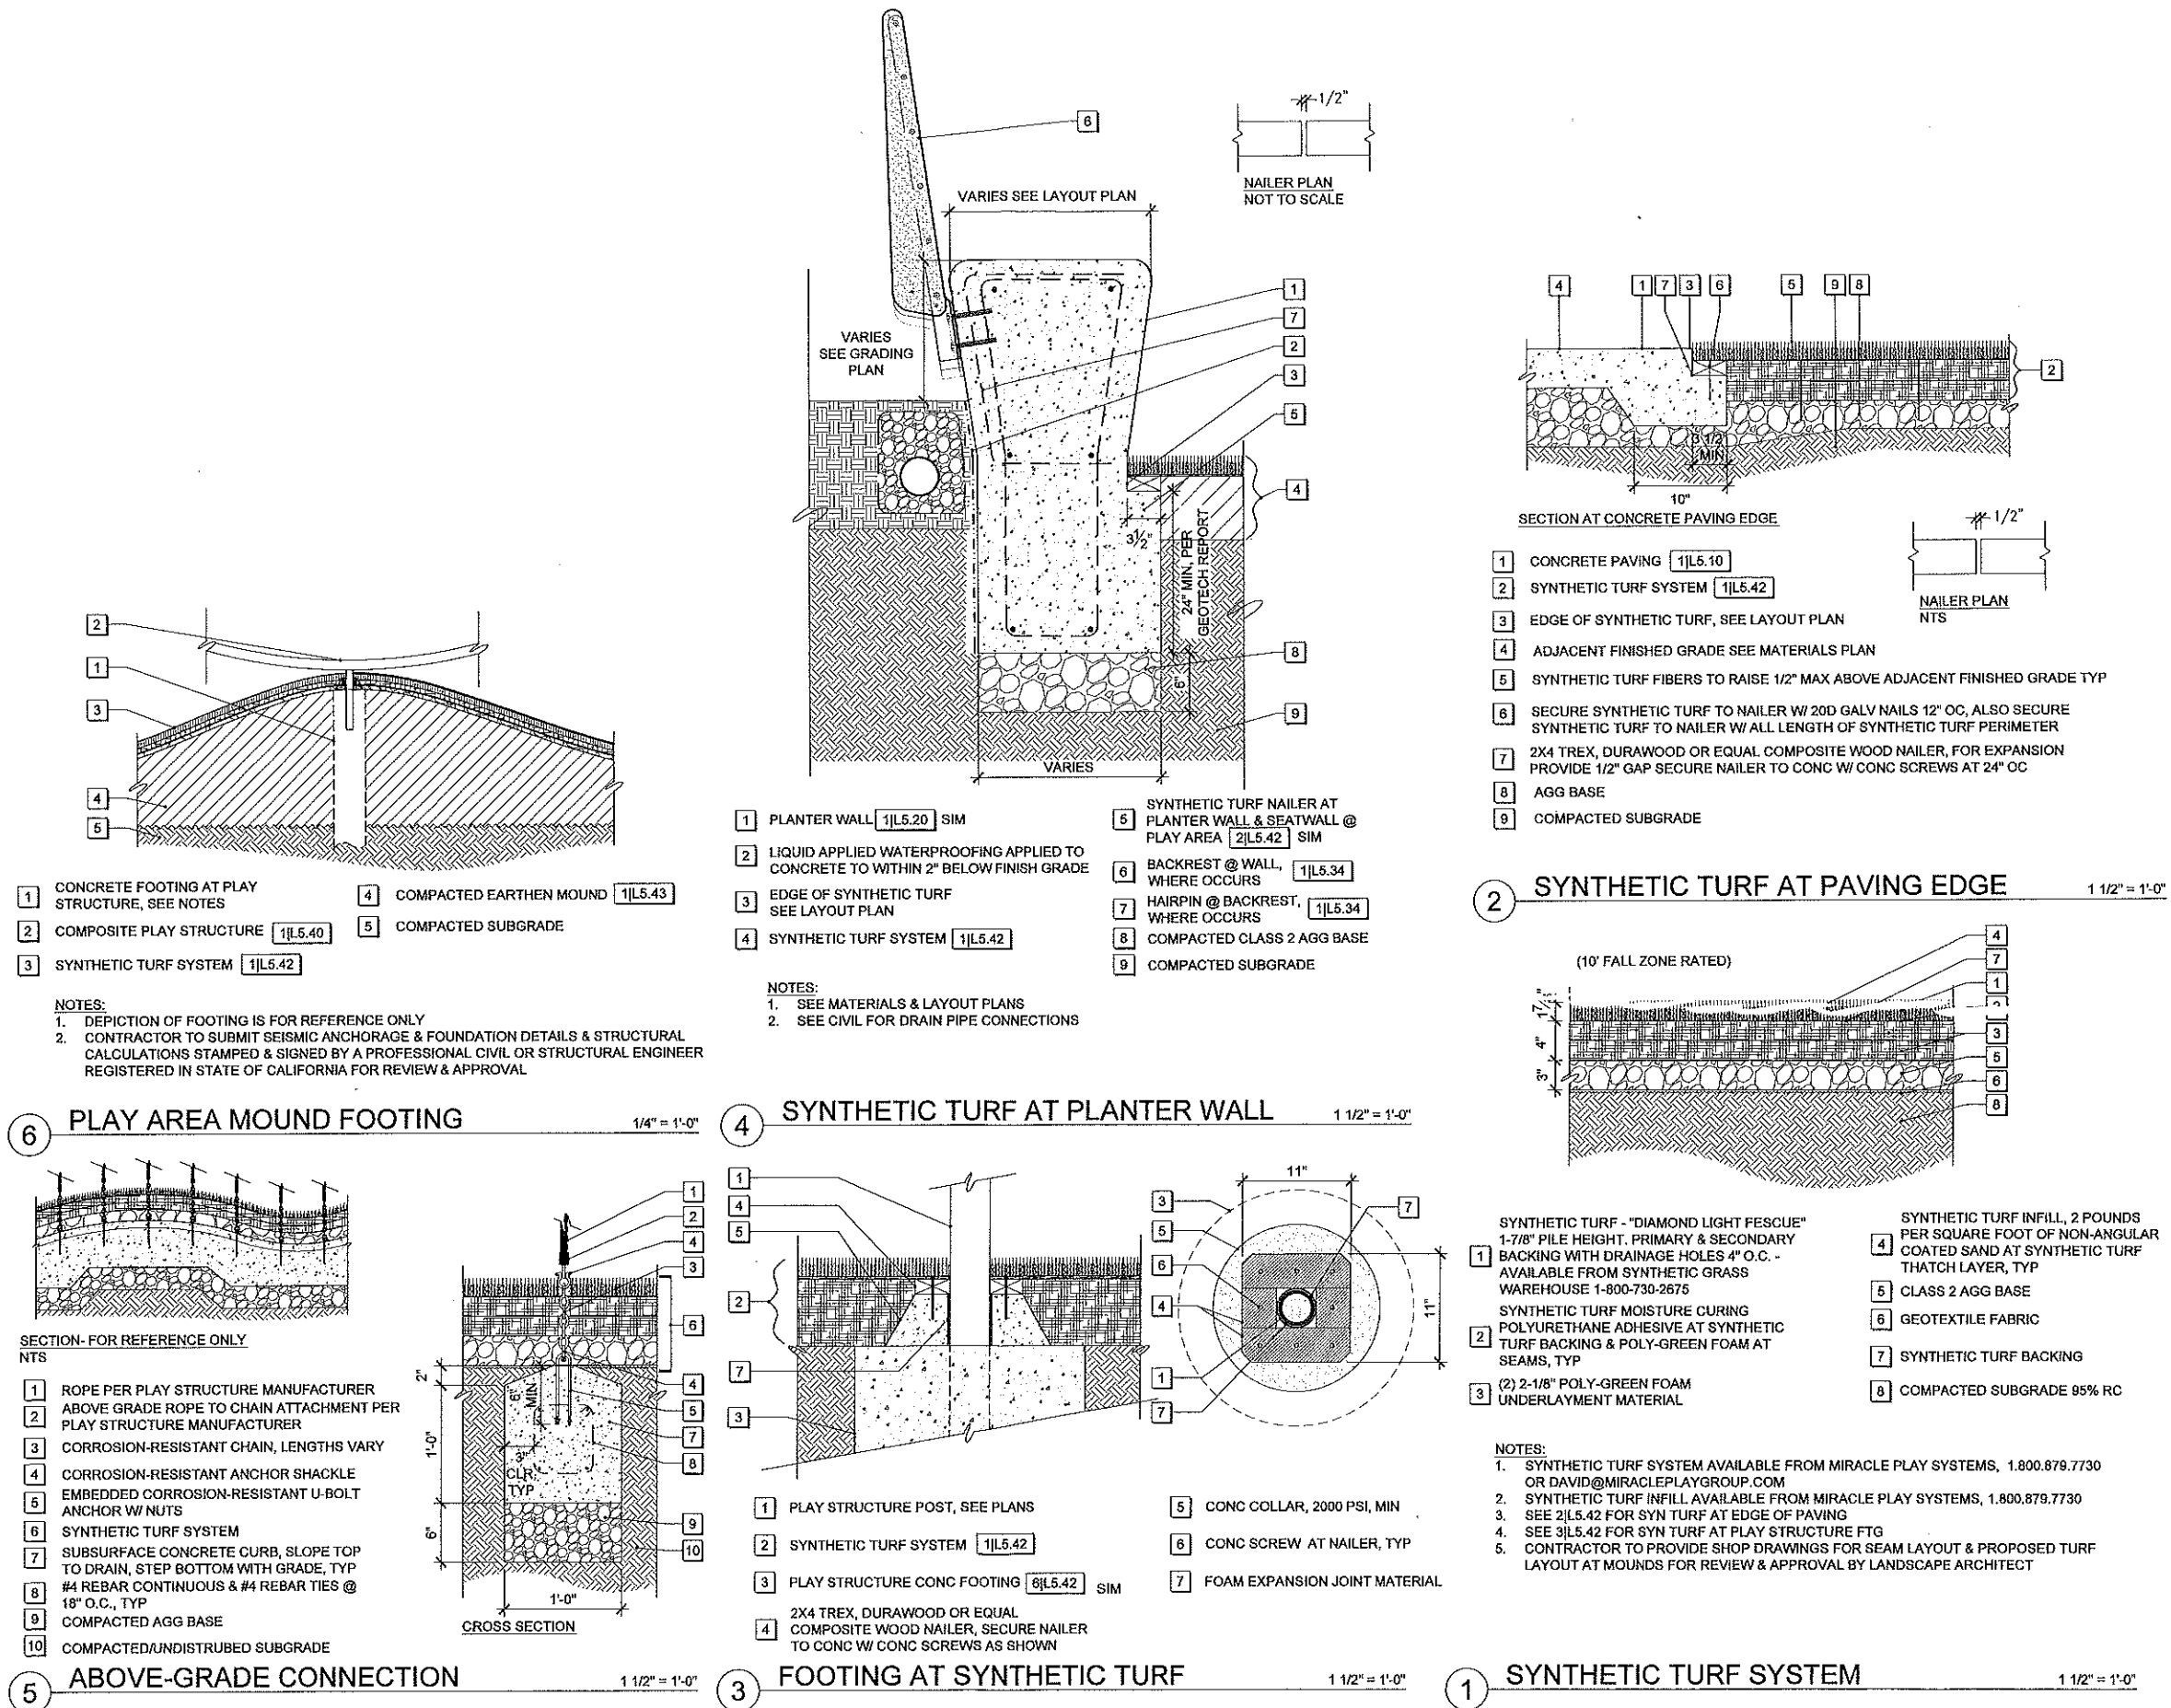
DATE	PROJECT NO.	DRAWN	CHECKED
07.01.15	2208V	CH	OF

DRAWING TITLE:  
**CONSTRUCTION  
DETAILS - PLAY  
AREA**

SHEET NO.:  
**L5.41**



Monday, March 24, 2014 12:46:07 PM



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**LICENSED LANDSCAPE ARCHITECT**  
STATE OF CALIFORNIA  
12/23/08  
07/01/15

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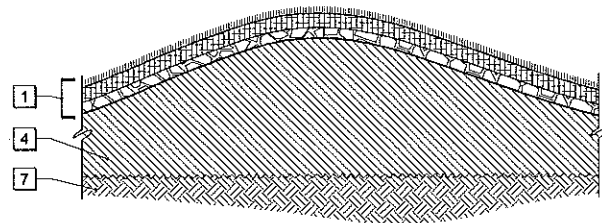
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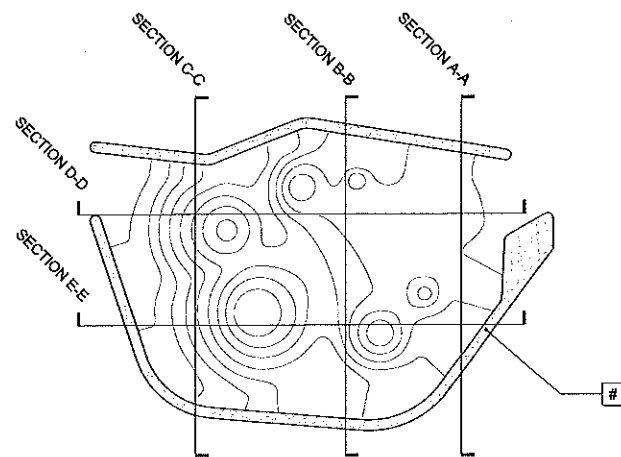
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**L5.42**

Tuesday, July 7, 2015 8:57:47 PM






- 1 SYNTHETIC TURF SYSTEM 1[L5.42]
- 2 ADJACENT CONCRETE PAVING AT SYNTHETIC TURF 2[L5.42]
- 3 CONCRETE PLANTER WALL 1[L5.20] & 4[L5.42]
- 4 STRUCTURAL FILL
- 5 KEYWAY AT TOE OF SLOPE, SEE 2[L1.03] FOR LOCATION
- 6 PERFORATED PIPE, SEE CIVIL DWGS
- 7 COMPACTED OR UNDISTURBED SUBGRADE
- 8 CONCRETE SEATWALL 1[L5.20] SIM
- 9 ADJACENT CONCRETE PAVING AT PLANTER WALL 1[L5.10]



TYPICAL MOUND @ PLAY AREA  
1/2" = 1'-0"



REFERENCE PLAN - SEE 2[L1.03] FOR ADDITIONAL GRADING INFORMATION  
1/16" = 1'-0"

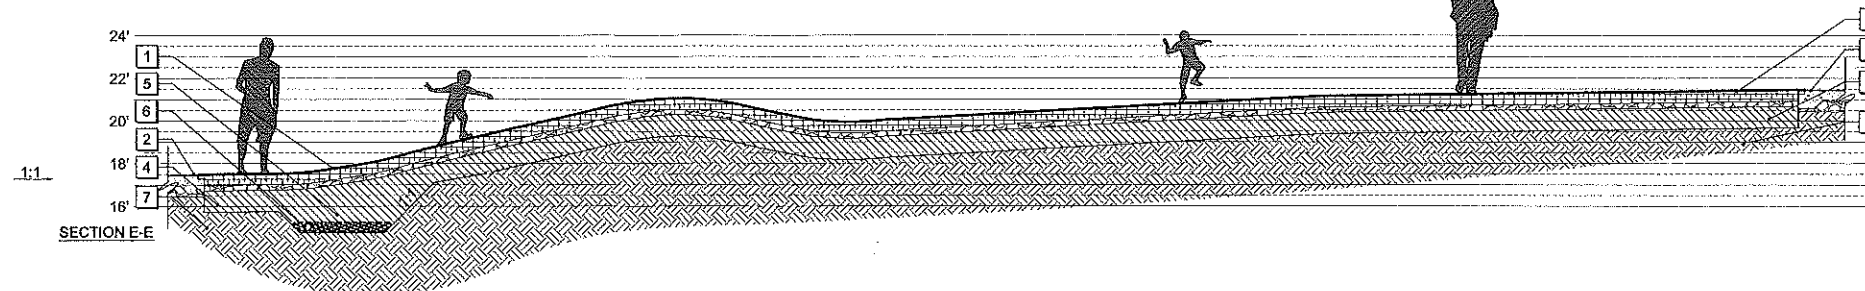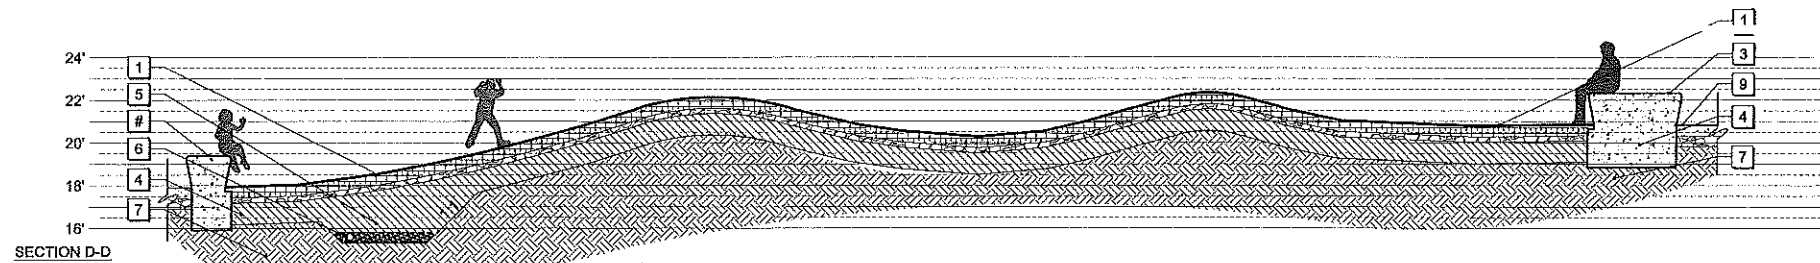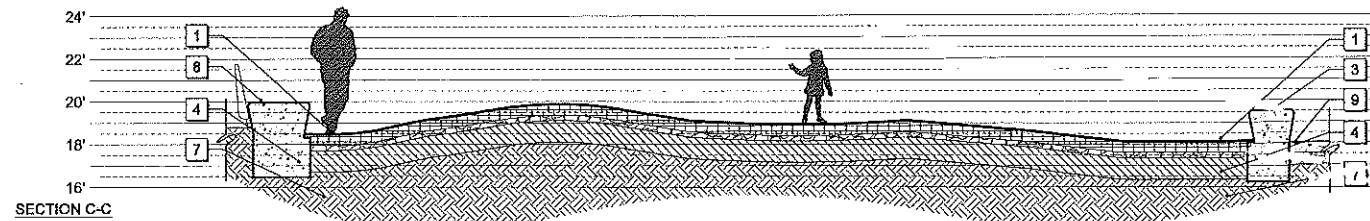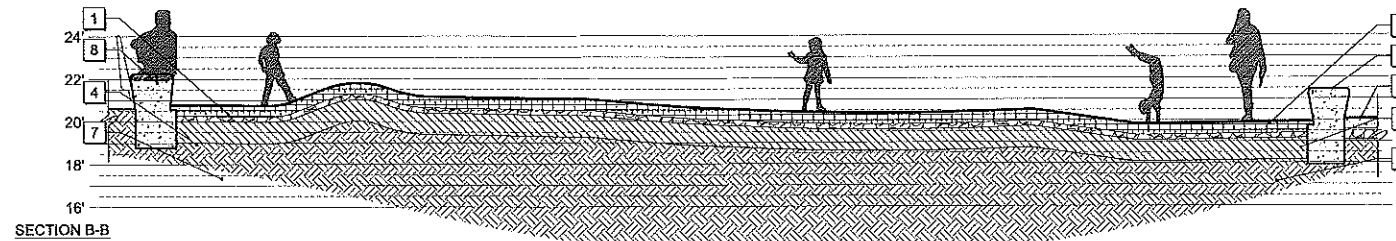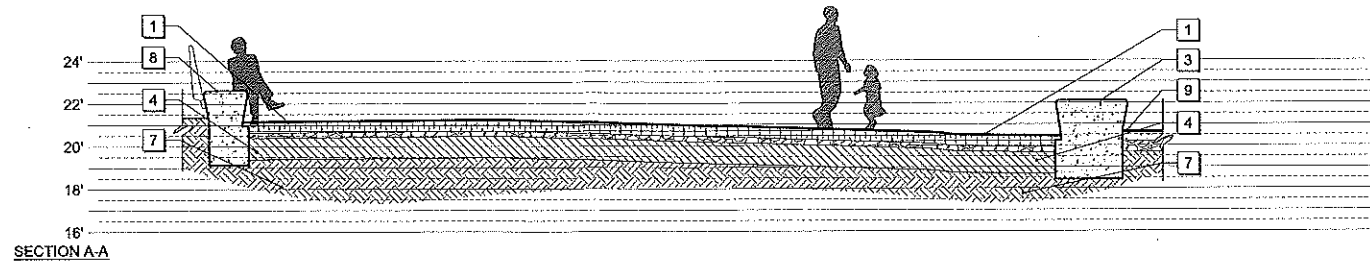

# 1 PLAY AREA MOUNDS AT PLAY SURFACE

1/4" = 1'-0"

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07.01.15	3206V	CH	DF

### DRAWING TITLE: CONSTRUCTION DETAILS - PLAY AREA

SHEET NO.  
L5.43