17th & FOLSOM STREET PARK


A RECREATION AND PARK COMMISSION PROJECT CONTRACT NO. 3054V (ID NO. FCP# 15129)



STREET VIEW - FOLSOM AND 17TH ST. LOOKING WEST

REQUIREMENTS TO BIDDERS

- IN ACCORDANCE WITH THE PROVISIONS OF THE CALIFORNIA PUBLIC CONTRACT CODE SECTION 3300, A BID SUBMITTED TO A PUBLIC AGENCY BY A CONTRACTOR WHO IS NOT LICENSED IN ACCORDANCE WITH CHAPTER 9 OF THE BUSINESS AND PROFESSIONS CODE SHALL BE CONSIDERED NON-RESPONSIVE AND SHALL BE REJECTED BY THE PUBLIC AGENCY
- AT THE TIME OF BID OPENING, THE CONTRACTOR SHALL POSSESS A VALID CLASS "A" CALIFORNIA GENERAL ENGINEERING CONTRACTOR'S LICENSE.

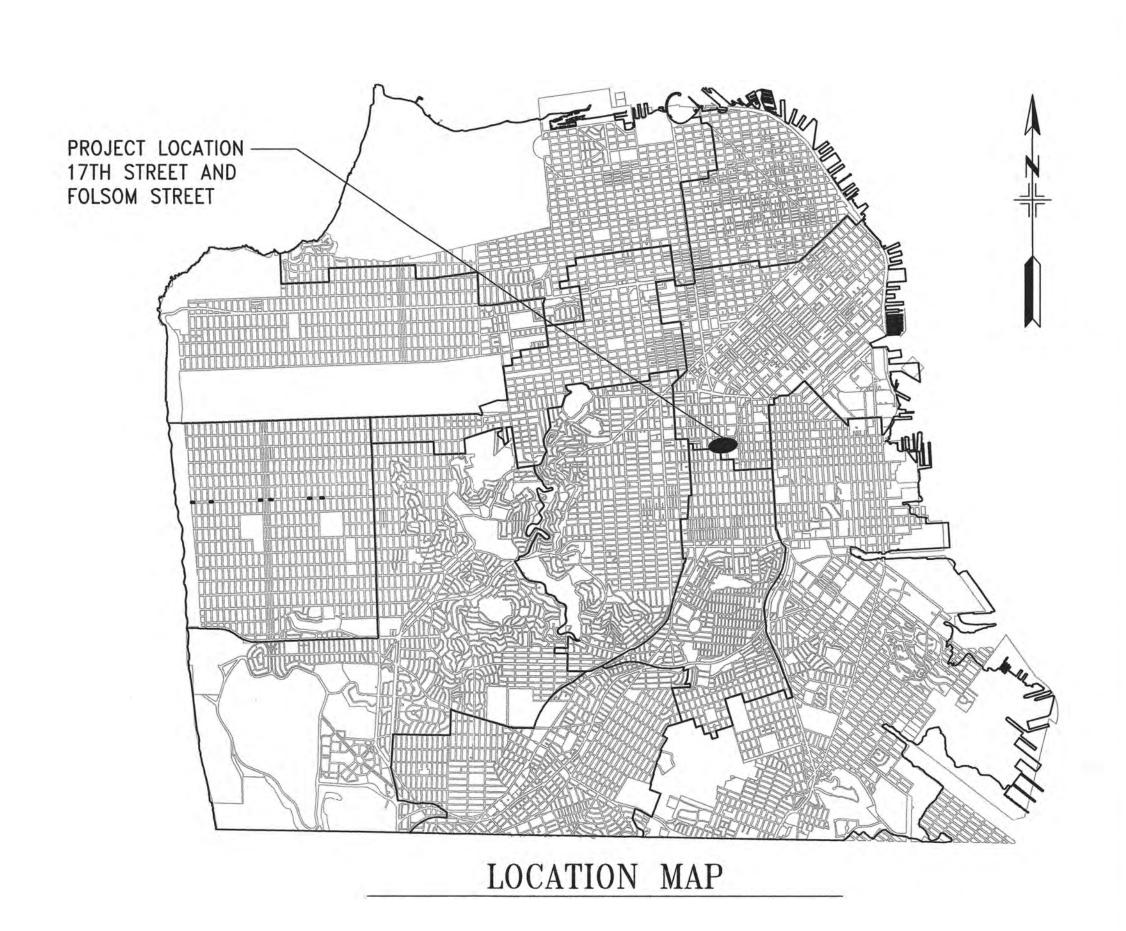

BUILDING DESIGN & CONSTRUCTION



DEPARTMENT OF PUBLIC WORKS

30 Van Ness Avenue San Francisco, CA Suite 410 (415) 557-470 Fax (415) 557-470

Project

17th AND FOLSOM STREET PARK

2080 FOLSOM STREET SAN FRANCISCO, CA 94110

Consulta

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COVER SHEET

Sheet No

G-0.0

Job No.

3054V

SHEET INDEX

GENERAL

SHEET NO.	<u>TITLE</u>
G-0.0	COVER SHEET
G-0.1	SHEET INDEX
G-0.2	ADA COMPLIANCE FORMS
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LANDSCAPE WORK

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L-0.2	ALTERNATE PLAN
L-0.3	EXCAVATION PLAN
L-0.4	IMPORT MATERIAL PLAN
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L-2.0	LAYOUT PLAN - LINE AND CURVE TABLE
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L-4.0	PAVING PLAN
L-5.0	DETAIL REFERENCE PLAN
L-5.1	PLAY EQUIP. & SITE FURN. REFERENCE PLAN
L-5.2	DETAIL REFERENCE PLAN FENCE AND GATE PLAN
L-6.0	IRRIGATION PLAN,
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L-7.2	PLANTING DETAILS
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ELECTRICAL LEGEND, ABBREVIATIONS AND GENERAL NOTES

ELECTRICAL WORK


E-0.2	LIGHTING DETAILS AND FIXTURE SCHEDULE
E-0.3A	TITLE 24
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E-0.3C	TITLE 24
E-0.3D	TITLE 24
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E-0.3F	TITLE 24
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E-1.1	ELECTRICAL SITE PLAN - MECHANICAL AND IRRIGATION SYSTEM

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V-1.0	PLAN-PIPING AND ELECTRICAL
V-2.0	NOTES AND LEGEND
V-3.0	DETAILS
V-4.0	DETAILS

REFERENCE

R-1.0 SURVEY

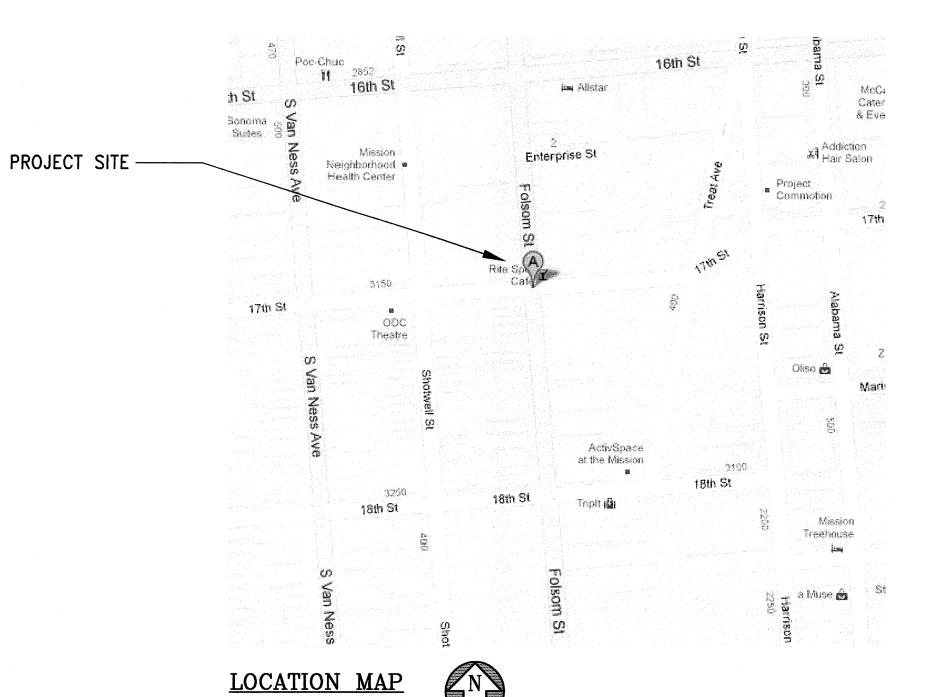

APPLICABLE CODES & STANDARDS

• 2013 CALIFORNIA BUILDING CODE

NOT TO SCALE

- 2013 INTERVENING CYCLE OF CALIFORNIA BUILDING CODE, JULY 1, 2015
- 2013 CALIFORNIA ELECTRICAL CODE
- 2013 CALIFORNIA PLUMBING'S CODE
- ASTM F1487 STANDARD CONSUMER SAFETY PERFORMANCE SPECIFICATION
- FOR PLAYGROUND EQUIPMENT FOR PUBLIC USE
- ASTM F1292 STANDARD SPECIFICATION FOR IMPACT ATTENUATION OF
- SURFACING SYSTEMS UNDER AND AROUND PLAYGROUND EQUIPMENT
- 2010 ADA STANDARD

BUILDING DESIGN & CONSTRUCTION



DEPARTMENT OF PUBLIC WORKS CITY AND COUNTY OF SAN FRANCISCO

30 Van Ness Avenue San Francisco, CA 94102-6028 Suite 4100 (415) 557-4700 Fax (415) 557-4701

Project

17th AND FOLSOM STREET PARK

2080 FOLSOM STREET SAN FRANCISCO, CA 94110

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SHEET INDEX

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PLAY AREA ADA INVENTORY FORM For ADA Coordinator Plan Check, Department of Public Works, Mayor's Office on Disability and Port of San Francisco

Provide one form for each cluster of composite play equipment and per AGE GROUP SERVED each age group. Scan all forms onto play area construction documents. □ <u>Infant</u> ☐ Pre-School (2-4 yrs) X School (5-12 yrs)

A PROJECT INFORMATION

1. Project Name: 17+11/FOLSOM ST PARK	2. Date Submitted: 7//7//5
3. Project Location: 2080 FOLSOM	4. Project Architect / Engineer:
5. Form Prepared by: EDWARD CHIN	6. Project Manager: PAULINA ARAICA
7. Phone and Email: (415) 558-4485 edward.chin@sfdpw.org	8. Phone & Email: (415) 581. 258 pauling. arai Cu @ 5490

B. PATH OF TRAVEL INFORMATION [2010 ADAS Section 202.4]

1. New Construction: ☑yes ☐no 2. Alteration: ☐yes ☐no 3. Barrier Removal: ☐yes ☐no

3. Path of Travel Components triggered by the work. On plans, show 2010 ADAS and 2013 CBC Sec 11B-202.4 compliance of each component and the Path of Travel to the play area, including signage. Check each component that applies. Provide comment if the feature was provided previously under the 1991 ADA Standard, or if it is being provided under the 2010 ADAS for new construction/alterations.

4. Route of Travel from public transit	Æyes □no	Comment:
5. Route of Travel on Site:	⊠yes ⊟no	Comment:
6. Parking :	□yes Ønone on site	Comment:
7. Toilet / Shower Facilities:	□yes Inone on site	Comment:
8. Public Telephones:	□yes ☑none on site	Comment:
9. Drinking fountain:	Øyes □none on site	Comment:
10.Passenger Loading Zone:	□yes □none on site	Comment:

E. STANDARDS AND COMPLIANCE DOCUMENTATION

• 2010 ADA Standards, Sections 240 and 1008 for all age groups 2 and above.

• US Consumer Product Safety Handbook (selected sections per CCR 65700).

 ASTM F-1487 Consumer Safety Performance Specification for Playground Equipment for Public Use (ages 2 thru 12). Provide documentation showing compliance with the following and scan compliance statement or material testing certificates onto plans:

ASTM F-1292 Standard Specification of Impact Attenuation of Surfacing Systems Under [and Around] Play Equipment – 2010 ADAS section 1008.2.6.2 and 2013 CBC section 11B-1008.2.6.2

ASTM F-1951 Standard Specification for Determination of Accessibility of Surface Systems Under and Around Playground Equipment-2013 ADAS section 1008.2.6.1 and 2013 CBC section 1008.2.6.1

F. NUMBER OF REQUIRED ELEVATED PLAY COMPONENTS ON ACCESSIBLE ROUTES

[2010 A	[2010 ADAS Section 240.2.2]				
Pick One	Total	50% MIN. OF ELEVATED PLAY COMPONENTS SHALL BE ON AN ACCESSIBLE ROUTE			
Ø	Less than 20	An accessible route may be a transfer access system, ramped access or route with less than 5% running slope			
	20 or More	25% min. of elevated play components must be accessible by ramp access and 25% min. may be accessible by either ramp or transfer system access for a total of 50% (Section 11B- 1008.4)			

G. NUMBER AND TYPE OF ACCESSIBLE GROUND LEVEL PLAY COMPONENTS IN EACH PLAY AREA (not including free standing play elements)

[* 2010 ADAS Table 240.2.1.2 modified by MOD-SF 240.2.1.1]

ELEVATED PLAY COMPONENTS PLANNED IN PLAY AREA			R OF ACCESSIBLE G Appendix A for CC		
PICK ONE	TOTAL AMOUNT (#)	On Accessible Route	ACTUAL #. PROVIDED	Different Type(S)	ACTUAL# PROVIDED
	1	1*		1*	
	2-4	2*		2*	
	5-7	3*		3*	
	8-10	4*		3	
	11-13	5*		3	
	14-16	6*		3	
	17-19	7*		3	
	20-22	8*	i i	4	
	23-25	9*		4	
	>25	8 + 1 for each additional 3 over 25, or fraction thereof			

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H.	LIST ELEVATED PLAY COMPONENTS (Show, label and/or key each on plans)			ESSESSO	GROUND LEV	EL PL	ER AND TYPES OF AY COMPONENTS
					ON ACC	ESSI	BLE ROUTES
Key #	On accessible route (transfer tier or ramp access)	# No.	Not on accessible route	Key #	Number and Name of Each Component	# No.	Number and Name of Different Play Types
A1				B1	5 WIN65	1	SWING
A2				B2	SPINNER		SPINNER.
А3				B3	SPINNER	1	
A4				B4	MULTIUSER		MULTI SPINNER
A5				B5	SPINNER	1	
A6				В6	CLIMBING POLE	l	CHMBING POLÉ
A7				B7	NET STRUCTURE	1	NET STRUCTURE
A8				B8	WATER JET		
A9				B9	warl	1	WATER PLAY
A10				B10			
A11				B11			·
A12				B12			
A13				B13			

ISSUE DATE: 6/2/15 - 17th and Folsom Park

ROBERTSON INDUSTRIES DTL REPORT NO.: 7028006-1

TEST RESULTS

Wheelchair Measurement Test

The sample material was prepared by Robertson Industries in a 5 foot X 5 foot wooder frame at a depth of 1.5 inches. The sample was cut by DTL enabling appropriate te arrangement. The sample was tested by propelling the wheelchair with four (4) even pushes across the material 6.56 feet within eight (8) seconds. This process was repeated five (5) times for each test (straight and 90° turn propulsions).

The table below shows the results for each trial. Per ASTM F1951-99, the work force averages were determined averaging the three median trials, discarding the highest and

Run#	No Material work per foot	With Material work per foo
	in pound force-inch	in pound force-inch
Straight Run 1	109.28	39.13
Straight Run 2	118.53	39.45
Straight Run 3	109.10	31.94
Straight Run 4	109.06	34.74
Straight Run 5	109.52	31.17
Average	109.30	35.27
Turn Run 1	118.34	41.51
Turn Run 2	111.81	39.65
Turn Run 3	109.51	44.37
Turn Run 4	110.68	41.10
Turn Run 5	114.21	44.48
Average	112.23	42.33

The wheelchair rider weight was 172lbs., which combined with the wheelchair for a total

ROBERTSON INDUSTRIES DTL REPORT NO.: 7028006-1

The average work per foot in pound force-inch values for straight propulsion and for turning with material should be less than the average work per foot values for straight and turning on flat surface with a grade of 7.1%.

Detroit Testing Laboratory, Inc.'s calibration system meets the requirements of

DTL ID	Description	Manufacturer	Model	Calib. Due
09357	Signal Conditioner	Daytronics	3370	7/07
09715	Reaction Torque Sensor	Lebow	2110220500	7/07
09696	Digital Protractor	Mitutoyo	Pro 360	4/08
	Wheelchair	Quickie	Q2	NCR
*****************************	Wheelchair Fixture	DTL	~	NCR

The sample material will be retained for fifteen (15) days, then disposed of at the

DETROIT TESTING LABORATORY, INC. Certification Programs Coordinate

Keith G. Shelton Certification Program Manager

IPEMA venui fiev, ASTM 6 **MANUFACTURER**

In the interest of public playground safety, IPEMA provides a third-party certification service whereby TÜV SÜD America validates a manufacturer's certification of conformance to the ASTM F1292-13, Standard Specification for Impact Attenuation of Surface Systems Under and Around Playground Equipment Standard.

The manufacturer listed below has received written validation from TÜV SÜD America that the products listed below conform with the requirements of ASTM F1292-13.

Robertson Industries, Inc., A Playcore Company 2414 West 12th Street Suite 5

Tempe, AZ 85281 PRODUCT NBR

TS400

TT200

TT350

TT450

(U)

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PRODUCT LINE TotTurf TotTurf

TotTurf

TotTurf

DESCRIPTION

4"/8ft TotTurf TPV Supreme 4" 2.0in/4ft Poured-In-Place rubber, playground safety surfacing 3.5in/8ft Poured-In-Place rubber, playground safety surfacing 4.5in/11ft Poured-In-Place rubber, playground safety surfacing

> TÜV America

You may verify this certificate by visiting IPEMA's website at http://ipema.org

PLAYGROUND SURFACING ADA ASTM F1951-09B COMPLIANCE

PLAYGROUND SURFACING ATTENUATION -**ASTM F1292 COMPLIANCE**

BUILDING **DESIGN & CONSTRUCTION**



CITY AND COUNTY OF SAN FRANCISCO 30 Van Ness Avenue (415) 557-4700 San Francisco, CA

94102-6028

17th AND FOLSOM STREET PARK

Fax (415) 557-4701

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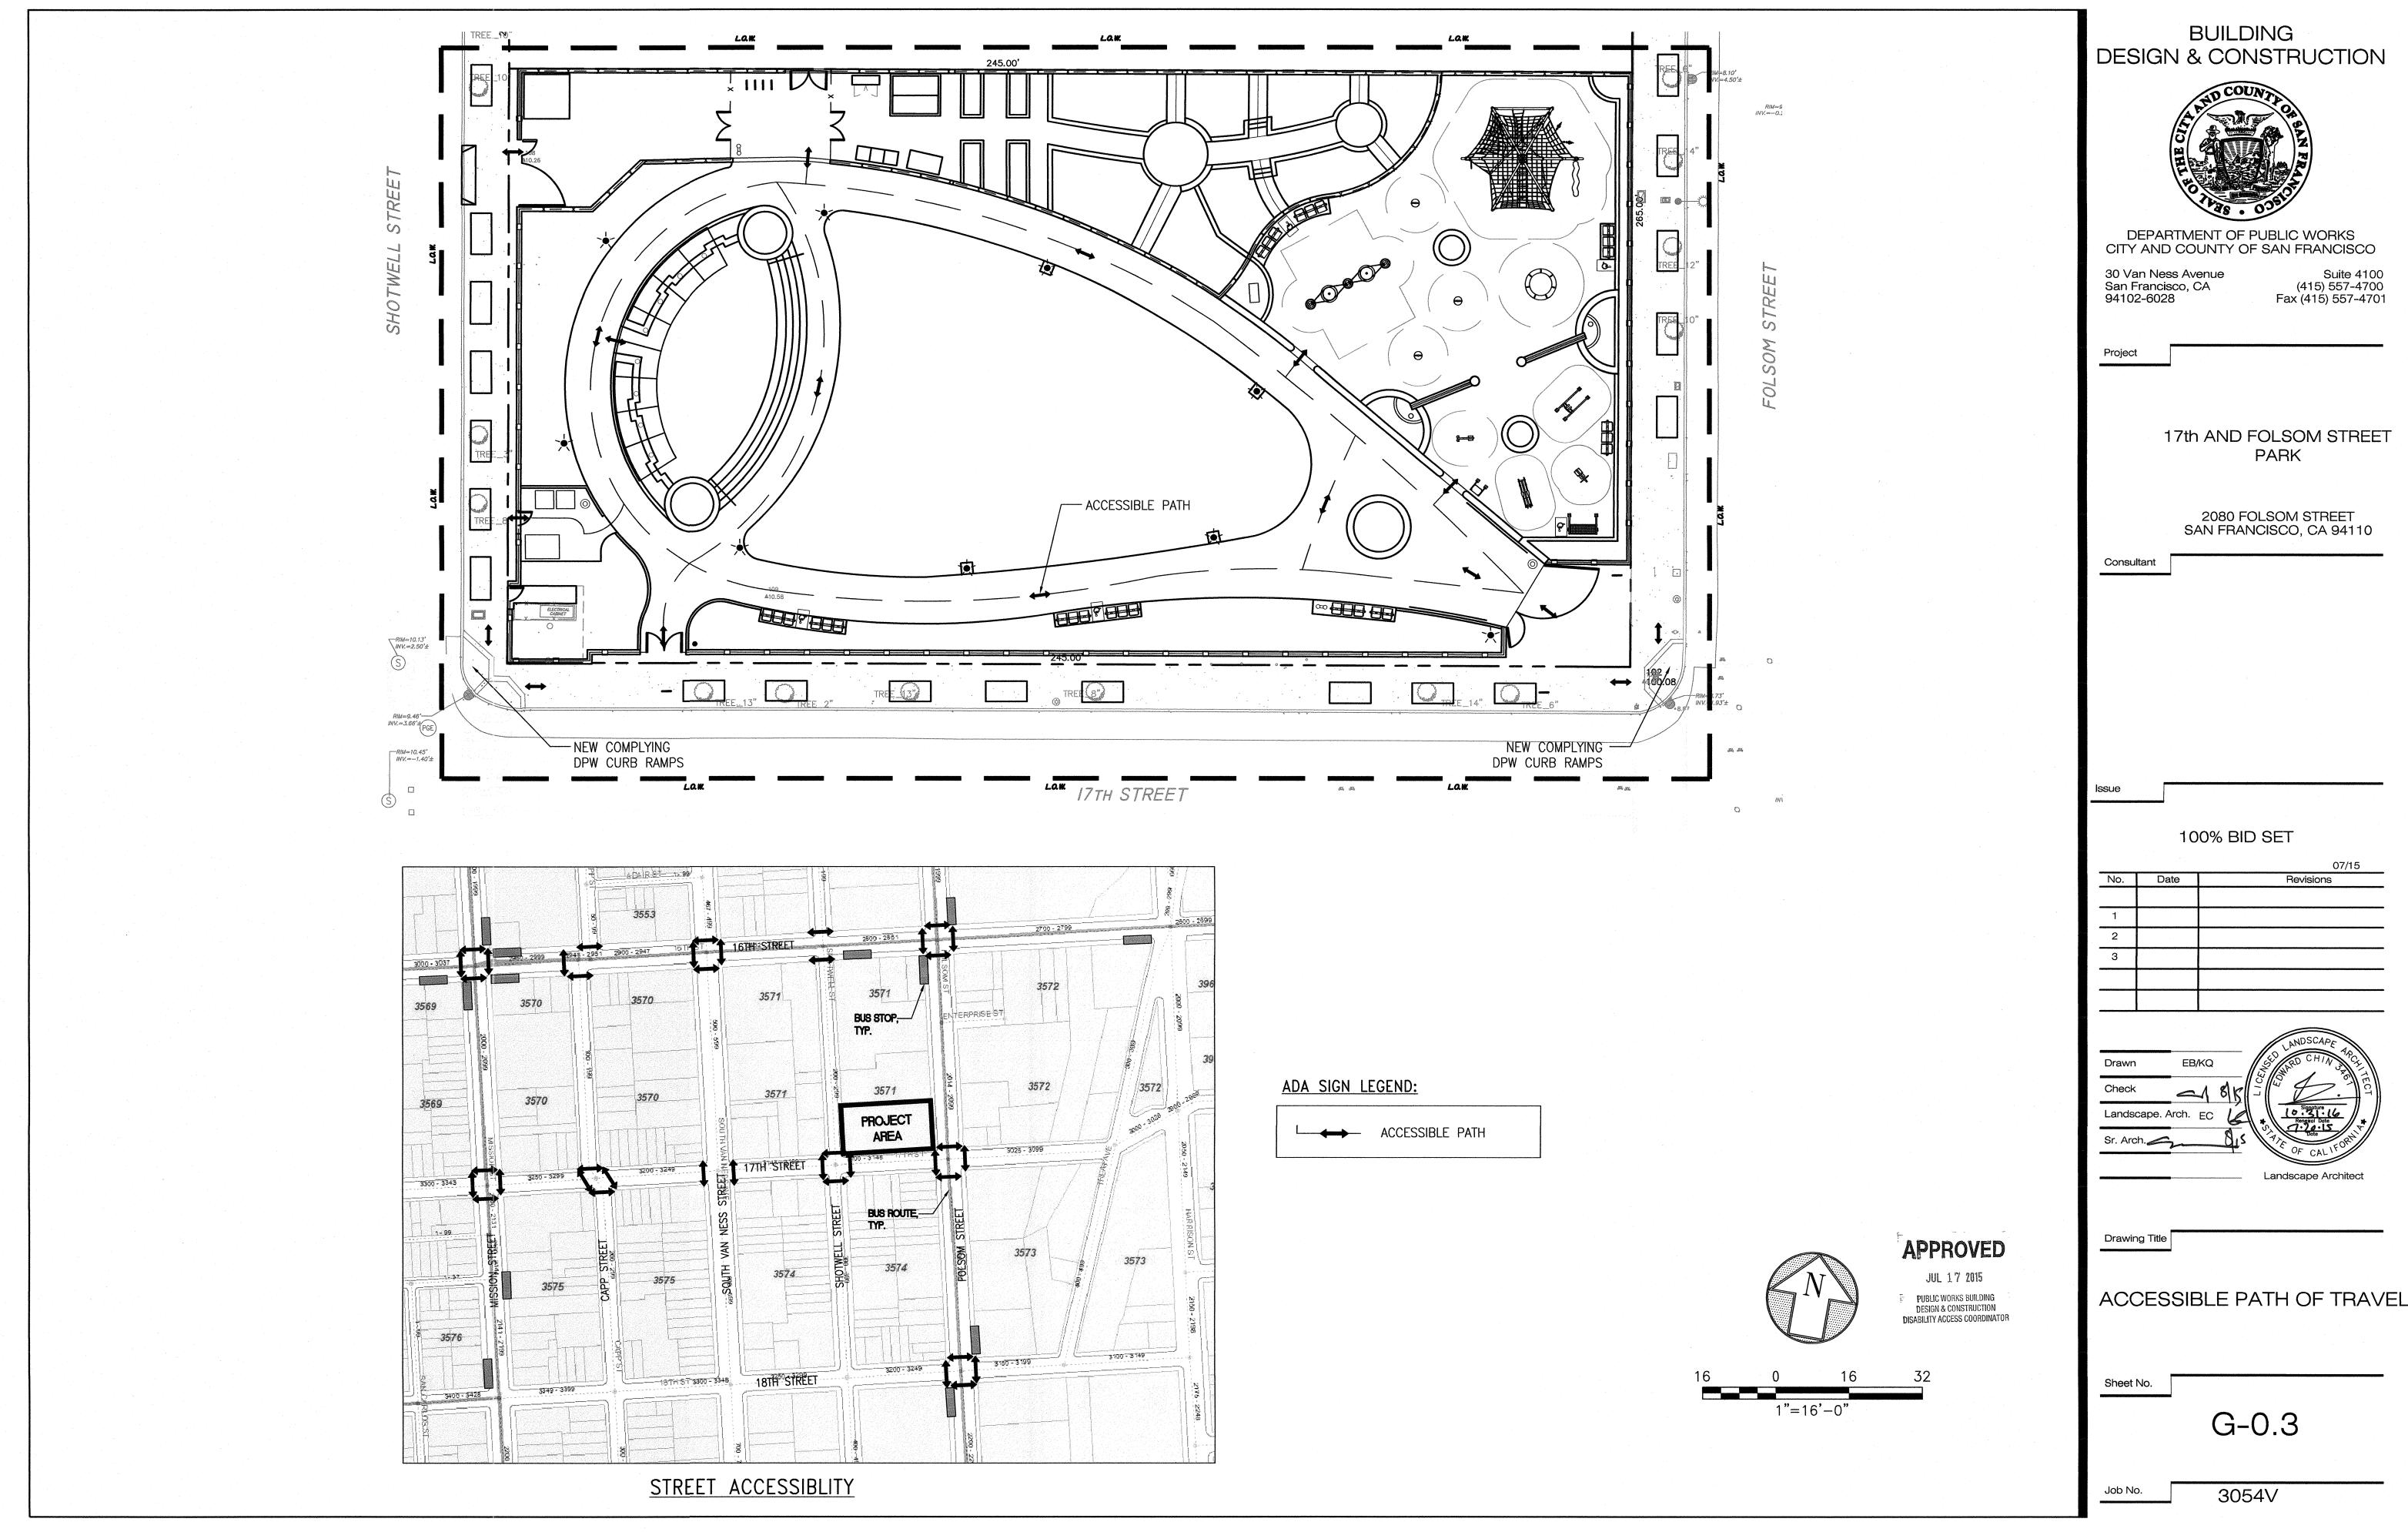
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ADA COMPLIANCE FORMS

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LANDSCAPE GENERAL NOTES AND ABBREVIATIONS

DEMOLITION NOTES

PROTECT ALL SITE ELEMENTS TO REMAIN.

PROVIDE CONSTRUCTION FENCING AT LIMIT OF WORK LINE THROUGHOUT CONSTRUCTION PERIOD.

ALL MATERIALS SHALL BE DISPOSED OF IN A LEGAL MANNER AS CONTRACTOR'S PROPERTY.

GENERAL NOTES

ALL WORK SHALL BE COMPLETED IN A THOROUGH AND WORKMANLIKE MANNER.

ALL WORK TO BE PERFORMED SHALL CONFORM TO ALL APPLICABLE CODES AND ORDINANCES OF GOVERNMENTAL AGENCIES HAVING JURISDICTION OVER THE PROJECT.

PROTECT ALL UTILITIES, IMPROVEMENTS AND STRUCTURES AND RESTORE TO NEW CONDITION AT NO ADDITIONAL COST TO THE CITY IF DAMAGED DURING THE COURSE OF WORK.

COORDINATE ALL WORK TO PREVENT CONFLICTS BETWEEN TRADES AND REPORT CONFLICTS OR INCONGRUITIES BETWEEN NEW IMPROVEMENTS AND/OR EXISTING FACILITIES TO THE CITY REPRESENTATIVE IMMEDIATELY.

THE CONTRACTOR IS RESPONSIBLE FOR THE COORDINATION AND INSTALLATION OF ALL PLUMBING AND ELECTRICAL ITEMS TO BE INSTALLED AS A PART OF THIS WORK.

CLEAR AND REMOVE ALL ORGANIC MATTER, DEBRIS AND RUBBISH FROM WITHIN THE LIMIT OF WORK. CONTRACTOR SHALL DISPOSE OF SAID MATERIAL IN A LEGAL MANNER AS HIS PROPERTY.

IN ADDITION TO THESE DRAWINGS. REFER TO CCSF STANDARD SPECIFICATIONS.

LAYOUT NOTES

VERIFY ALL DIMENSIONS IN THE FIELD PRIOR TO BEGINNING CONSTRUCTION AND REPORT ANY DISCREPANCIES TO THE CITY REPRESENTATIVE PRIOR TO PROCEEDING.

WRITTEN DIMENSIONS ON DRAWINGS SUPERSEDE SCALE DIMENSIONS.

ALL DIMENSIONS ARE TO BE MEASURED HORIZONTALLY.

VERIFY LOCATION AND ELEVATIONS OF UTILITY VAULTS AND OTHER COVERS AND REPORT ANY CONFLICTS OR DISCREPANCIES TO THE CITY REPRESENTATIVE.

PLACE EXPANSION JOINTS WHERE ALL HORIZONTAL PAVING ABUTS A VERTICAL SURFACE AND AS SHOWN ON PLANS. JOINTS SHALL BE 3/8" PRE-MOLDED ASPHALTIC FIBER MATERIAL.

THE CONTRACTOR SHALL STAKE ALL PAVED AREAS AND FOOTINGS FOR REVIEW BY THE CITY REPRESENTATIVE BEFORE FINAL CONSTRUCTION.

GRADING NOTES

VERIFY ALL GRADES IN THE FIELD BEFORE PROCEEDING WITH WORK, INCLUDING EXISTING IMPROVEMENTS: LOCATIONS AND ELEVATIONS OF AREA DRAINS.

EXISTING GRADES SHOWN ARE APPROXIMATE AND SHALL BE FIELD VERIFIED. ALL DISCREPANCIES SHALL BE REPORTED TO THE CITY REPRESENTATIVE IMMEDIATELY

THE CONTRACTOR SHALL BE RESPONSIBLE FOR POSITIVE SURFACE DRAINAGE IN ALL PAVING AND PLANTING AREAS. ALL GROUND SURFACES SHALL BE FINISHED TO A SMOOTH AND CONTINUOUS GRADE, DRAINING AND FREE OF STANDING WATER.

PROVIDE A SMOOTH TRANSITION BETWEEN EXISTING AND NEW GRADES IN PLANTING AREAS. WHERE NEW PAVEMENT ABUTS NEW PAVEMENT, FINISH GRADES SHALL BE FLUSH, UNLESS OTHERWISE NOTED. EASE TOP AND TOE OF ALL SLOPES TO PROVIDE SMOOTH TRANSACTIONS BETWEEN GROUND PLANES.

THE CITY REPRESENTATIVE RESERVES THE RIGHT TO MAKE ADJUSTMENTS IN THE FINISHED GRADES AS THE WORK PROGRESSES.

ELEVATIONS ARE BASED ON CITY AND COUNTY OF SAN FRANCISCO DATUM, UNLESS OTHERWISE NOTED.

PLANTING NOTES

SEE STANDARD SPECIFICATIONS, SECTION 1007 "PLANTING", FOR ADDITIONAL PLANTING INFORMATION.

PLANT LISTS PROVIDED (SEE SHEET L-7.0/7.1) ARE FOR THE CONVENIENCE OF THE CONTRACTOR. IN CASE OF DISCREPANCIES. THE PLAN SHALL GOVERN.

CITY REPRESENTATIVE IS TO INSPECT AND TAG ALL PLANT MATERIALS AT NURSERY GROWING GROUNDS PRIOR TO DELIVERY. CONTRACTOR SHALL REVIEW ALL PLANT MATERIAL ON SITE WITH CITY REPRESENTATIVE AND SHALL INSTALL MATERIAL ONLY AFTER OBTAINING APPROVAL FROM THE CITY REPRESENTATIVE.

THE CITY REPRESENTATIVE RESERVES THE RIGHT TO MAKE SUBSTITUTIONS. ADDITIONS, AND DELETIONS IN THE PLANTING SCHEME AS THE WORK PROGRESSES.

CONTRACTOR SHALL REVIEW PLANT MATERIAL LOCATION PRIOR TO FINAL PLANTING WITH THE CITY REPRESENTATIVE. LOCATIONS SHOWN ON PLANS ARE DIAGRAMMATIC ONLY.

UNLESS OTHERWISE NOTED, ALL GROUNDCOVER AND SHRUBS SHALL BE SPACED TRIANGULARLY.

ALL NEWLY PLANTED GROUND COVER AND SHRUB AREAS TO RECEIVE 3" MIN. COMPACTED, SHREDDED BARK, SEE SPECIFICATIONS.

SITE METAL WORK NOTES

SUBMIT SHOP DRAWINGS FOR ALL METAL WORK.

ALL MEMBERS TO BE STRUCTURAL STEEL GALVANIZED SIZE AND TYPE AS INDICATED ON DETAIL DRAWINGS.

SHOP ASSEMBLY, WITH FULL DEPTH WELDS, TYPE "FILLET WELD" CONTINUOUS, GRIND SMOOTH.

HOT DIP GALVANIZE ALL MEMBERS PER SPECIFICATIONS.

ABBREVIATIONS

CCSF CITY & COUNTY OF SAN FRANCISCO

C. C CENTER LINE CATCH BASIN

CLR. CLEAR CONC. CONCRETE N.I.C. NOT IN CONTRACT CONT. CONTINUOUS NO., # NUMBER CONTROL JOINT

NO KNOWN EQUAL DIA., Ø DIAMETER DRAWING O.C. ON CENTER


EXISTING O.D. OUTSIDE DIAMETER EACH P.A. PLANTING AREA **EXPANSION JOINT** R RADIUS

FOOTING SPECS SPECIFICATIONS ST. STREET GALV. GALVANIZED

TYP. TYPICAL JOINT U.O.N.UNLESS OTHERWISE NOTED L.O.W. LIMIT OF WORK MAX. MAXIMUM FLUSH OR ALIGNED

TYPICAL EXISTING TREE PROTECTION NOT TO SCALE

MIN. MINIMUM

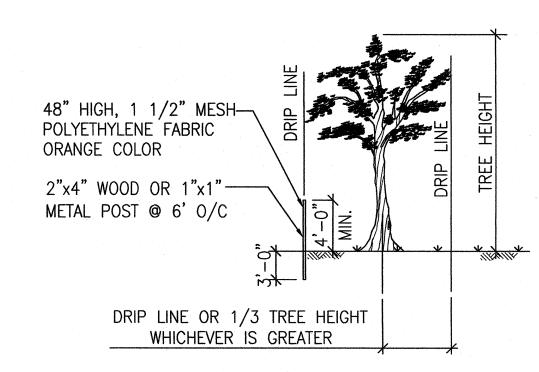

NOTES:

- PROTECT ALL EXISTING TREES WHOSE DRIP LINE IS WITHIN 25 FEET OF EXCAVATION, TRENCHING, GRADING, OR PATHWAY WORK, AGAINST INJURY OR DAMAGE FROM CONSTRUCTION OPERATIONS.
- SEE SPECIFICATION 01560 "PROTECTION OF TREES" FOR OTHER REQUIREMENTS.
- PROTECT TREES PRIOR TO COMMENCING WORK BY ERECTING A TEMPORARY SAFETY FENCE PER DETAIL ABOVE ON SIDE(S) ADJACENT TO CONSTRUCTION.
- EXCEPT WHEN ON ASPHALT PAVEMENT, NO VEHICLES OR MECHANICAL EQUIPMENT LARGER THAN A DITCHWITCH OR BOBCAT CLASS MACHINE ARE PERMITTED ANY CLOSER TO A TREE THAN 1/3 OF TREE HEIGHT OR TREE DRIP LINE, WHICHEVER DISTANCE IS GREATER. SHOULD VEHICLES OR EQUIPMENT (OTHER THAN MECHANICAL TRENCHING) BE NECESSARY WITHIN THIS PROXIMITY OF A TREE. A 4 INCH DEEP LAYER OF APPROVED BARK MULCH SHALL BE APPLIED OVER THE AREA TO BE USED BY SUCH VEHICLES OR EQUIPMENT.

MH MANHOLE (N) NEW

N.T.S. NOT TO SCALE

FINISH GRADE S.J. SCORE JOINT

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DEPARTMENT OF PUBLIC WORKS CITY AND COUNTY OF SAN FRANCISCO

17th AND FOLSOM STREET

PARK

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San Francisco, CA

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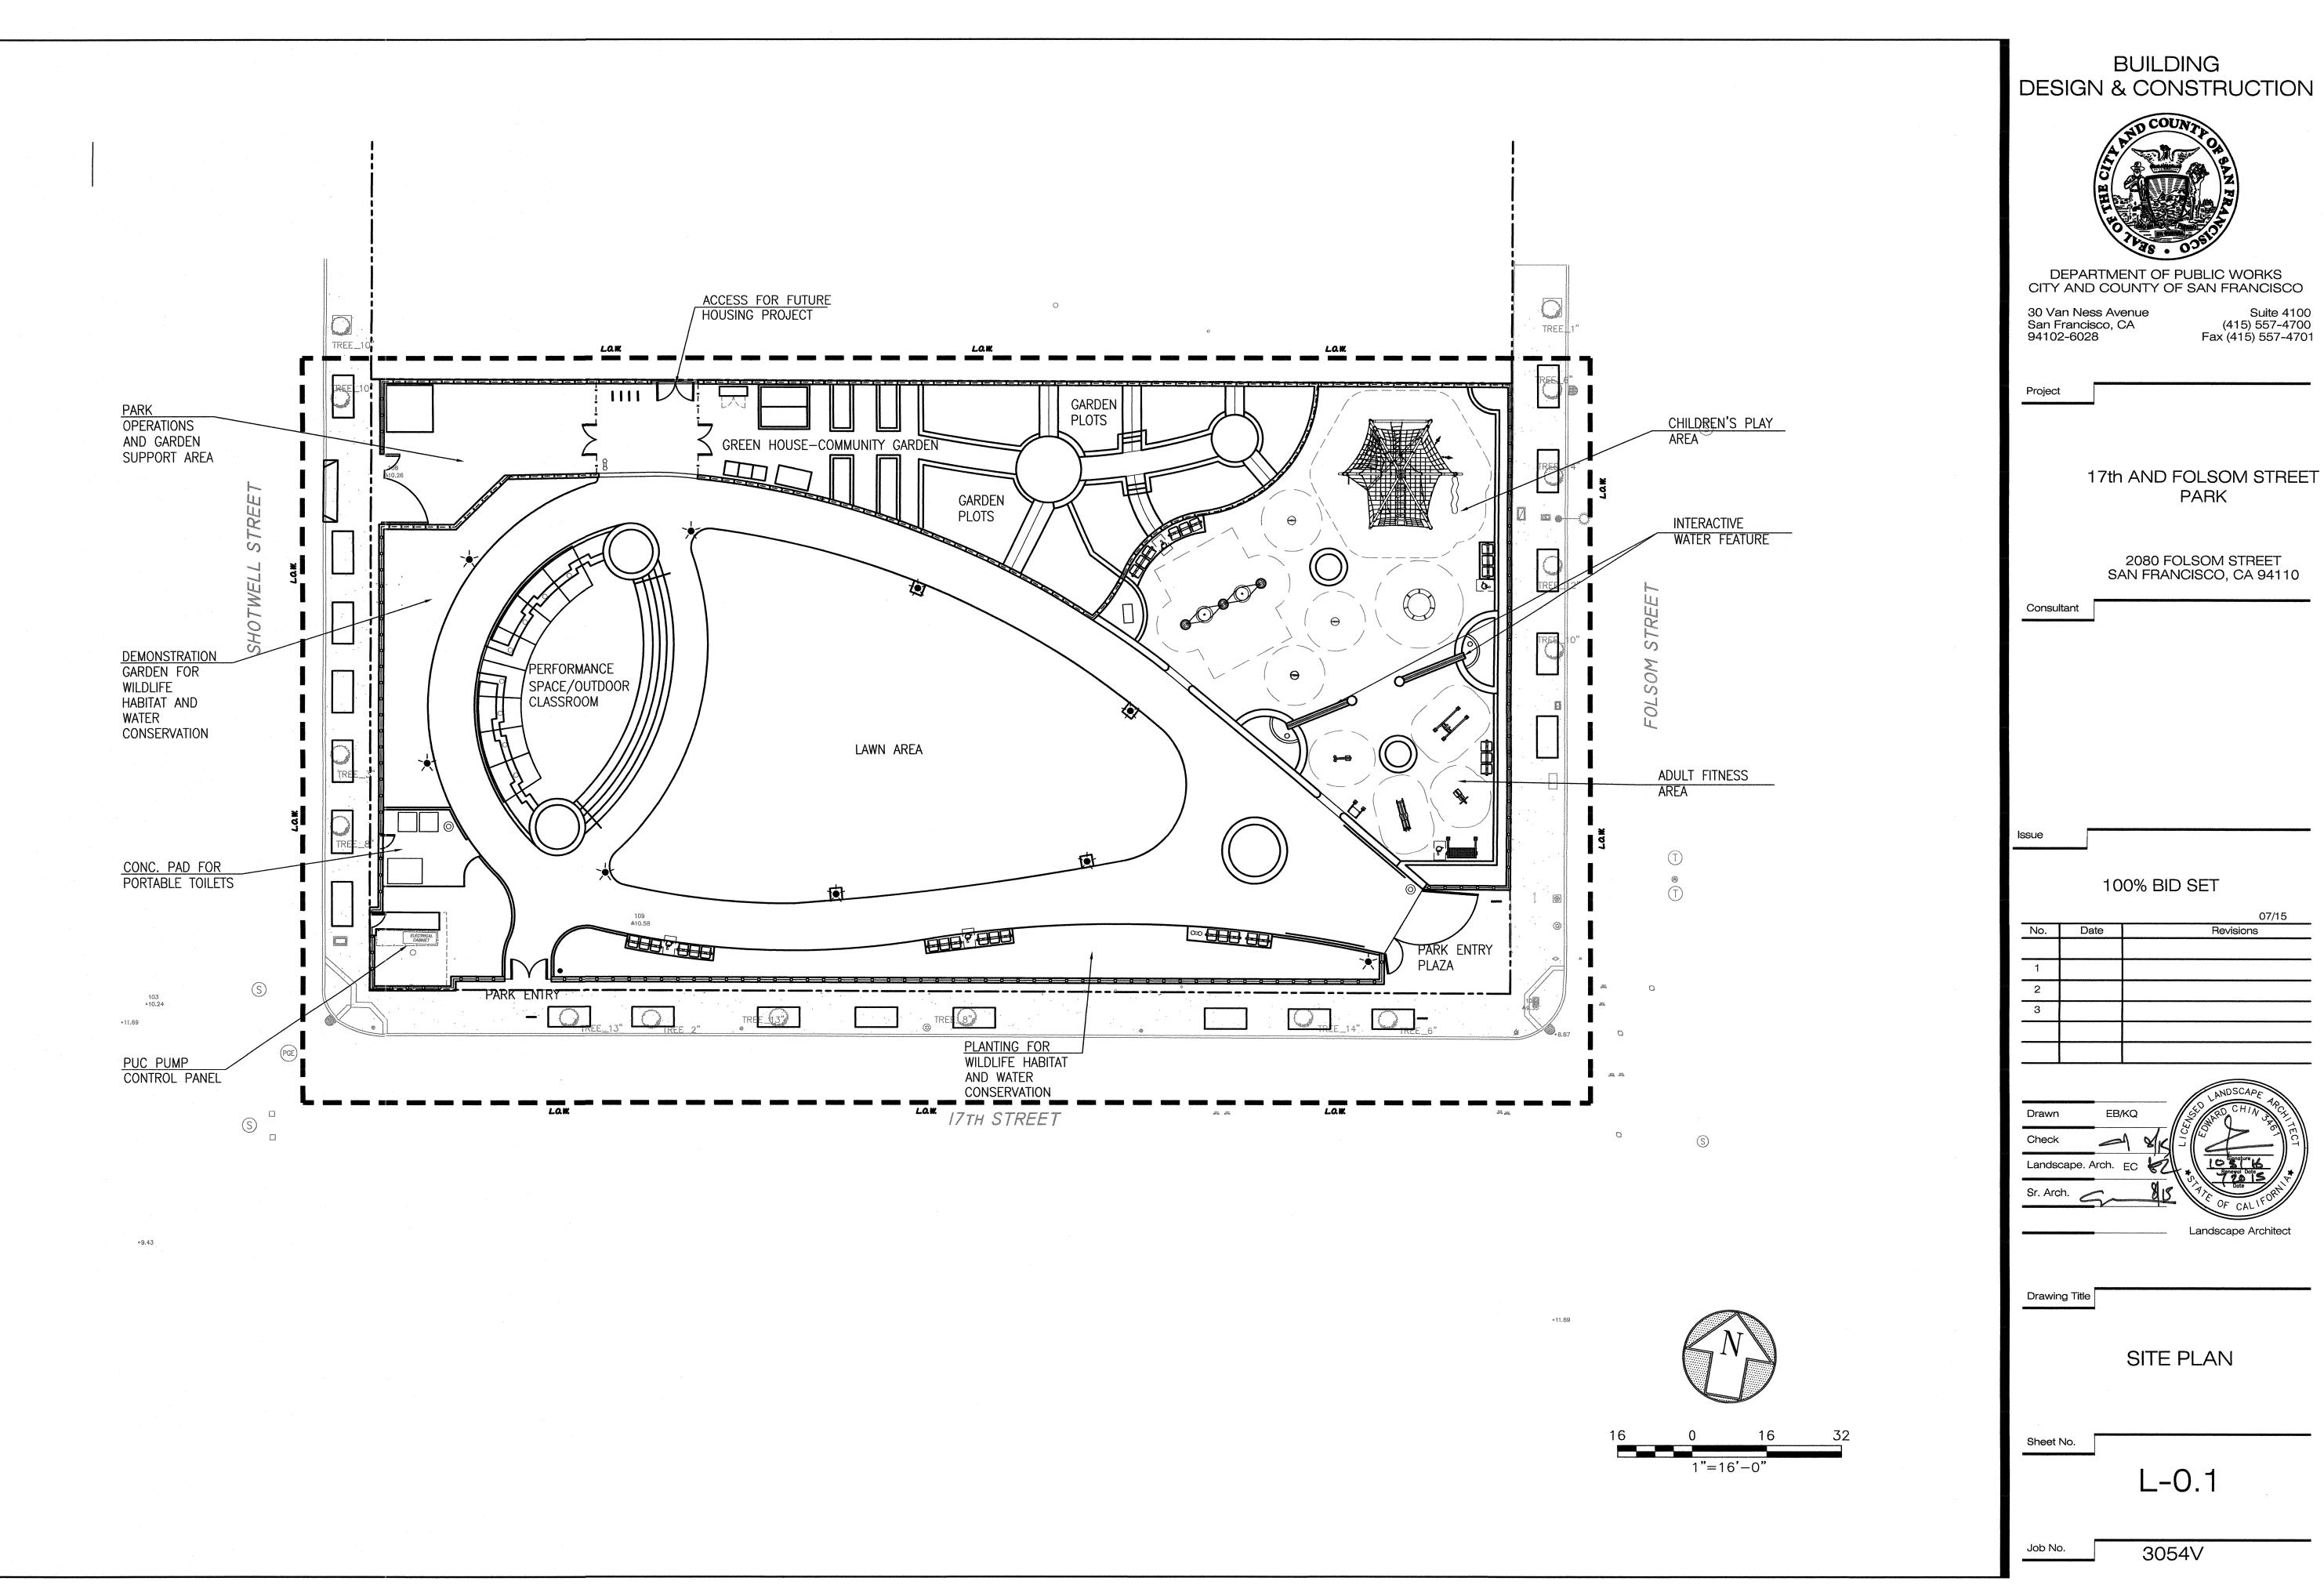
Landscape Architect


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LANDSCAPE GENERAL NOTES AND ABBREVIATIONS

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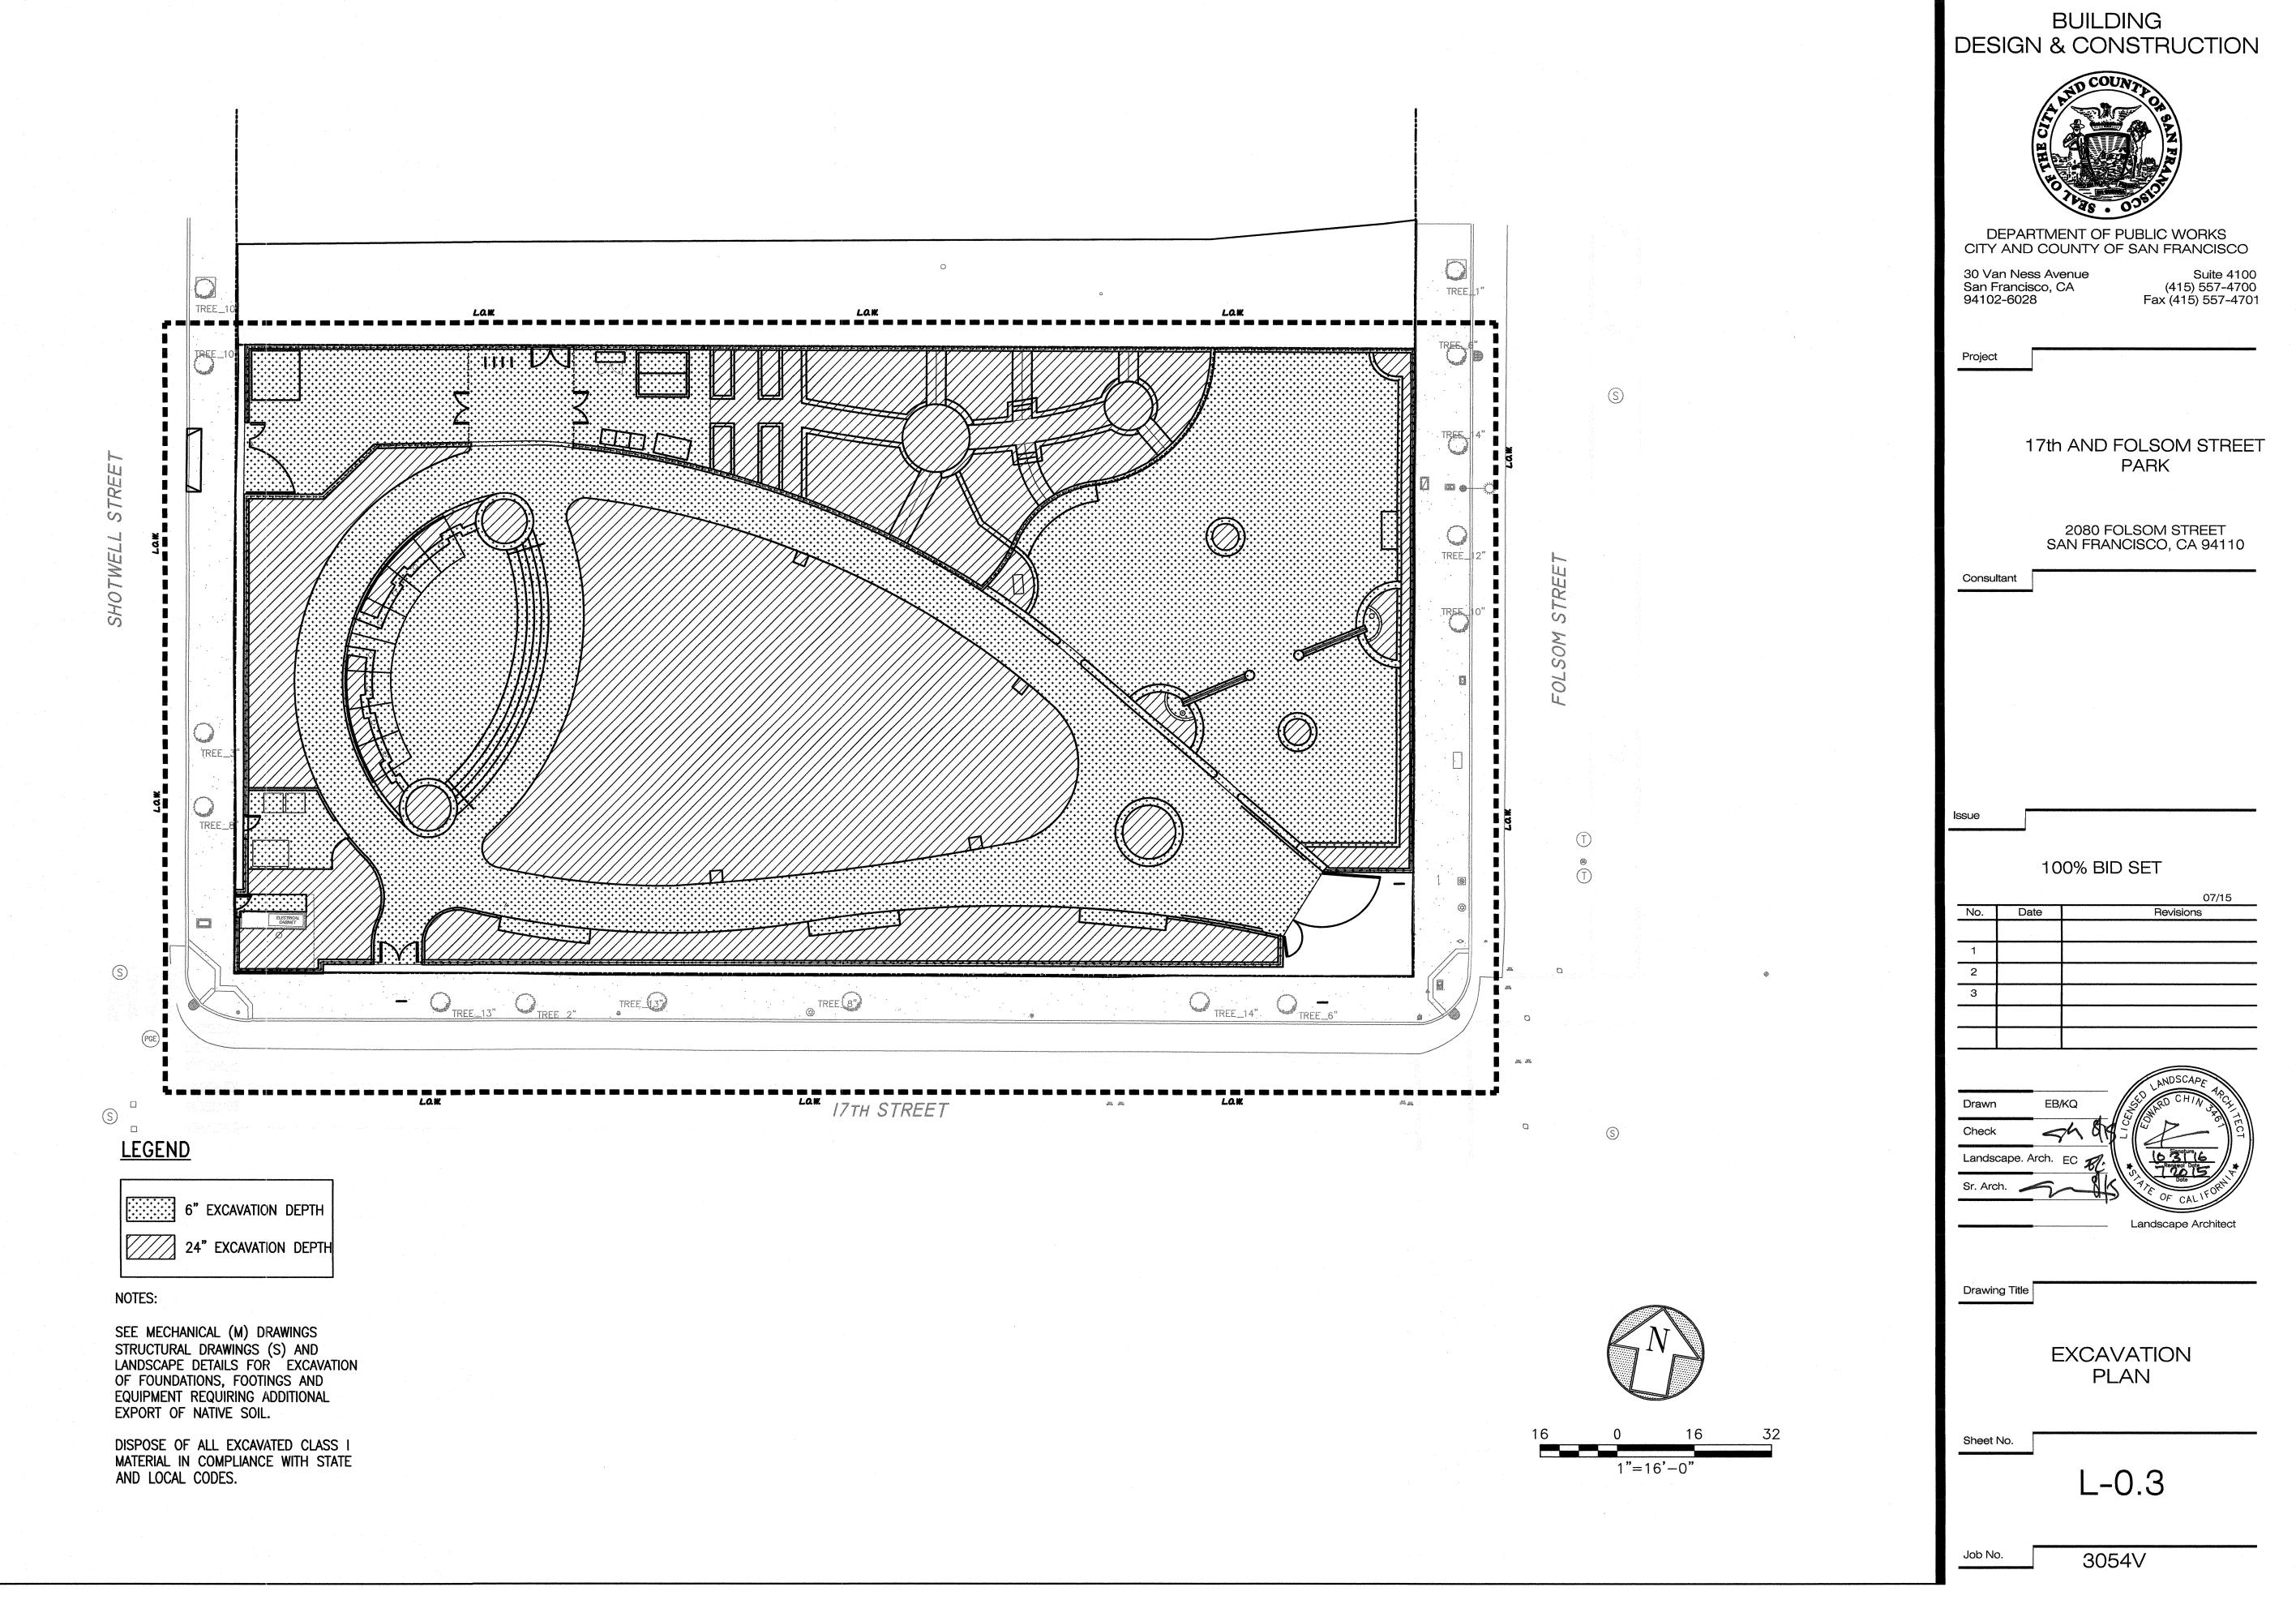
ALTERNATE PLAN


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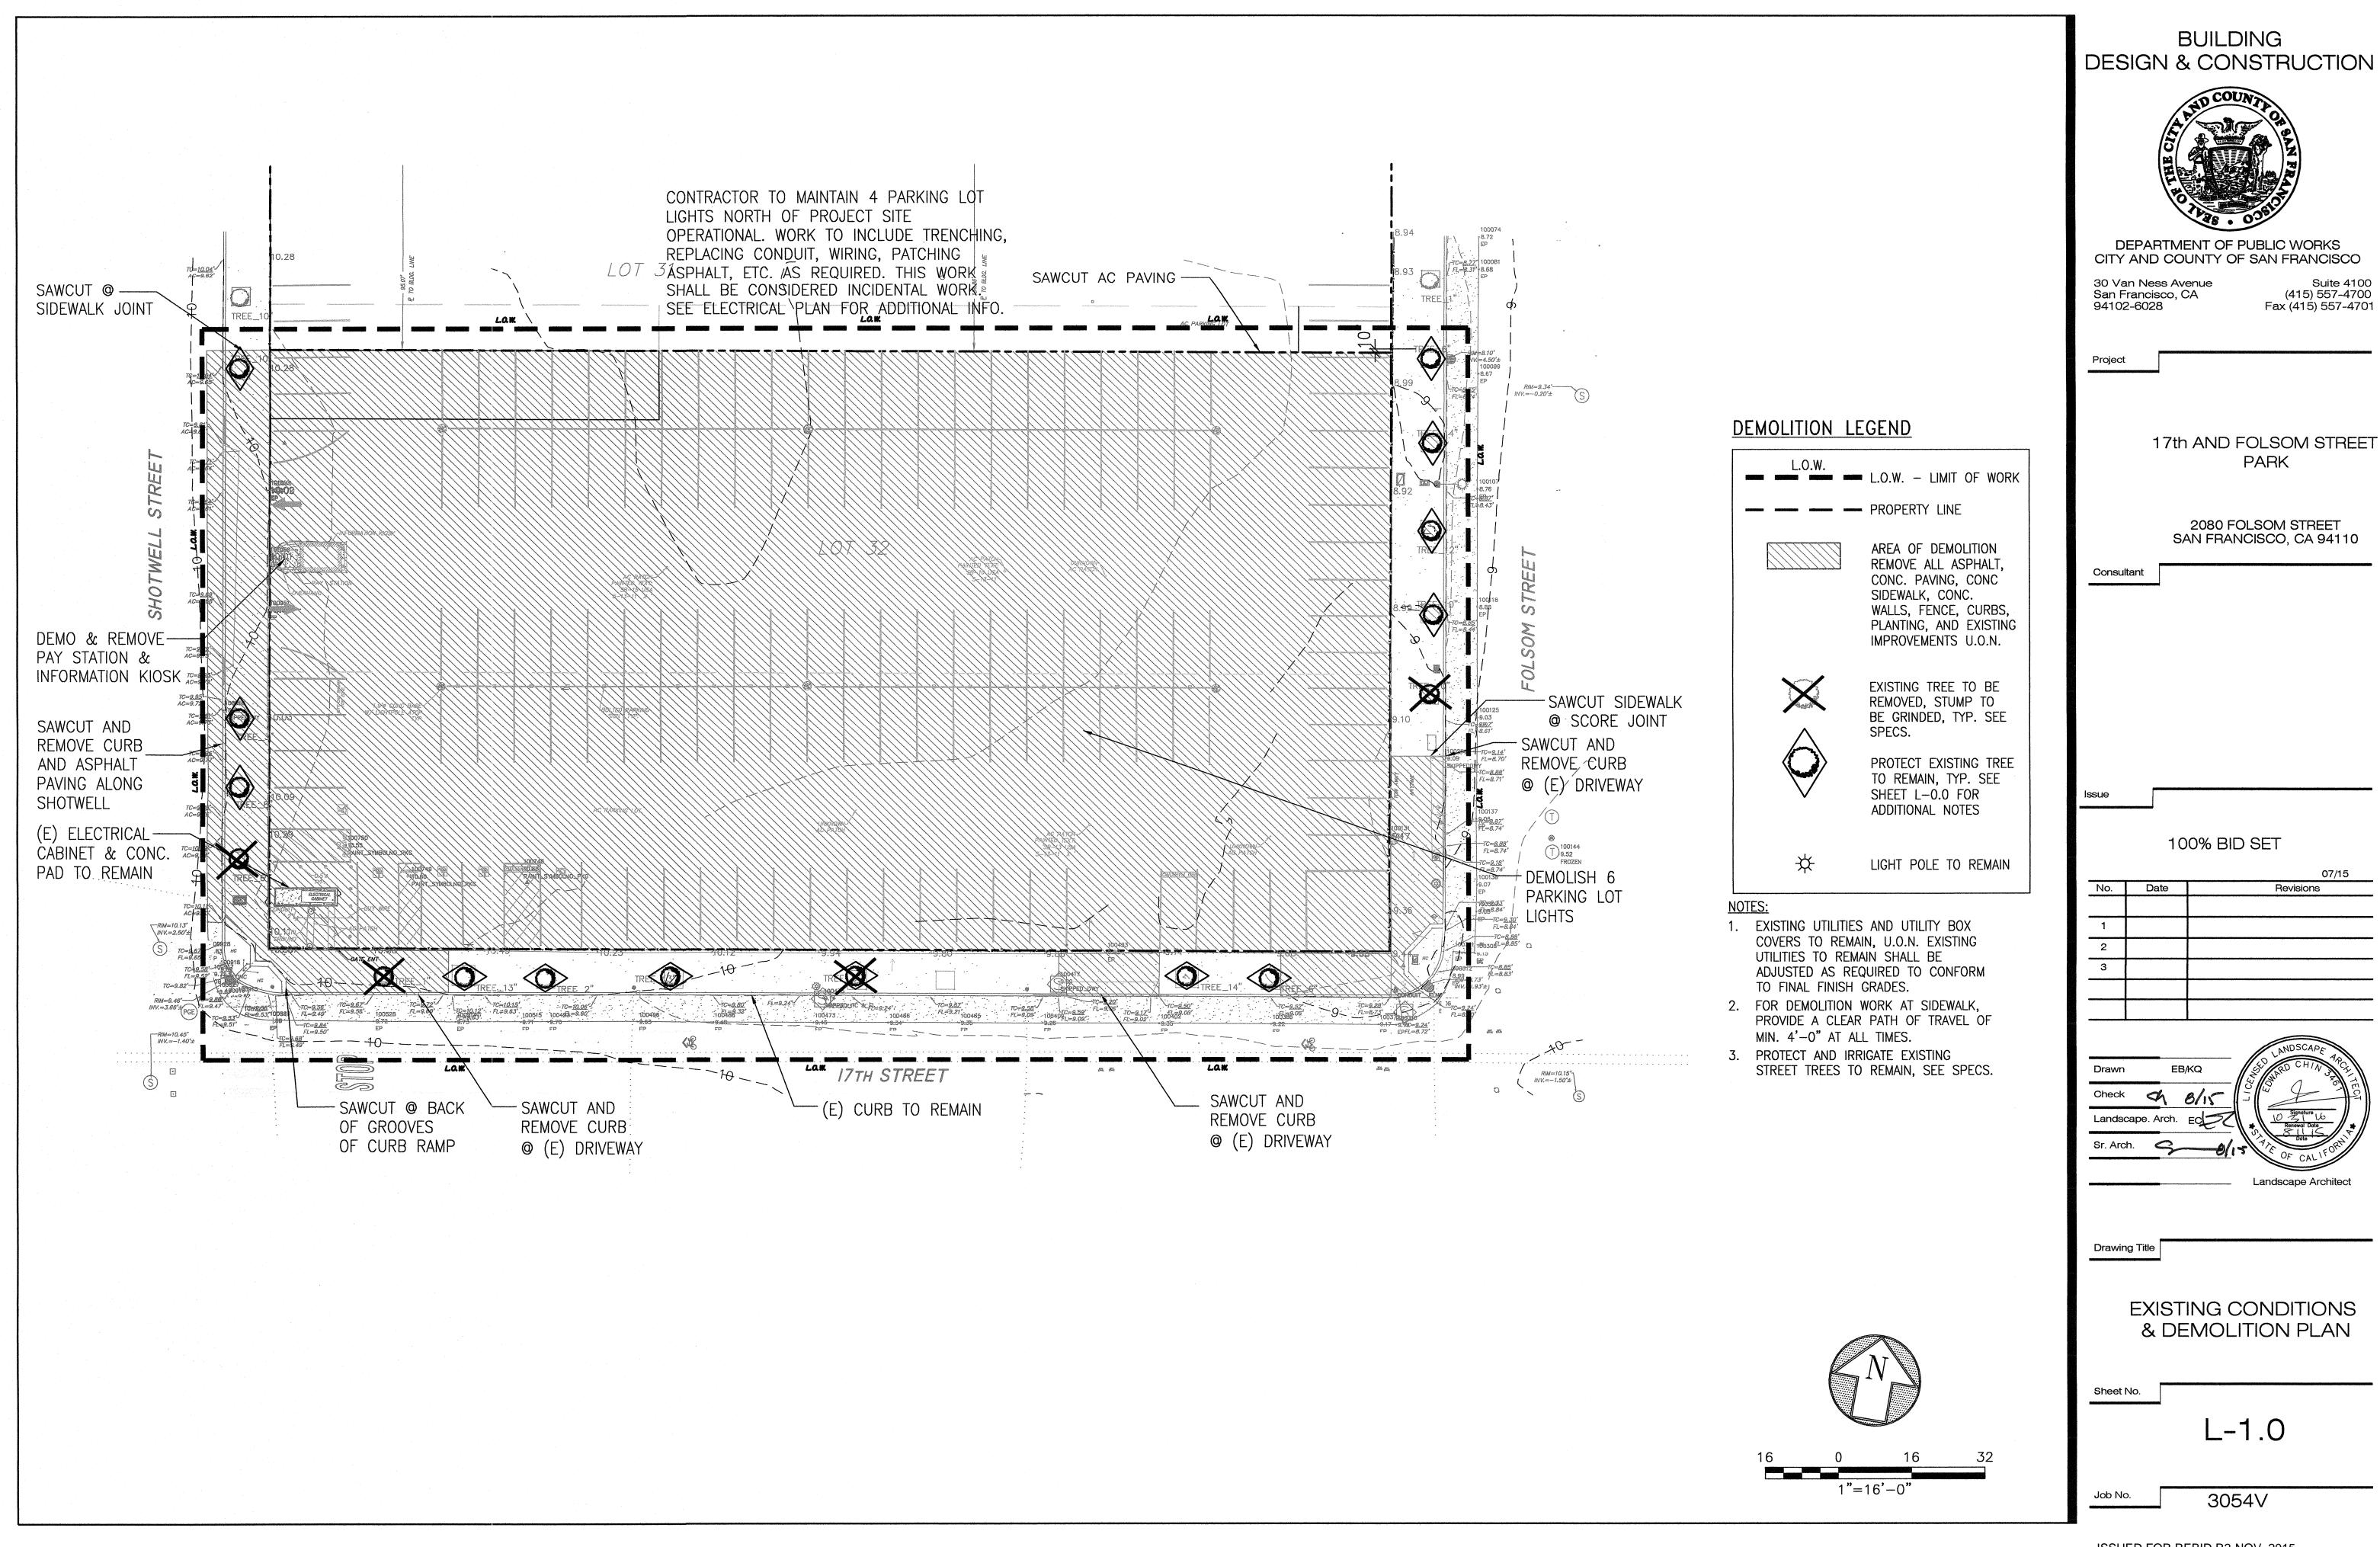
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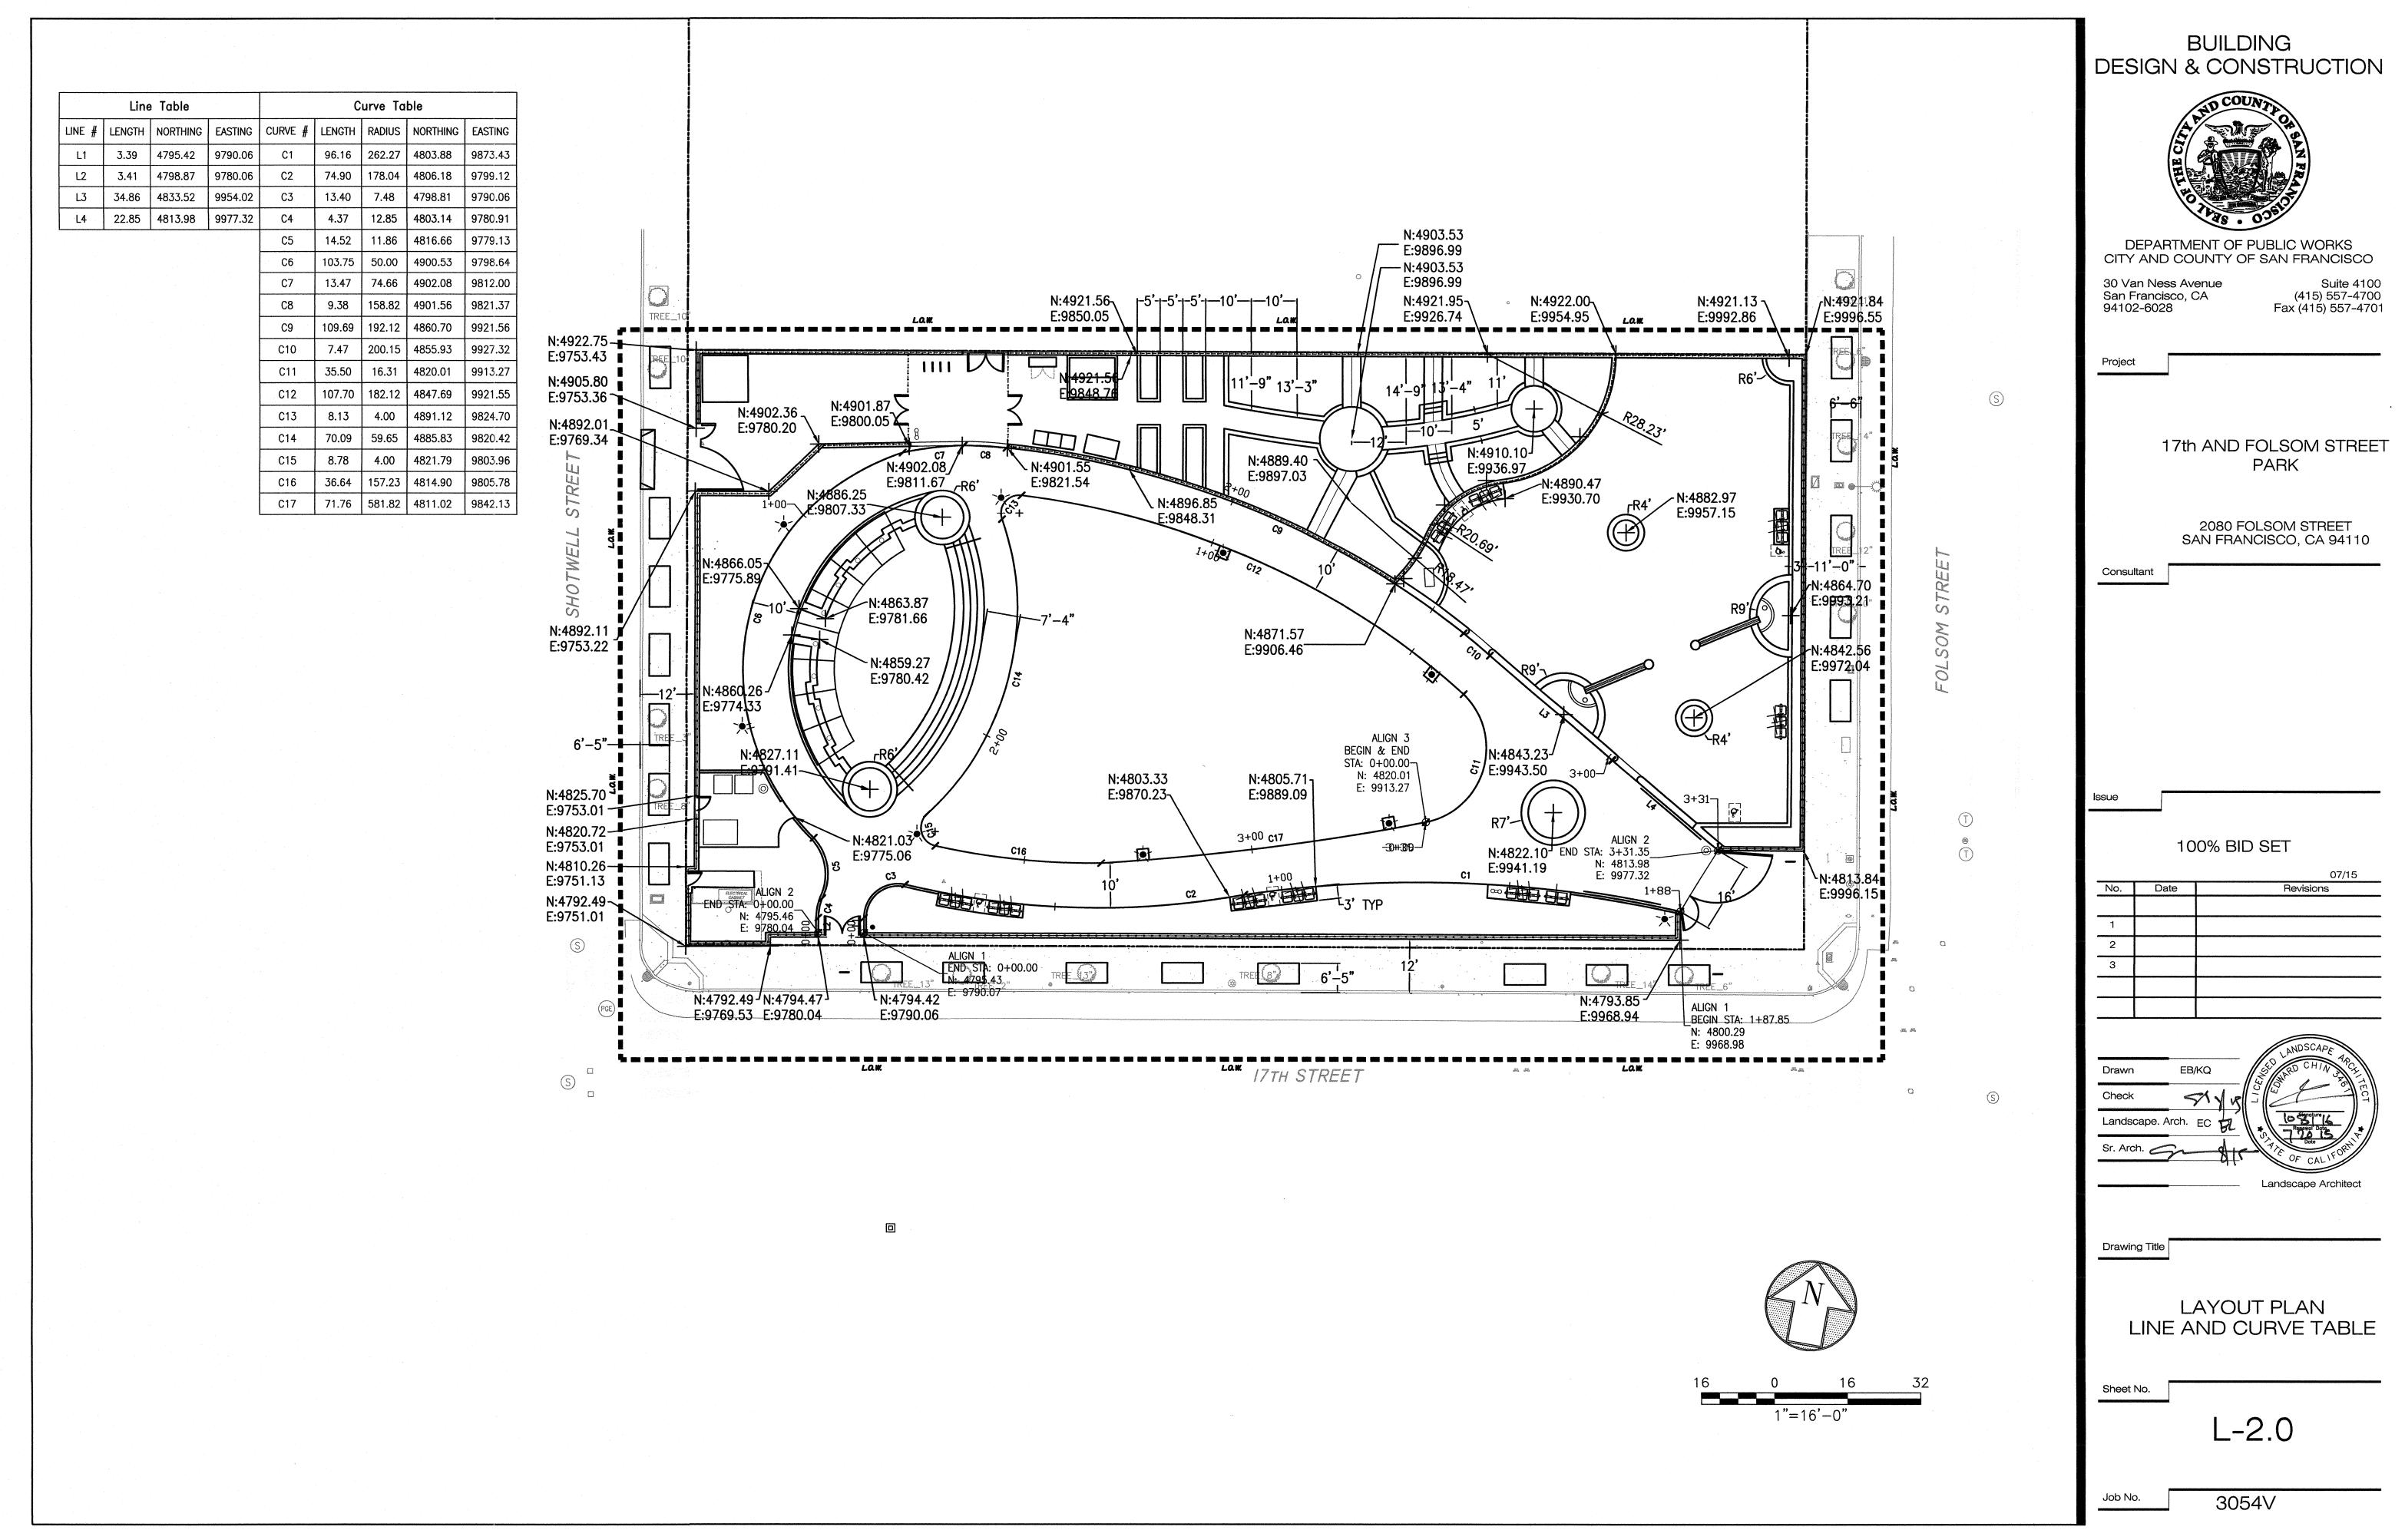
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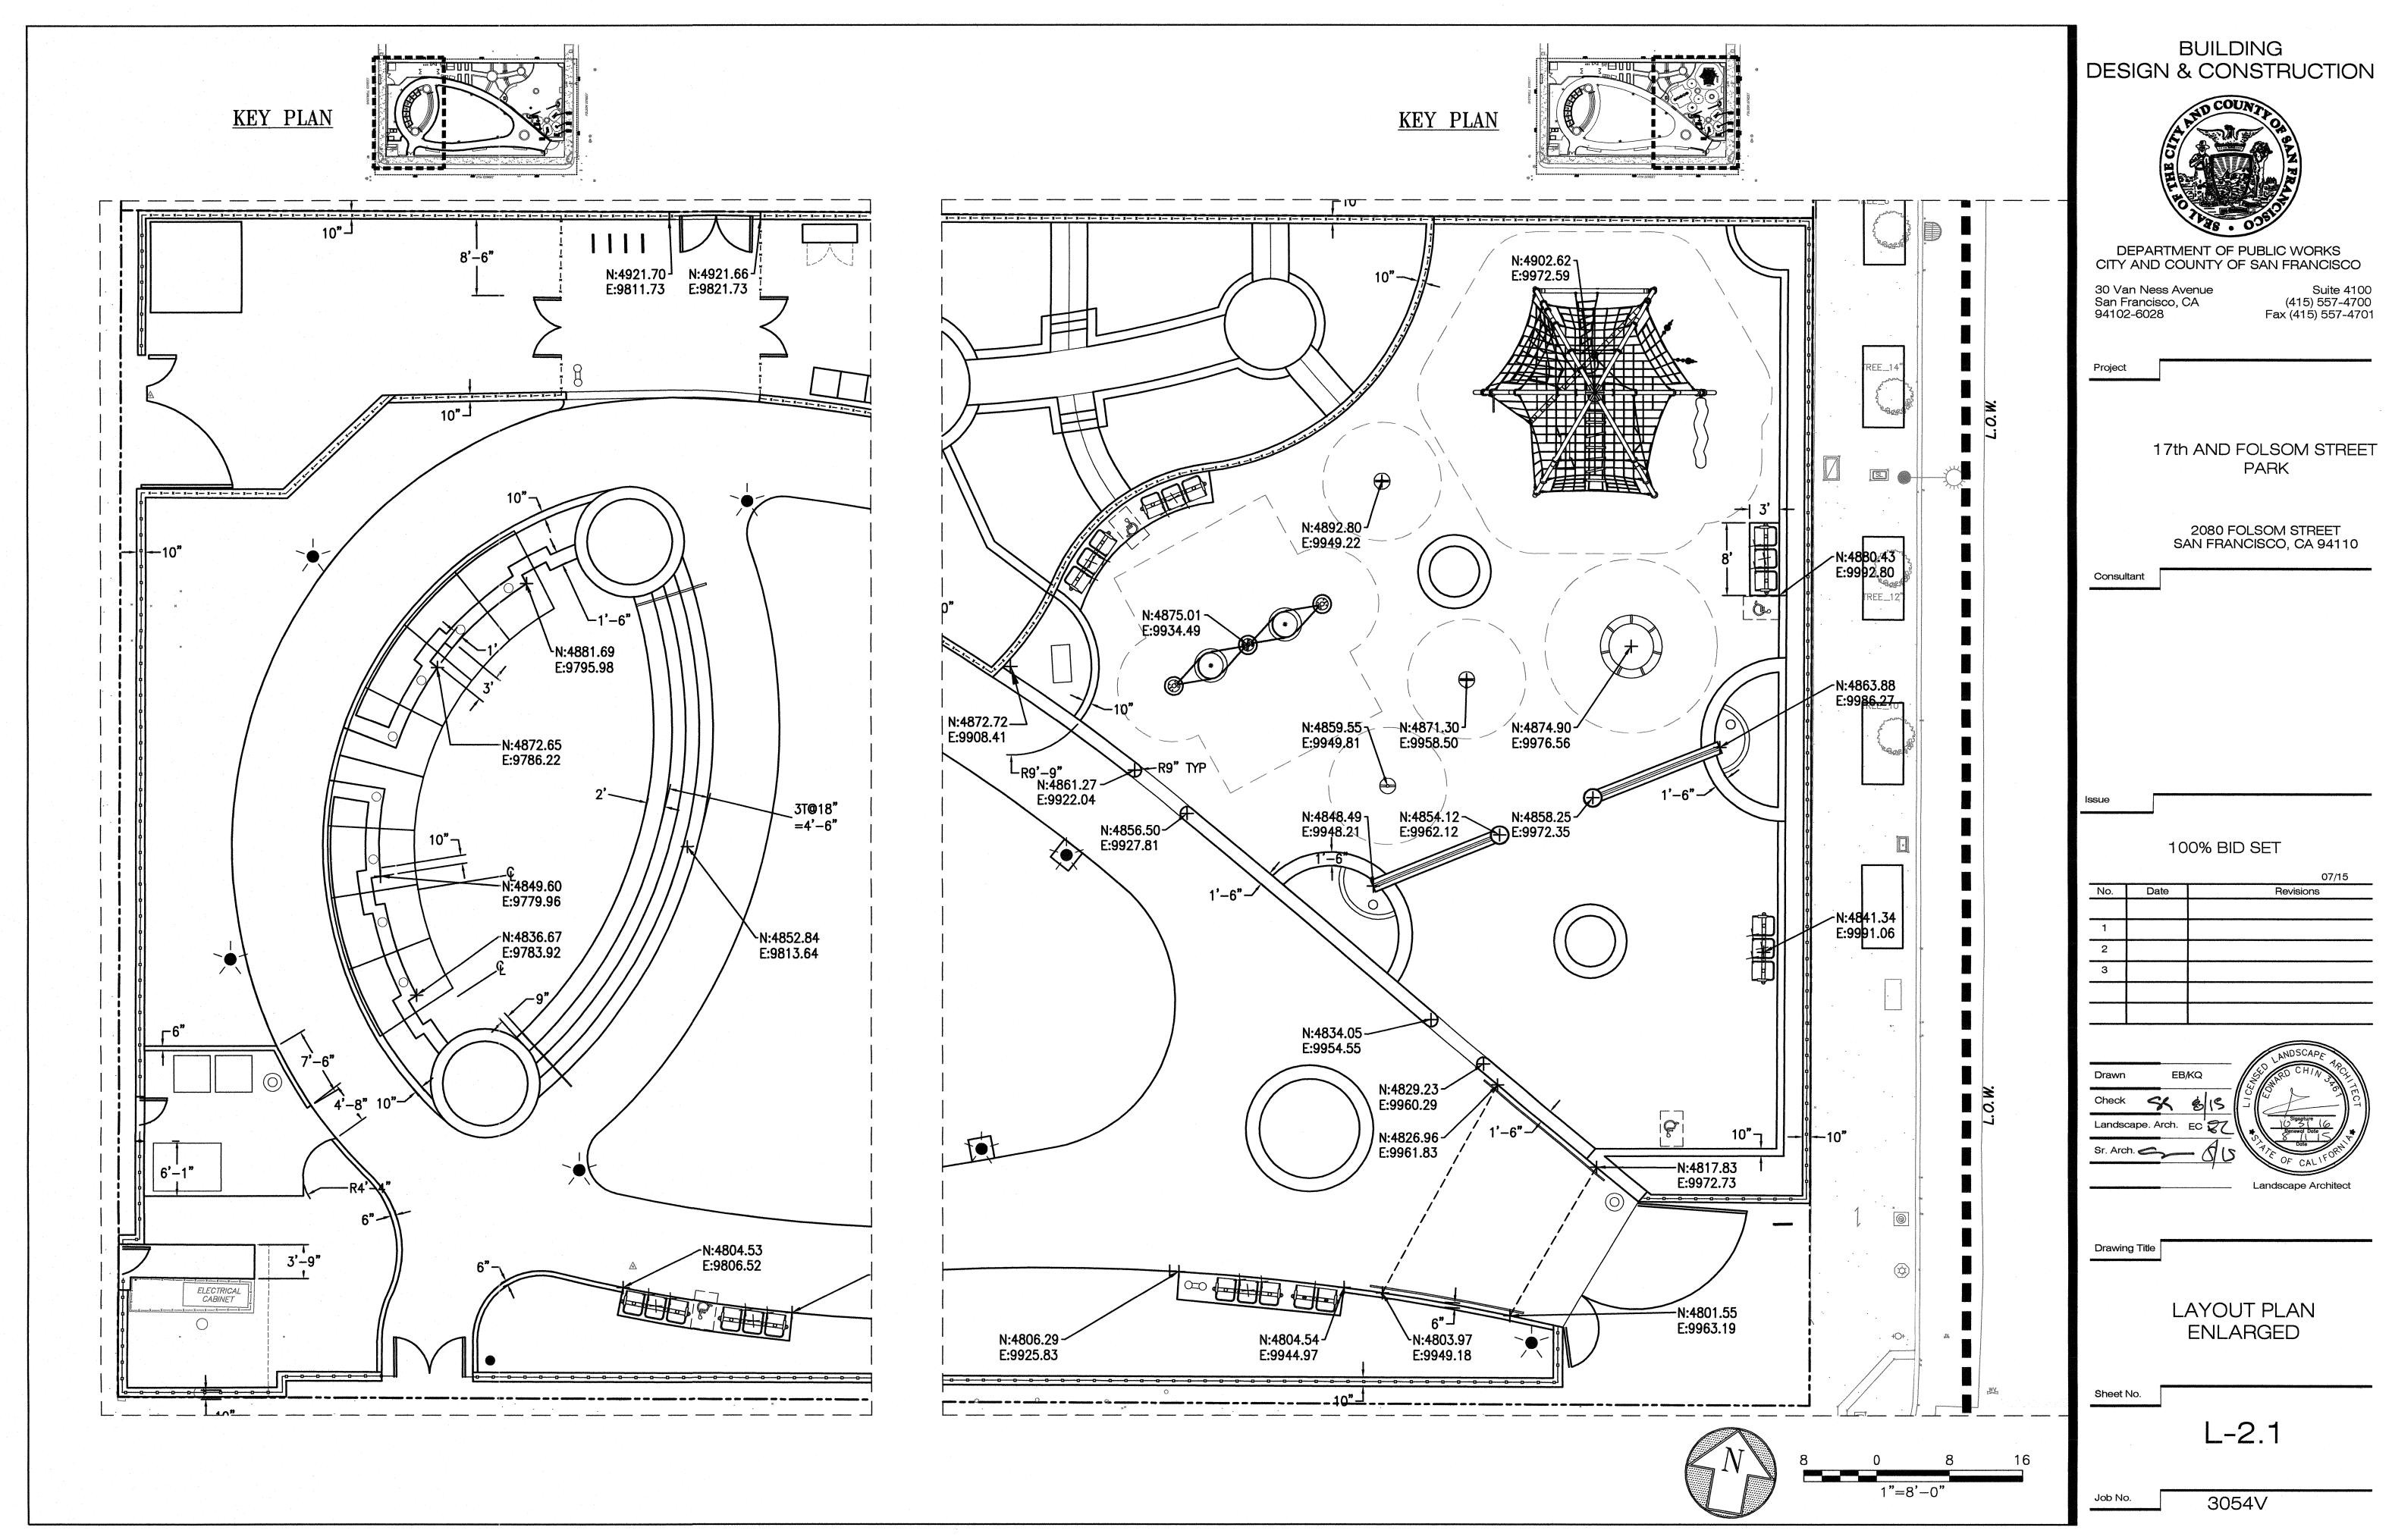
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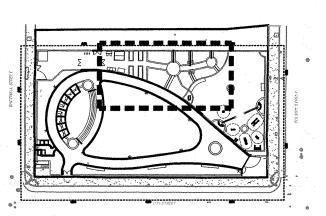







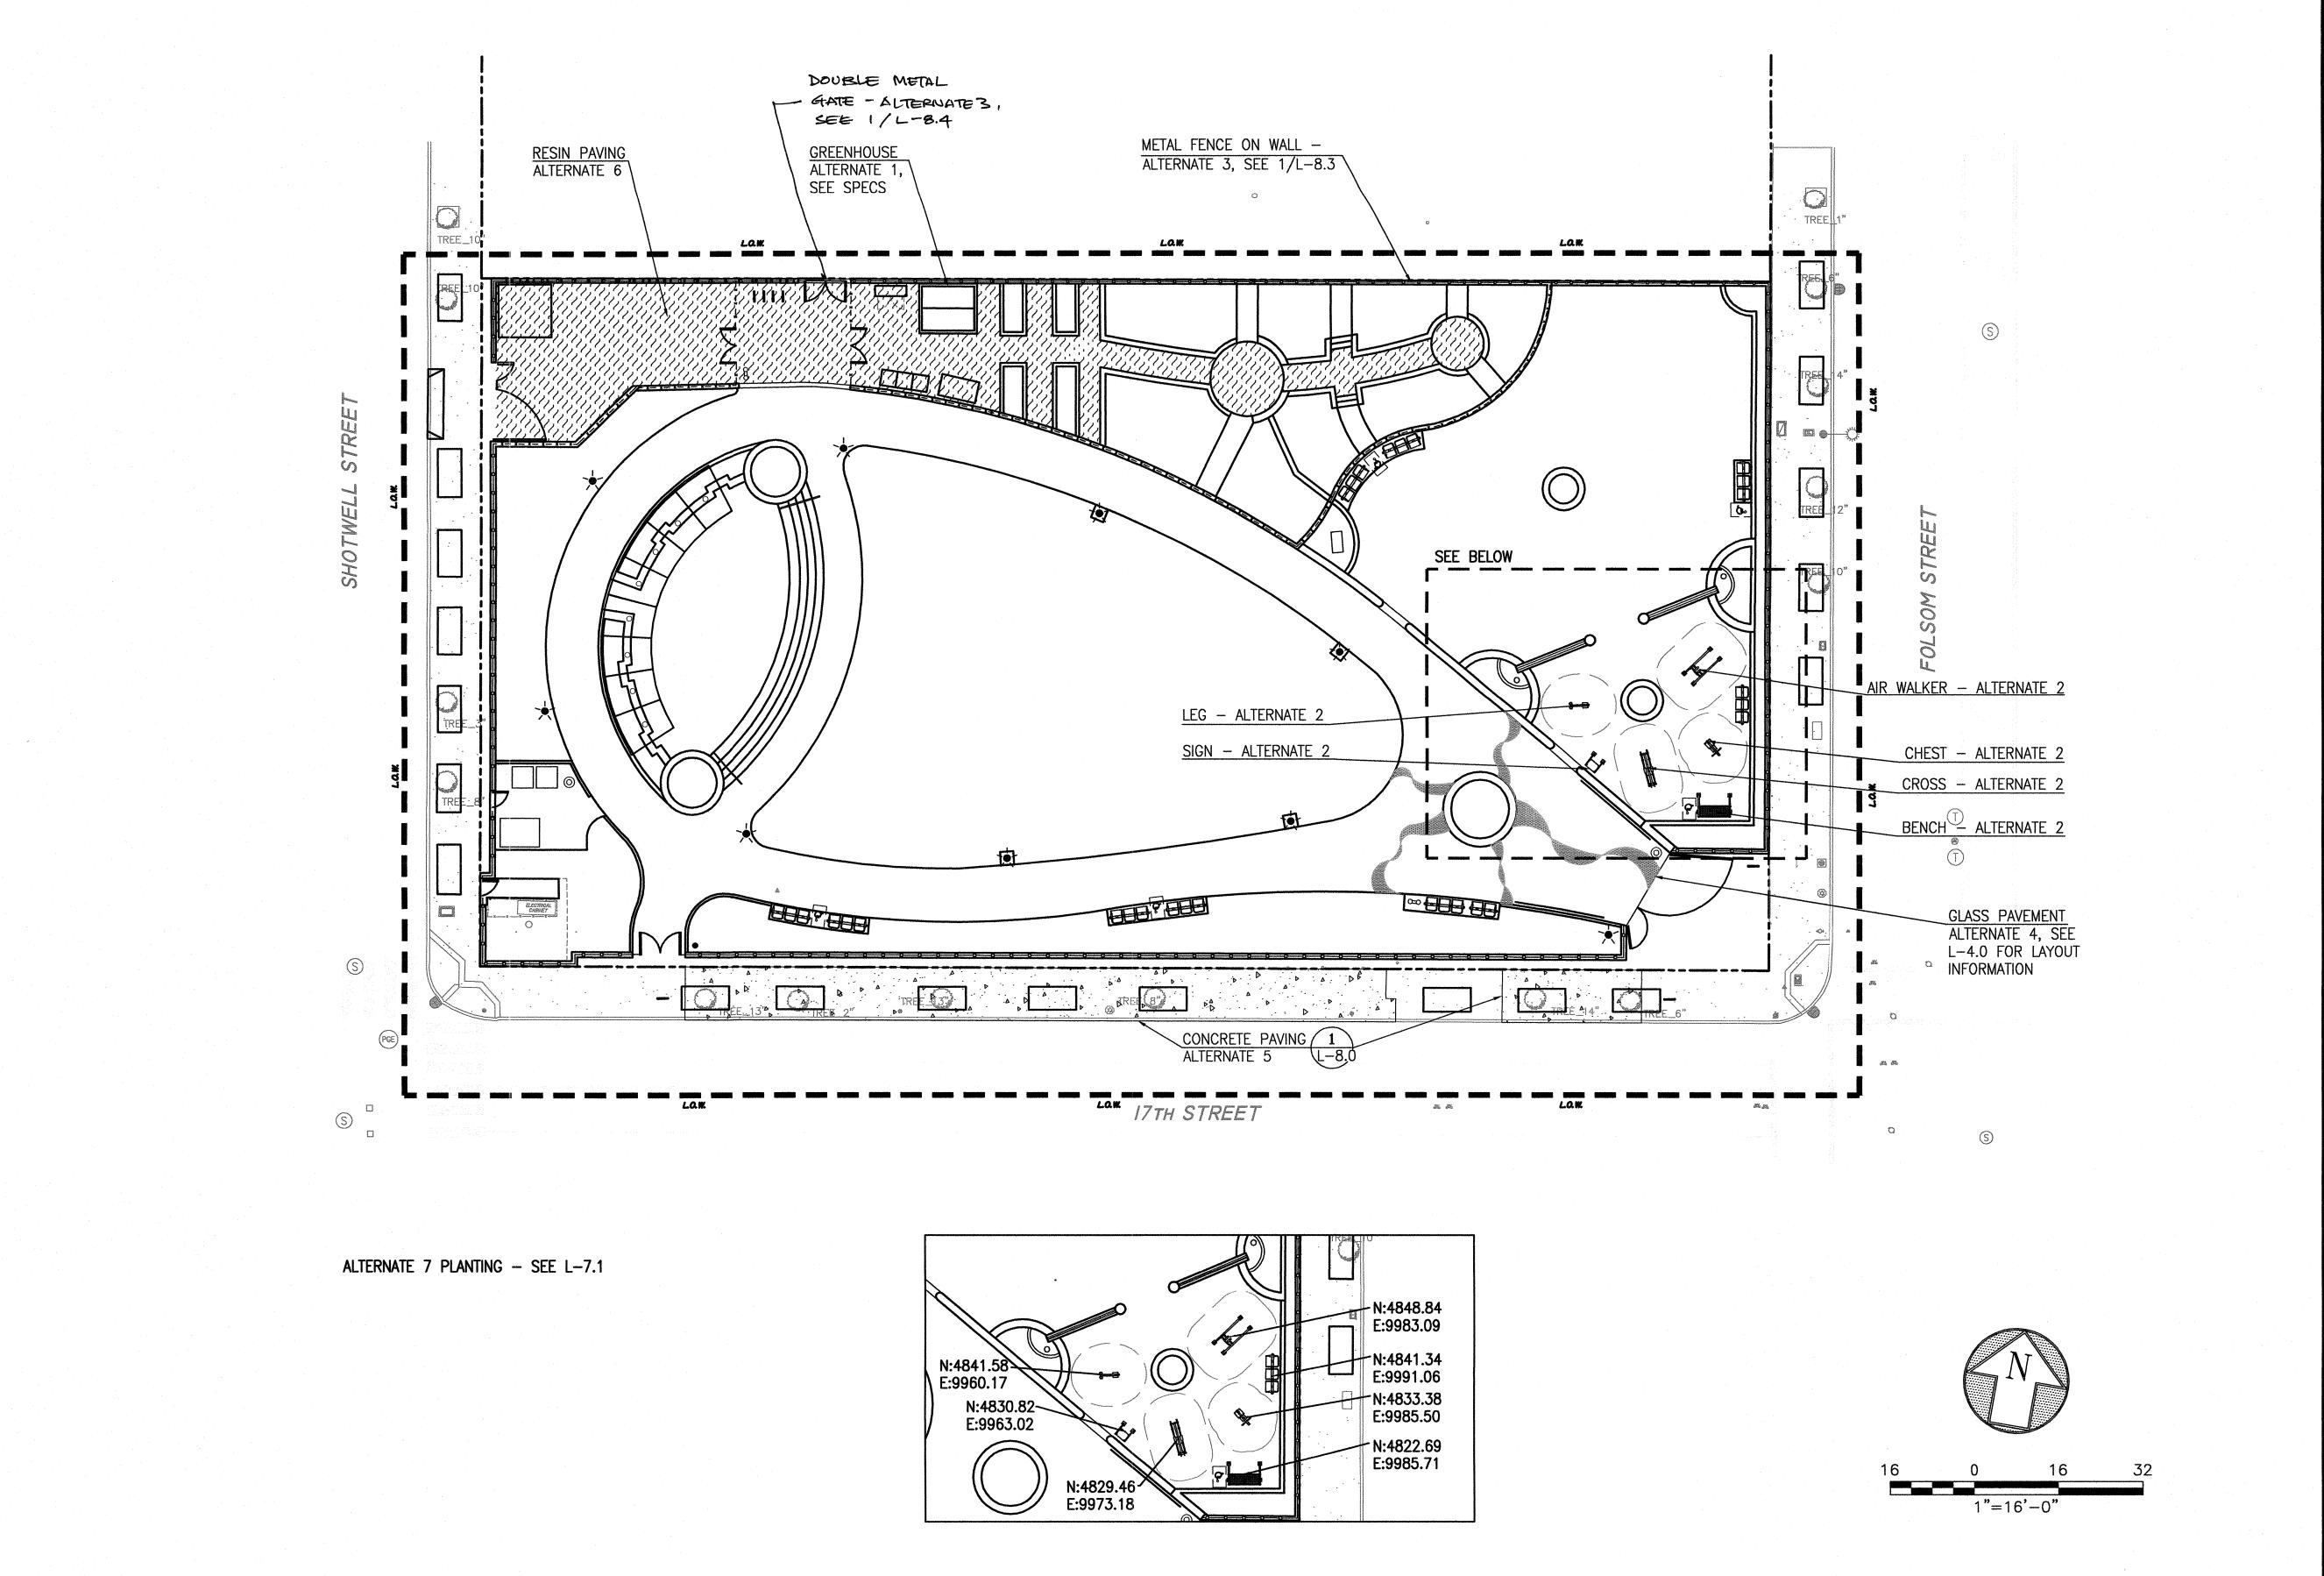

KEY PLAN

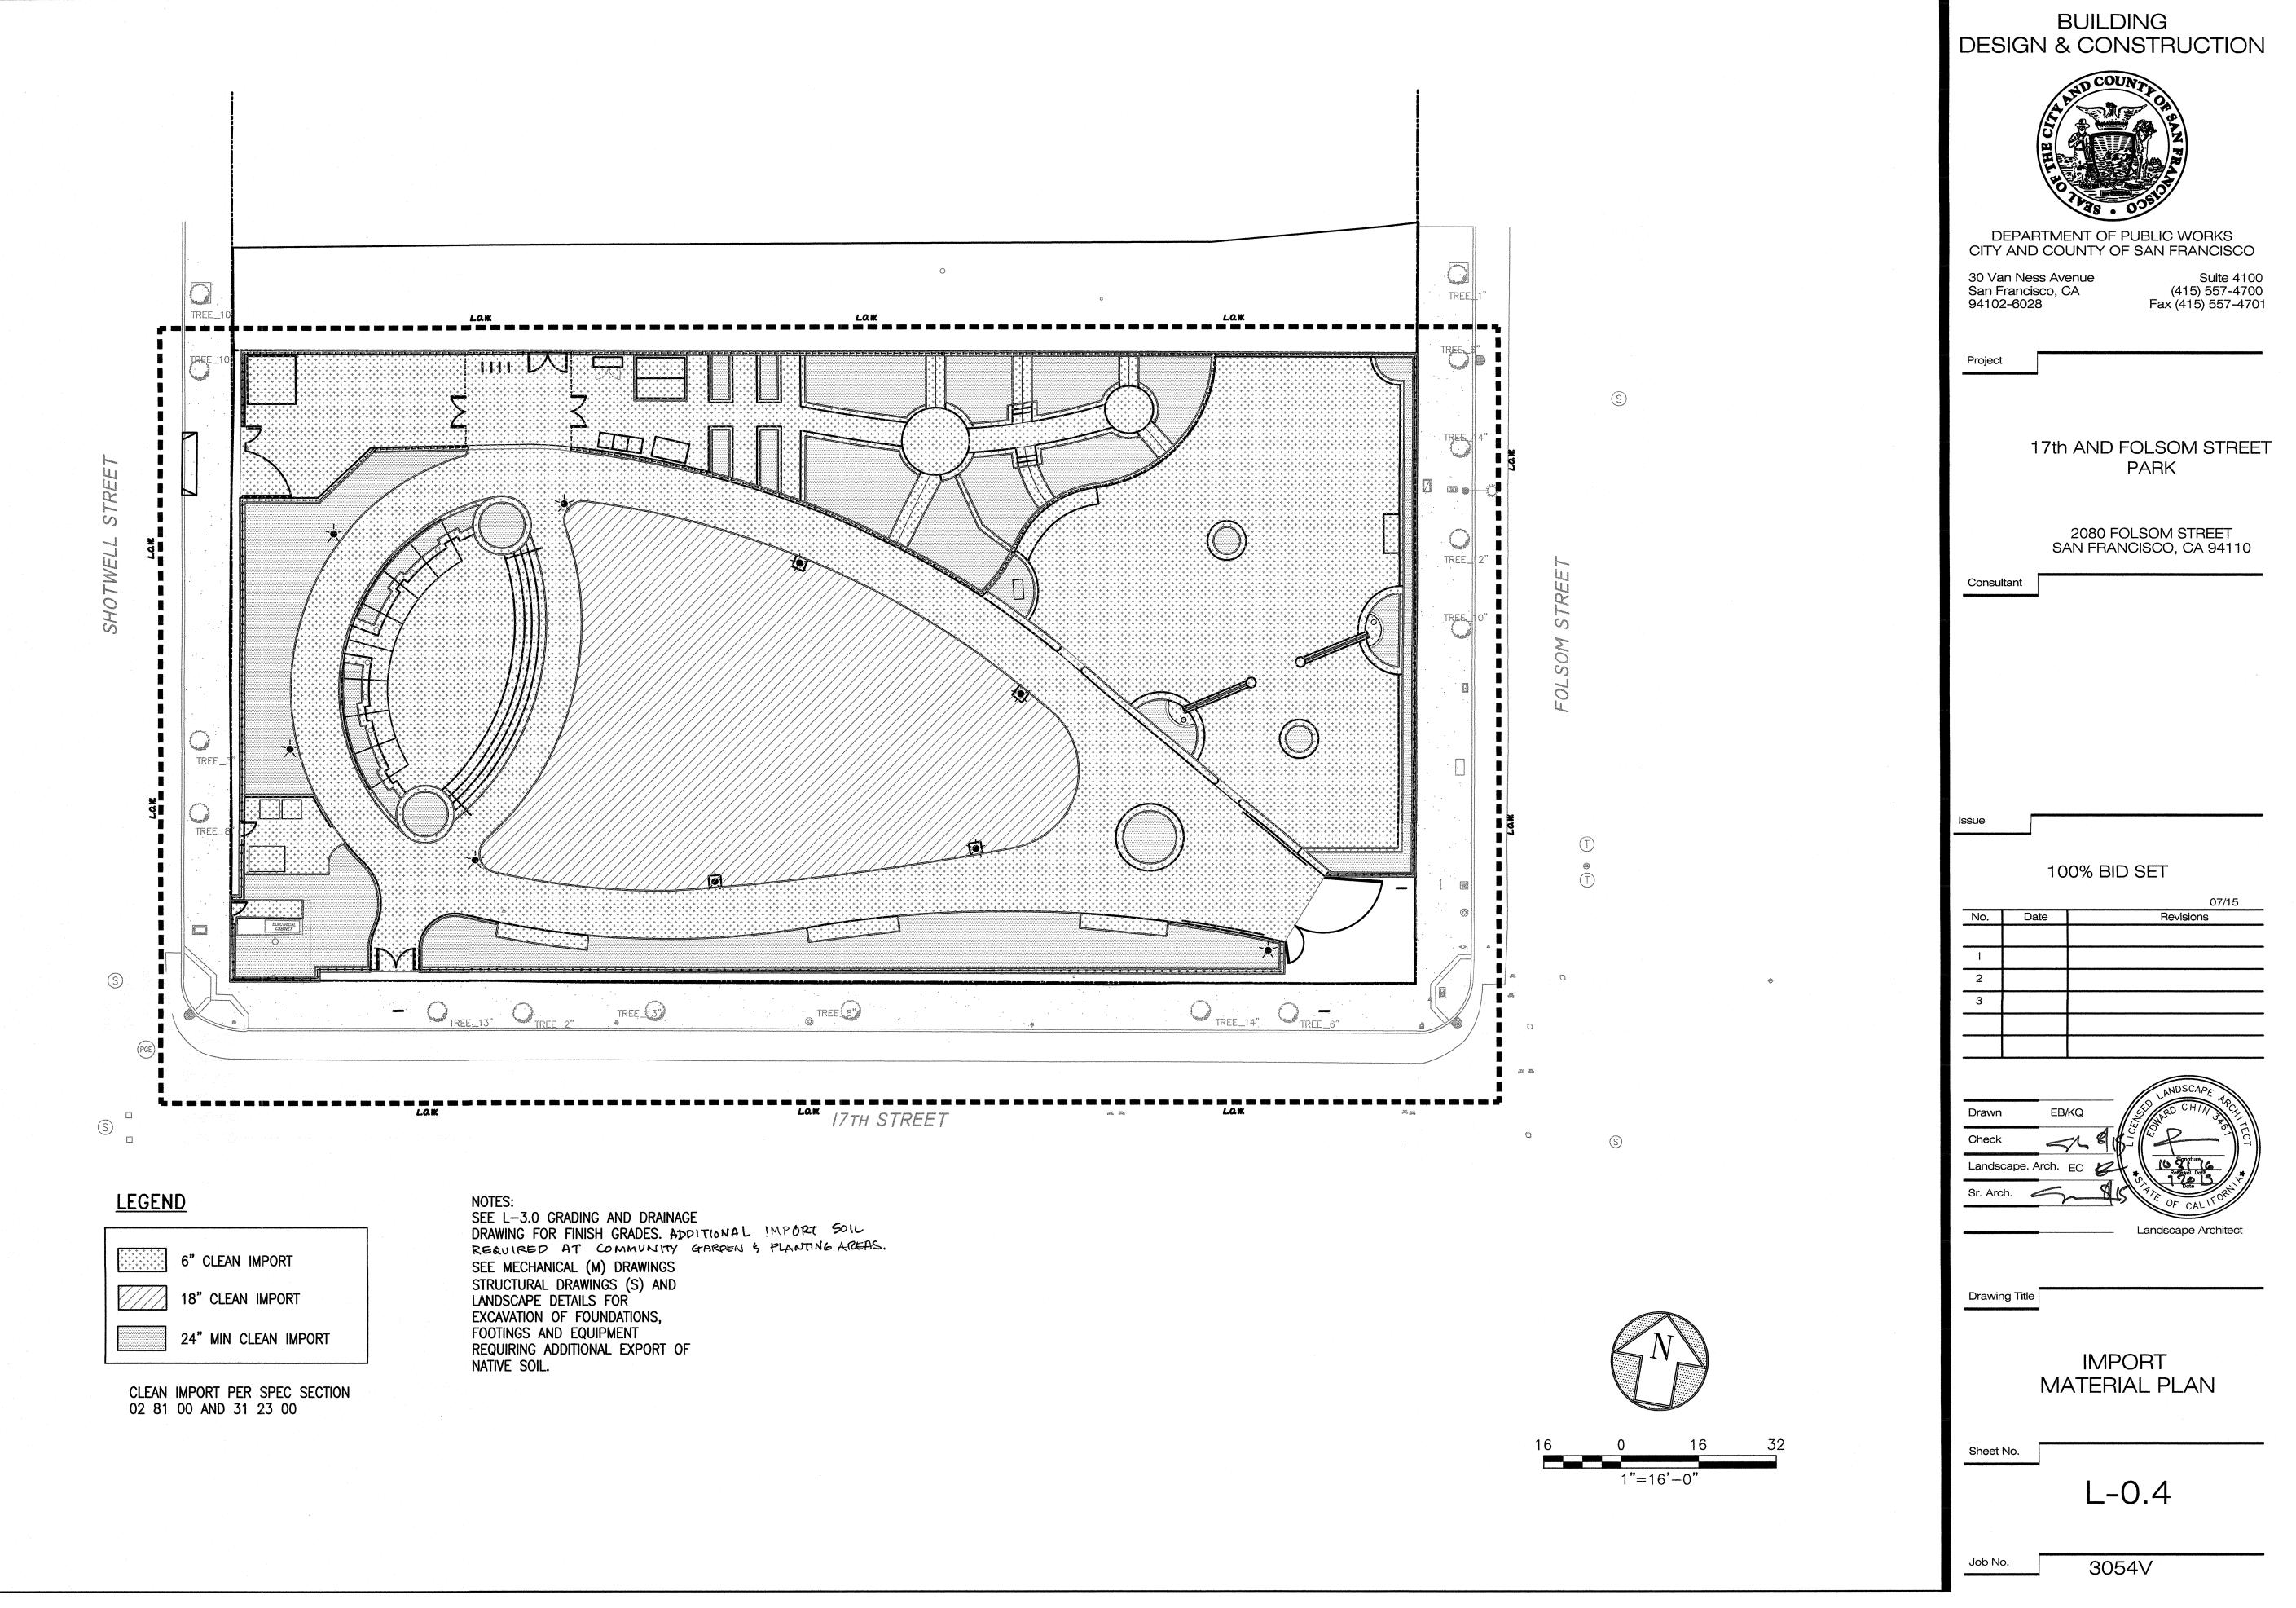

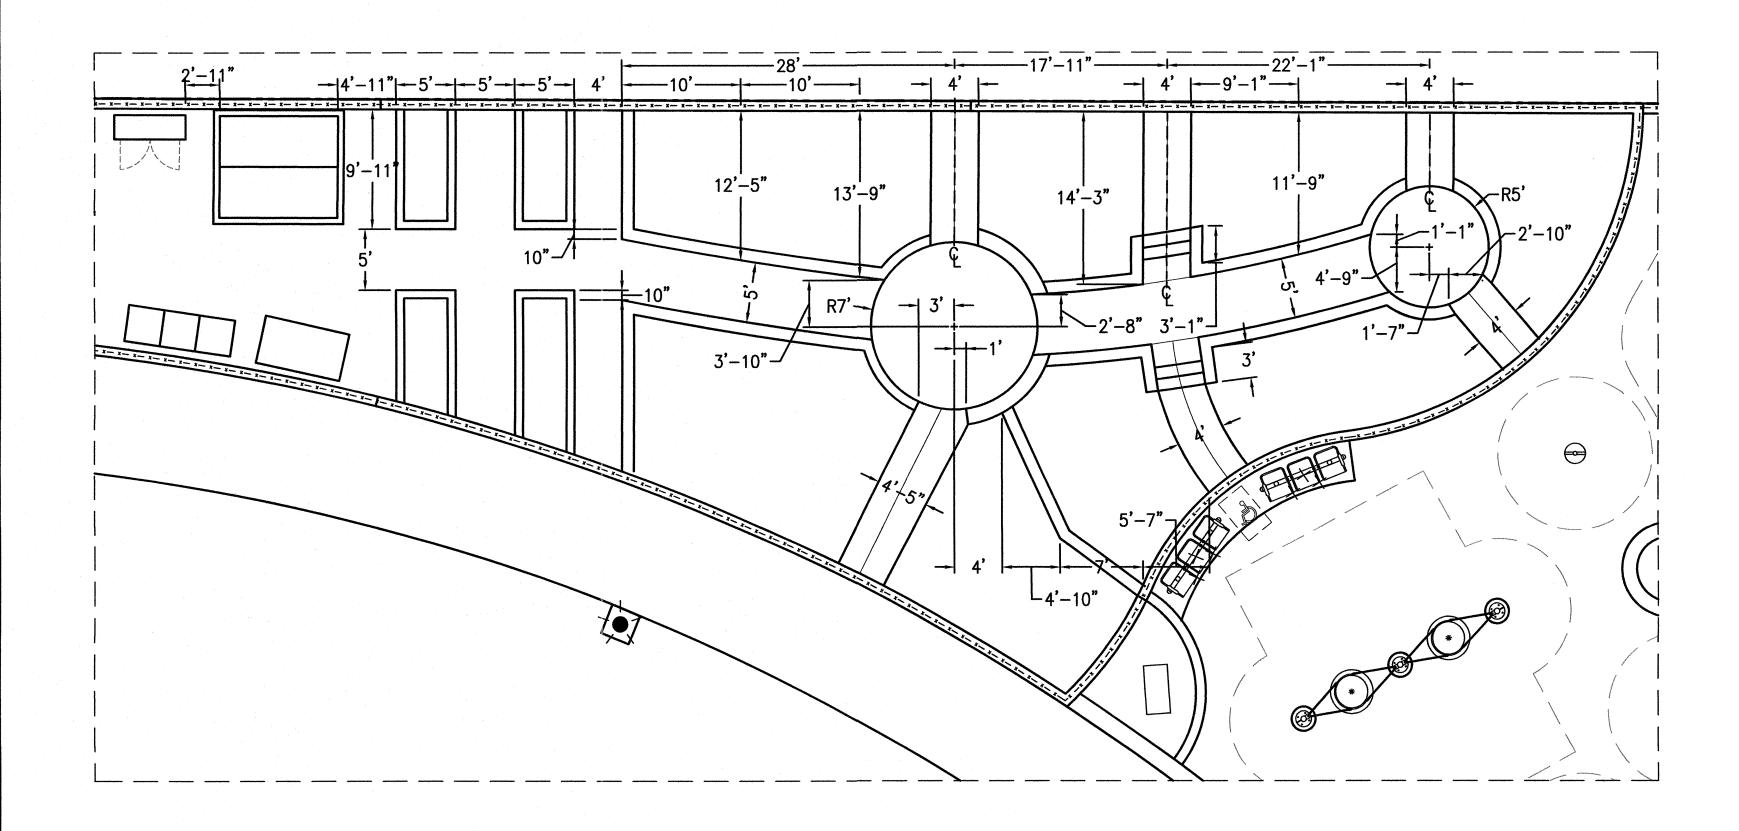

BUILDING DESIGN & CONSTRUCTION



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17th AND FOLSOM STREET PARK

2080 FOLSOM STREET SAN FRANCISCO, CA 94110

Consultant

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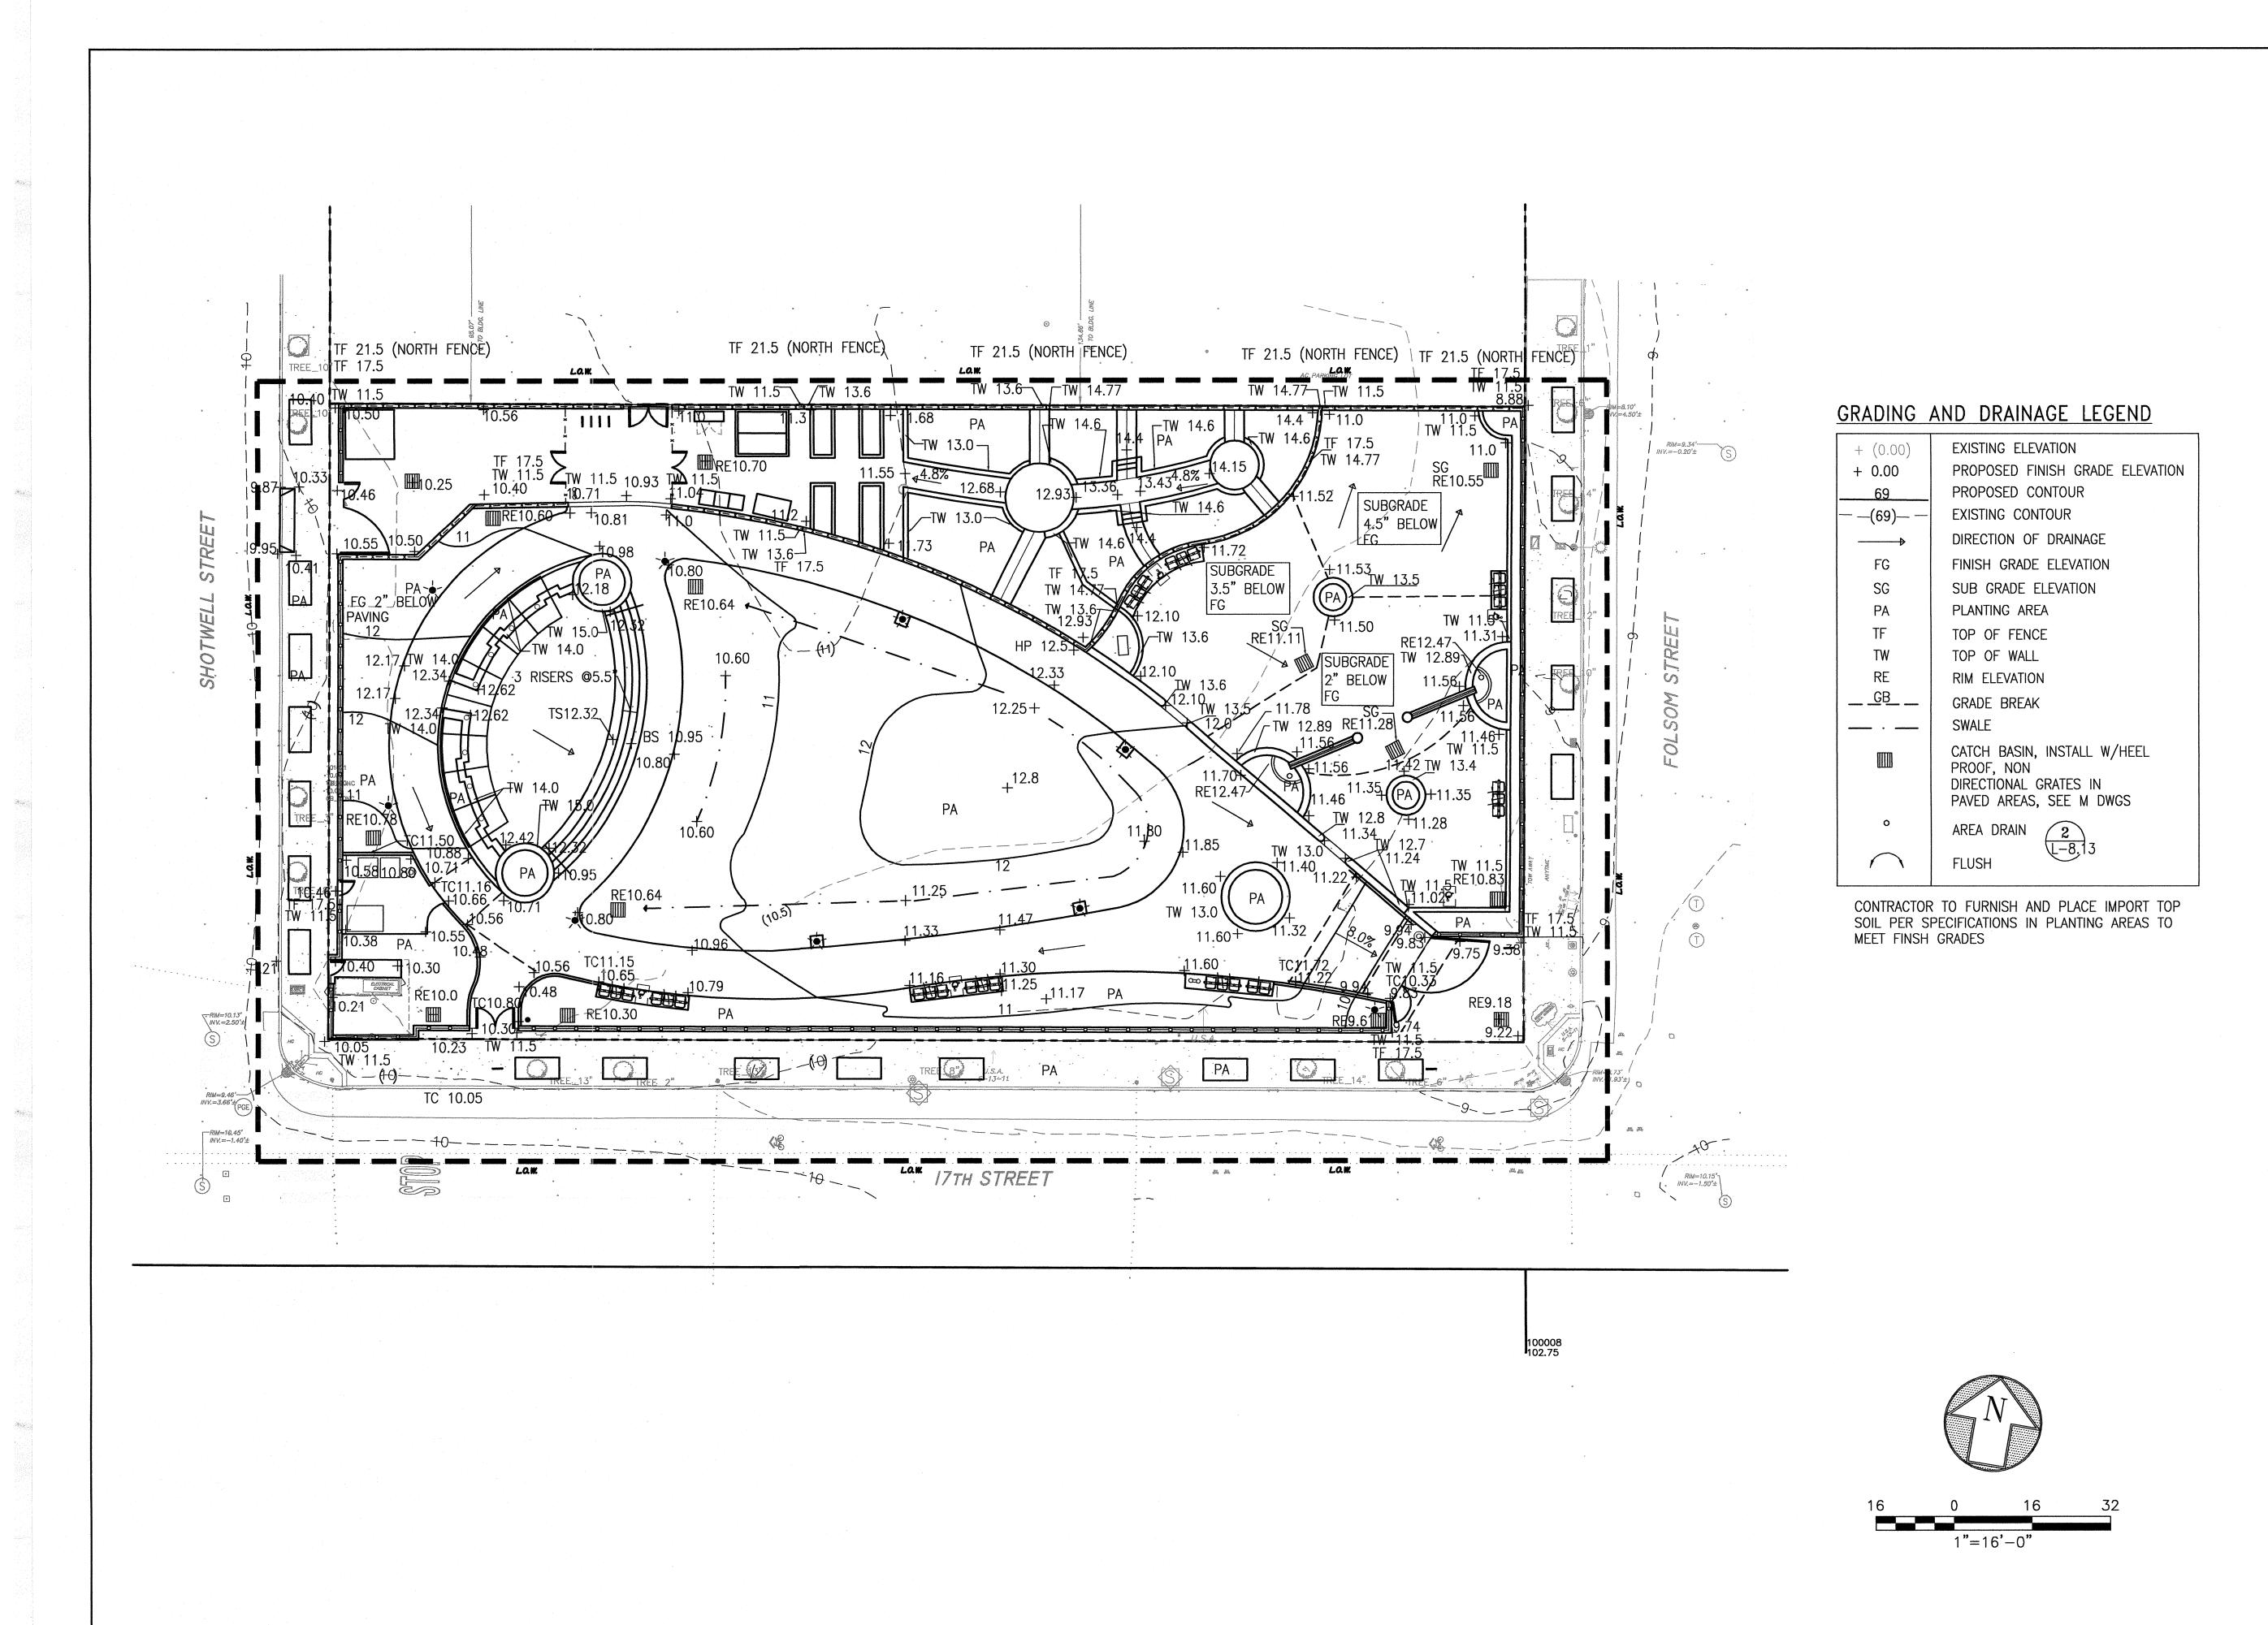
LAYOUT PLAN ENLARGED

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3054V

8 0 8 16 1"=8'-0"



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2080 FOLSOM STREET SAN FRANCISCO, CA 94110

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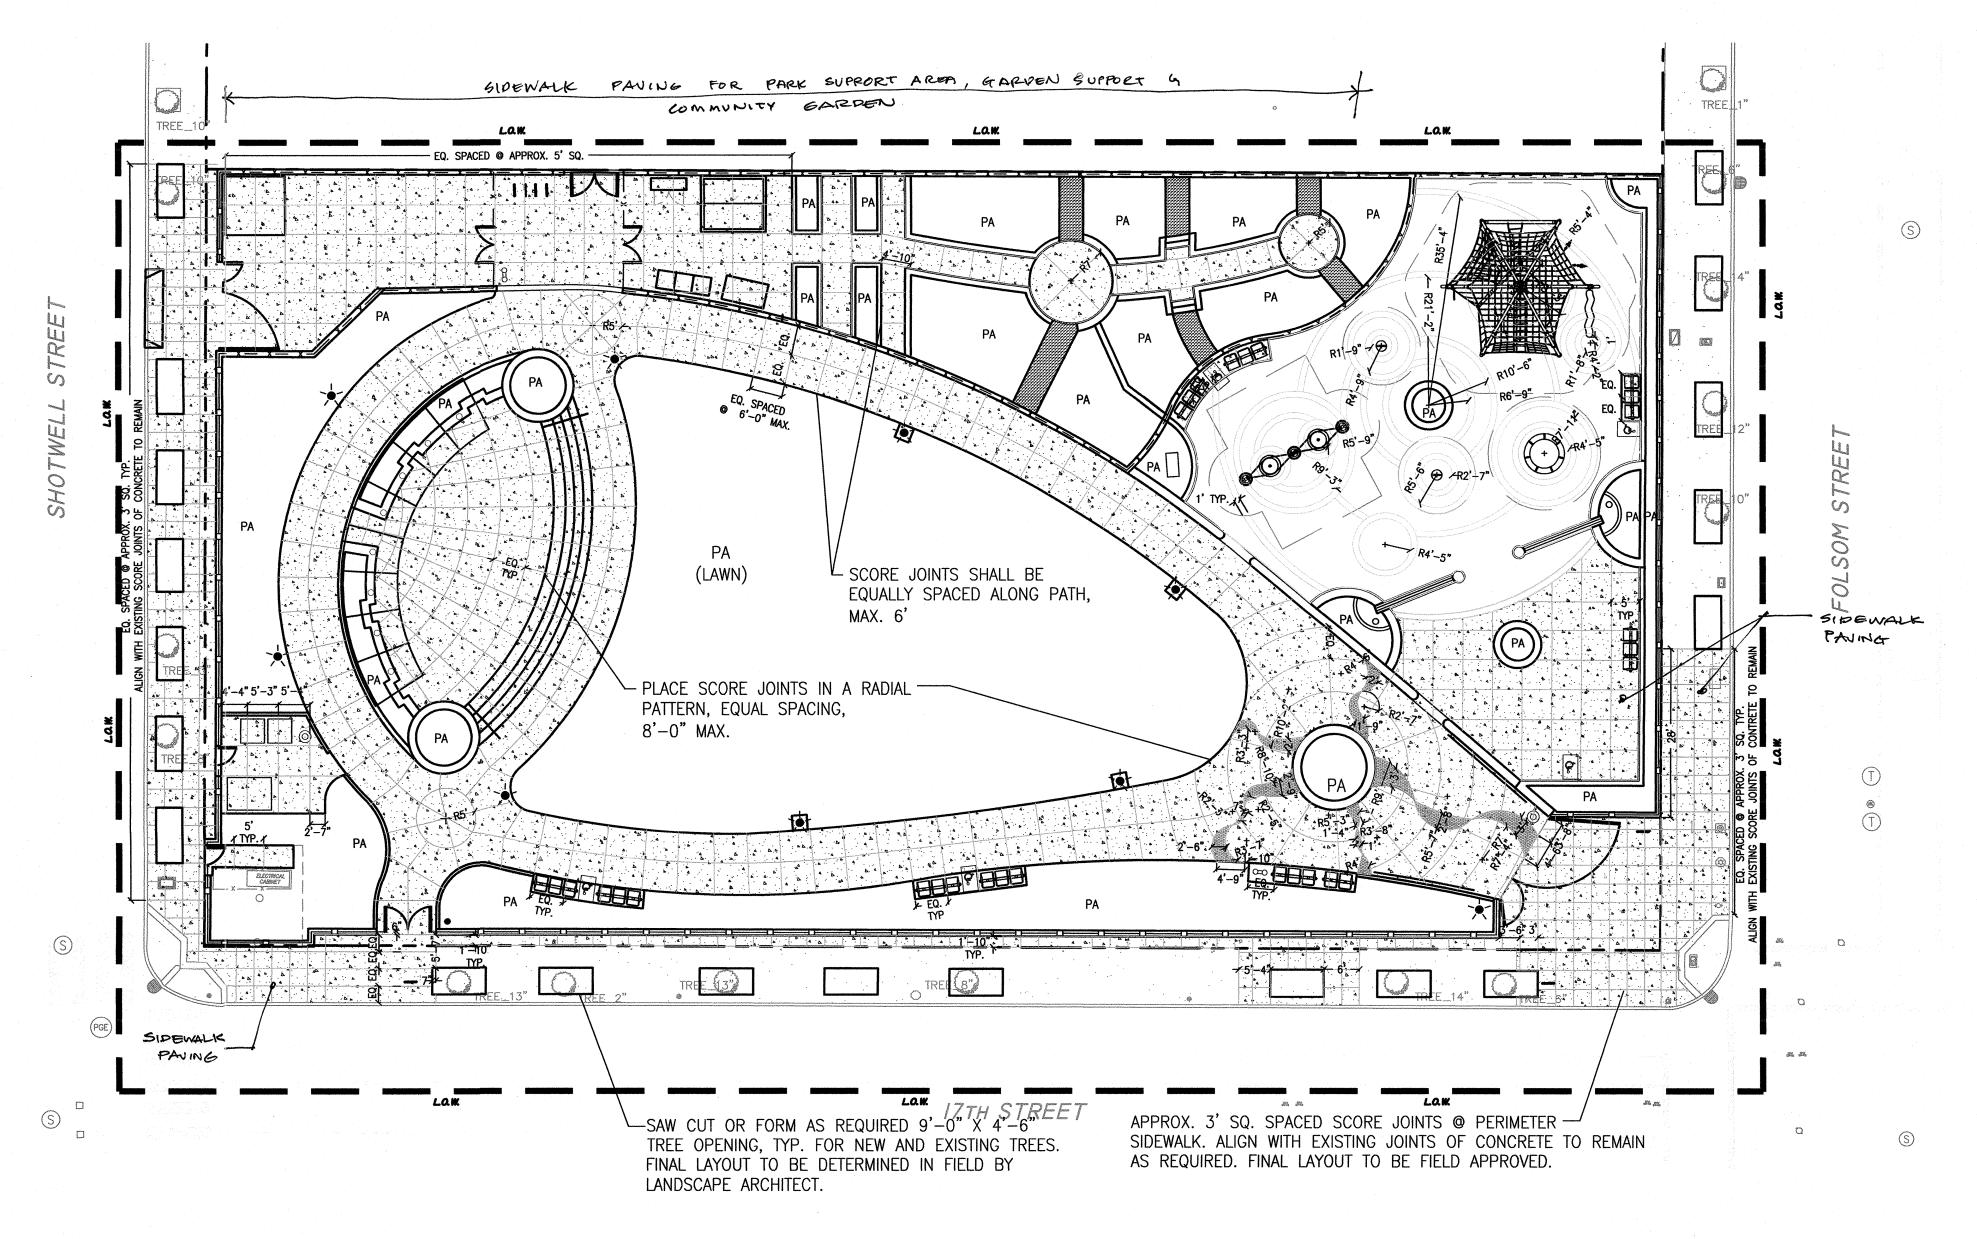
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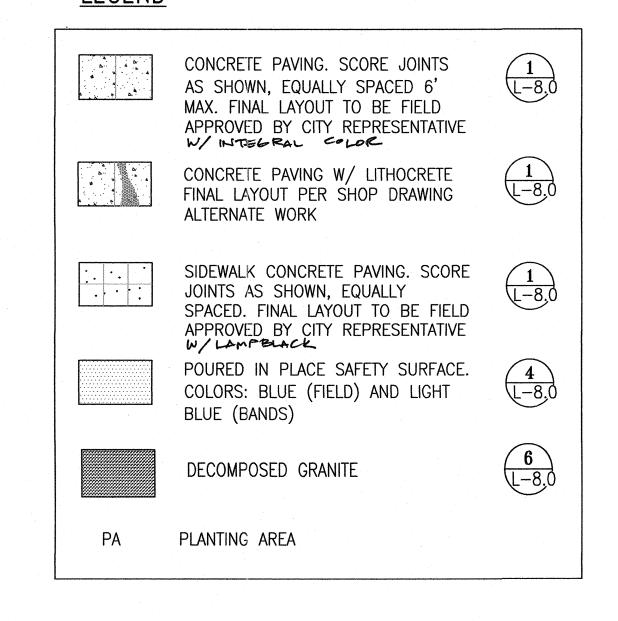
GRADING & DRAINAGE PLAN


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LEGEND





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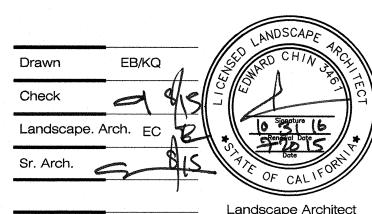
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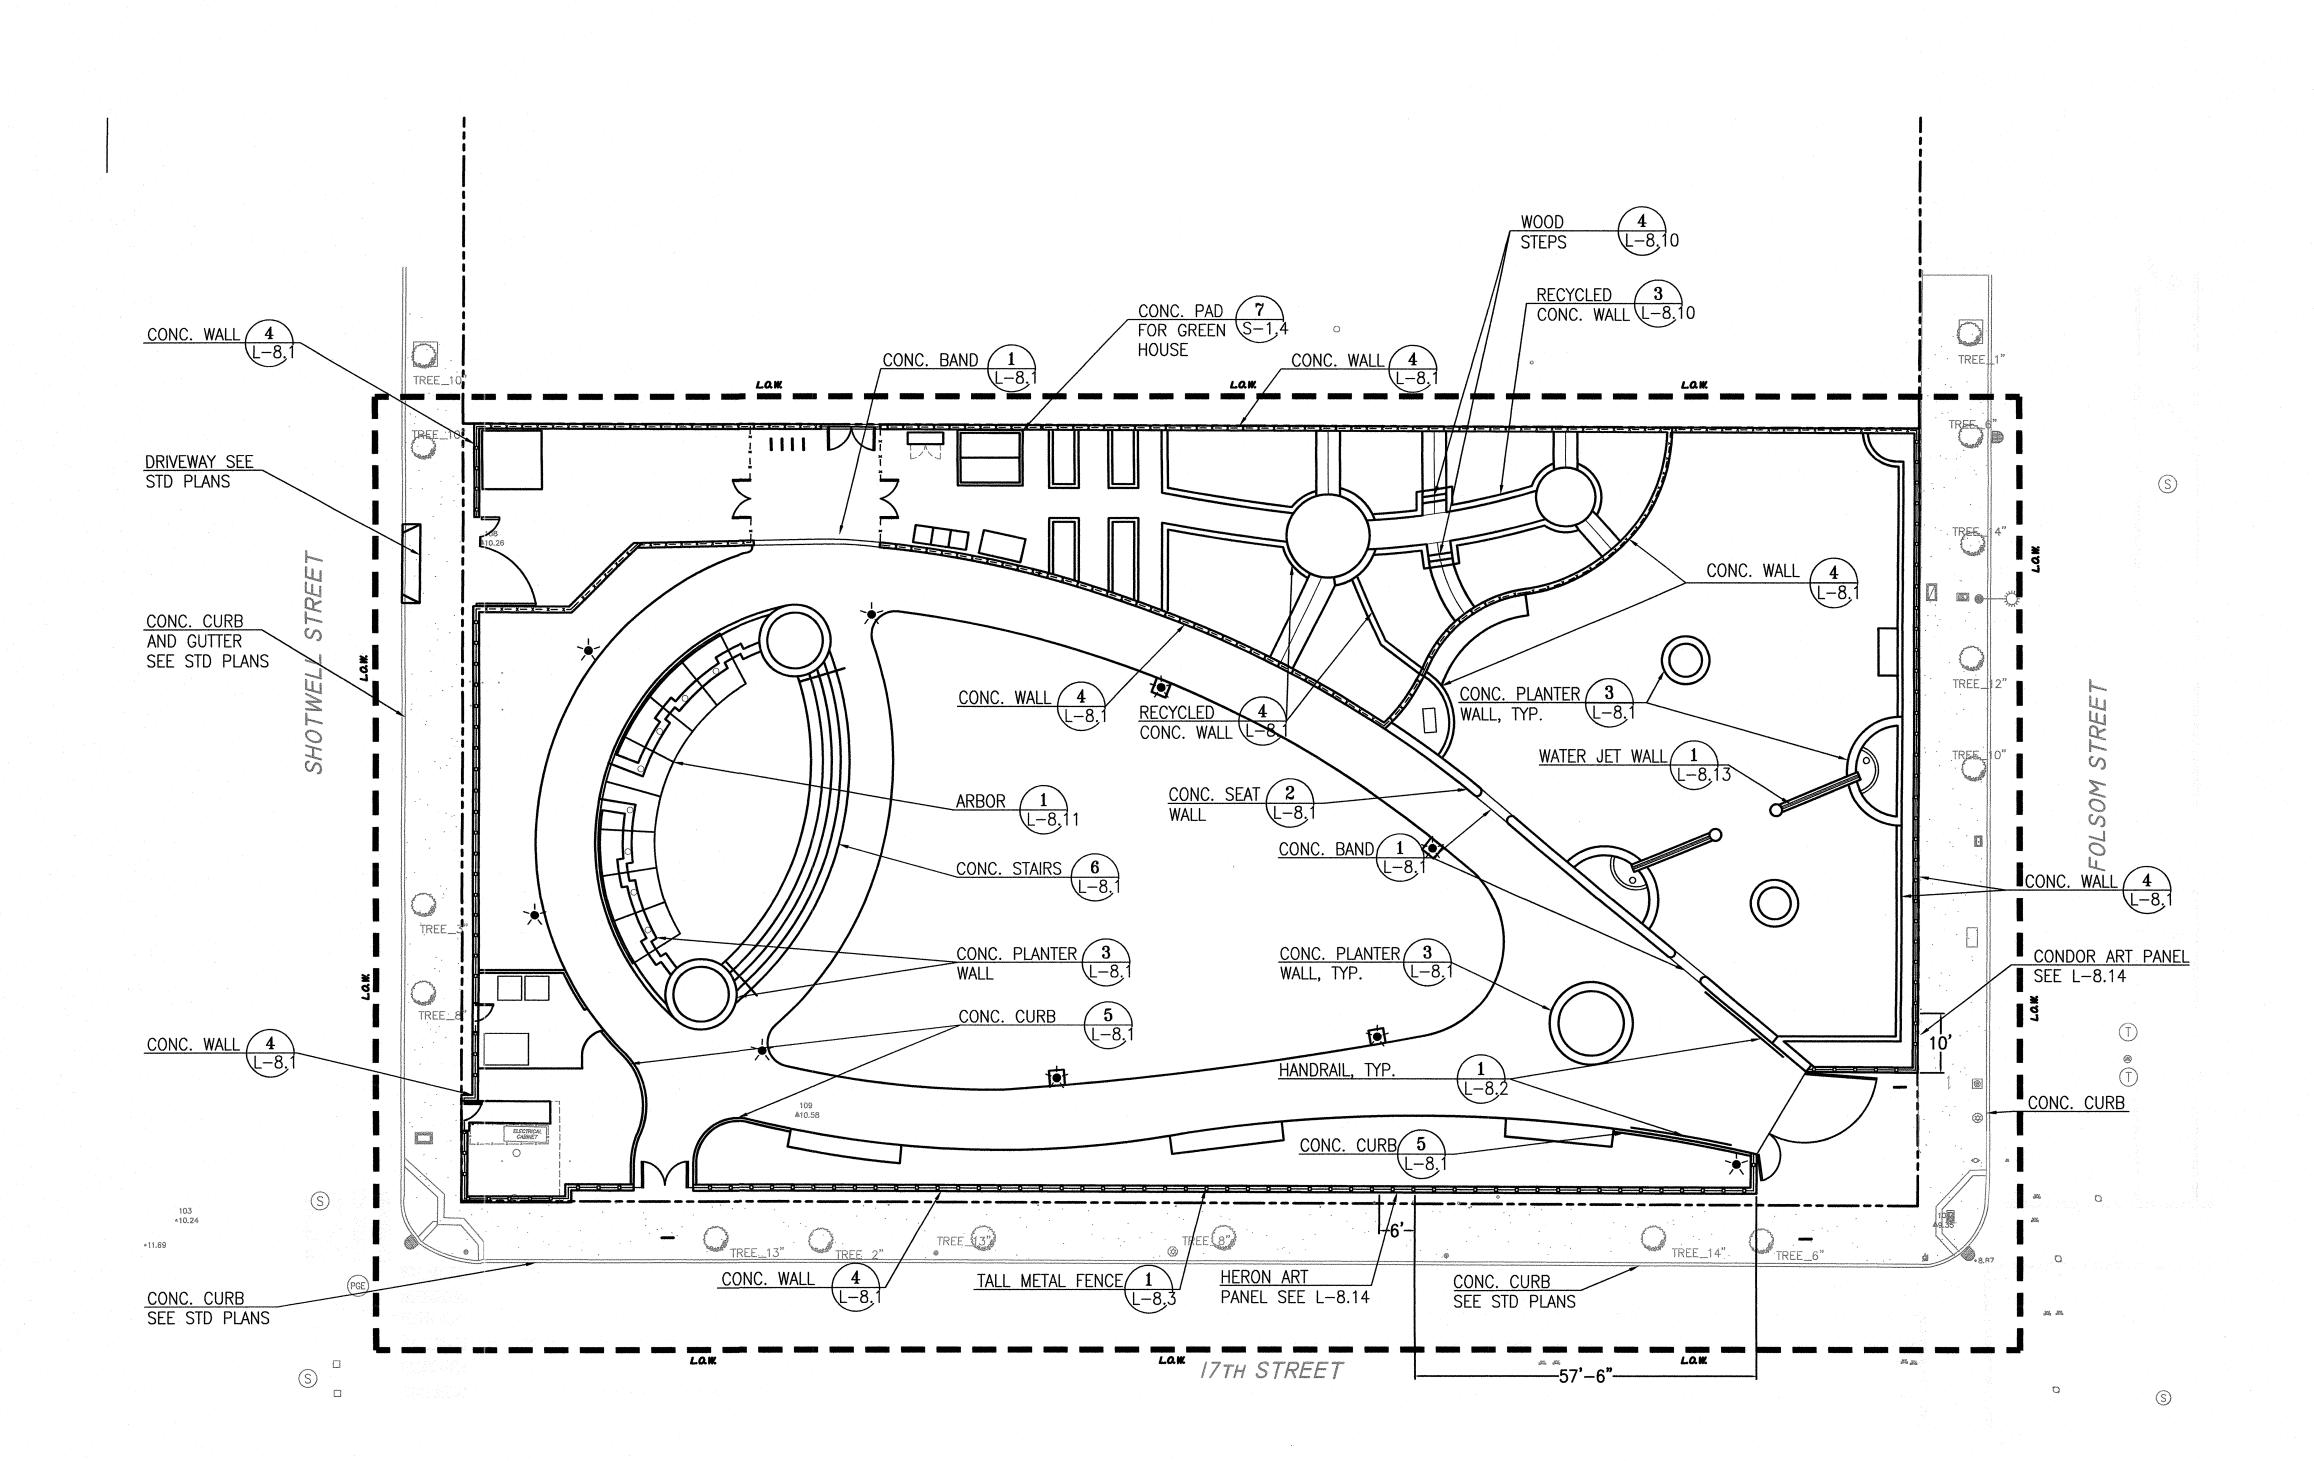
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PAVING PLAN

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16 0 16 32 1"=16'-0" BUILDING DESIGN & CONSTRUCTION

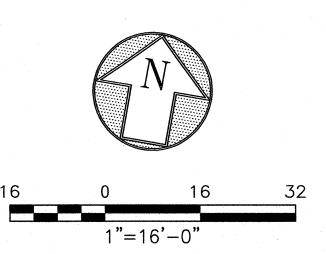

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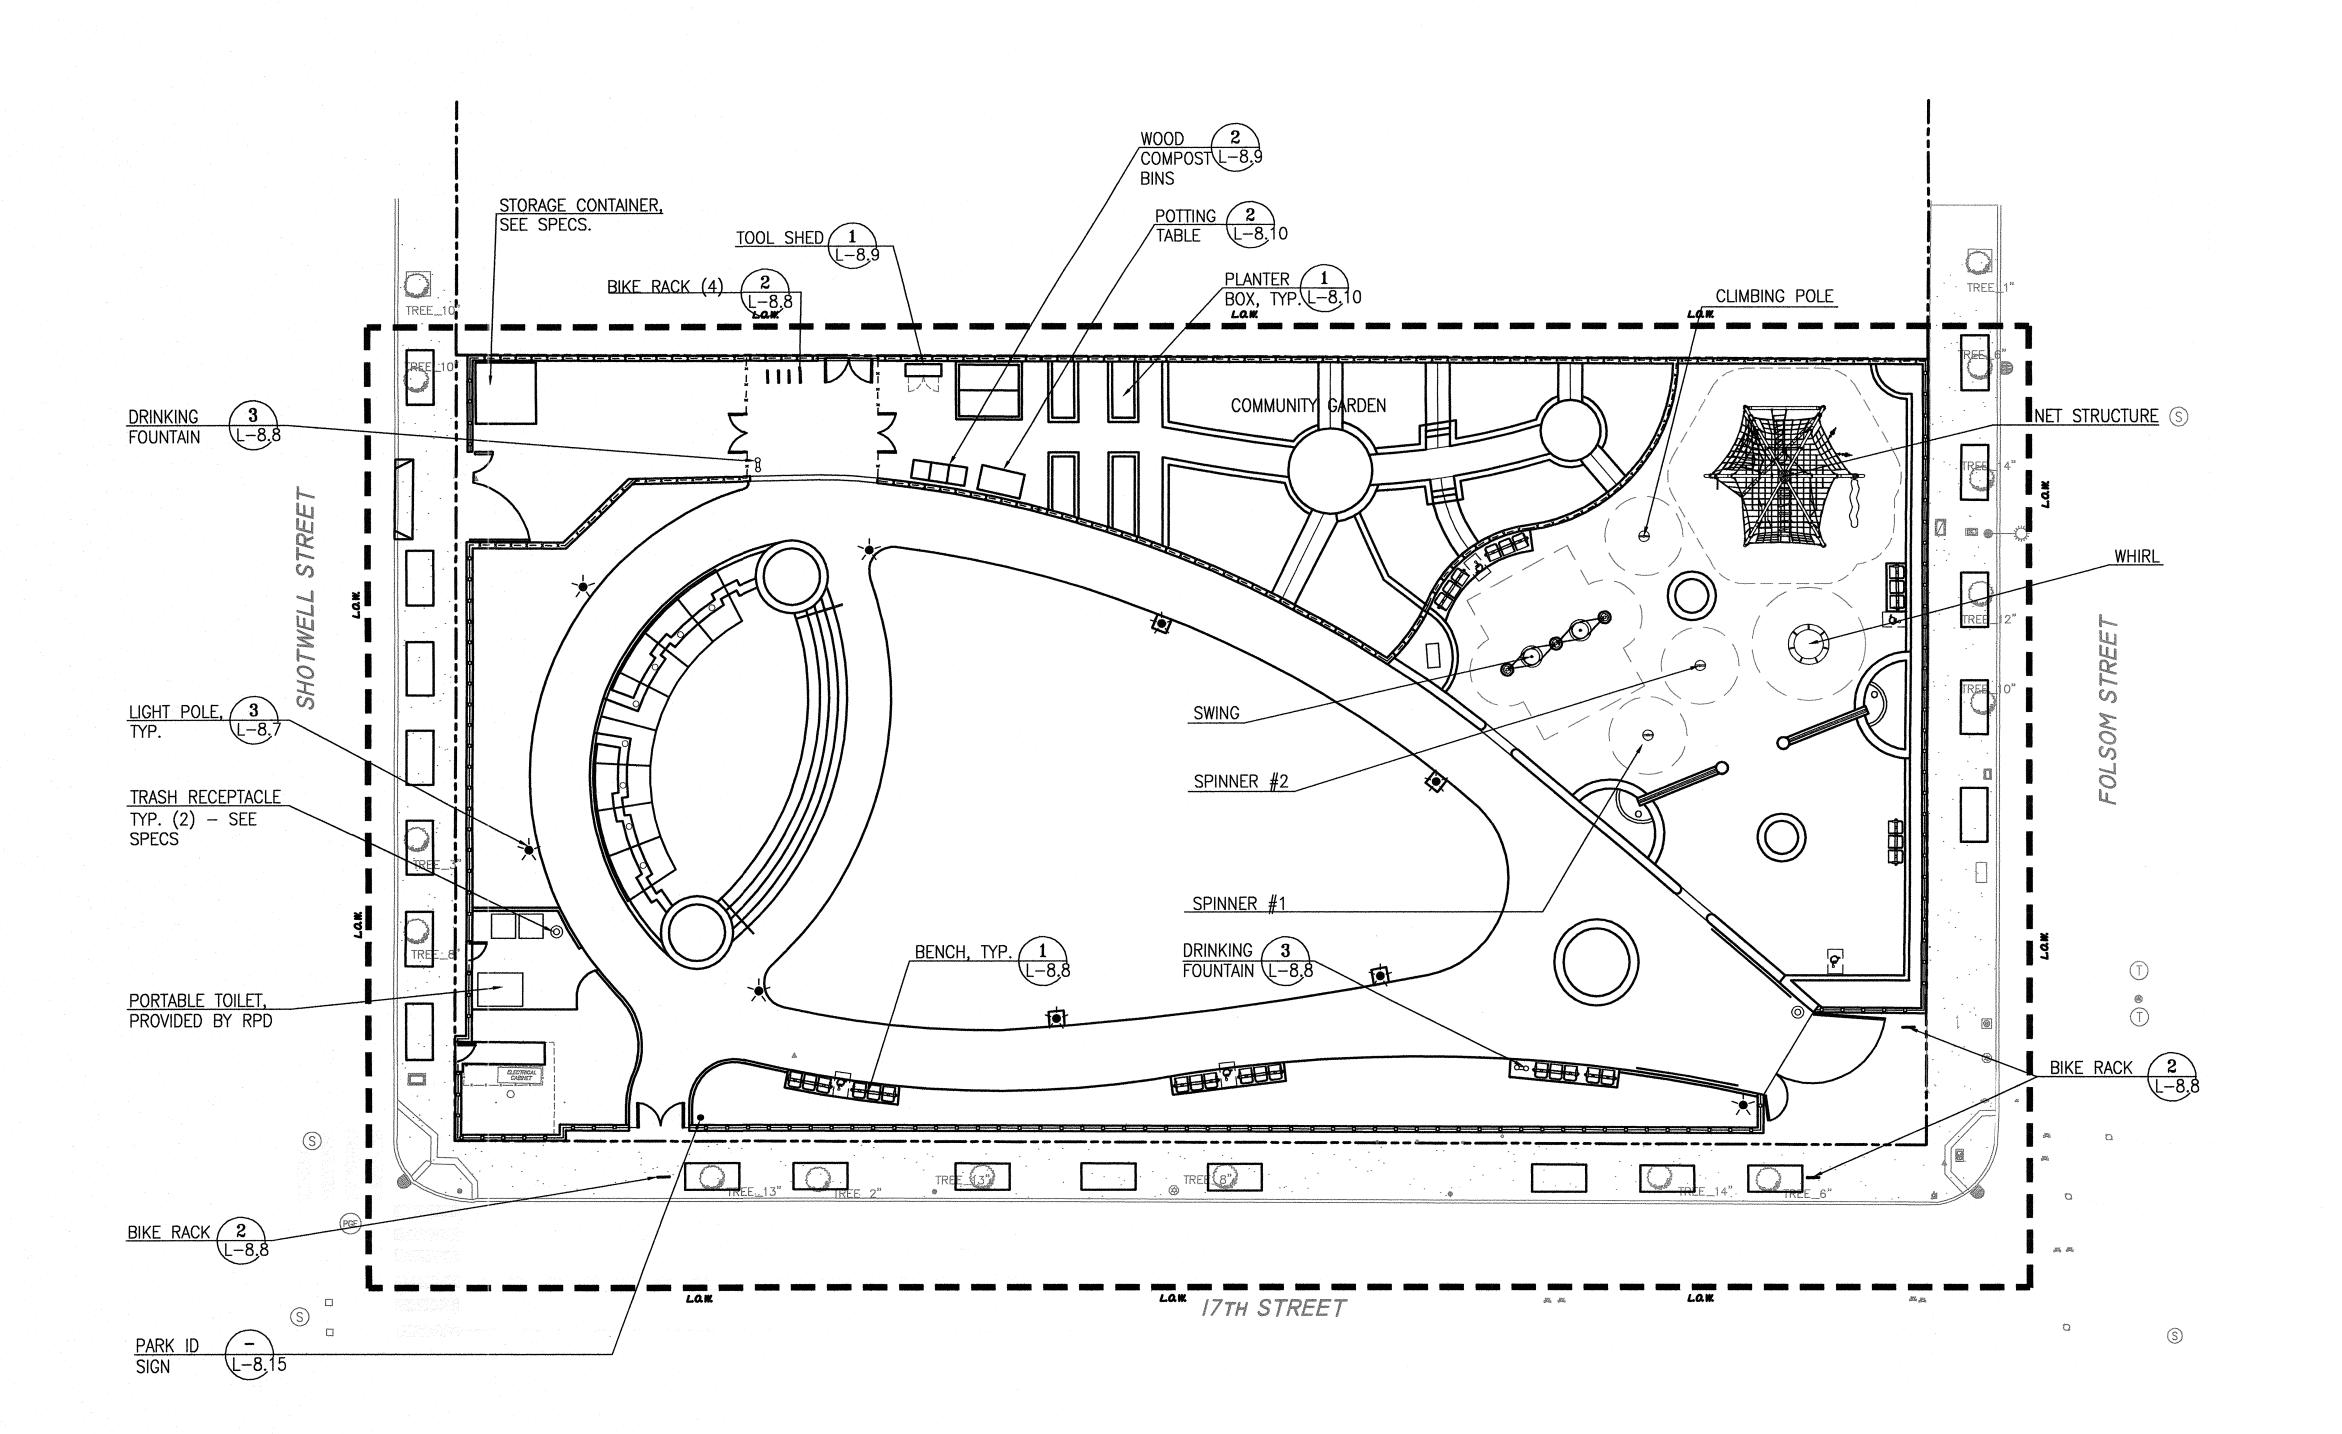
DETAIL REFERENCE PLAN


Landscape Architect

Sheet No.

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Job No. 3054V



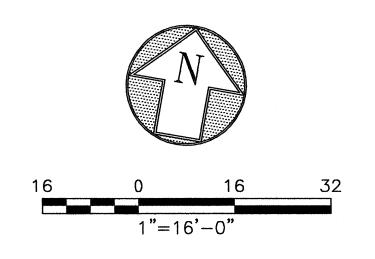

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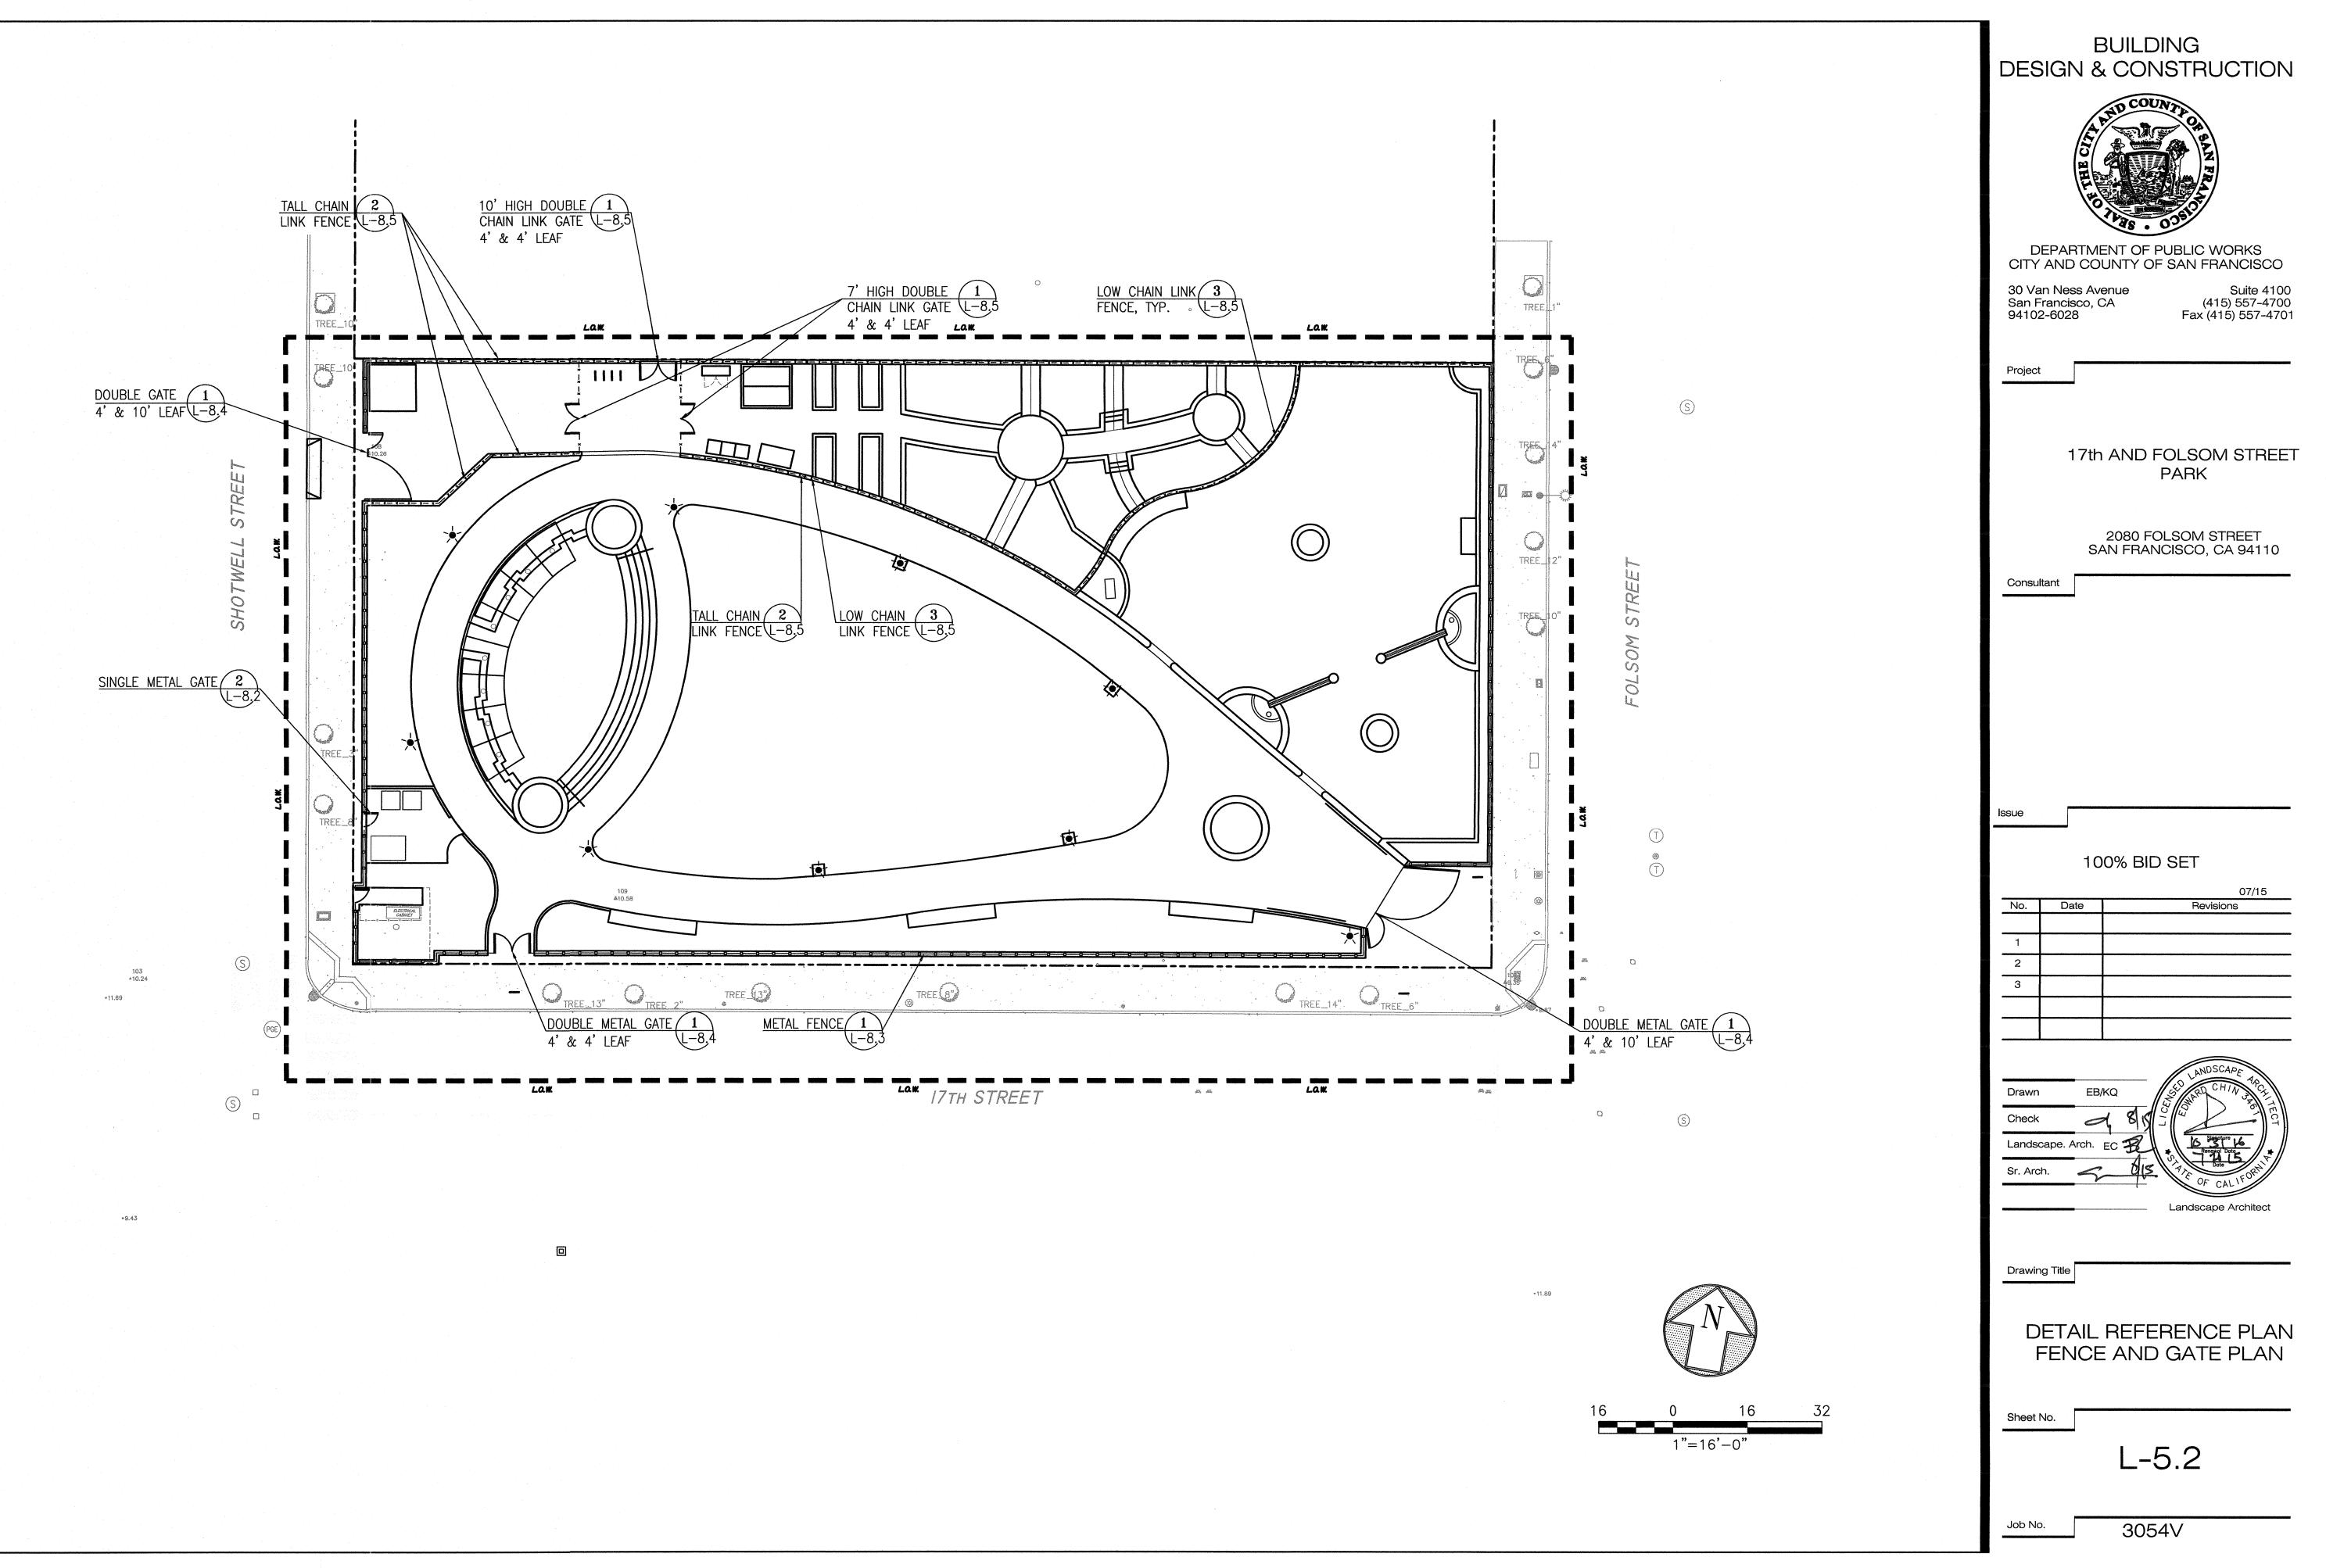
PLAY EQUIPMENT AND SITE FURNISHINGS REFERENCE PLAN


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Job No.

3054V





M		(N) 2 " WATER METER, BY SFWD, NEW INSTALLATIONS, PH: 415-551-2900. CONTRACTOR TO COORDINATE AND PAY FOR METER INSTALLATION AS PART OF CONTRACT. ALLOW 120 DAY LEAD TIME FORSFWD WORK.			
В	FEBCO	LEAD FREE BACKFLOW PREVENTER, 2", LF %25YWITH 120 MESH INLINE BASKET FILTER, INSTALL IN STAINLESS STEEL GUARDSHAG ENCLOSURE.	CK		
C	HUNTER	IC-3000-SS, WITH WIRELESS SOLAR SYNC MODULE AND TWO (2) REMOTE CONTROLS.		######################################	
H	NIBCO	BRASS GATE VALVE, 2"		RED & WHITE	
•	HUNTER	QUICK COUPLER, 1", HQ-44LRC WITH SPRING LOADED LOCKABLE	CAP.		
•	HUNTER	QUICK COUPLER, 1", HQ-44LRC IN ROUND TRAFFIC RATED CONCRETE BOX			
+	HUNTER	IBV AND DRIP VALVE ASSEMBLY, SIZE AS INDICATED			
•	HUNTER	IBV, SIZE AS INDICATED			
8	HUNTER	ROTATOR SIDE STRIP: MPSS530		and the second	
Ø	HUNTER	ROTATOR: MPCORNER MPLCS515			
2	HUNTER	ROTATOR; MP CORNER MPRCS515	.22		
Δ	HUNTER	ROTATOR: MP1000-90	.19	-	
Δ	HUNTER	ROTATOR: MP1000-180	.37		
A	HUNTER	ROTATOR: MP1000-270	.57		
本	HUNTER ROTATOR: MP1000-360 .75		.75		
•	HUNTER RZWS - 36"- CV (36" TREE ROOT WATERING SYSTEM, 2 PER TREE) .50		.50		
*	HUNTER	PCB-10 (UMBRELLA BUBBLER)	1.0	, Marie 1994	
	HUNTER	ECO-MAT DRIP SYSTEM IN LAWN AREA, 6" DEPTH. ECO-MAT FED BY WATER FEATURE CISTERN W/ METER BACK UP, REFER TO M-DRAWINGS FOR CONNECTION.	15	, adversariada	

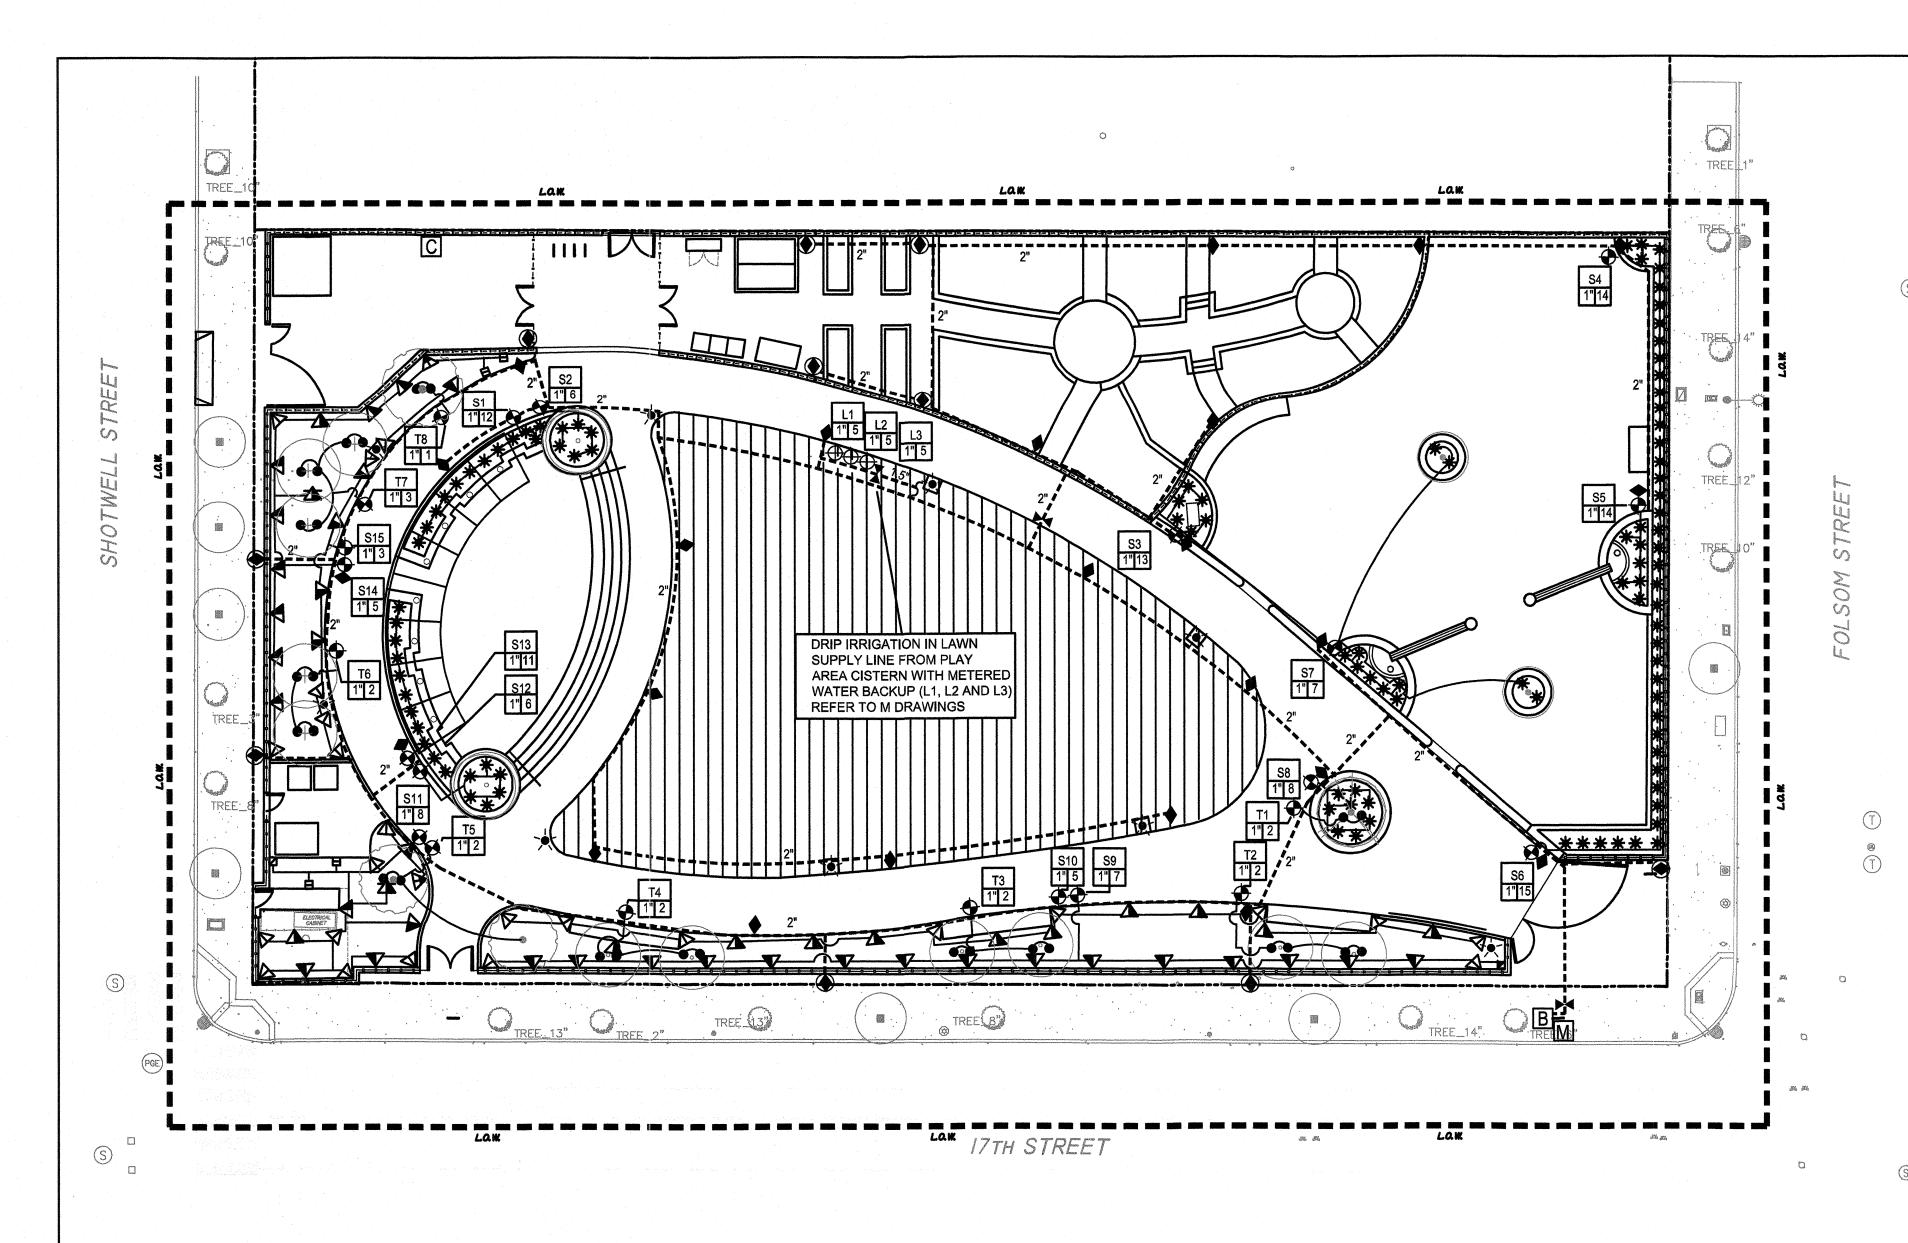MAIN LINE: SCH. 40 GALVANIZED STEEL PIPE @ 18" DEPTH.

LATERAL LINE: PVC SCH 40 @ 12" DEPTH SIZE AS INDICATED IN LATERAL PIPE SIZING SCHEDULE

IRRIGATION LEGEND

MANUF.

DESCRIPTION

SIZE AS INDICATED.

SYMBOL


IRRIGATION NOTES:

- 1. THE IRRIGATION PLAN IS DIAGRAMMATIC AND DOES NOT SHOW EXACT LOCATIONS OF ALL PIPING, SLEEVES, VALVES, EQUIPMENT OR OTHER CONFLICTS. REFER TO DRAWINGS AND DETAILS AND INSTALL THESE ITEMS PARALLEL TO AND AS CLOSELY AS POSSIBLE TO CURBS, HEADERS OR PAVING EDGES UNLESS OTHERWISE INDICATED.
- 2. ALL WORK SHALL CONFORM TO STATE AND LOCAL CODES.
- 3. THESE NOTES AND IRRIGATION PLAN GOVERN IRRIGATION INSTALLATION ONLY AND ARE NOT INTENDED TO GOVERN OTHER WORK.
- 4. VERIFY AND COORDINATE PROPOSED LOCATION OF POINT OF CONNECTION AND IRRIGATION EQUIPMENT AND MAIN LINE PRIOR TO COMMENCEMENT OF WORK. ANY DISCREPANCY BETWEEN THE DRAWINGS AND FIELD CONDITIONS WHICH AFFECTS IRRIGATION LAYOUT OR FUNCTIONALITY SHALL BE BROUGHT TO THE ATTENTION OF THE CITY REPRESENTATIVE PRIOR TO COMMENCEMENT OF TRENCHING.
- 5. THE CONTRACTOR IS RESPONSIBLE FOR THE INSTALLATION OF A COMPLETELY OPERATIONAL IRRIGATION SYSTEM THAT PROVIDES 100% HEAD TO HEAD COVERAGE TO PLANTED AREAS. THE WORK OF THE CONTRACT INCLUDES ADJUSTMENTS TO THE SYSTEMS INDICATED, INCLUDING QUANTITIES OF PIPING, HEADS, NOZZLES & OTHER EQUIPMENT, AS NECESSARY TO ASSURE 100% HEAD TO HEAD COVERAGE.
- 6. IRRIGATION HEADS MUST AVOID OVERSPRAY ONTO PAVEMENT PER CODE. MINOR ADJUSTMENTS OF HEAD TYPE, NOZZLE TYPE, QUANTITY AND CONFIGURATION MAY BE REQUIRED AT NO ADDITIONAL COST TO THE PROJECT TO ACHIEVE CONFORMANCE TO CODE AND COVERAGE REQUIREMENTS.
 - INSTALL ALL CONTROL WIRING IN SCHEDULE 40 PVC SLEEVES, SIZE AS REQUIRED FOR EASE OF INSERTION/REMOVAL. COMMON TRENCH WITH MAINLINE WHERE POSSIBLE WITH A MINIMUM HORIZONTAL DISTANCE OF 4" BETWEEN LINES AND WITH NO LINE ABOVE ANOTHER. INSTALL ALL PIPING CROSSING UNDER PAVING IN SCH 40 GALVANIZED STEEL SLEEVES OF SUFFICIENT SIZE TO ALLOW FOR EASY INSERTION AND REMOVAL.
- 8. ALL CONTROL AND QUICK COUPLER VALVES SHALL BE INSTALLED IN PLANTED AREAS IN PROXIMITY TO PATHWAYS AND OTHER VALVE BOXES PER THE DETAILS, UNLESS OTHERWISE INDICATED. MAINLINE PIPING AND LATERAL PIPING SHALL BE INSTALLED IN PLANTED AREAS EXCEPT WHERE CROSSING PATH AS INDICATED ON DRAWINGS.
- 9. INSTALL QUICK COUPLERS LOCATED IN PAVING IN 8" TRAFFIC RATED CONCRETE BOXES WITH BOLT DOWN LIDS.
- 10. ALL IRRIGATION EQUIPMENT AND SPRAY SHALL BE ADJUSTED TO AVOID CONFLICT WITH UTILITY BOXES, ELECTROLIERS, FIRE HYDRANTS, AND DRAINAGE PIPE. SEE SEPARATE DRAWINGS FOR FURTHER INFORMATION.
- 11. COORDINATE WORK WITH ALL APPROPRIATE TRADES FOR THE INSTALLATION OF PIPING, PIPE SLEEVES AND ELECTRICAL CONDUIT PRIOR TO COMMENCEMENT OF TRENCHING.
- 12. INSTALL EACH CONTROL VALVE AND ISOLATION VALVE IN A SEPARATE VALVE BOX THE PER DETAIL.

- 11. SEE MANUFACTURERS INFORMATION AND INSTALLATION DETAILS FOR SUBSURFACE IRRIGATION SYSTEM. INSTALL PER MANUFACTURER'S RECOMMENDATION AND SPACING AFTER ACQUIRING SOIL SAMPLE, SEE SPECS.
- 12. USE DOUBLE LAPPED TEFLON TAPE ON ALL THREADED CONNECTIONS.
- 13. POP-UP SPRINKLER HEIGHT: INSTALL 12" IN GROUND COVER/ SHRUB AREAS.
- 14. IF ANY IRRIGATION HEADS SUFFER FROM LOW HEAD DRAINAGE, INSTALL INLINE CHECK VALVES BELOW EACH HEAD AS NECESSARY, OR REPLACE THE IRRIGATION HEAD WITH ONE WITH BUILT IN CHECK VALVES.
- 15. THE IRRIGATION SYSTEM HAS BEEN DESIGNED TO WORK WITH AN (E) STATIC WATER PRESSURE READING OF AT LEAST 40 PSI, AND AN AVAILABLE WATER SUPPLY OF 50 GPM: VERIFY PRIOR TO AND NOTIFY THE ENGINEER IMMEDIATELY IF THERE ARE DISCREPANCIES.
- 16. INSTALL THE CONTROLLER AS INDICATED IN THE DRAWING. VERIFY WITH THE CITY REPRESENTATIVE THE EXACT INSTALLATION LOCATION AND PROXIMITY TO A 110 V SERVICE FOR THE CONTROLLER PRIOR TO INSTALLATION OF THE ELECTRICAL CONNECTION.
- 17. ATTACH A ELECTRONICALLY PRODUCED LEGEND INSIDE THE CONTROLLER DOOR STATING THE AREAS COVERED BY EACH REMOTE CONTROL VALVE AND PRODUCE AN ELECTRON
- 18. THE CONTRACTOR SHALL PRESSURE CHECK FOR FIVE HOURS THE MAIN PRESSURE SUPPLY LINE, WITH VALVES INSTALLED, AND RECEIVE INSPECTION A HARD COPY SIGN OFF FROM CITY REPRESENTATIVE PRIOR TO BACKFILLING ANY PART OF THE MAINLINE.
- 19. WHEN THE CONSTRUCTION WORK HAS BEEN COMPLETED, THE WORK SITE SHALL BE CLEARED OF ALL DEBRIS AND RUBBISH RESULTING FROM THE IRRIGATION SYSTEM OPERATIONS AND LEFT IN A NEAT AND ORDERLY CONDITION.
- 20. THE CONTRACTOR SHALL CONDUCT AN IRRIGATION SYSTEM COVERAGE TEST PRIOR TO PLANTING. THERE WILL BE A FINAL IRRIGATION INSPECTION CONDUCTED BY THE LANDSCAPE ARCHITECT PRIOR TO THE BEGINNING OF THE MAINTENANCE PERIOD.
- 21. THE CONTRACTOR SHALL GUARANTEE THE ENTIRE IRRIGATION SYSTEM FOR ONE YEAR FROM DEFECTIVE MATERIALS AND WORKMANSHIP. REPAIR THE SYSTEM, AND ANY RESULTING DAMAGE TO THE SITE, AT NO COST TO THE CITY.

LATERAL PIPE	SIZING SCHEDULE
GPM	PIPE SIZE (NOMINAL SCH 40 PVC)
8 OR LESS	3/4" Ø
13	1" Ø
23	1 1/4" Ø

NOTE:
IRRIGATION PIPING DOWNSTREAM OF THE REMOTE CONTROL UNIT SHALL
BE SIZED PER THE CHART ABOVE AND NOT INDICATED ON THE PLAN
DRAWINGS. REFER TO THE IRRIGATION LEGEND FOR SPRINKLER FLOW
RATES (GPM). NO PIPING DOWNSTREAM OF THE REMOTE CONTROL VALVE
TO THE SPRINKLER SHALL BE SIZED SMALLER THAN THE SPRINKLER
THREADED INLET SIZE.

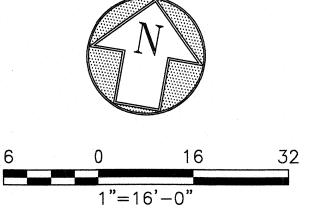

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Project

STATION NUMBER

17th AND FOLSOM STREET PARK

2080 FOLSOM STREET SAN FRANCISCO, CA 94110


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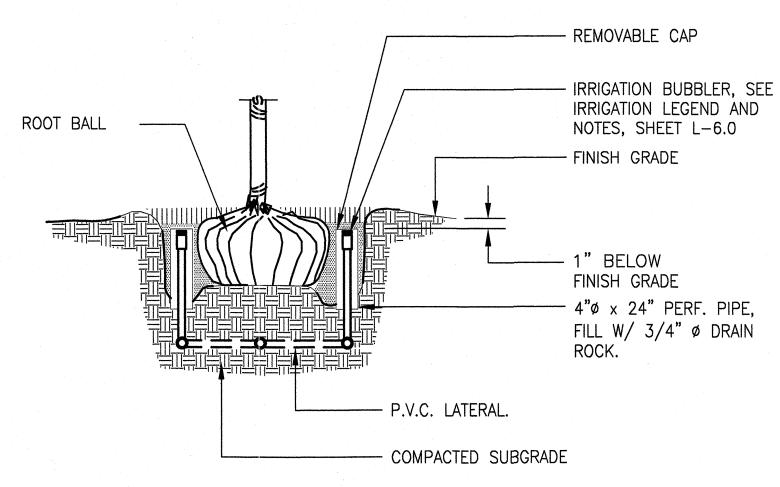


IRRIGATION PLAN

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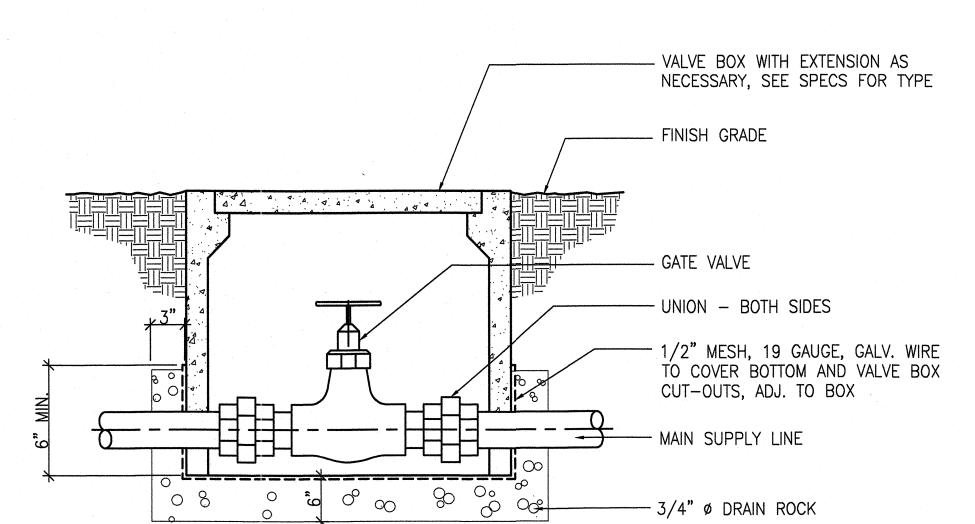
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Job No. 3054V




NOTE: CONTRACTOR TO PROVIDE (2) BUBBLERS PER TREE, SEE IRRIGATION PLAN SHEET L-6.0

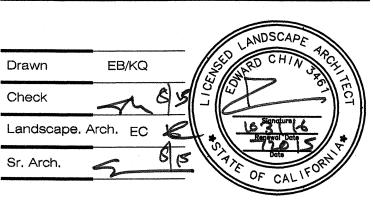BUBBLER INSTALLATION @ TREE PIT




GATE VALVE AND VALVE BOX

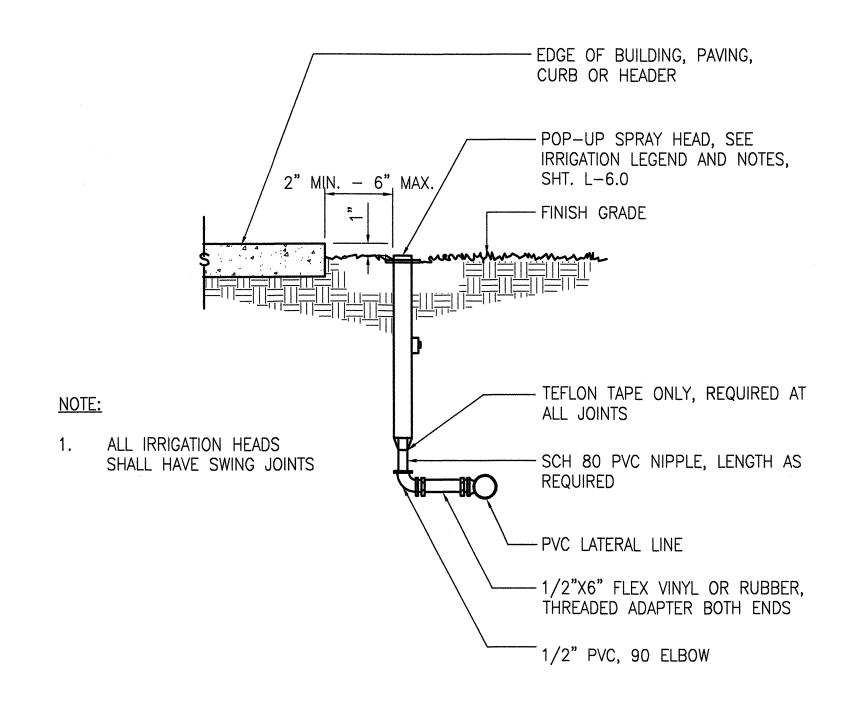

POP-UP SPRAY HEAD

NOT TO SCALE

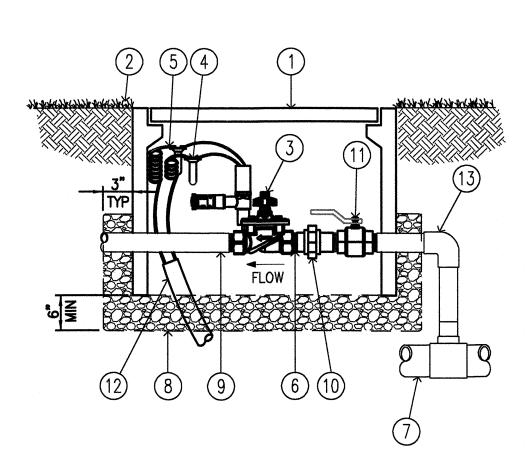

(1) CONCRETE VALVE BOX, SEE SPECS

2) FINISHED GRADE

3) REMOTE CONTROL VALVE, SEE NOTE 1

(4) WATERPROOF CONNECTORS (2)

(5) 18-24" COILED WIRE

6 BRASS NIPPLE (2)

(7) MAINLINE PIPE AND FITTINGS

8 3 MINUS WASHED GRAVEL,W/ 3, 19 GAUGE, GALV. WIRE MESH SURROUND.

9 PVC LATERAL PIPING

(10) GS UNION, LINE SIZE

(11) BRASS BALL VALVE, LINE SIZE

(12) CONDUIT WITH WATERTIGHT SEALED END, SEE SPECS

(13) GS PIPING

REMOTE CONTROL VALVE

NOT TO SCALE

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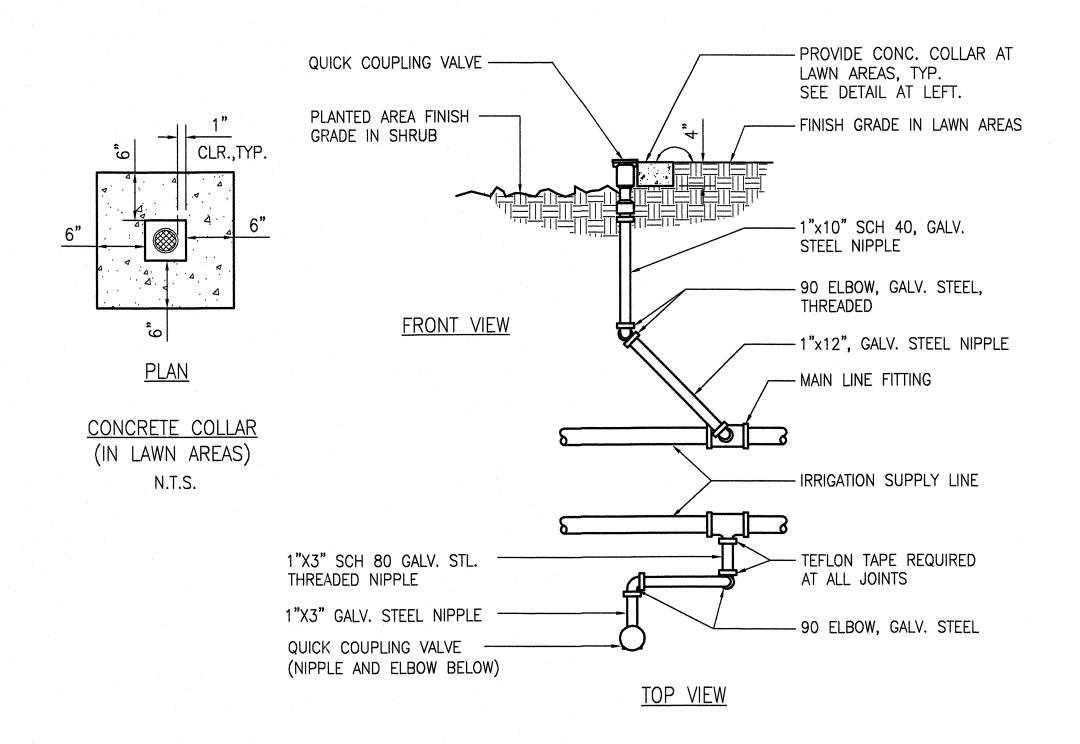
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Landscape Architect

IRRIGATION DETAILS


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QUICK COUPLING VALVE


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IRRIGATION SUPPLY LINE

NOT TO SCALE



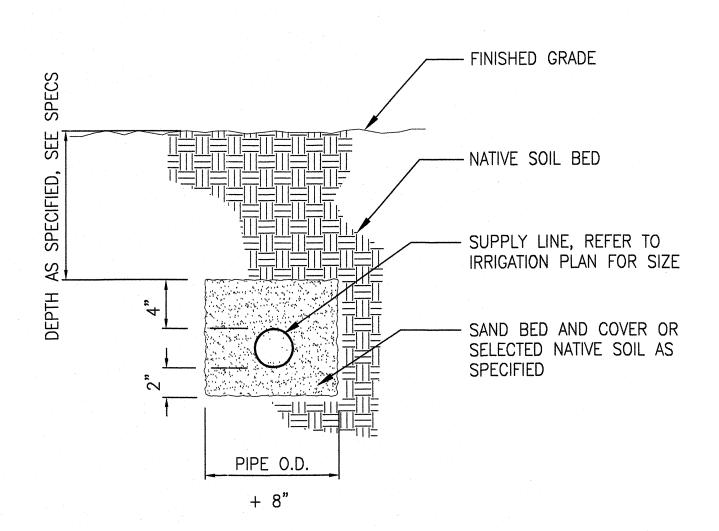

BACKFLOW PREVENTER INSTALLATION

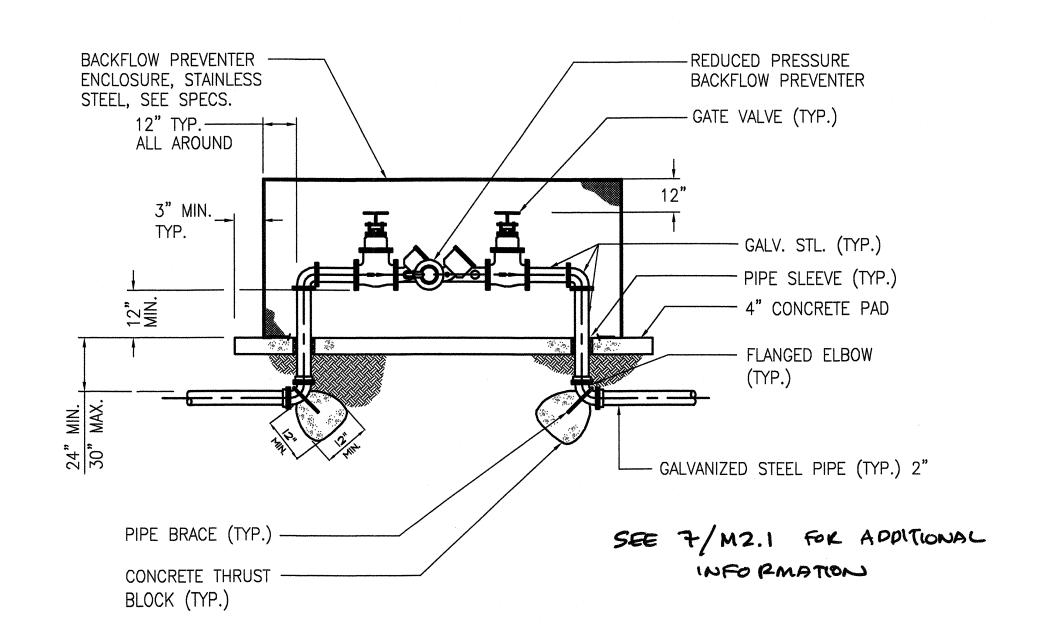NOT TO SCALE

ROUND ——————————VALVE BOX	14"x19" RECTANGI VALVE BOX ——	ULAR	13"x20" JUMBO VALVE BOX
12"			
12" EDGE OF LAWN	12" I, WALK, FENCE, CURB, E	ETC	

- CENTER BOX OVER VALVE TO FACILITATE SERVICING VALVE.
- SET BOXES 1" ABOVE FINISH GRADE OR MULCH COVER IN GROUND COVER/SHRUB AREA AND FLUSH WITH FINISH GRADE IN TURF AREA.
- SET VALVE BOX ASSEMBLY IN GROUND COVER/SHRUB AREA WHERE POSSIBLE. INSTALL IN LAWN AREA ONLY IF GROUND COVER/SHRUB AREA DOES NOT EXIST ADJACENT TO LAWN.
- 4. SET BOXES PARALLEL TO EACH OTHER AND PERPENDICULAR TO EDGE.
- 5. AVOID HEAVILY COMPACTING SOIL AROUND VALVE BOX EDGES TO PREVENT COLLAPSE AND DEFORMATION OF VALVE BOX SIDES.
- 6. VALVE BOXES SHALL HAVE BOLT DOWN LIDS WITH BOLTS INSTALLED.

VALVE BOX INSTALLATION DETAIL

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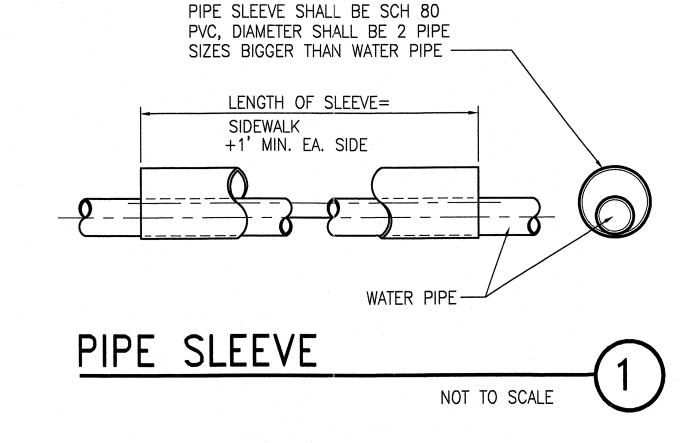
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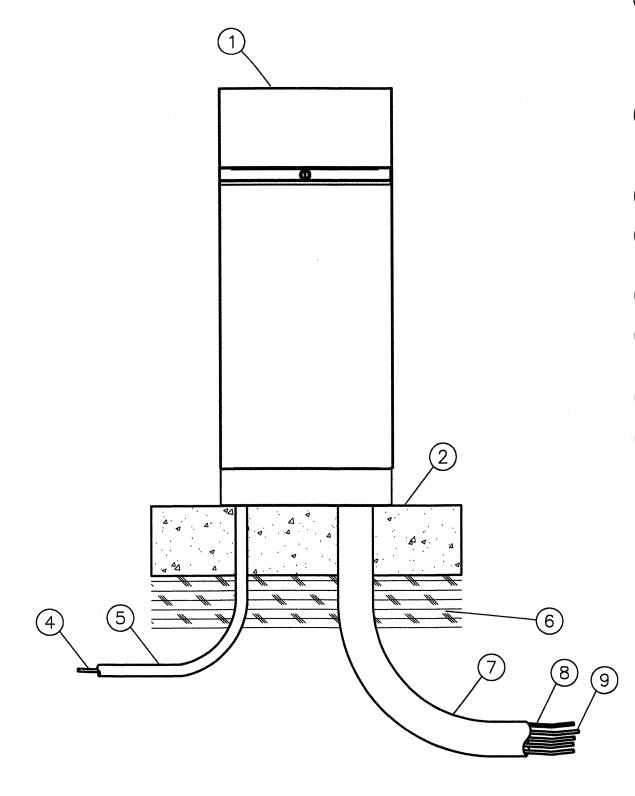
Landscape Architect

IRRIGATION DETAILS

L-6.2

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1 IRRIGATION CONTROLLER: HUNTER ICORE 30 STATION CONTROLLER W/ WIRELESS SOLAR SYNC WEATHER STATION MOUNTED ON PEDESTAL. PROVIDE TWO COMPATIBLE REMOTE CONTROLS & MOUNT IN A FREE STANDING HEAVY DUTY STAINLESS STEEL LOCKABLE ENCLOSURE, SEE IRRIGATION PLANS AND

SPECS.

2) FINISH GRADE

3 POWER SUPPLY WIRE

- 5 1-INCH SCH 40 PVC CONDUIT, FITTINGS AND SWEEP ELL FOR POWER SUPPLY
- 6 COMPACTED SUBGRADE
- 7 3-INCH SCH 40 PVC CONDUIT, FITTINGS AND SWEEP ELL FOR STATION WIRES
- 8 FLOW SENSOR WIRE (PE 39, 89 OR 54) TO FLOW SENSOR
- 9 MASTER VALVE AND REMOTE CONTROL VALVE WIRES

- 1. FOR EASE OF INSTALLATION INTO A CONTROLLER WITH MORE THAN 24 STATIONS, INSTALL A JUNCTION BOX AT THE BASE OF CONTROLLER AND TRANSITION LARGER VALVE AND COMMON WIRES FROM FIELD TO 18 AWG MULTI CONDUCTOR WIRE TO BE USED IN CONTROLLER.
- 2. PROVIDE PROPER GROUNDING COMPONENTS TO ACHIEVE GROUND RESISTANCE OF 10 OHMS OR LESS.
- 3. SOLAR SYNC WEATHER STATION TO BE LOCATED IN FIELD BY CITY REPRESENTATIVE.

PEDESTAL MOUNT CONTROLLER ENCLOSURE

NOT TO SCALE 2

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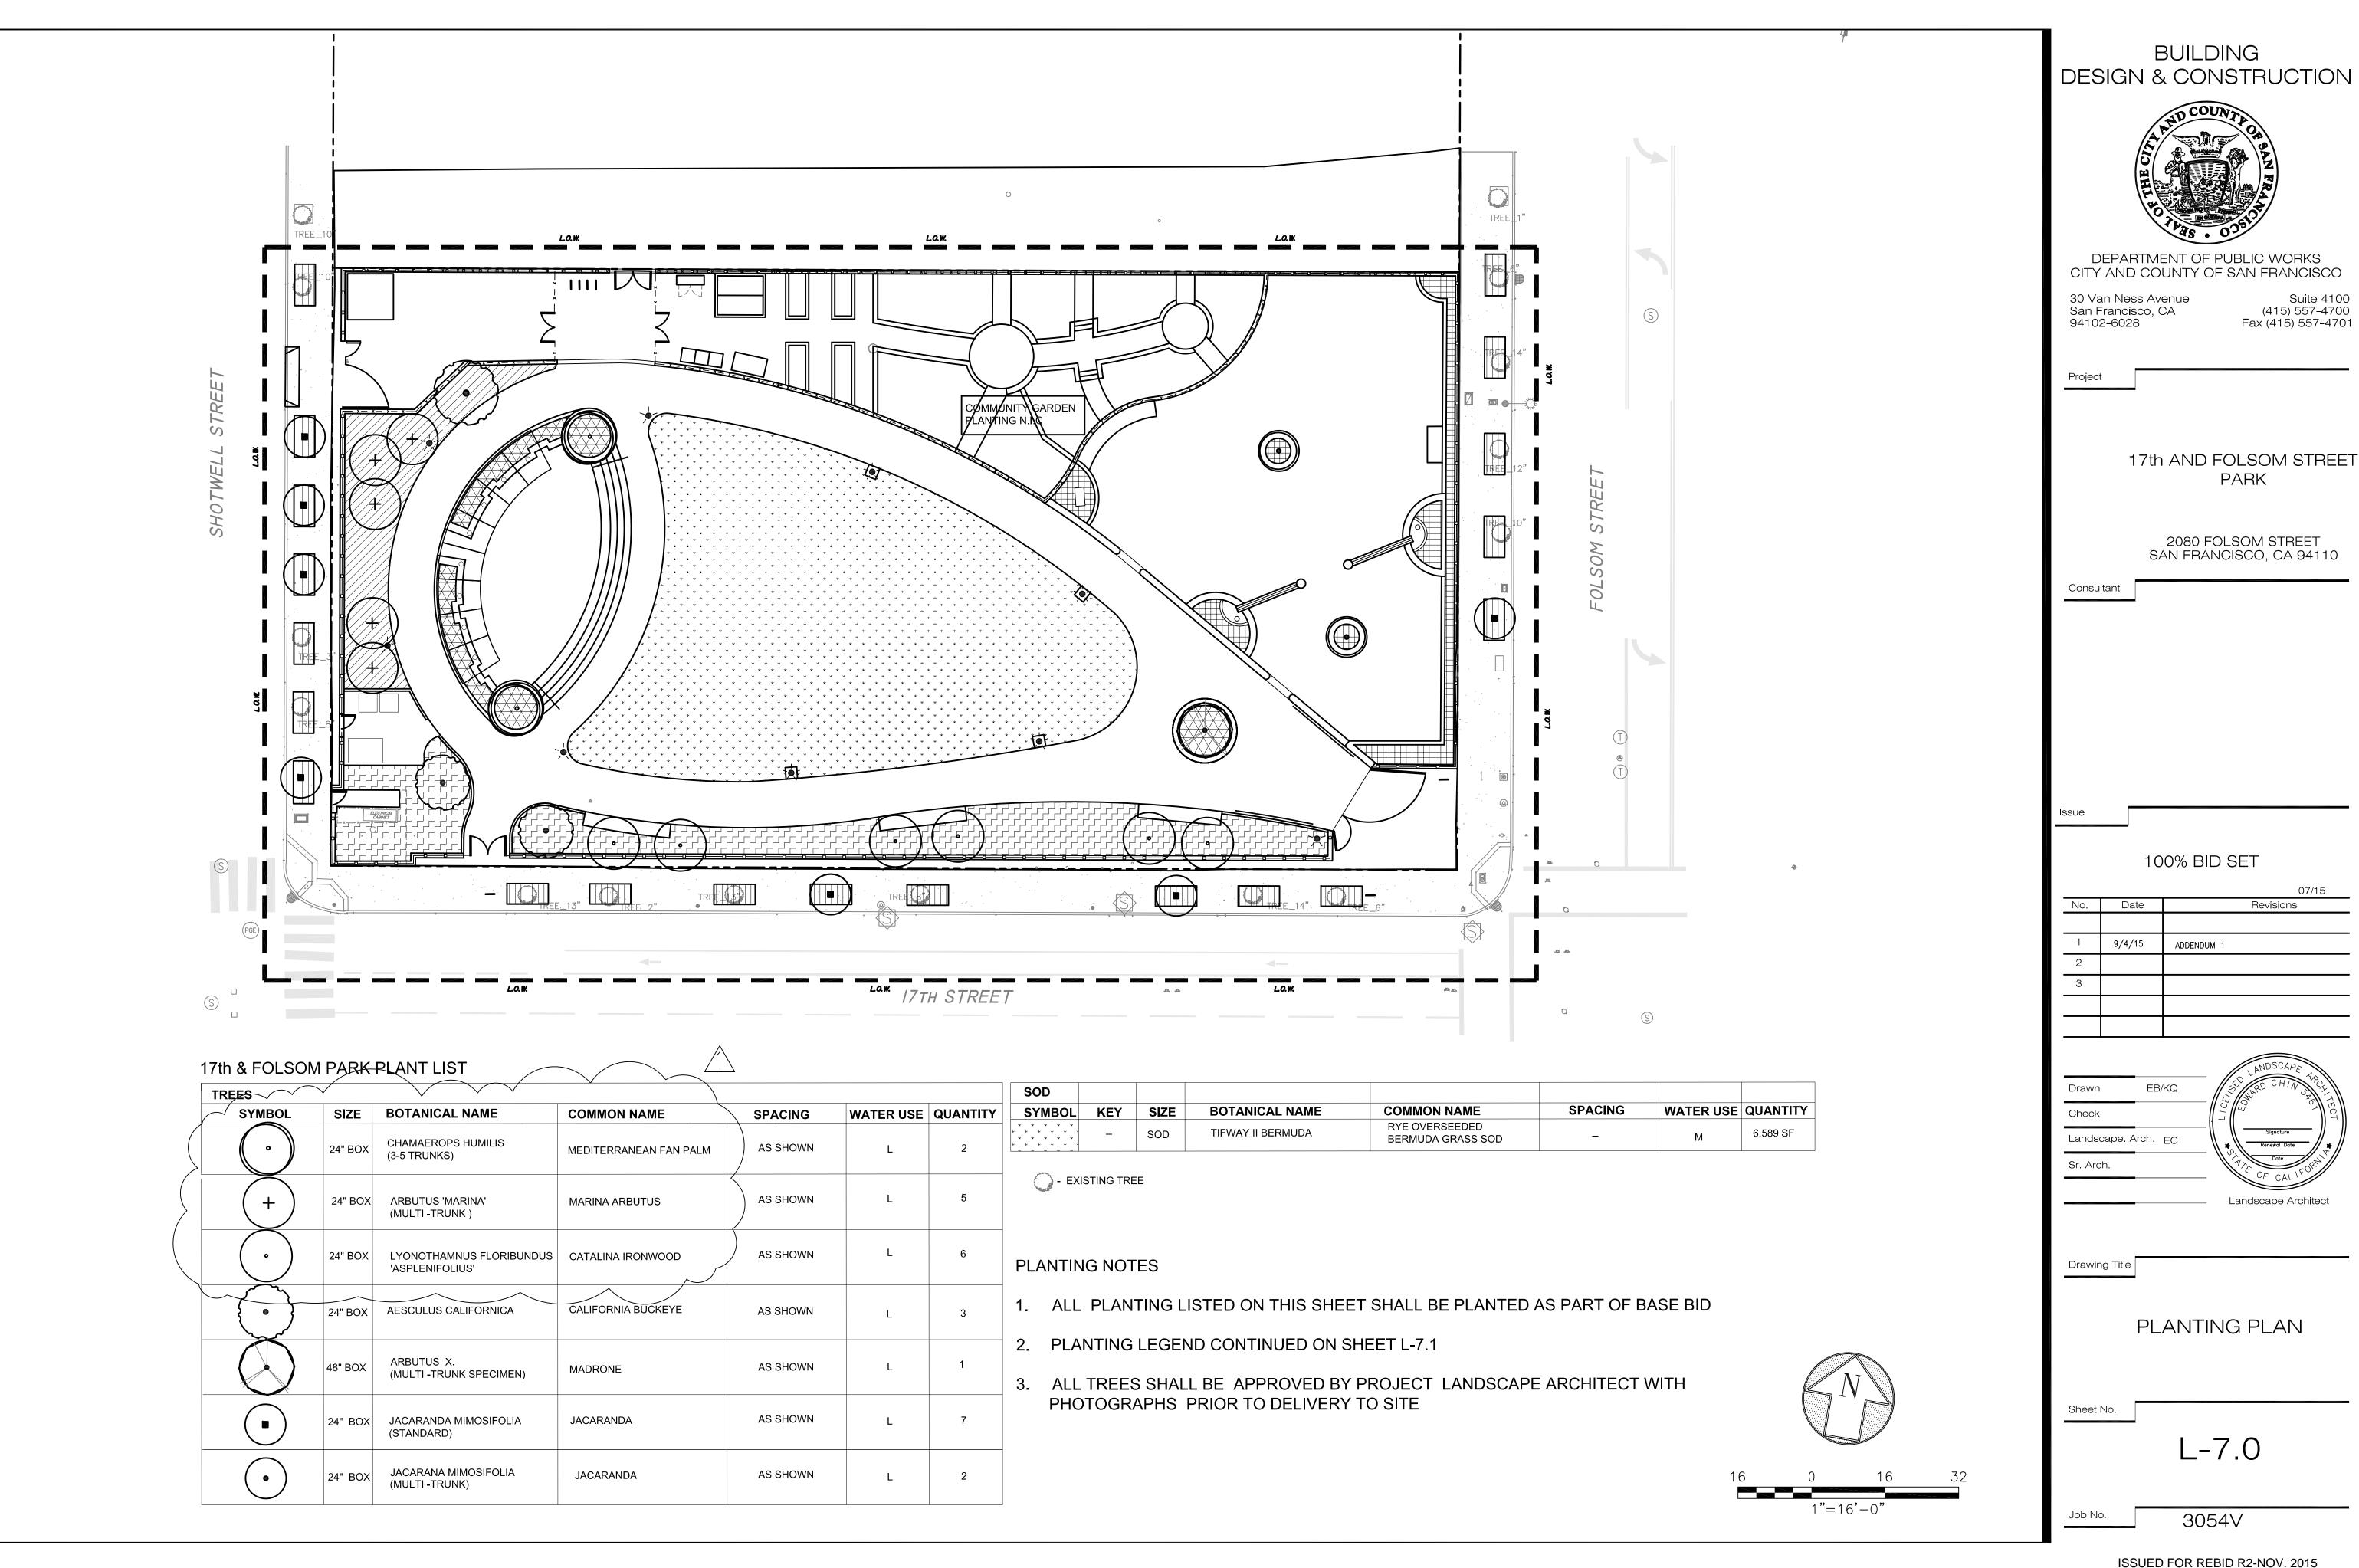
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IRRIGATION DETAILS

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17th & FOLSOM PARK PLANT LIST

SYMBOL	SIZE	BOTANICAL NAME	COMMON NAME	SPACING	WATER USE	QUANTITY
PLAYGROUND PLANTERS - 481 SF						
	1 GAL	ERICAMERIA LARICIFOLIA	TURPENTINE BUSH	2' O.C.	L	-6-
	1 GAL	SEDUM SPECTABILIS	SHOWY STONEGROP	2' O.C.	L	12
	1 GAL	ZAUSCHERIA CALIFORNICA	CALIFORNIA FUCHSIA	2' O.C.	L	6
	1 GAL	ENCELIA CALIFORNICA	COAST SUNFLOWER	2' O.C.	L	6
	1 GAL	GALLARDIA PULCHELLA	INDIAN BLANKET	2' O.C.	L	6
	1 GAL	OREGANEUM X MAJORICUM	ITALIAN OREGANO	2' O.C.	L	6
	1 GAL	ERIGERON GLAUCA	SEASIDE DAISY	2' O.C.	L	6
	1 GAL	ACHILLEA MILLEFOLIUM	YARROW	2' O.C.	L	15
	1 GAL	SALVIA 'MESA AZURE'	AZURE MOUNTAIN SAGE	2' O.C.	L	15
	1 GAL	PENSTEMON 'GARNET'	PENSTEMON	2' O.C.	L	12
	5 GAL	CAREX TUMULICOLA	BERKELEY SEDGE	2' O.C.	L	9
	1 GAL	MONDARDELLA VILLOSA	COYOTE MINT	2' O.C.	L	6
	1 GAL	PENSTEMON X.	PENSTEMON	2' O.C.	L	-9-
SOUTH PLANTING - 188	0 SF					
	5 GAL	DENDROMECON RIGIDA	BUSH ISLAND POPPY	4' O.C.	L	9
	1 GAL	IRIS DOUGLASIANA	IRIS	2' O.C.	L	45
	5 GAL	RIBES VIBURNIFOLIUM	EVERGREEN CURRANT	5' O.C.	L	25
	5 GAL	CARPENTERIA CALIFORNICA 'EVE	BUSH ANEMONE	3' O.C.	L	23
	5 GAL	CASE' RHAMNUS CALIFORNICA	COFFEEBERRY	5' O.C.	L	12
	1 GAL	SALVIA 'MESA AZURE'	AZURE MOUNTAIN SAGE	18" O.C.	L	45
┍┦╒┦╒┦╘┧╘┦╘┧╘┧╘┧╘┪╘┪ ╒ ╒┸╘┧╘┧╘┧╘┧╘┧╘┧╘┧╘┧╘┧╘	1 GAL	PENSTEMON SPECTABILIS	SHOWY PENSTEMON	2' O.C.	L	40
	1 GAL	ARTEMESIA 'DAVID'S CHOICE'	COAST SAGEWORT	2' O.C.	L	25
	5 GAL	LEYMUS CONDENSATUS 'CANYON PRINCE'	CANYON PRINCE WILD RYE	3' O.C.	L	25
	5 GAL	BUDDLEIA 'BLUE CHIP'	DWARF BUTTERFLY BUSH	3' O.C.	L	21
STAGE & ENTRY AREA	PLANTER	RS - 363 SF				
	15 GAL	BOUGAINVILLEA 'SAN DIEGO RED'	NCN	AS SHOWN	L	6
	1 GAL	SALVIA APIANA 'DWARF'	WHITE SAGE	2' O.C.	L	15
	5 GAL	AZIGANANTHOS SPP.	KANGAROO PAW	2' O.C.	L	9
	5 GAL	ARTEMESIA 'DAVID'S CHOICE'	COAST SAGEWORT	2 O.C.	L	9
	5 GAL	GALVEZIA SPECIOSA	ISLAND BUSH SNAPDRAGON	2' O.C.	L	9
	5 GAL	CORDYLINE X 'JURRED'	FESTIVAL GRASS	2' O.C.	L	9
	1 GAL	GALLARDIA GRANDIFLORA	INDIAN BLANKET	2' O.C.	L	18
						<u> </u>

PLANTING NOTES

- 1. SEE STANDARD SPECIFICATIONS, SECTION "PLANTING", FOR ADDITIONAL PLANTING INFORMATION.
- 2. ALL TREES LISTED ON L 7.0 AND SOD LAWN SHALL BE PLANTED/INSTALLED AS PART OF THE CONTRACT.
- 3. ALL AREAS TO RECEIVE PLANTING SHALL BE PREPARED AS PART OF THE CONTRACT.
- 4. THE CONTRACTOR SHALL REVIEW ALL PLANT MATERIAL ON SITE WITH THE CITY REPRESENTATIVE AND SHALL INSTALL PLANT MATERIAL ONLY AFTER OBTAINING APPROVAL FROM THE CITY REPRESENTATIVE. THE CONTRACTOR SHALL CONTACT THE CITY REPRESENTATIVE 21 DAYS PRIOR TO THE PLANT DELIVERY TO ARRANGE REVIEW AND INSPECTION PRIOR TO PLANTING WITH THE CITY REPRESENTATIVE.
- 5. THE CITY REPRESENTATIVE RESERVES THE RIGHT TO MAKE SUBSTITUTIONS, ADDITIONS AND DELETIONS IN THE PLANTING SCHEME AS THE WORK PROGRESSES BASED ON SITE CONDITIONS OR THE AVAILABILITY OF SPECIES AND VARIETIES OF SPECIFIED PLANT MATERIAL AT NO ADDITIONAL COST TO THE CONTRACT.
- 6. ALL GROUNDCOVER AND SHRUBS SHALL BE SPACED TRIANGULARLY.
- 7. SHRUB AREAS SHALL RECEIVE WEED FABRIC, REFER TO SPECIFICATIONS.
- 8. ALL NEW TREES AND SHRUB MATERIAL MUST BE APPROVED ONSITE BY THE CITY REPRESENTATIVE PRIOR TO PLANTING. THE CITY REPRESENTATIVE RESERVES THE RIGHT TO REJECT PLANT MATERIAL FOR DISCREPANCIES IN VARIETY, SIZE SPECIFIED, HEALTH OR CONDITION.

17th & FOLSOM PARK PLANT LIST, CONTINUED

1	SYMBOL		SIZE	BOTANICAL NAME	COMMON NAME	SPACING	WATER USE	QUANTITY
	WEST PLAN	TING AREA	- 967 SF					
			5 GAL	CISTUS 'SUNSET'	ROCKROSE	3' O.C.	L	27
			1 GAL	BRODIAEA ELEGANS	HARVEST BRODIAEA	2' O.C.	L	12
			1 GAL	IRIS DOUGLASIANA	IRIS	2' O.C.	L	27
			1 GAL	ASCLEPIAS SPP.	MILKWEED	2' O.C.	L	30
			5 GAL	MIMULUS HYBRID ORANGE	MONKEY FLOWER	2' O.C.	L	60
			5 GAL	CARPENTERIA CALIFORNICA	BUSH ANEMONE	2' O.C.	L	21
			5 GAL	ROMNEYA COULTERI	MATILIJA POPPY	6' O.C.	L	5
			5 GAL	RIBES VIBURNIFOLIUM	RED FLOWERING CURRANT	3' O.C.	L	25
			1 GAL	FESTUCA OVINA 'GLAUCA'	SHEEP FESCUE	2' O.C.	L	25
	ESPALIERE	D PLANTS	@ COMMU	INITY GARDEN FENCE TO BE LOCA	TED IN FIELD			
	_	_	15 GAL	PRUNUS SALICINA 'WEEPING'	SANTA ROSA PLUM	AS SHOWN	M	2
-	_	_	15 GAL	CITRUS MEYERI	MEYER LEMON	AS SHOWN	М	2
	_	_	15 GAL	FICUS CARICA 'DESERT KING'	MISSION FIG	AS SHOWN	M	2
	-	_	15 GAL	MALUS DOMESTICA	GRANNY SMITHY APPLE	AS SHOWN	М	2
	_	_	15 GAL	VITUS CALIFORNICA	CALIFORNIA WILD GRAPE	AS SHOWN	M	2
	SIDEWALK	PLANTERS	- 815 SF					
			1/4 " MIN	US BLUE PATHWAY FINES MULCH,	3" DEPTH			

PLANTING ALTERNATE:

BASE BID: LABOR TO INSTALL PLANTS LISTED ON THIS SHEET, WEED FABRIC AND MULCH SHALL BE PERFORMED BY RECREATION AND PARK DEPARTMENT STAFF WITHIN THE PARK BOUNDARY.

ALTERNATE #7: LABOR TO INSTALL PLANTS LISTED ON THIS SHEET, WEED FABRIC AND MULCH SHALL BE PERFORMED BY CONTRACTOR WITHIN THE PARK BOUNDARY.

BUILDING DESIGN & CONSTRUCTION



DEPARTMENT OF PUBLIC WORKS
CITY AND COUNTY OF SAN FRANCISCO

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Project

17th AND FOLSOM STREET PARK

2080 FOLSOM STREET SAN FRANCISCO, CA 94110

Consultant

Issue

100% BID SET

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Drawing Title


PLANTING LEGEND

Sheet No.

L-7.1

Job No.


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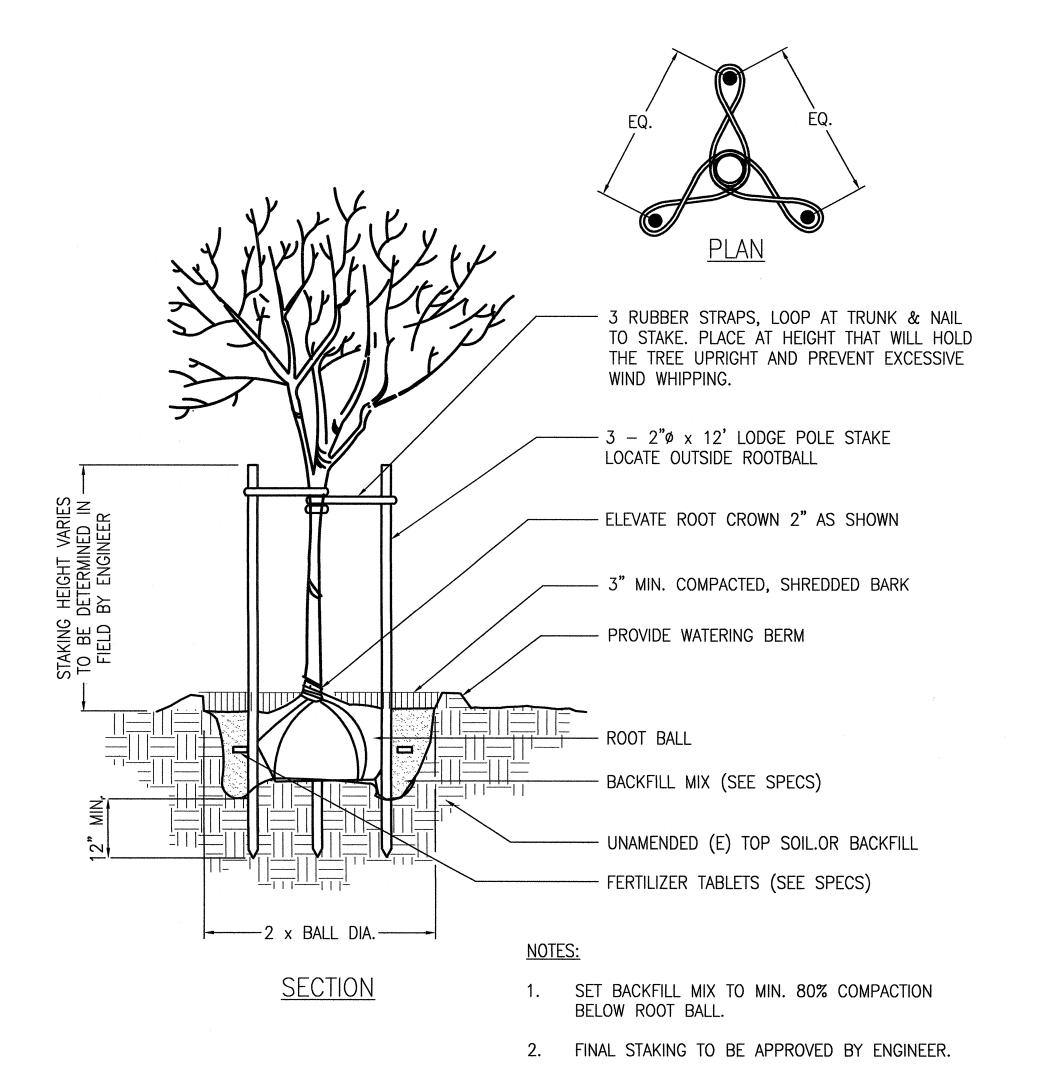
GROUND COVER PLANTING

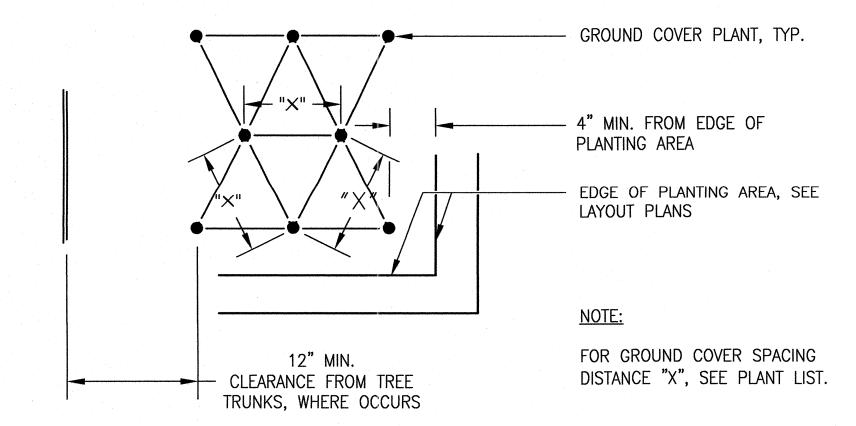SHRUB PLANTING

NOT TO SCALE



NOT TO SCALE

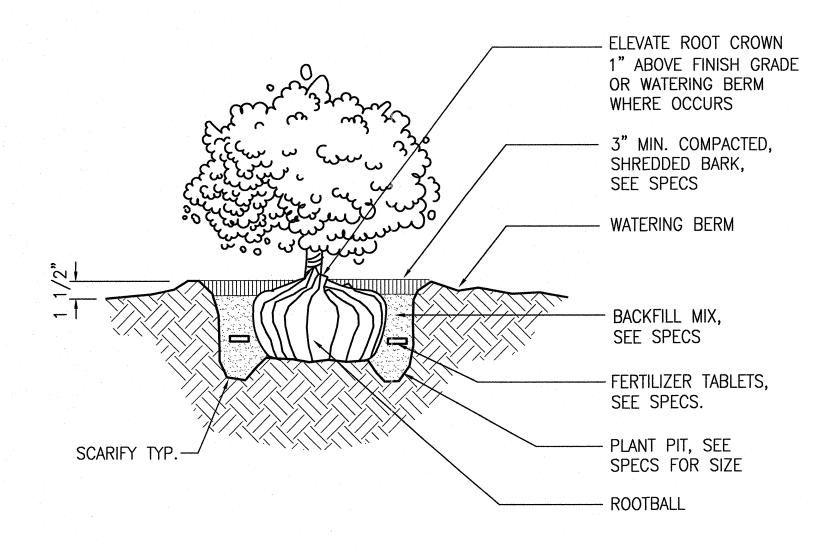

TREE PLANTING & STAKING

NOT TO SCALE

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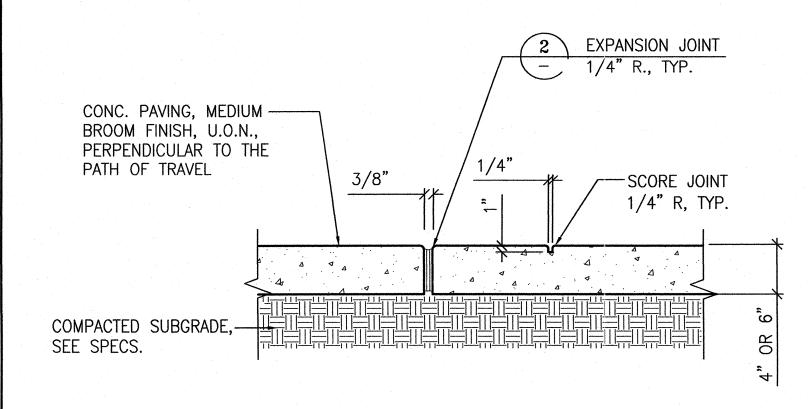
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Landscape Architect						

PLANTING DETAILS

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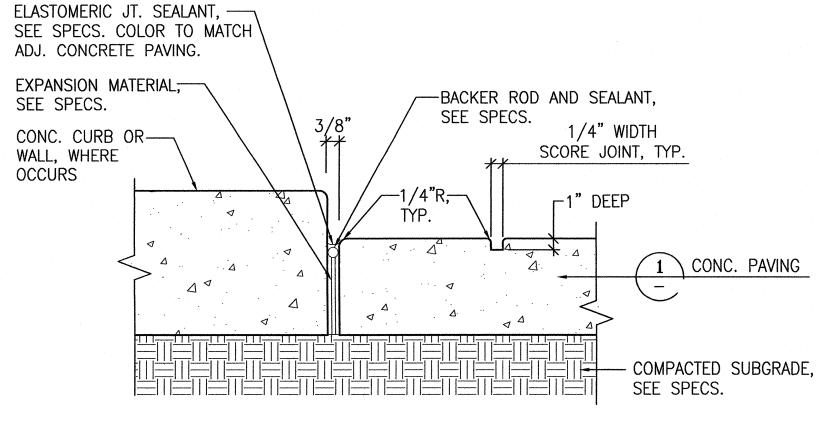
NOTES:

1. PLACE EXPANSION JOINTS WHERE PAVING ABUTS ANY VERTICAL SURFACE.

2. 6" CONCRETE TO BE USED IN 10' WIDE PATH. 6" CONCRETE SHALL HAVE #4 REBAR 12" O.C. EACH WAY

CONCRETE PAVING

SCALE: 1"=1'-0"



NOTES:

- 1. PLACE EXPANSION JOINTS WHERE PAVING ABUTS ALL VERTICAL SURFACES.
- 2. HANDTOOL ALL JOINTS.

EXPANSION & SCORE JOINT

SCALE: N.T.S.

THICKENED CONCRETE EDGE

8" MIN.

1 CONC. PAVING

SCALE: 1"=1'-0"

- COMPACTED SUBGRADE,


SEE SPECS.

-CONC. PAVING, A.C. PAVING

OR UNIT PAVERS, SEE

PAVING PLAN


—— 1/4" RADIUS

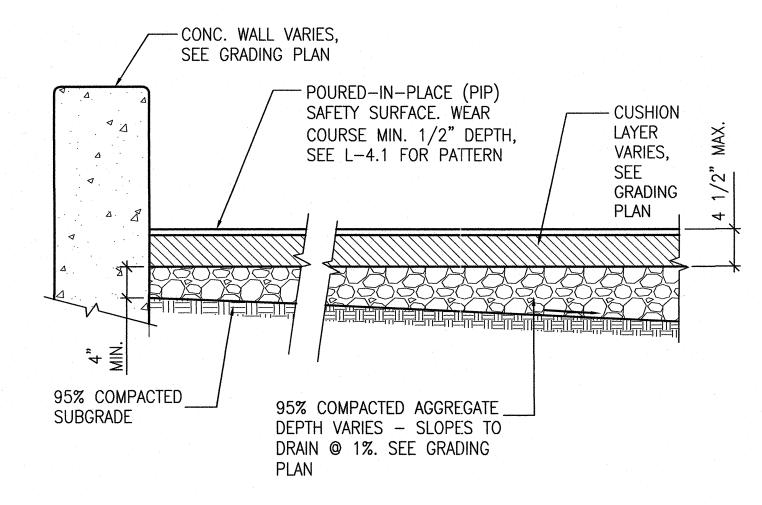

PIP SAFETY SURFACE

SCALE: N.T.S.




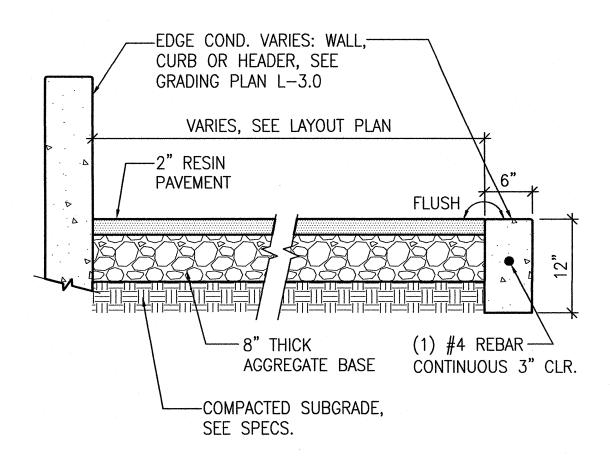

RESIN PAVEMENT - ALTERNATE

SCALE: 1"=1'-0"

5

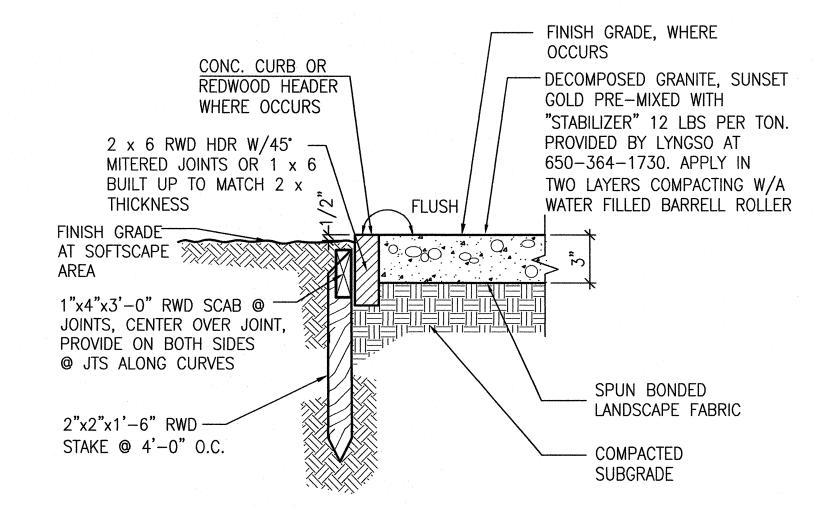

DECOMPOSED GRANITE/HEADER

6 SCALE: N.T.S

BUILDING **DESIGN & CONSTRUCTION**



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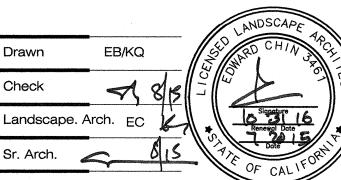
17th AND FOLSOM STREET PARK

2080 FOLSOM STREET SAN FRANCISCO, CA 94110

Consultant

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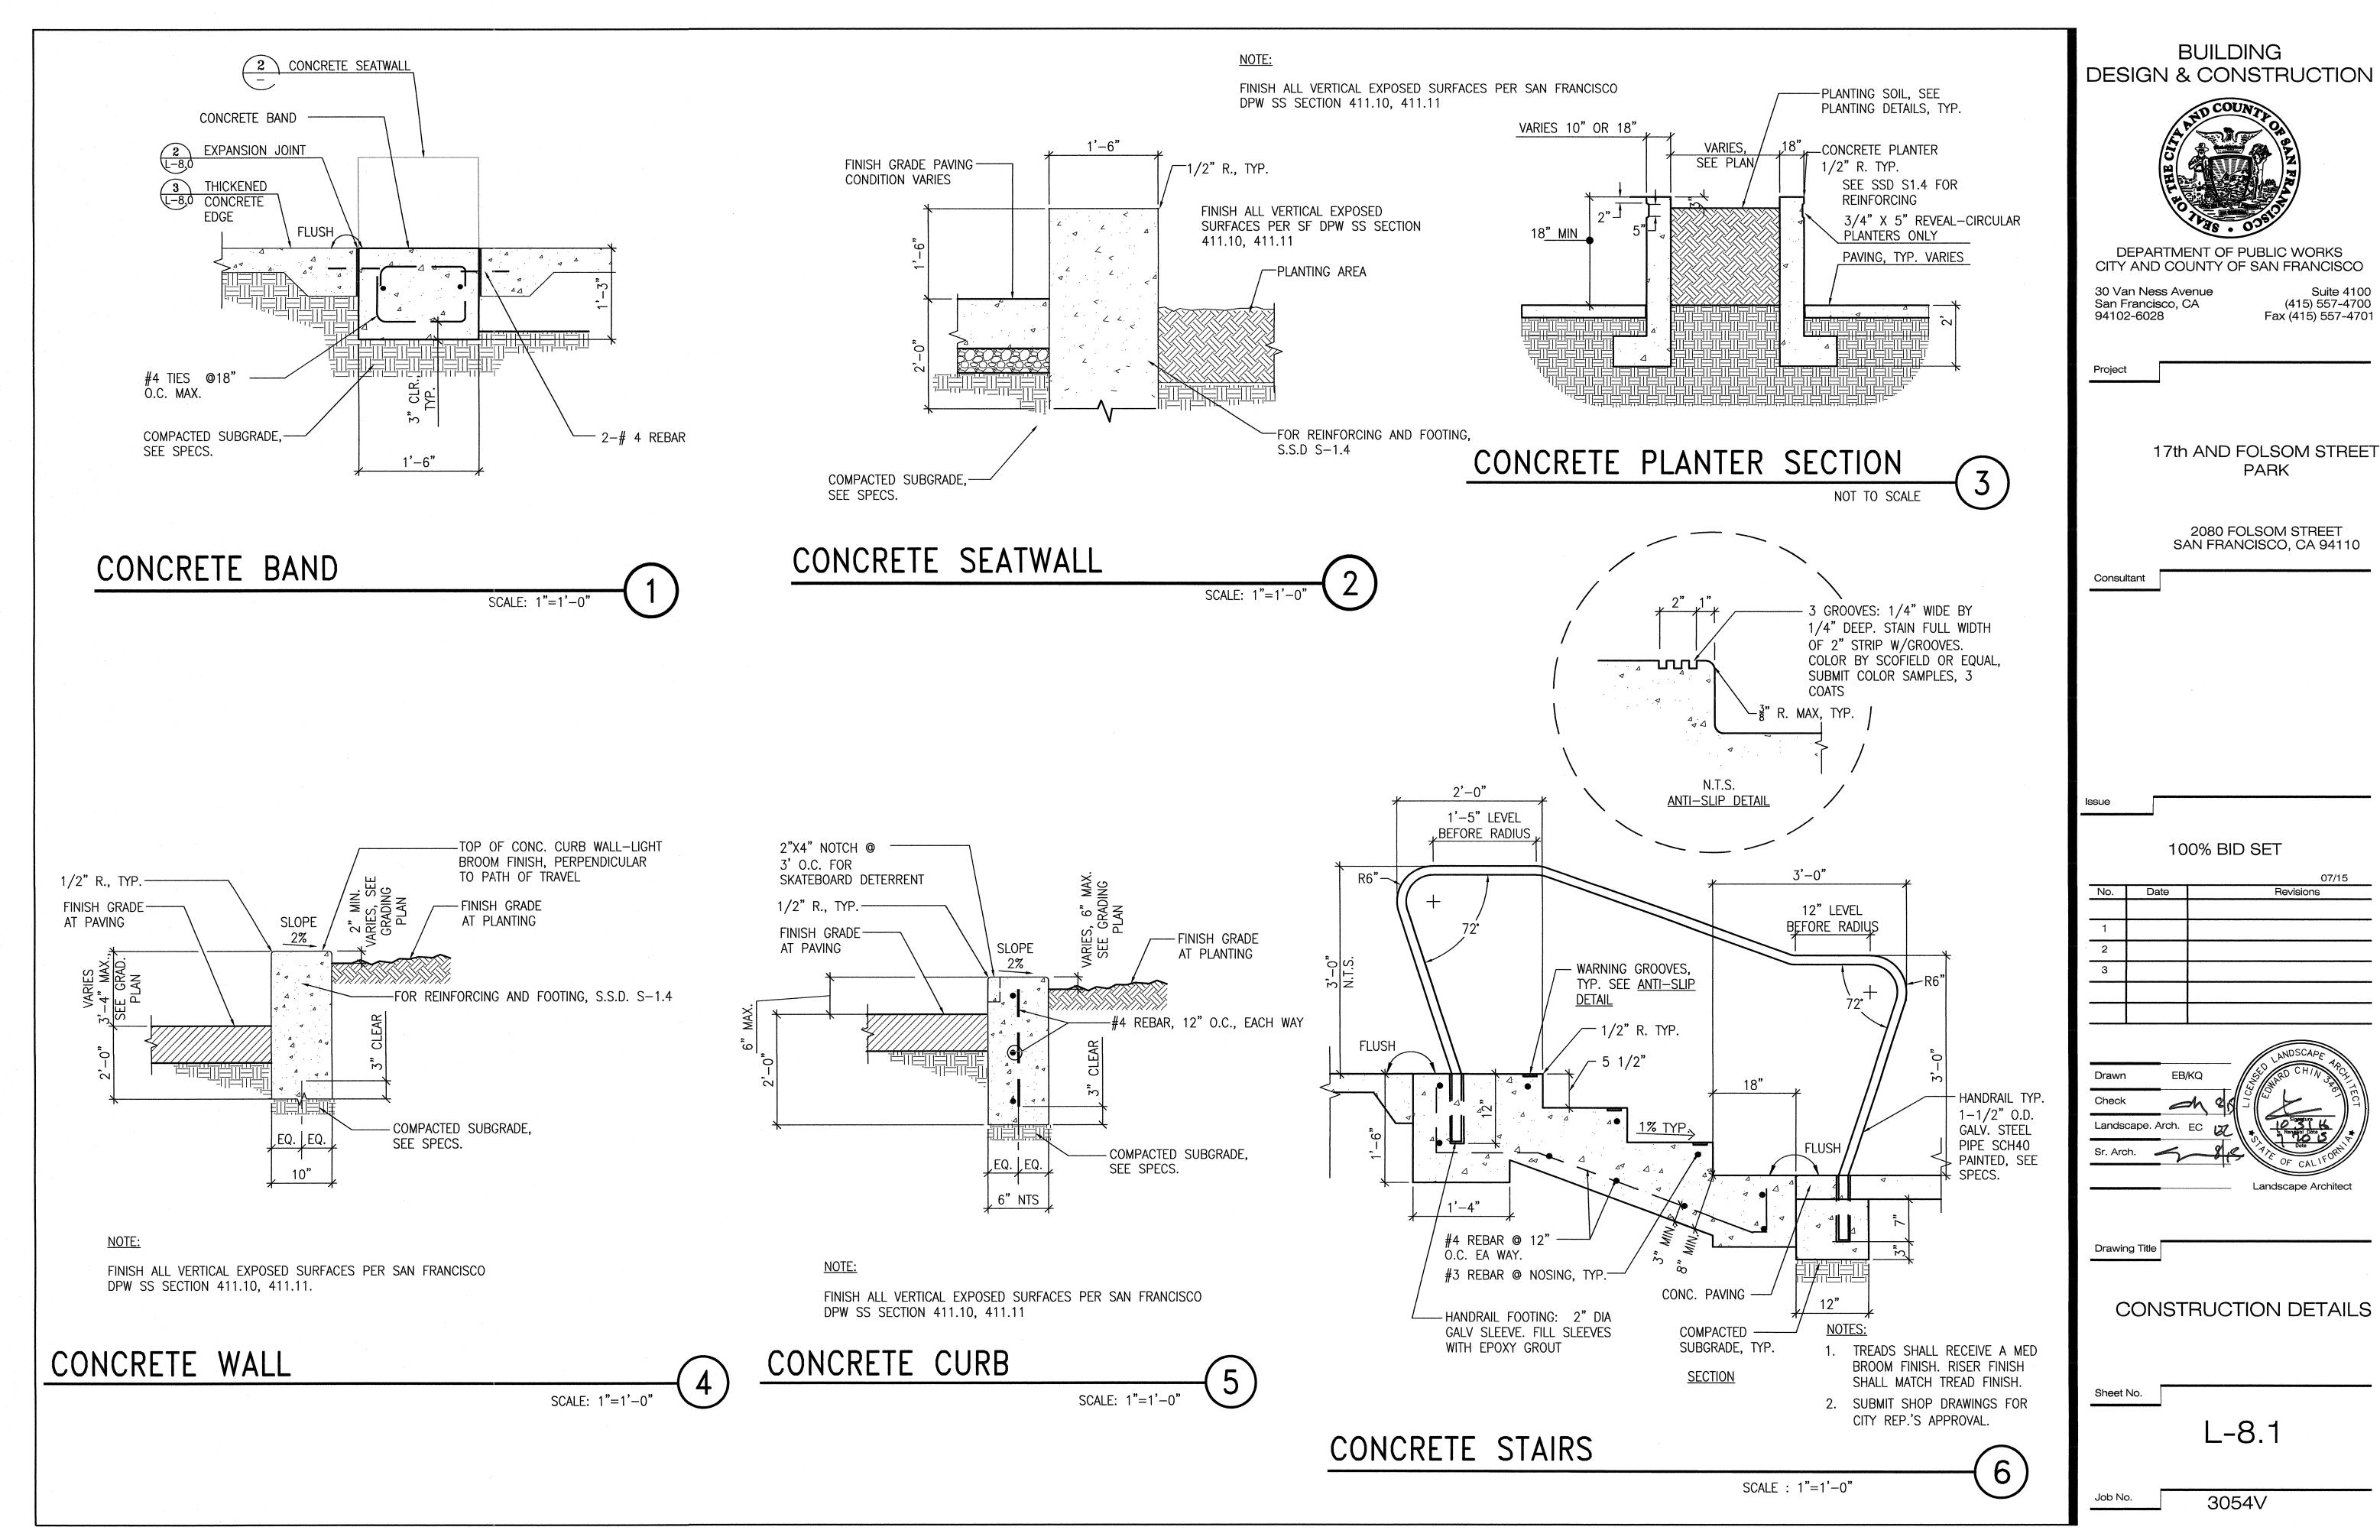



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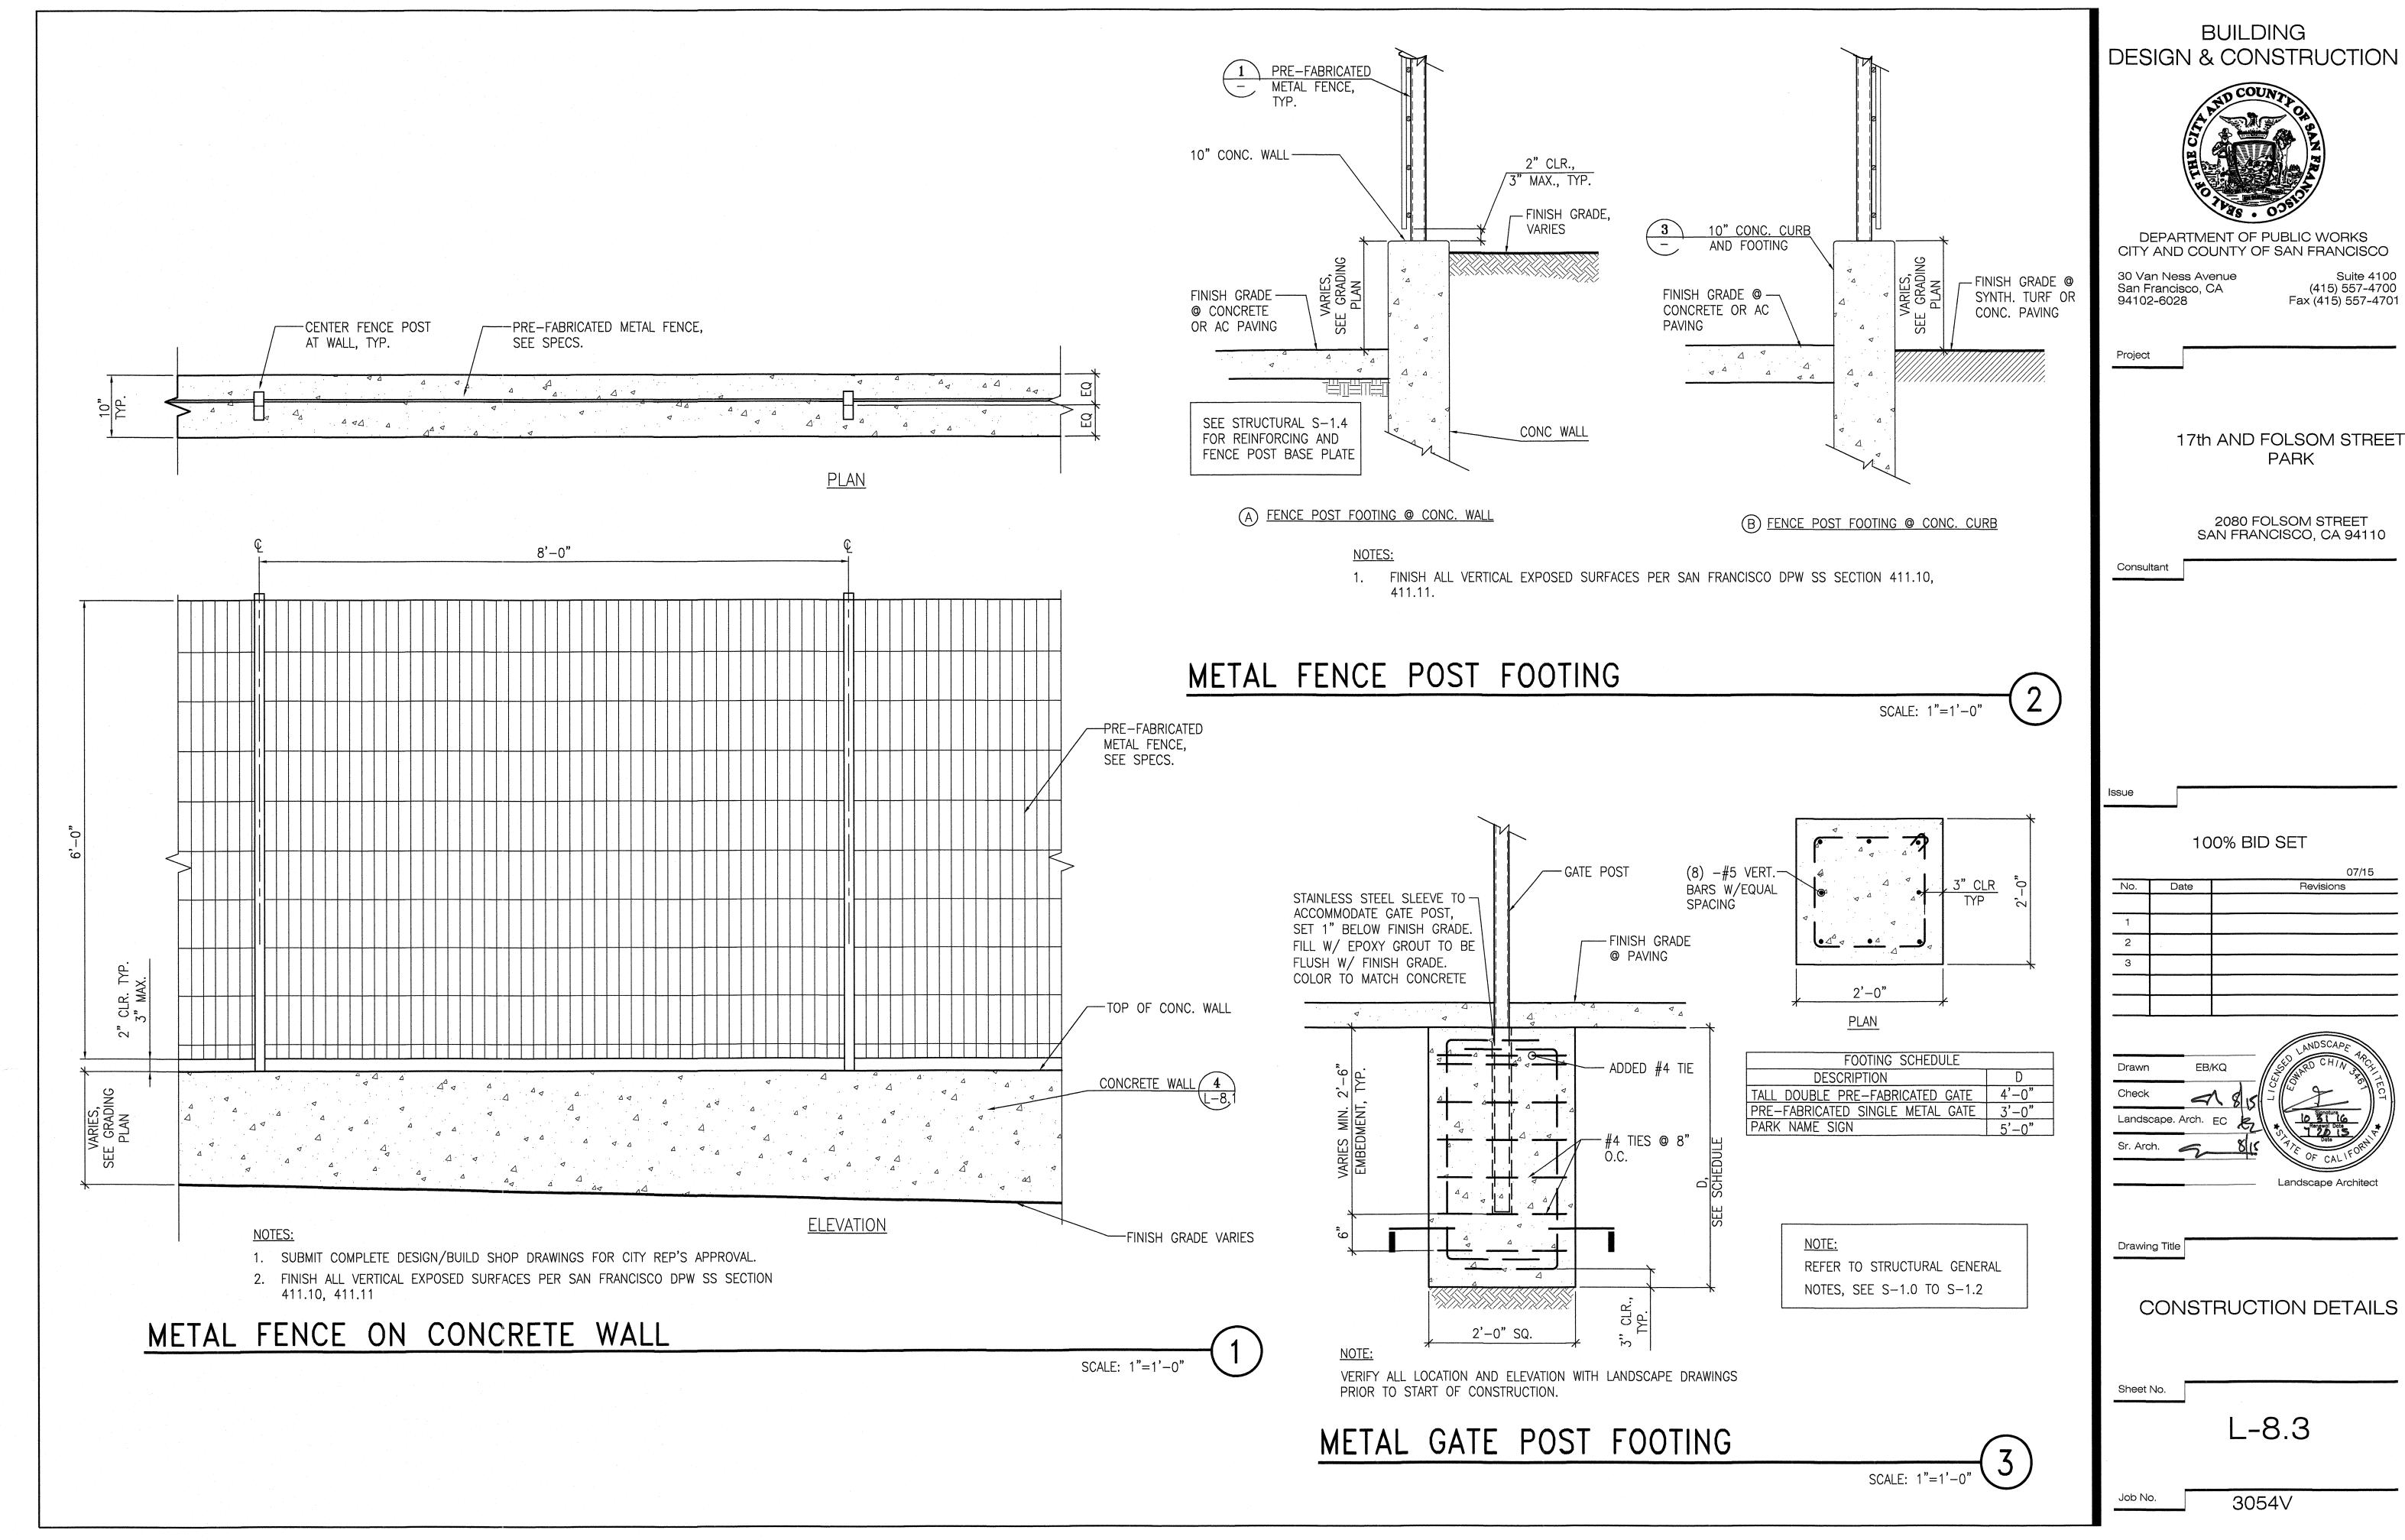
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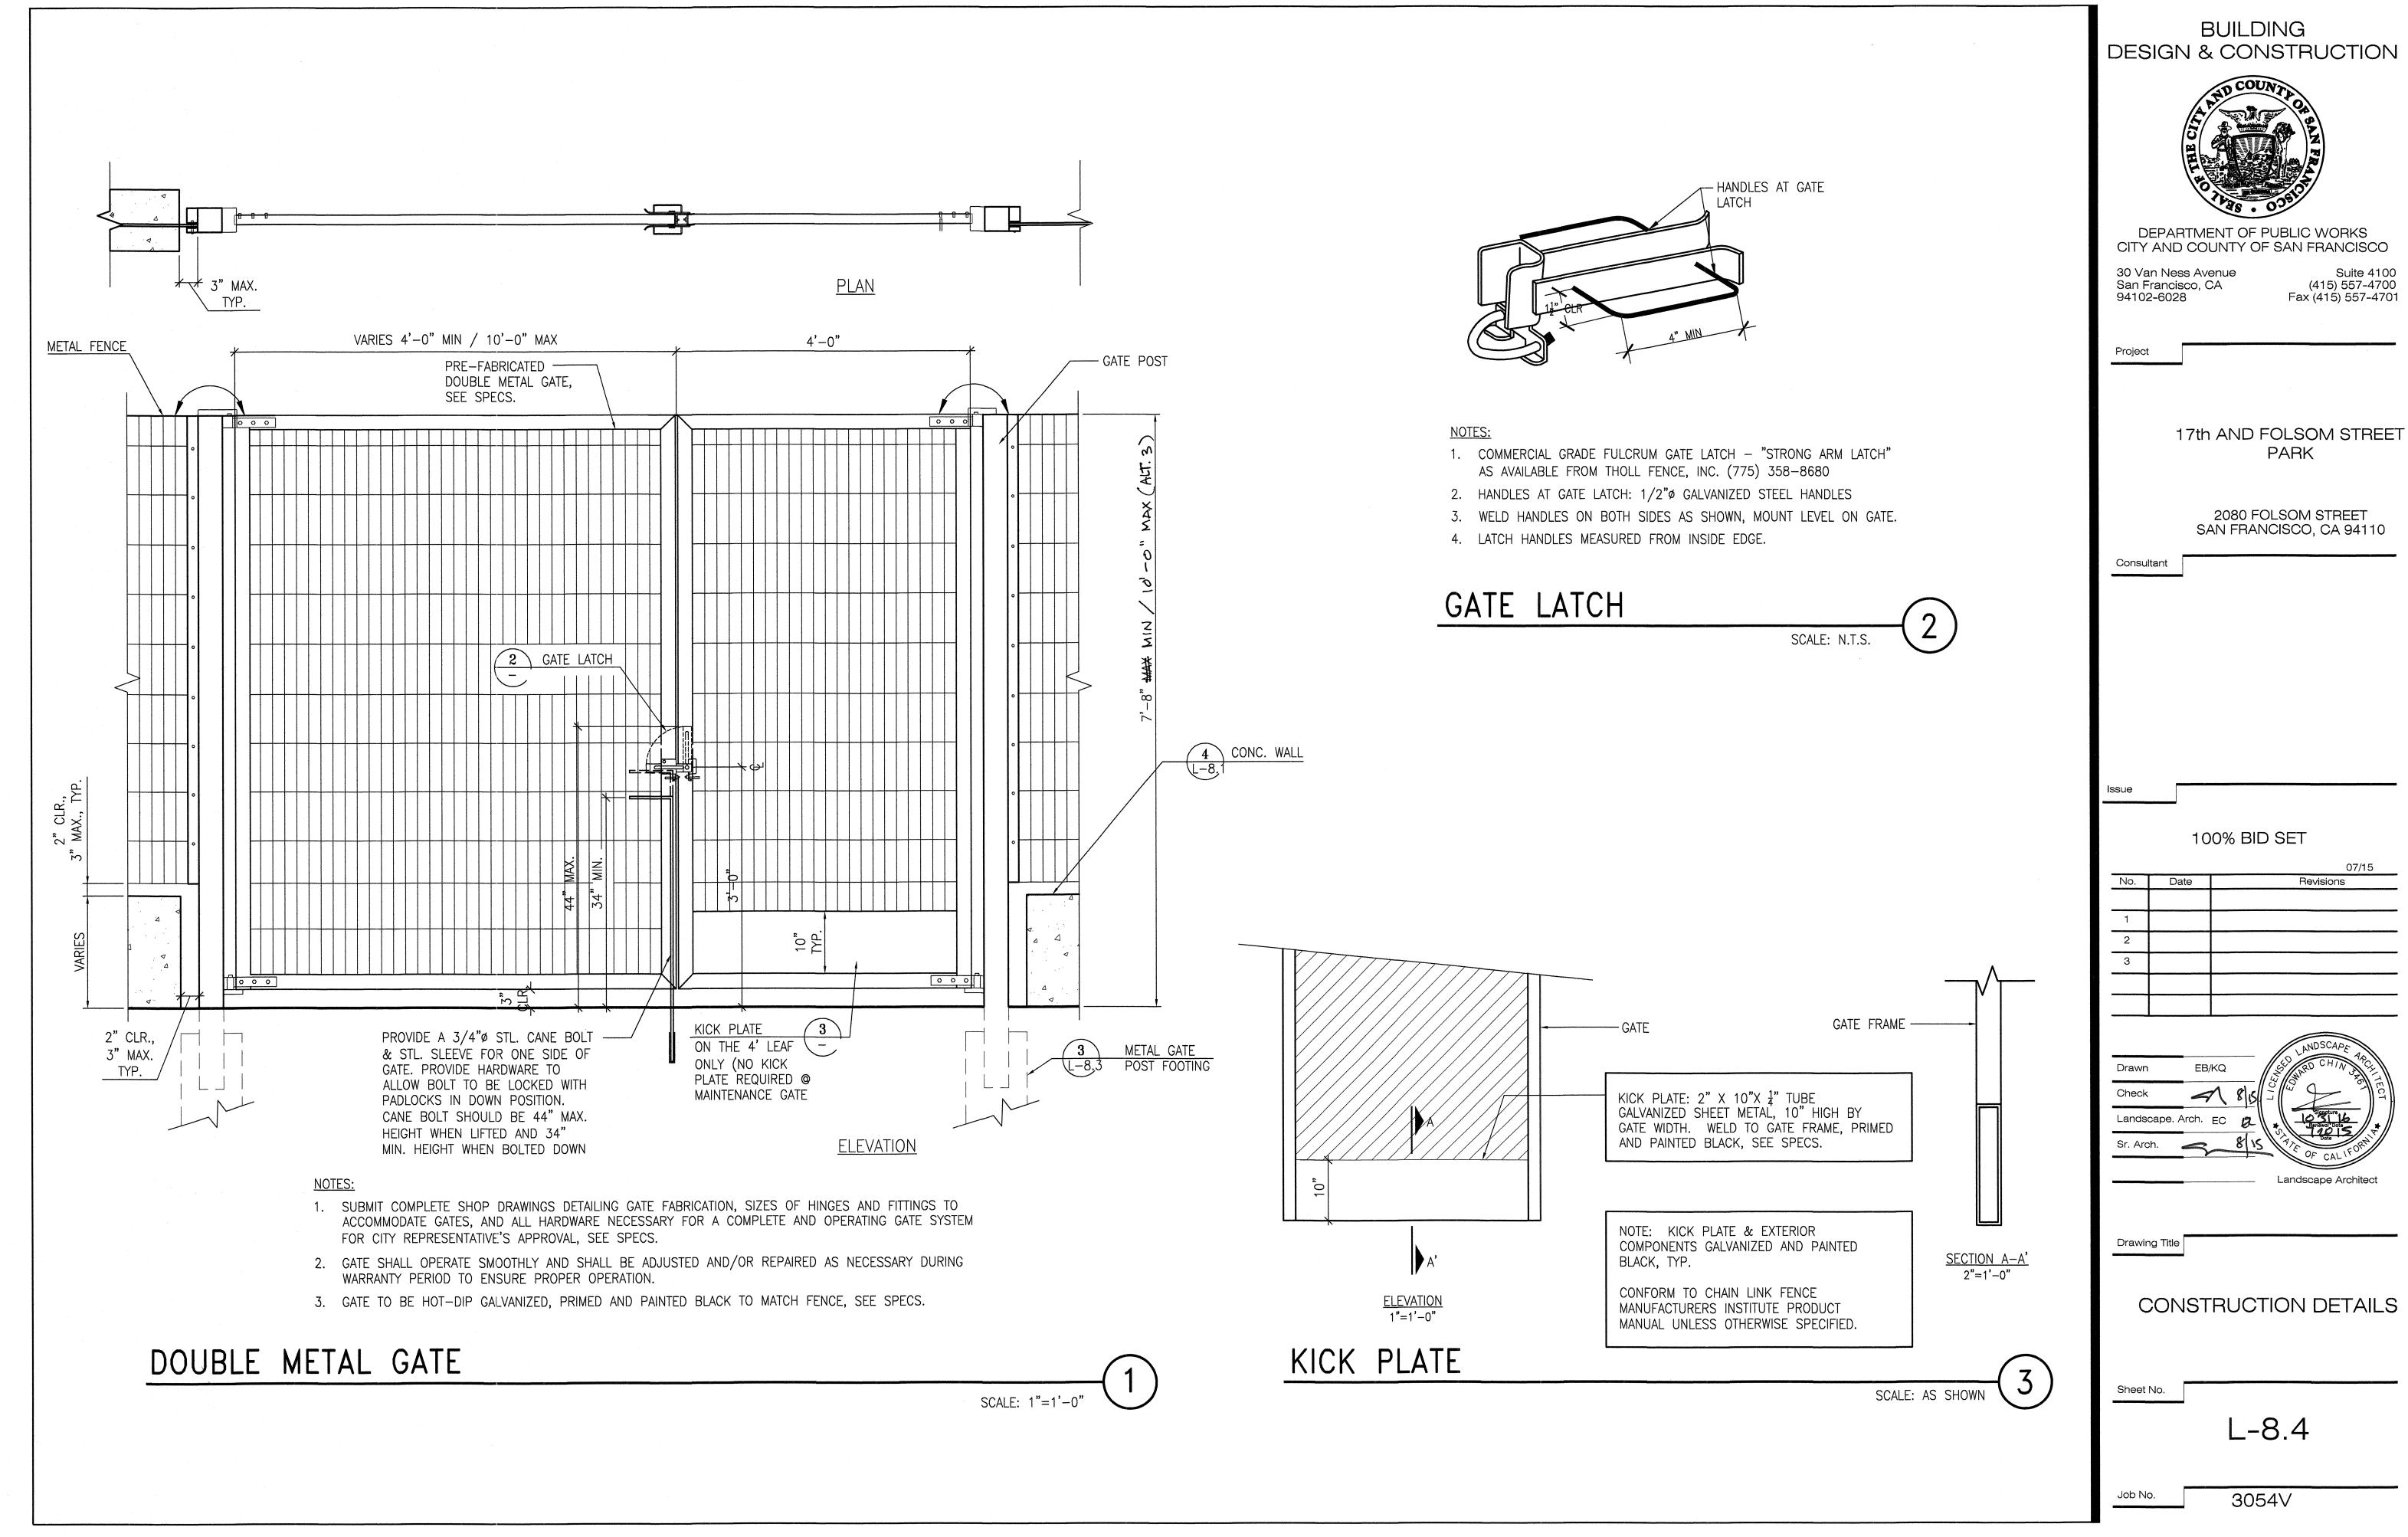
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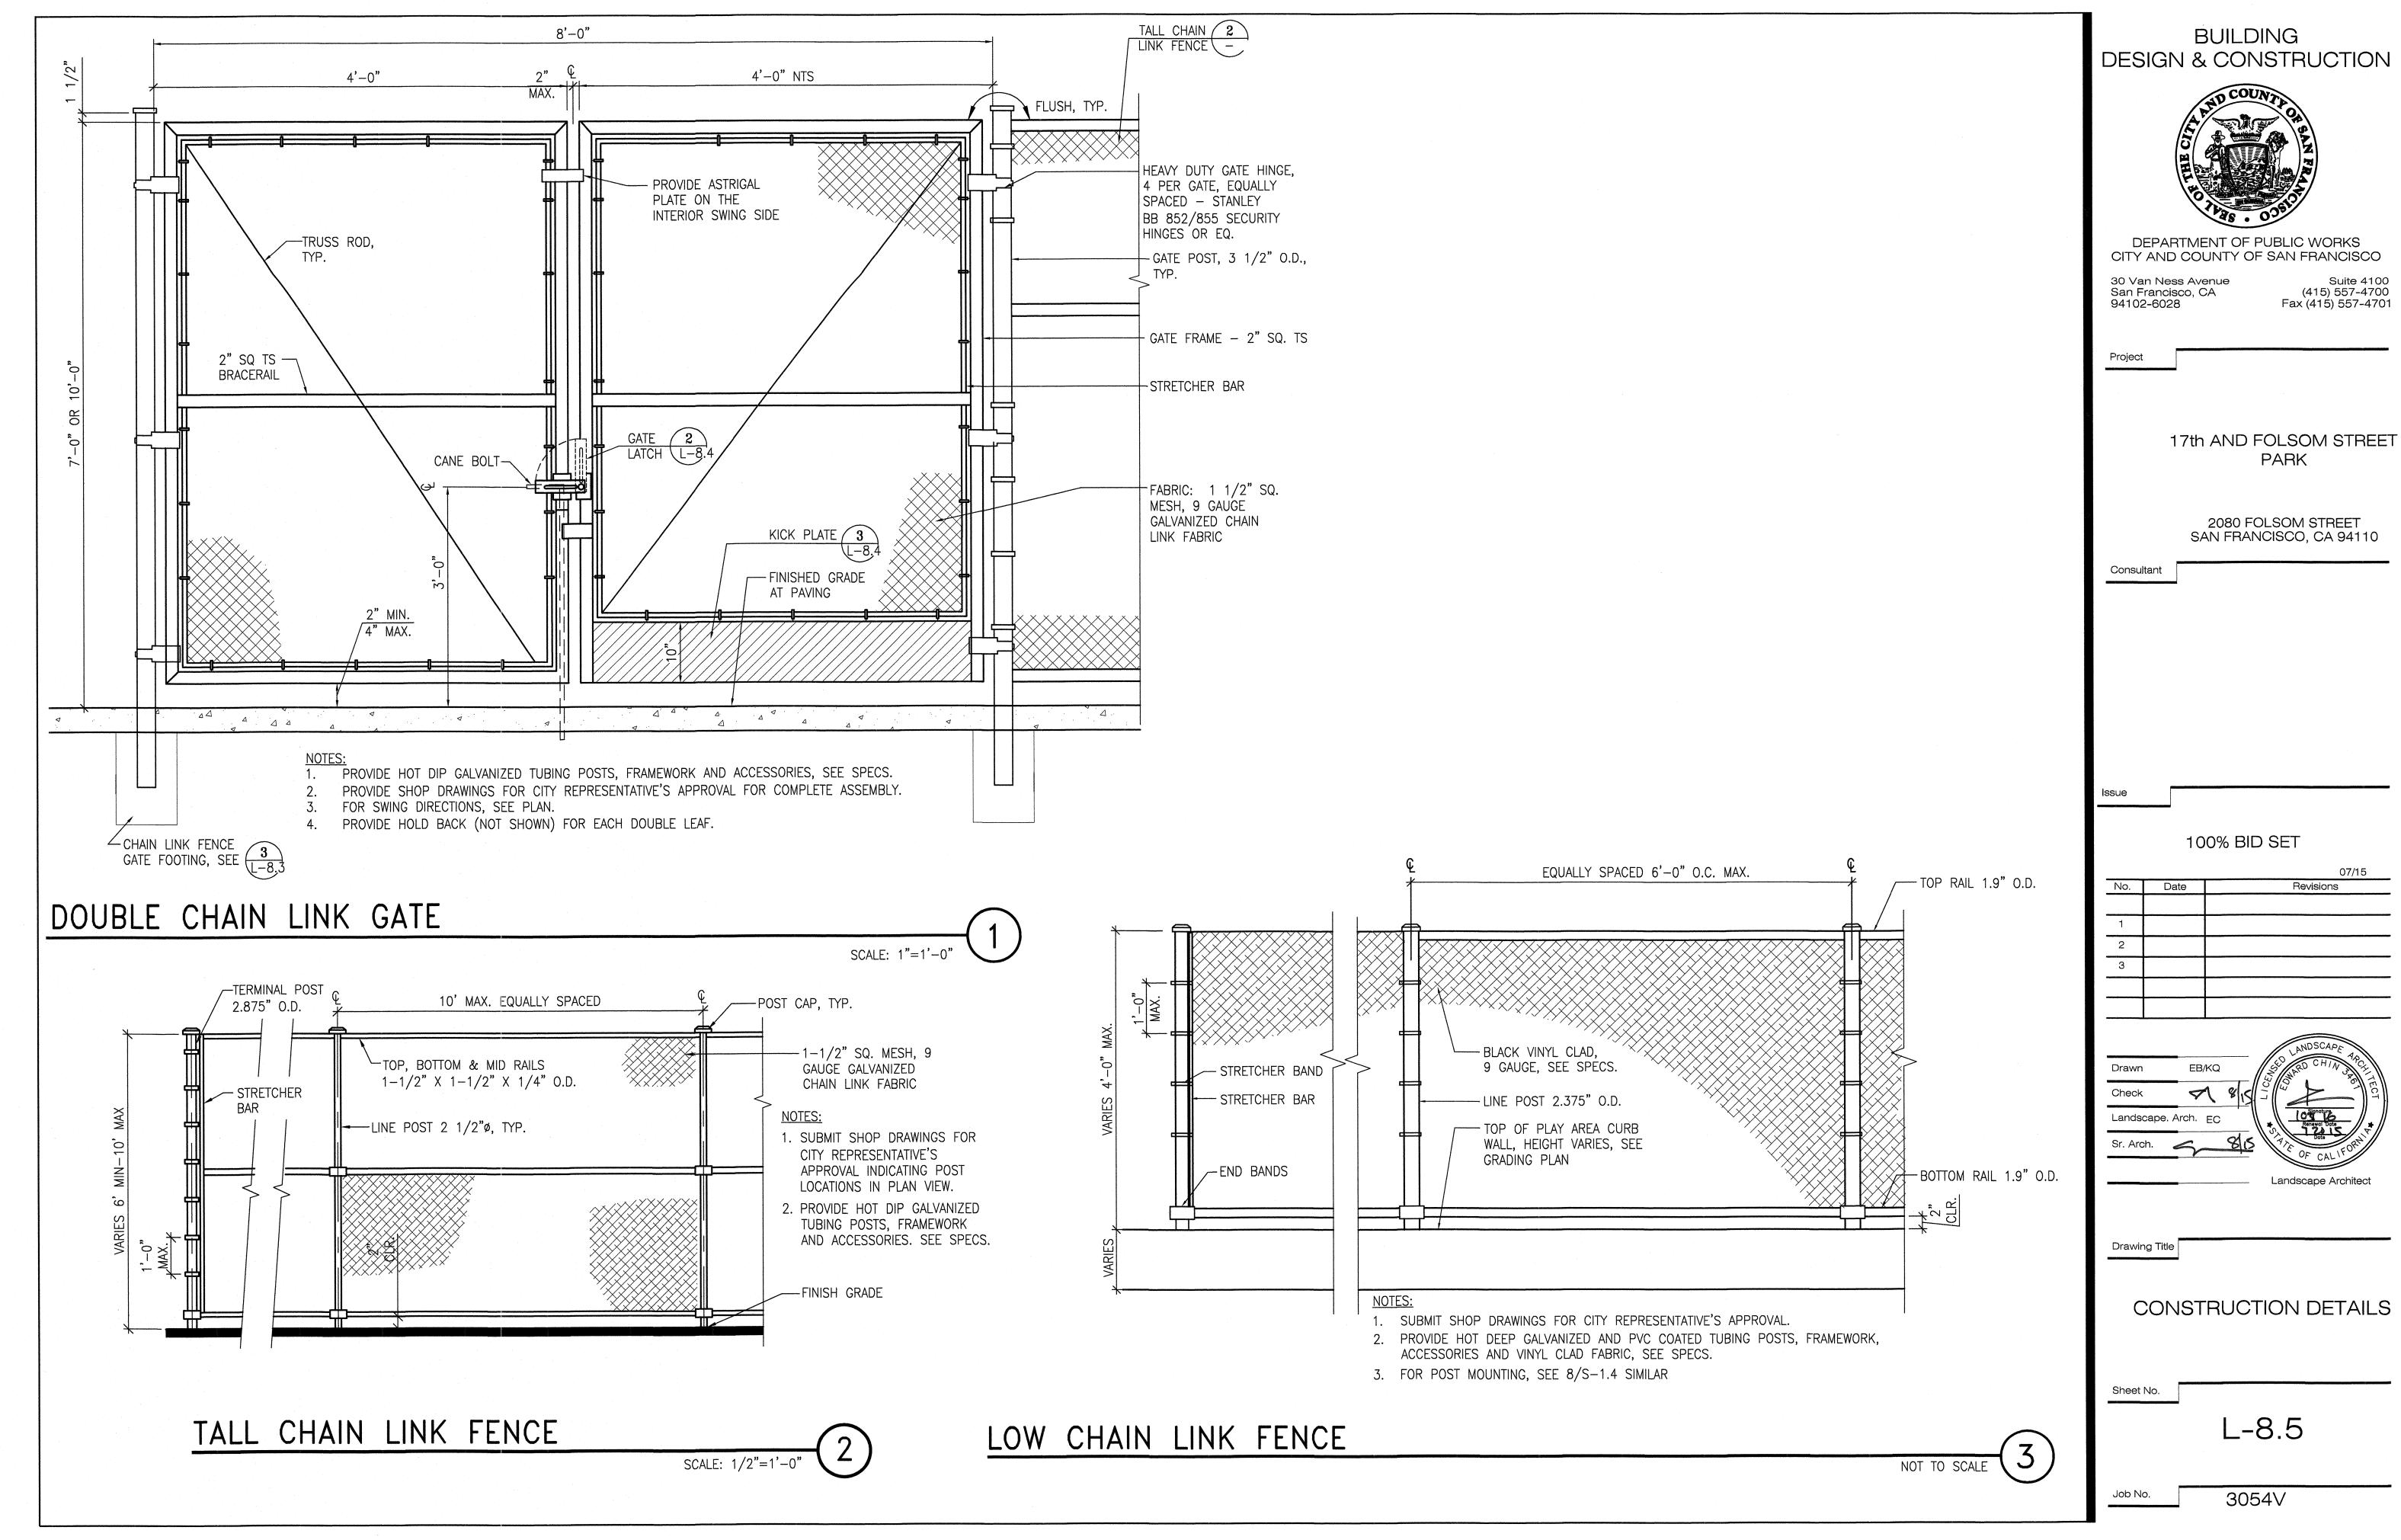
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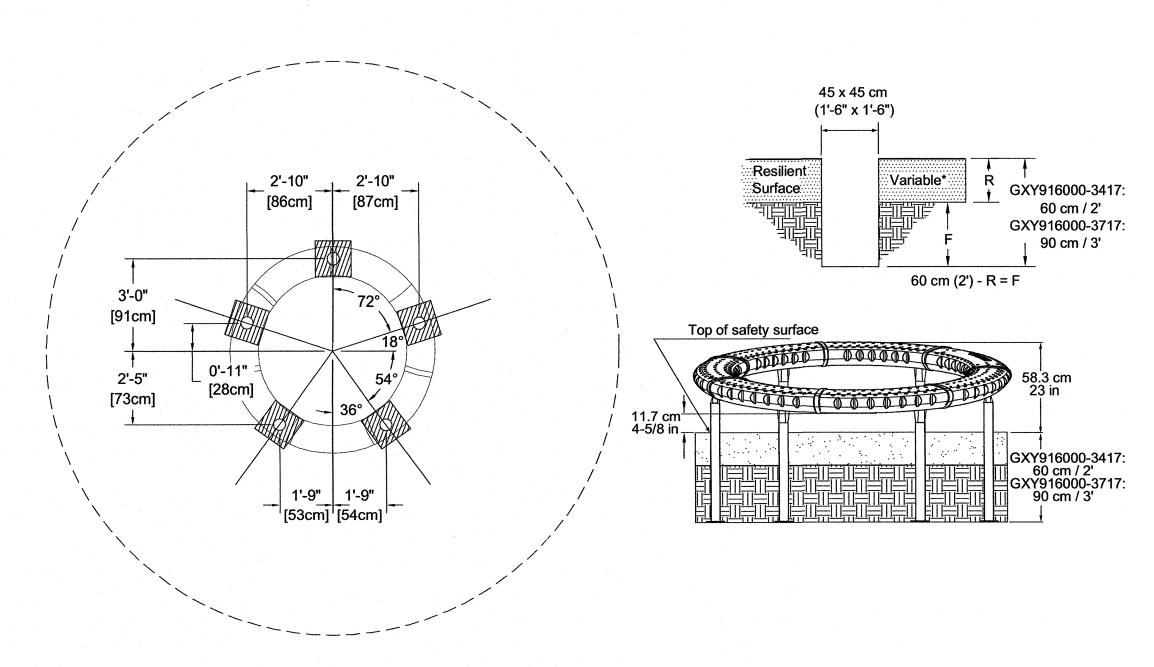








GXY916 - SUPERNOVA IN-GROUND FOOTINGS

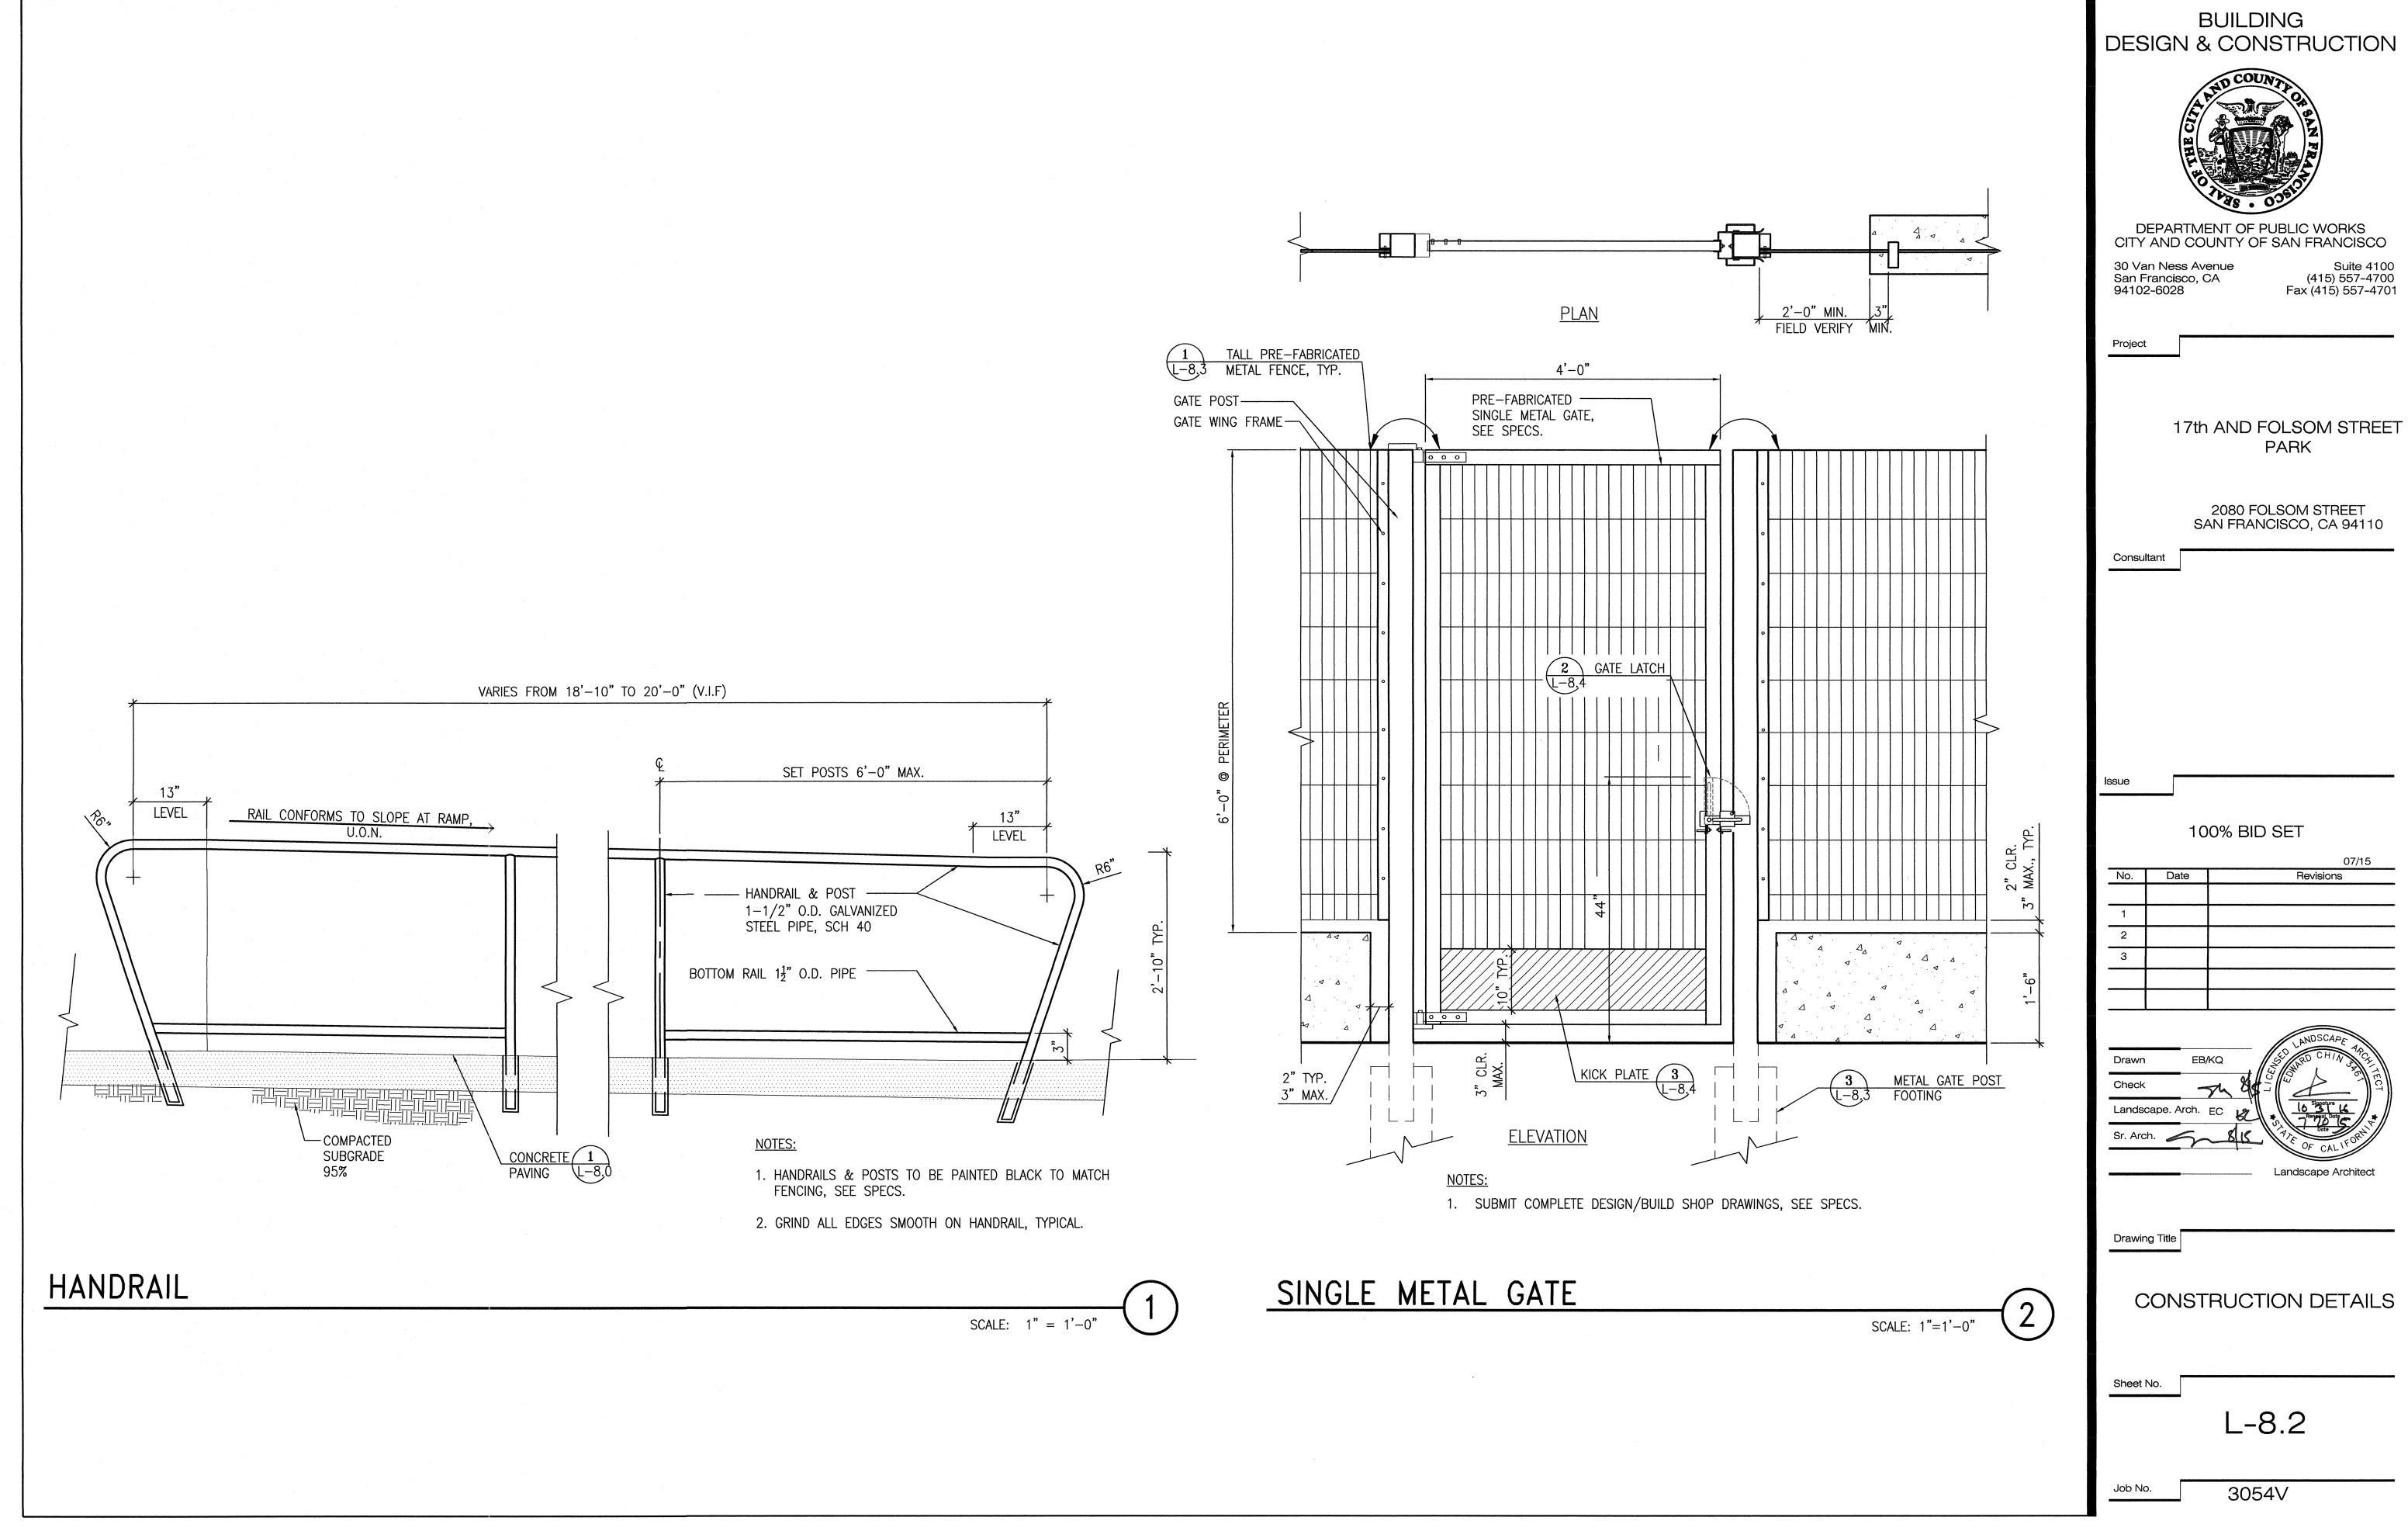

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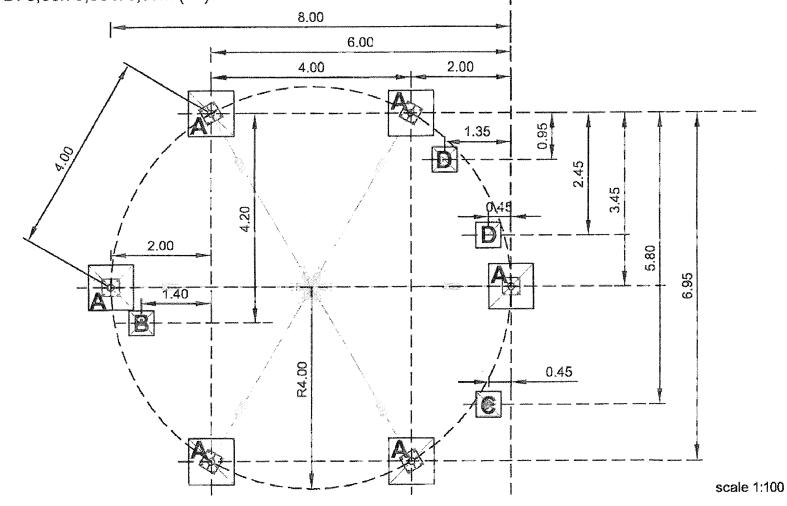
WHIRL FOOTING


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8630: EXPLORER DOME

Foundation plan Synthetic surfacing

Foundation A: 0,90 x 0,90 x 0,30m (6x) Foundation B, C, D: 0,50x 0,50 x 0,30m (4x)



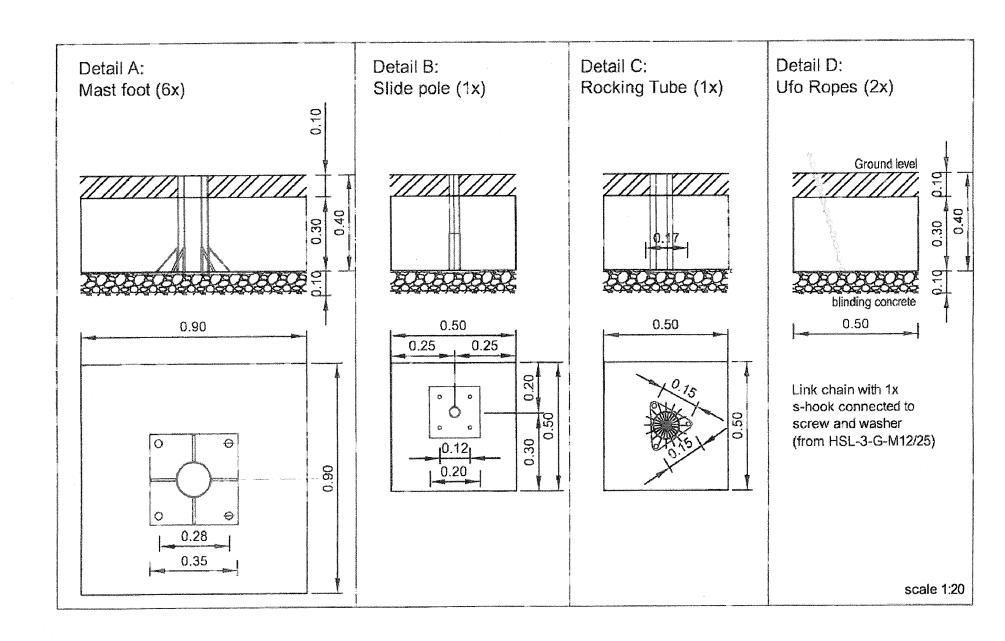

Quality of concrete: C 25/30 (B 25)
The notes to the foundation plan are to be observed!
Subject to technical alterations. / Please ask for current standards.

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COROCORD
The Spacenet Inventors

NET STRUCTURE FOOTING

NOT TO SCALE

2)

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17th AND FOLSOM STREET PARK

2080 FOLSOM STREET SAN FRANCISCO, CA 94110

Consultant

Issue

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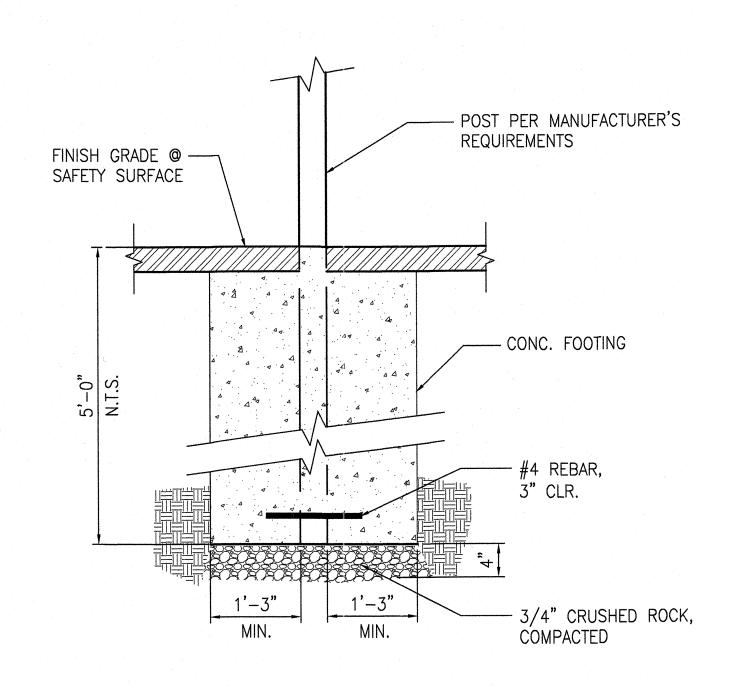
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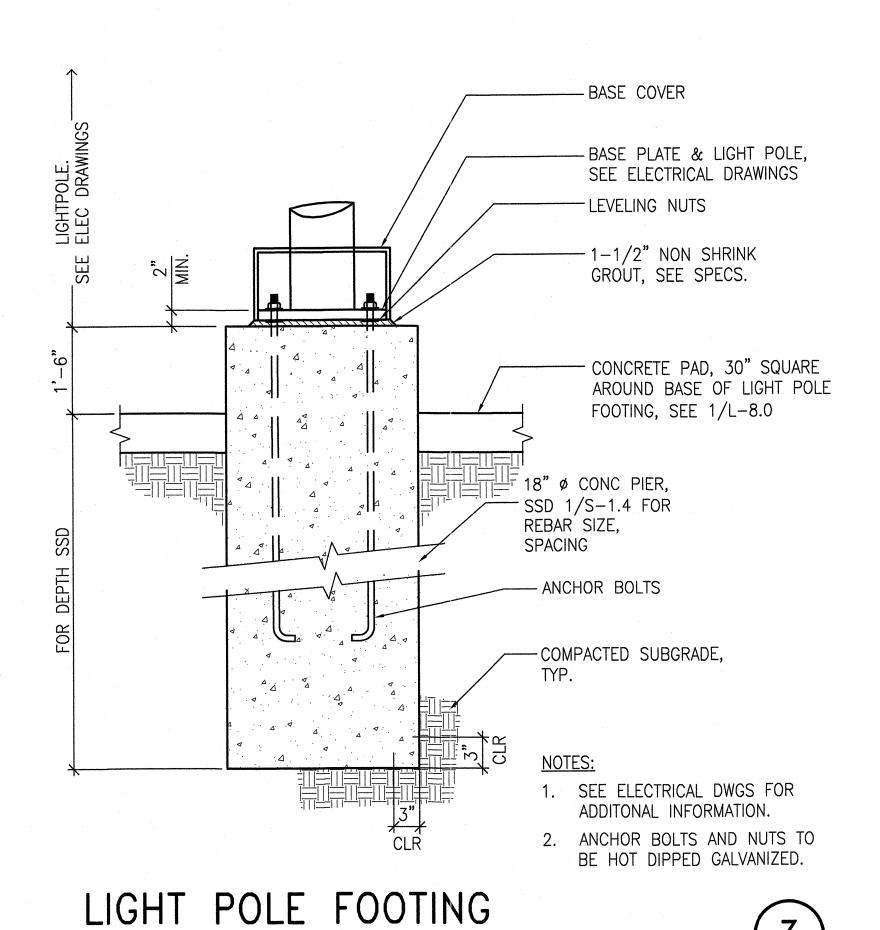
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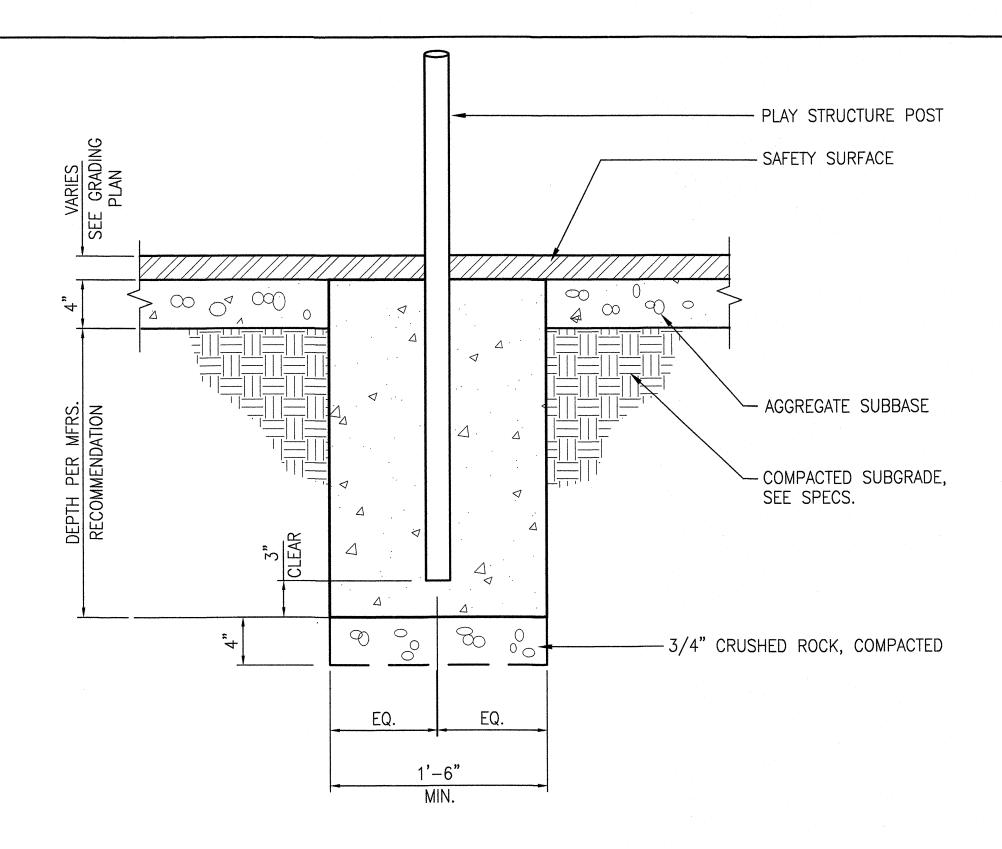
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TYPICAL FOOTING FOR BELT AND BUCKET SWINGS SCALE: 3/4"=1'-0"



SCALE: N.T.S.



TYPICAL FOOTING FOR PLAY EQUIPMENT

·_{-0"} 2

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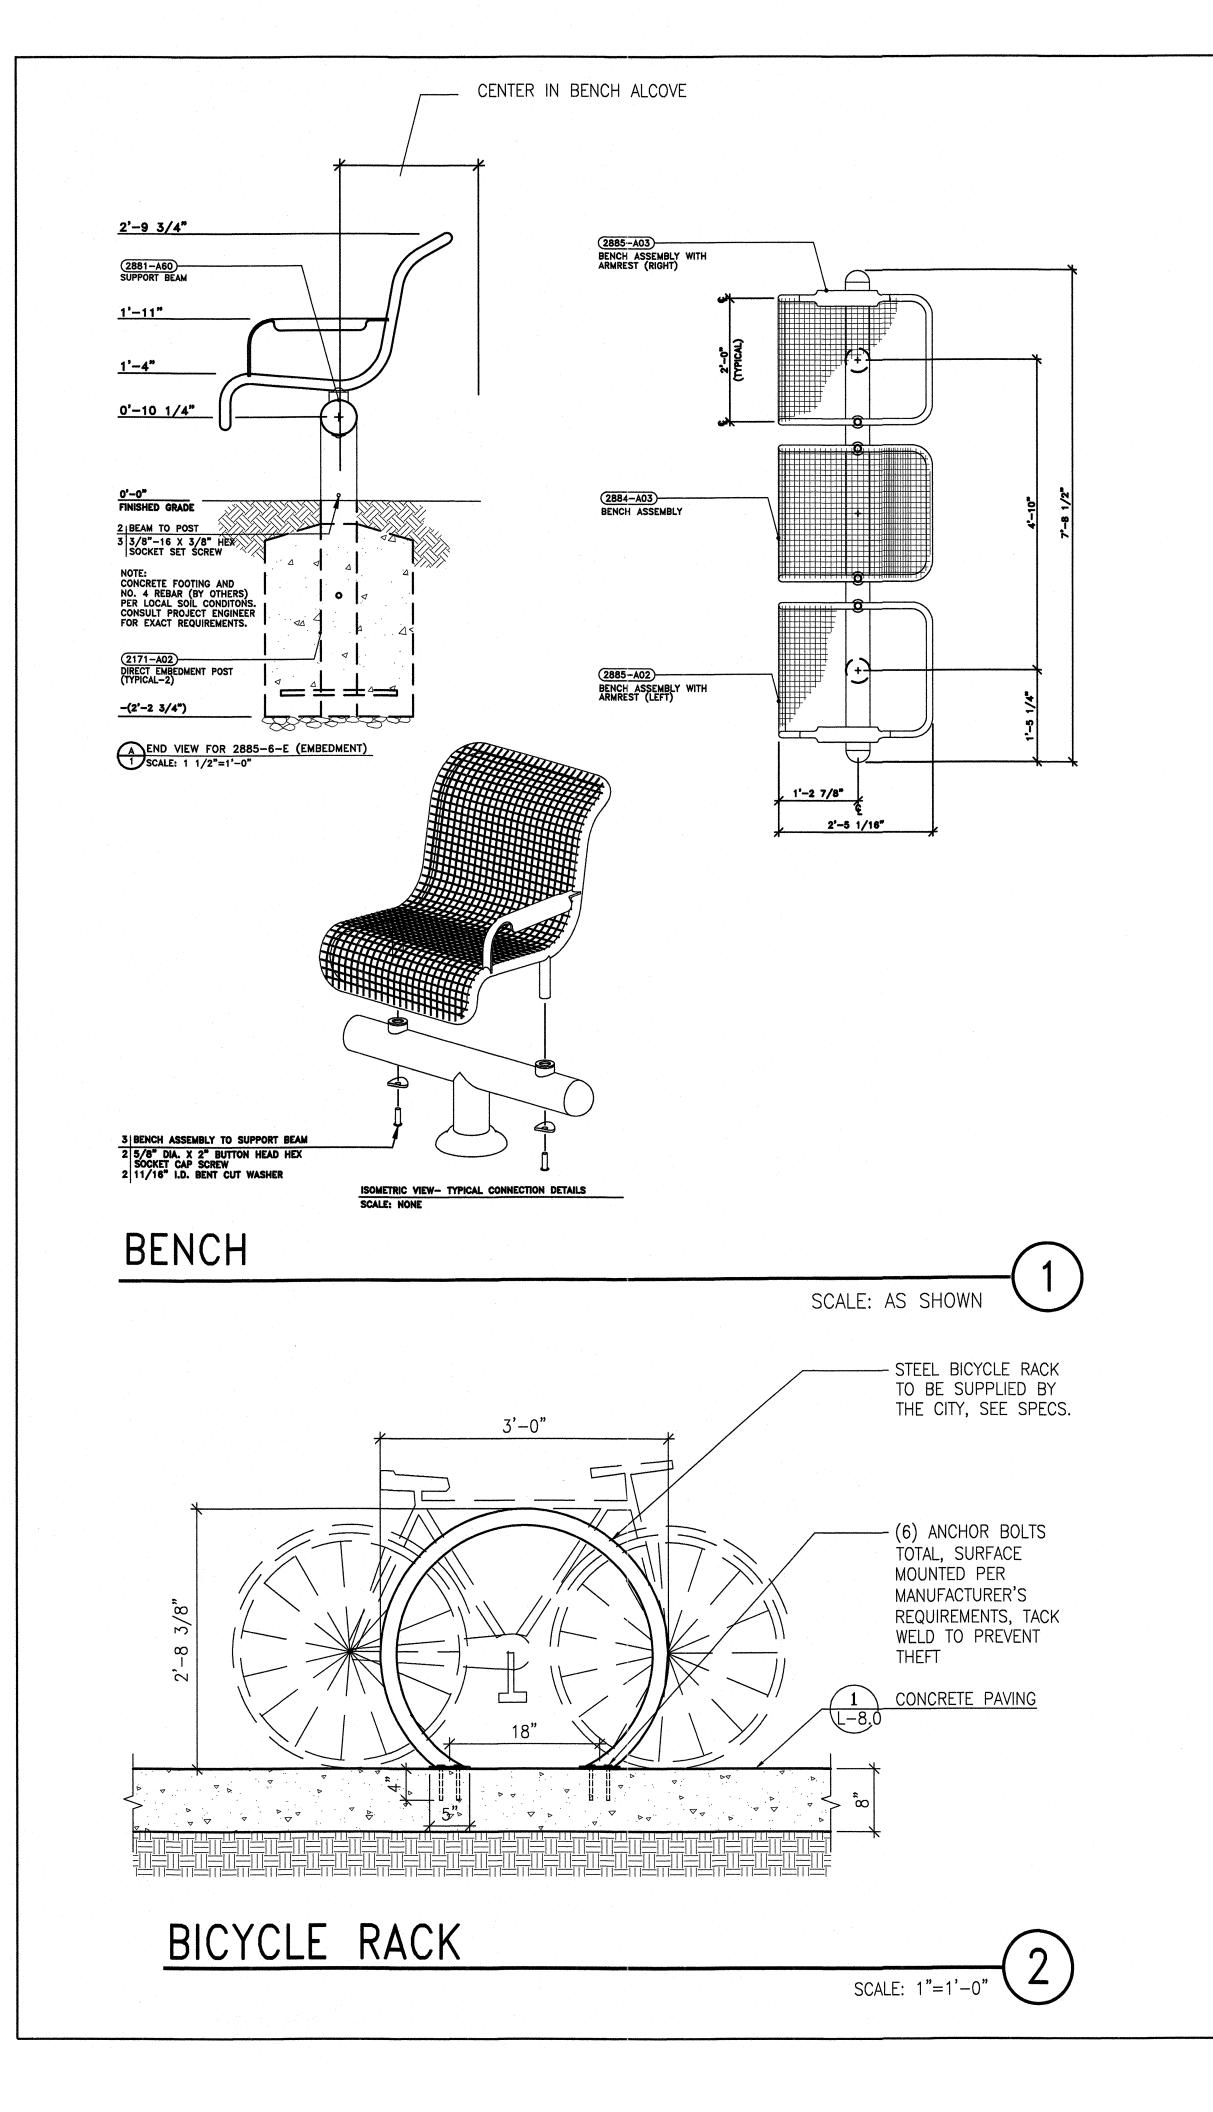
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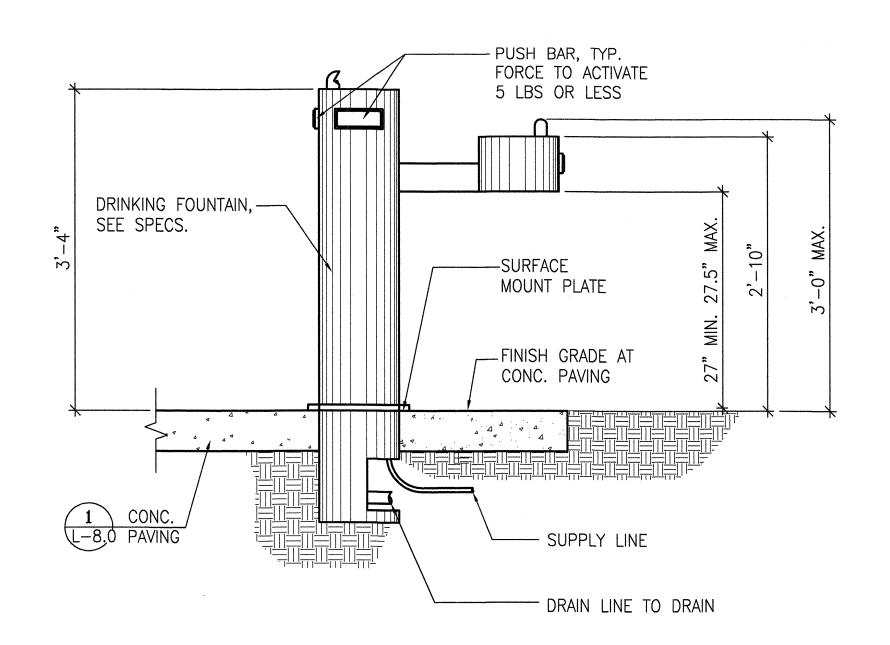
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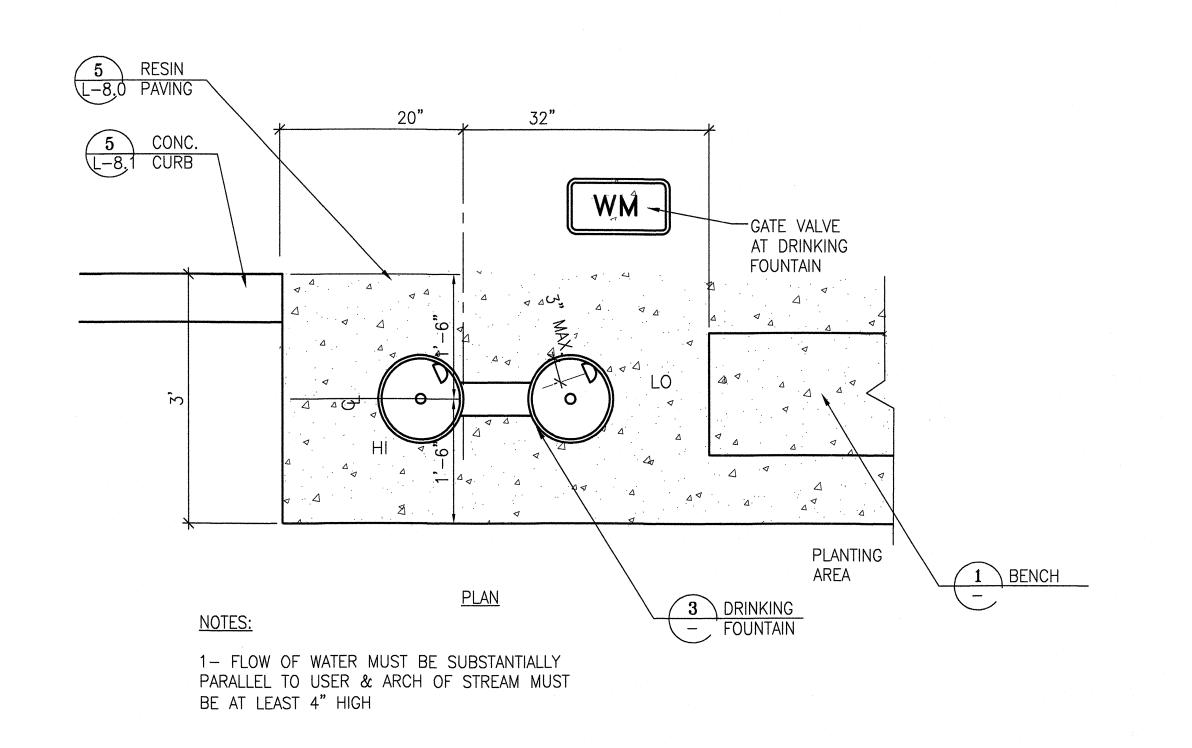
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DRINKING FOUNTAIN

SCALE: 1"=1'-0"



DRINKING FOUNTAIN - PLAN

SCALE: NTS

4

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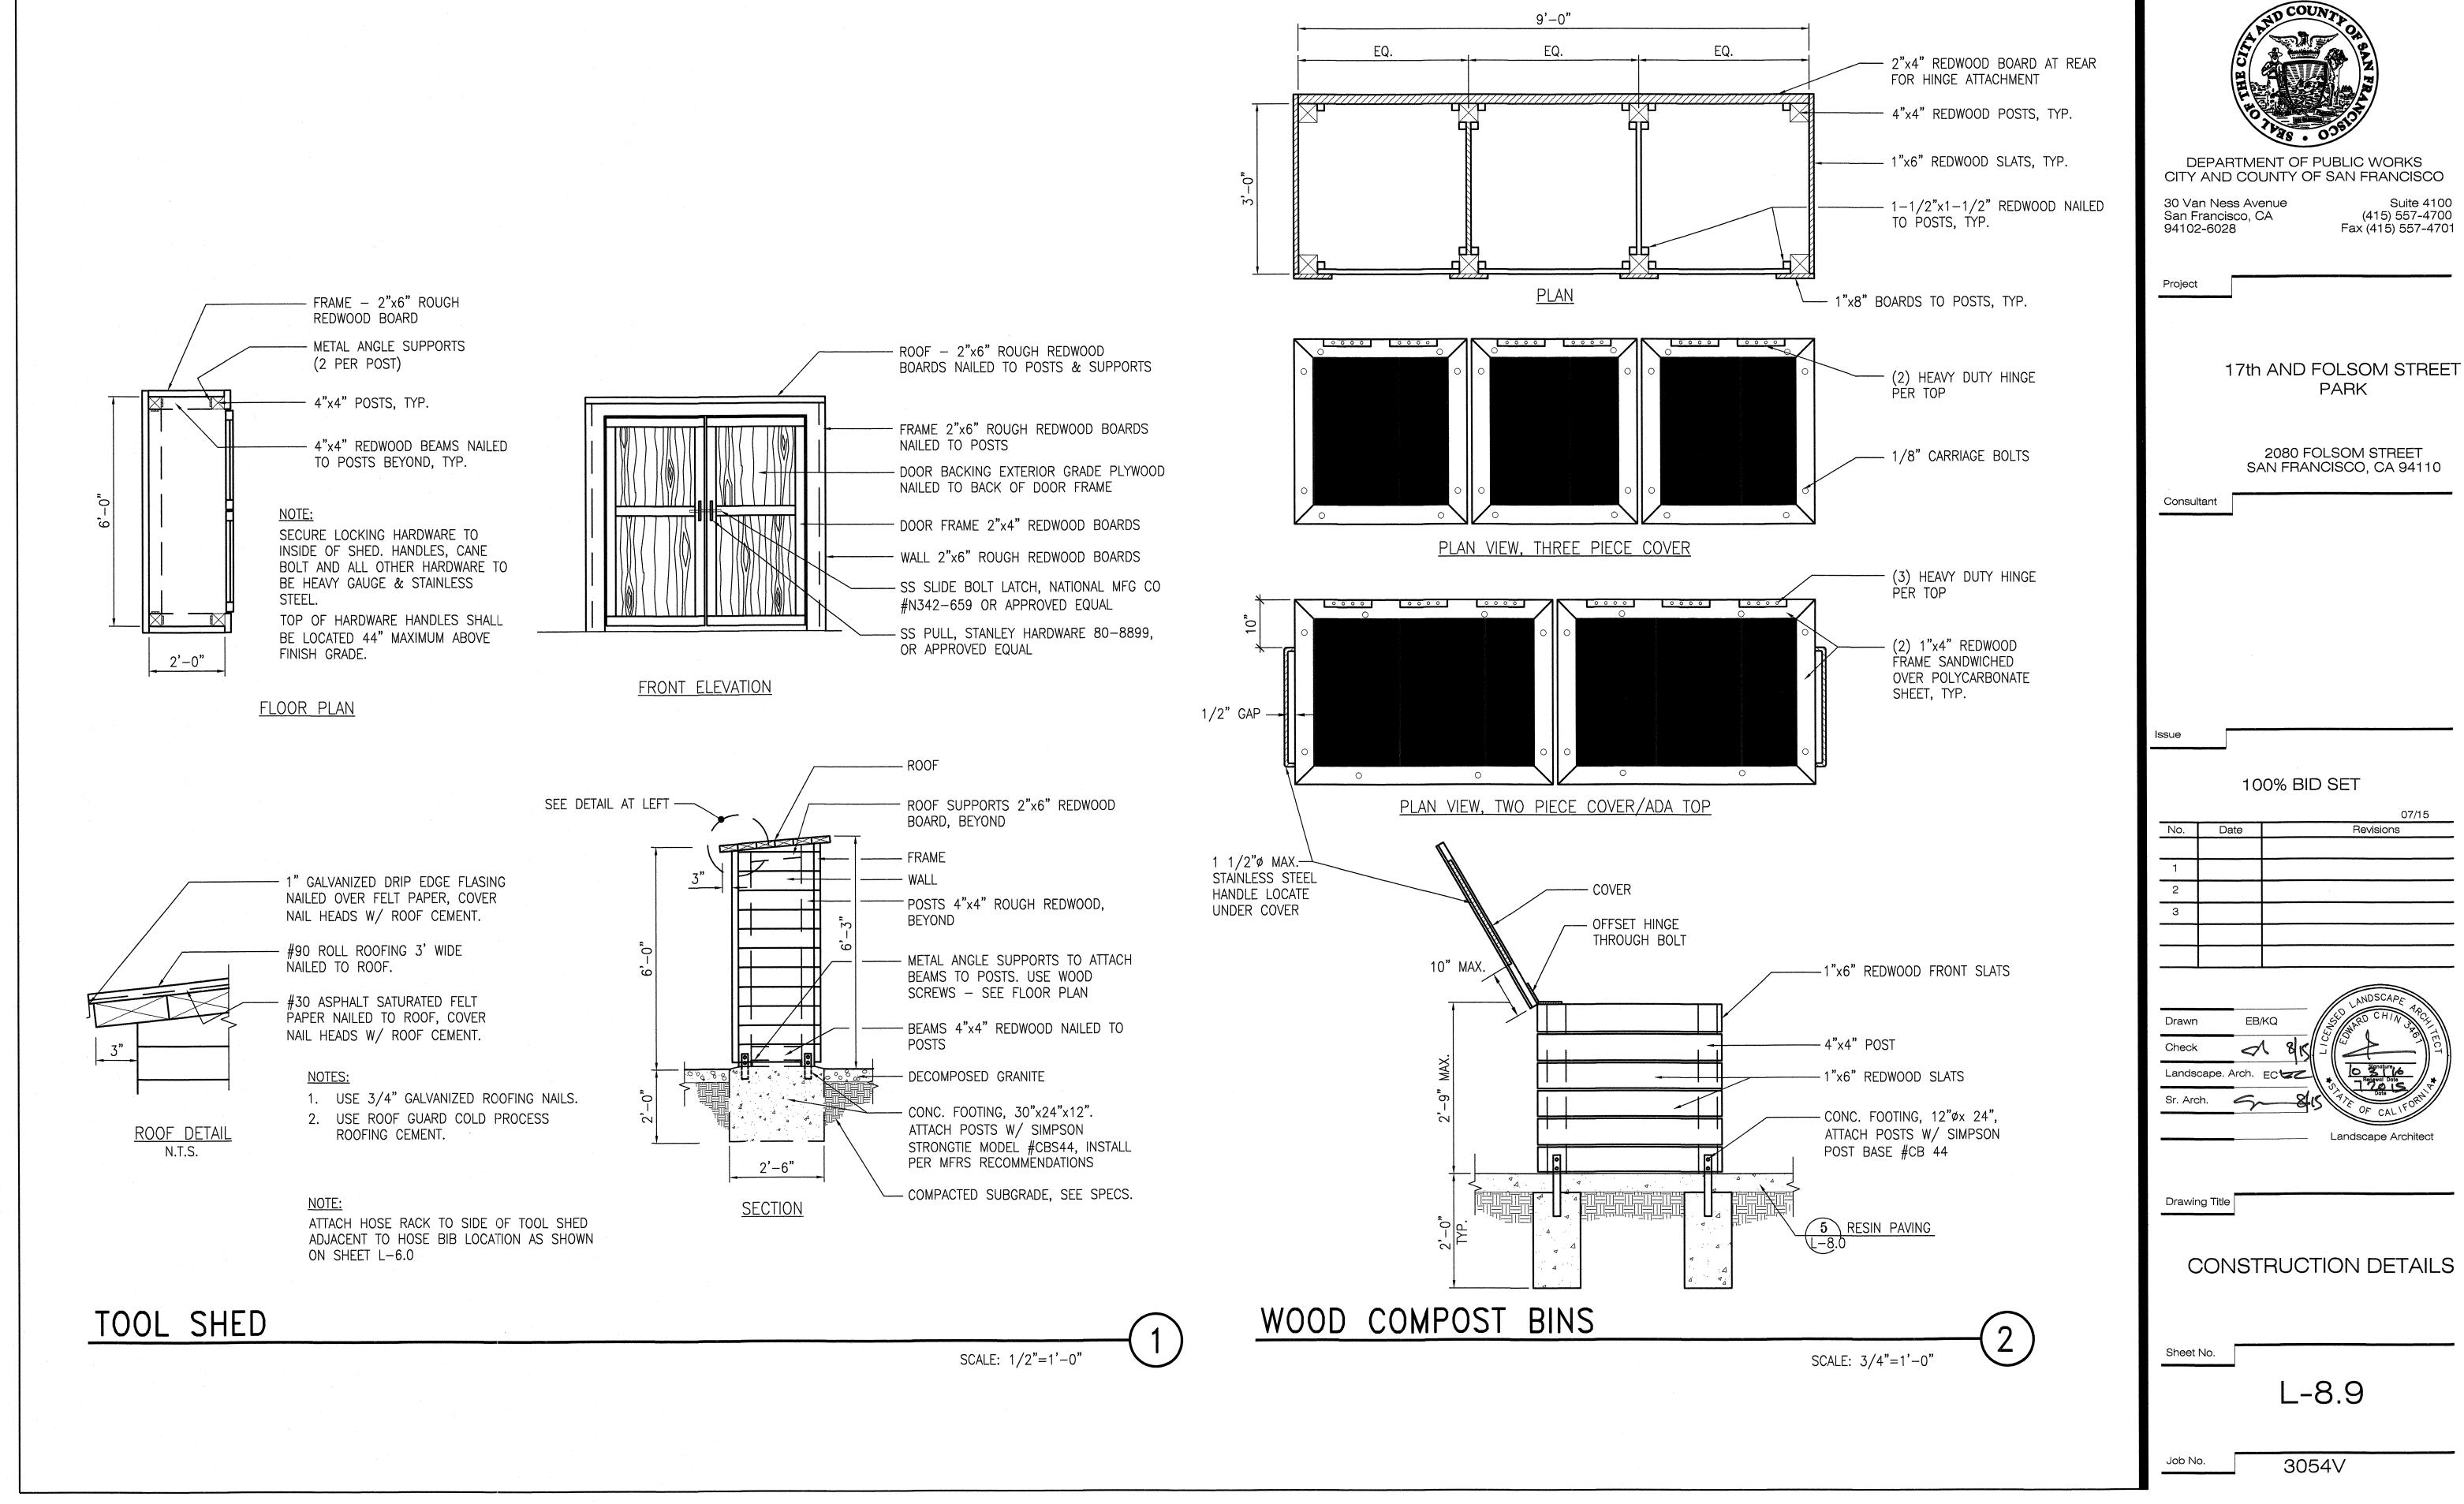
CONSTRUCTION DETAILS

Landscape Architect

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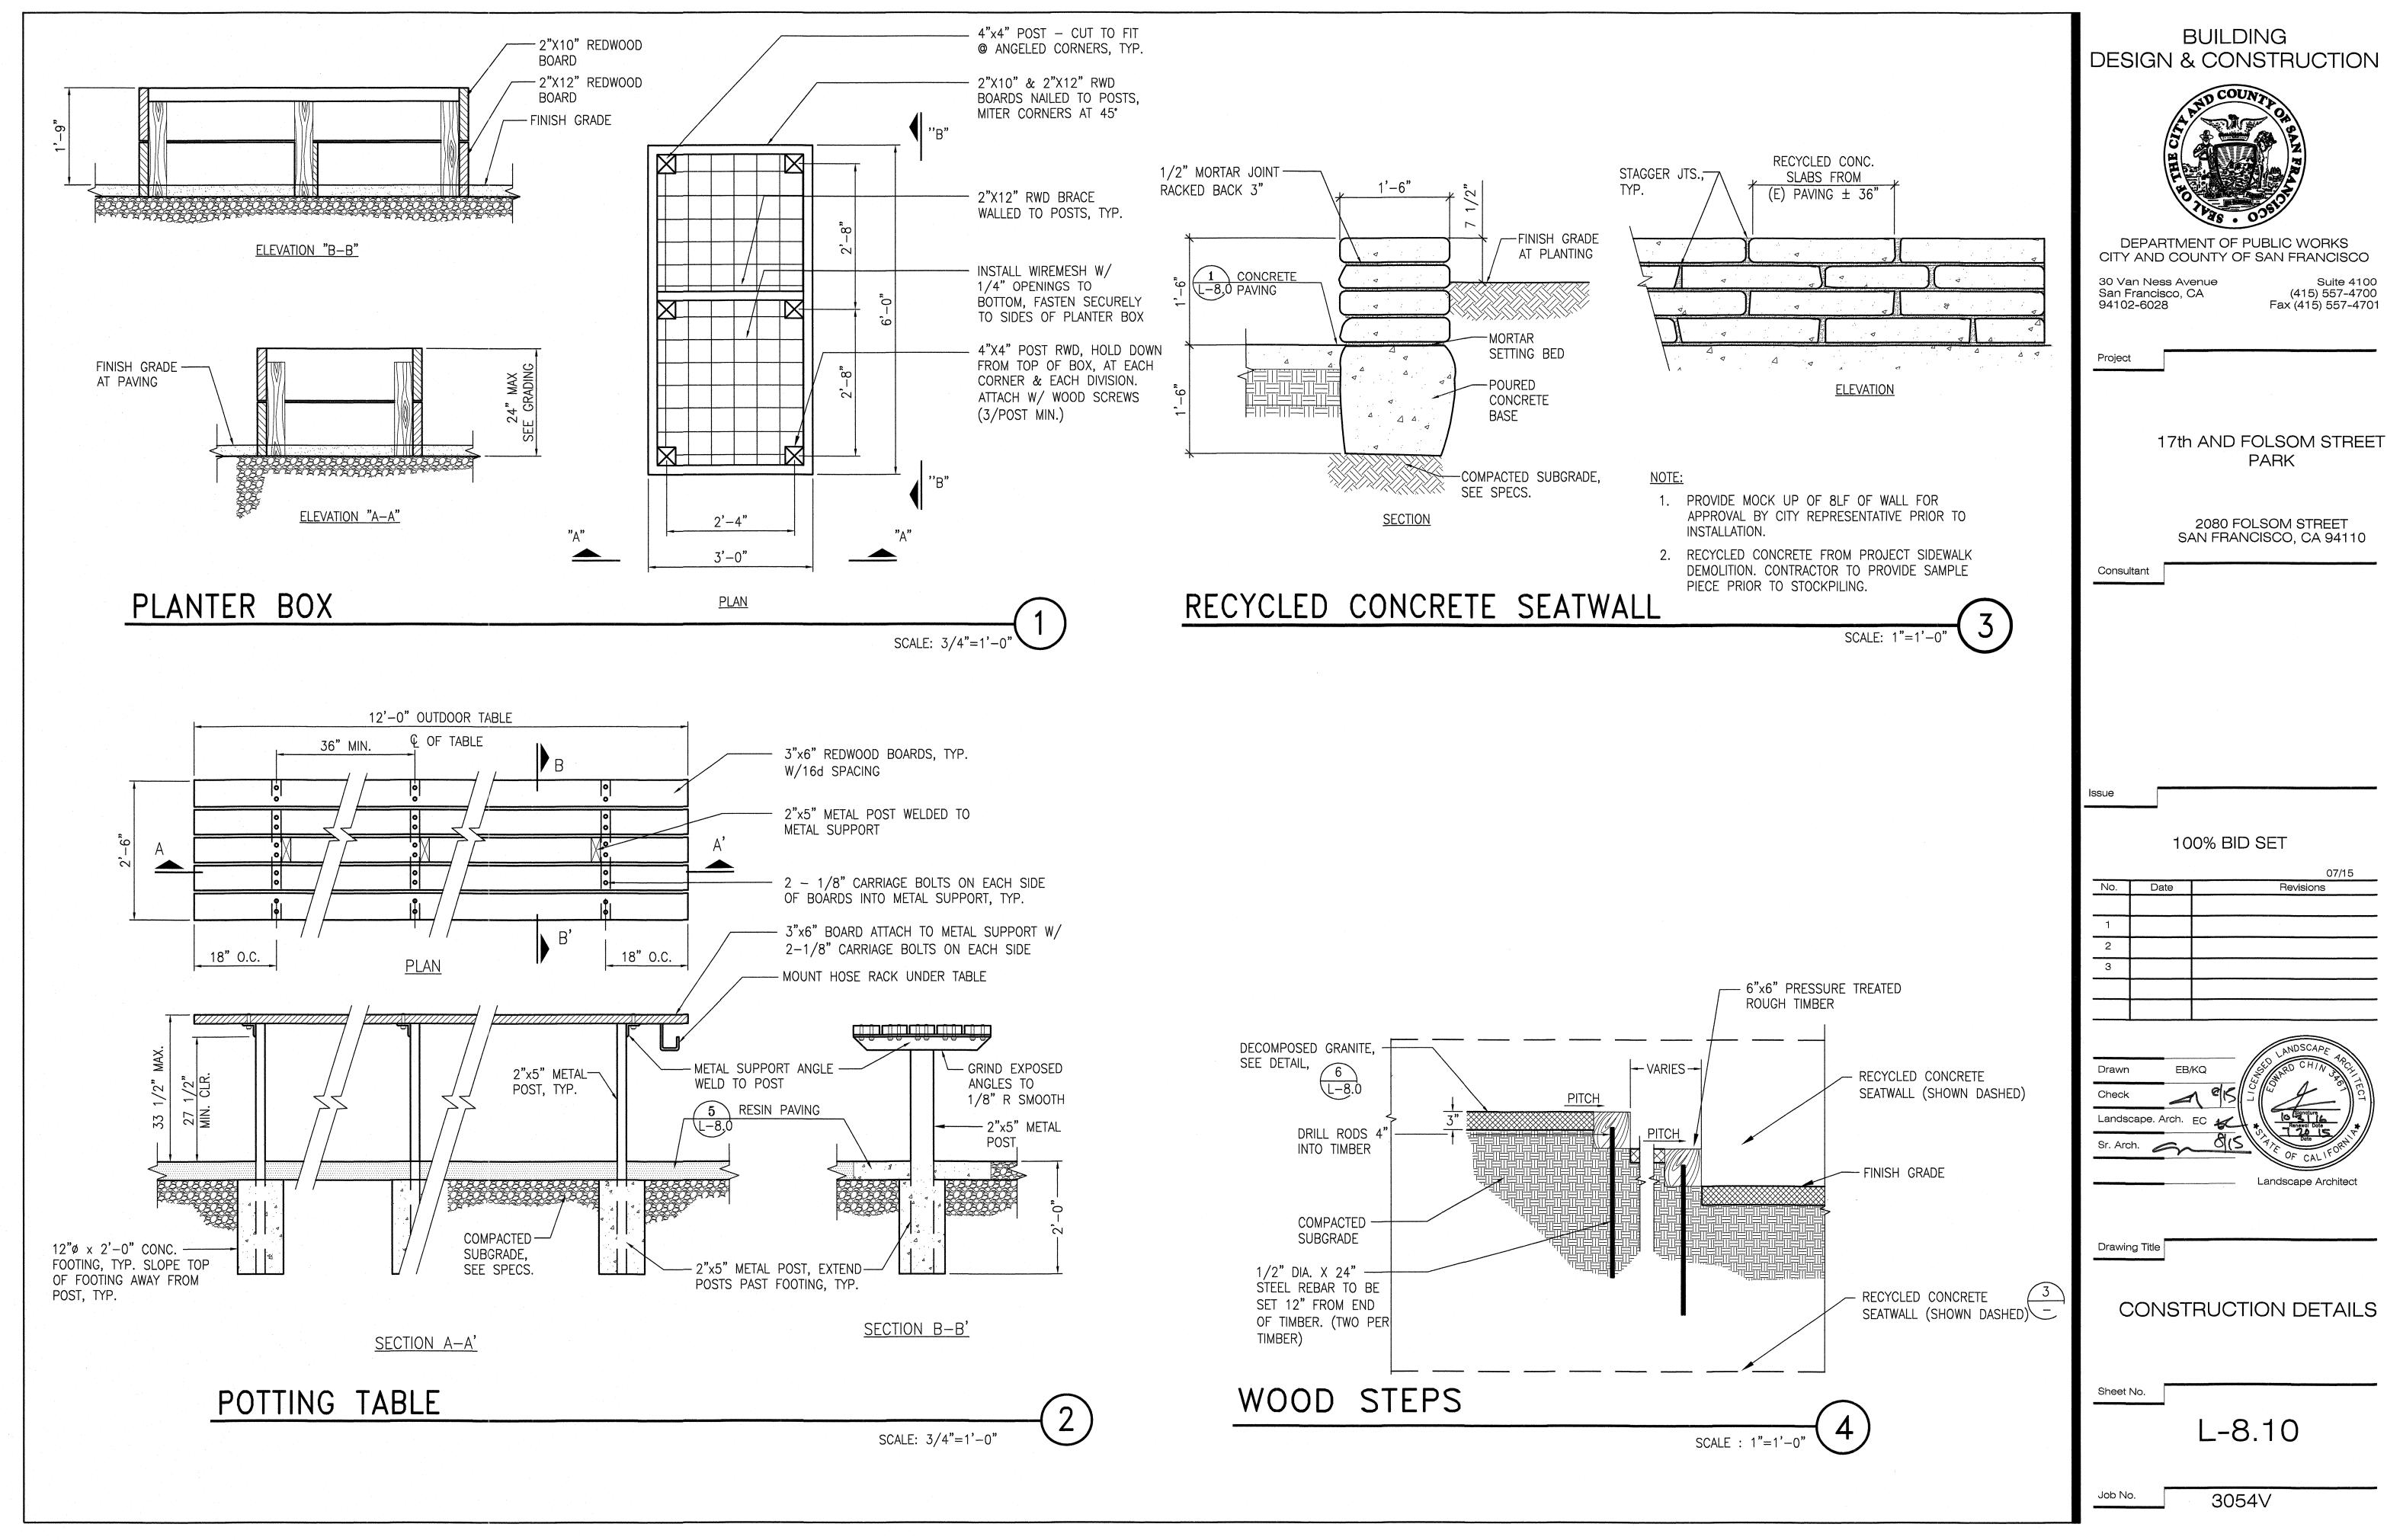
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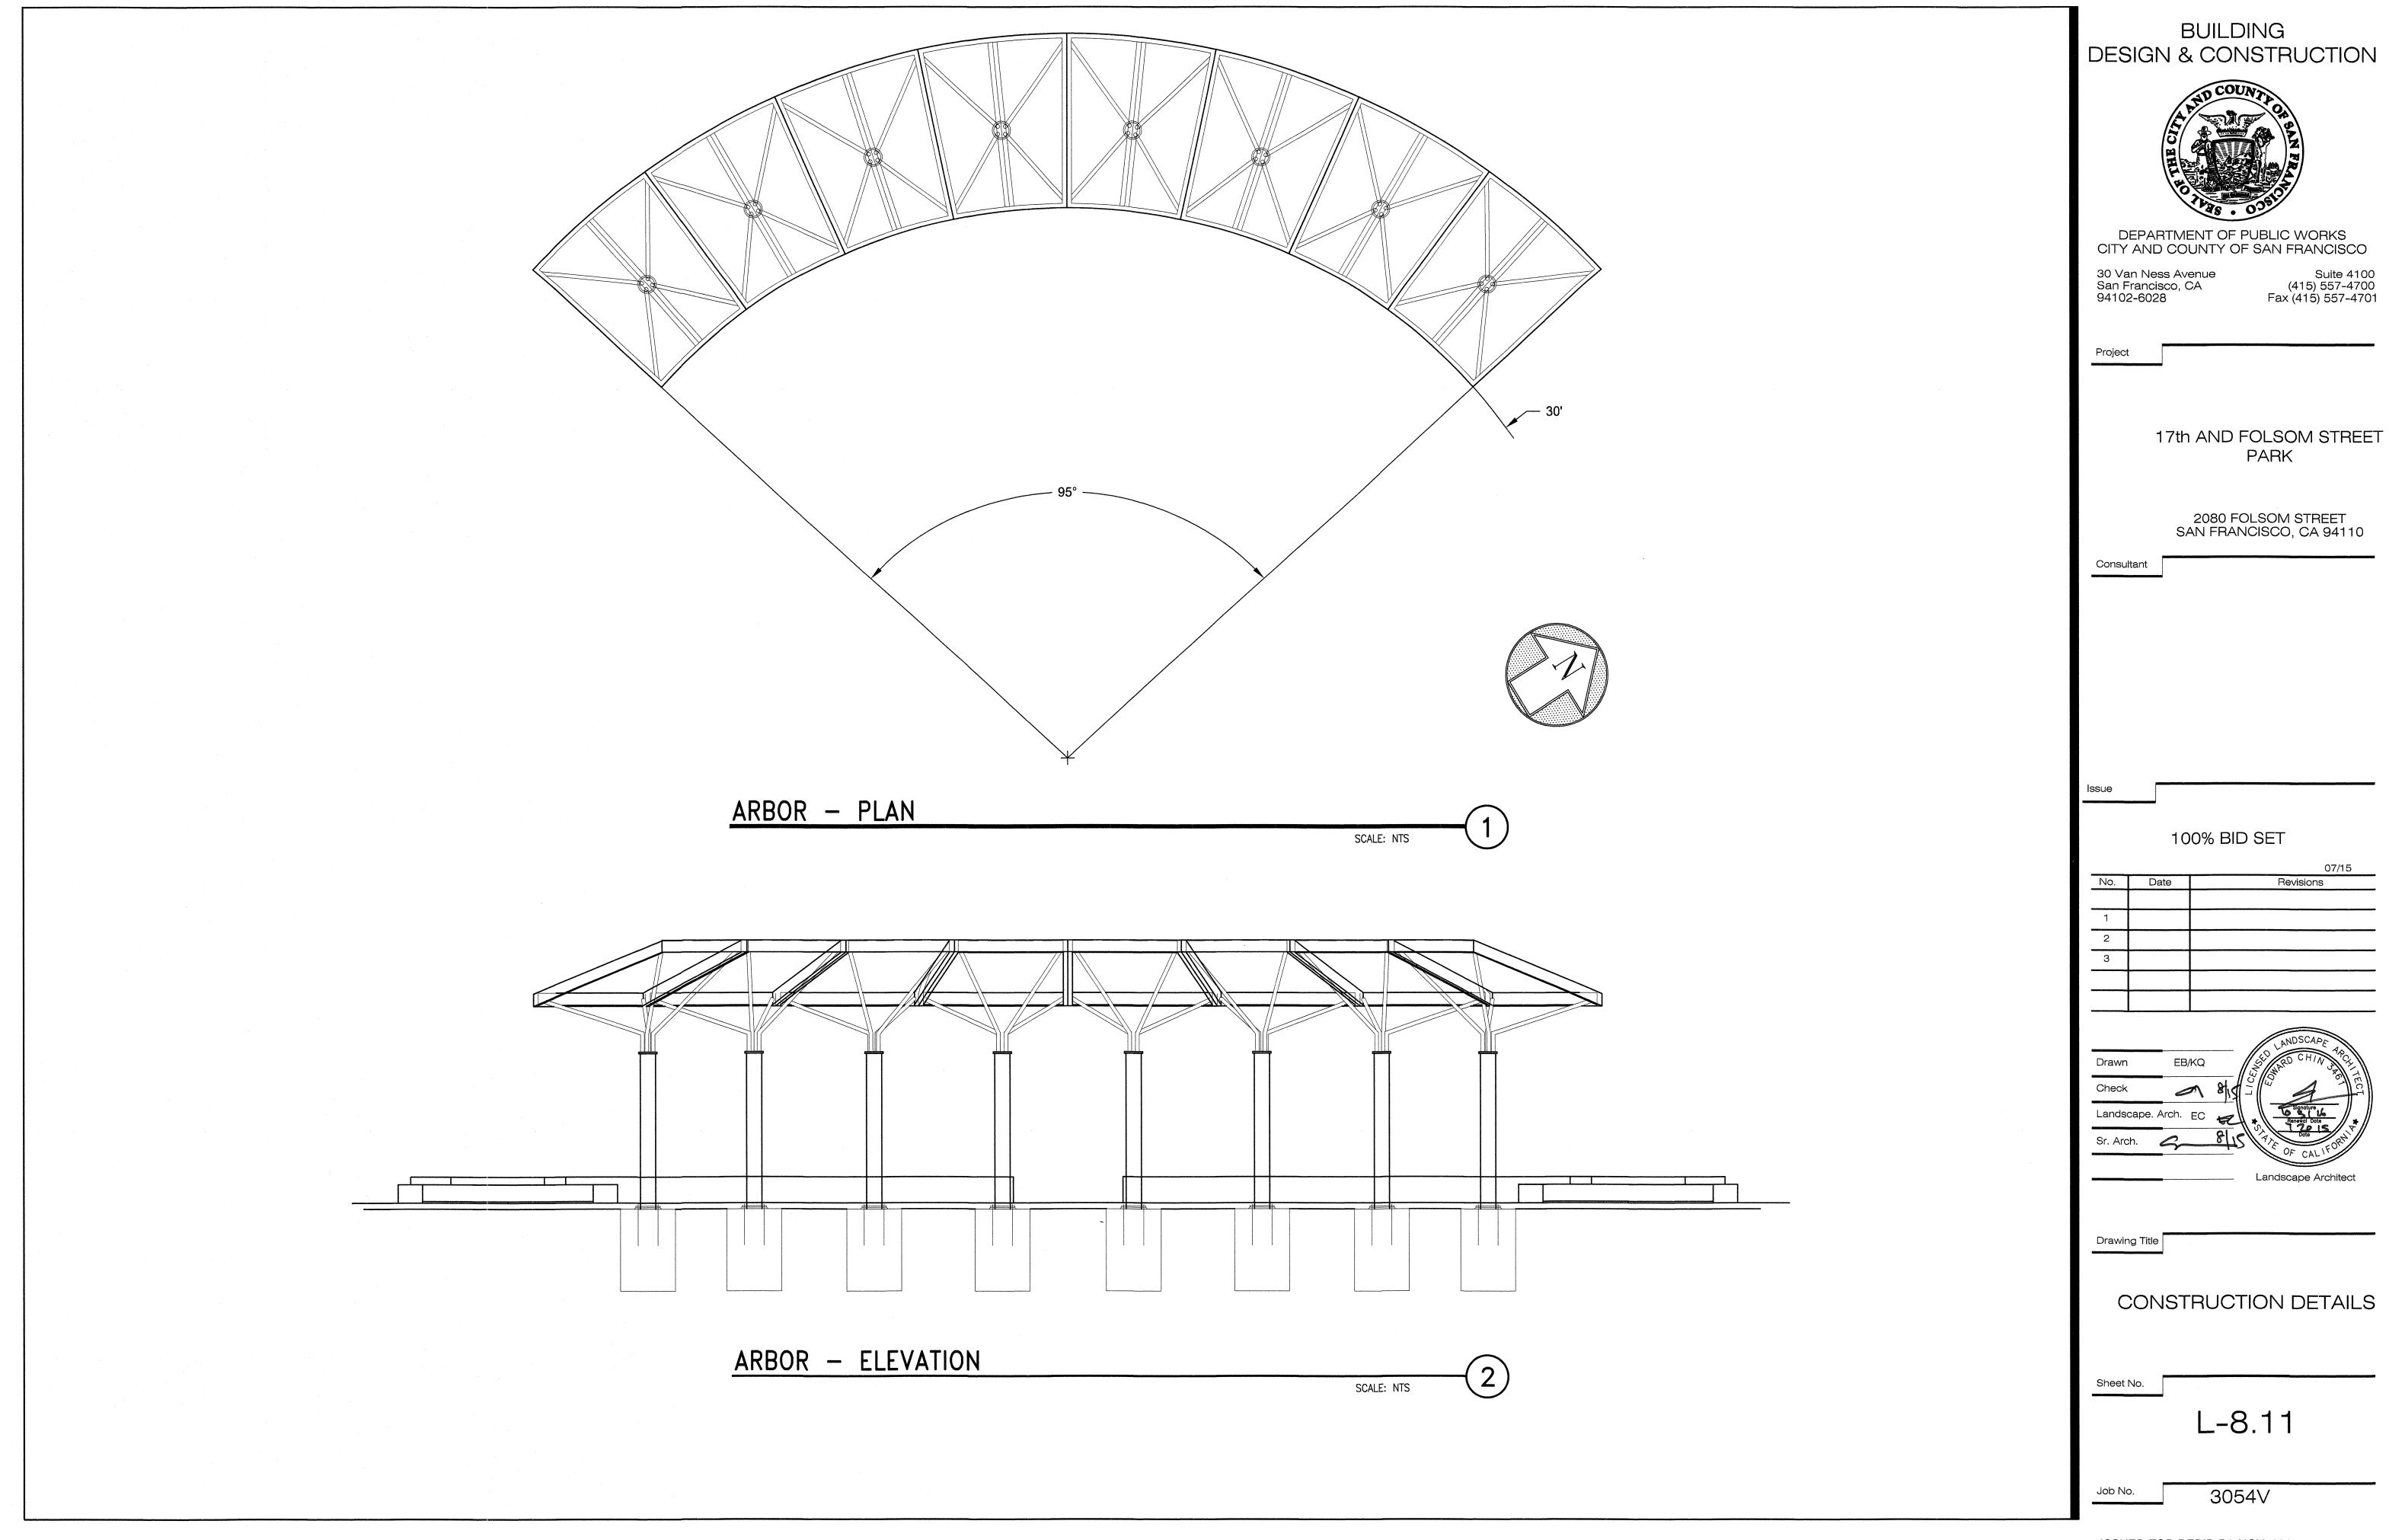
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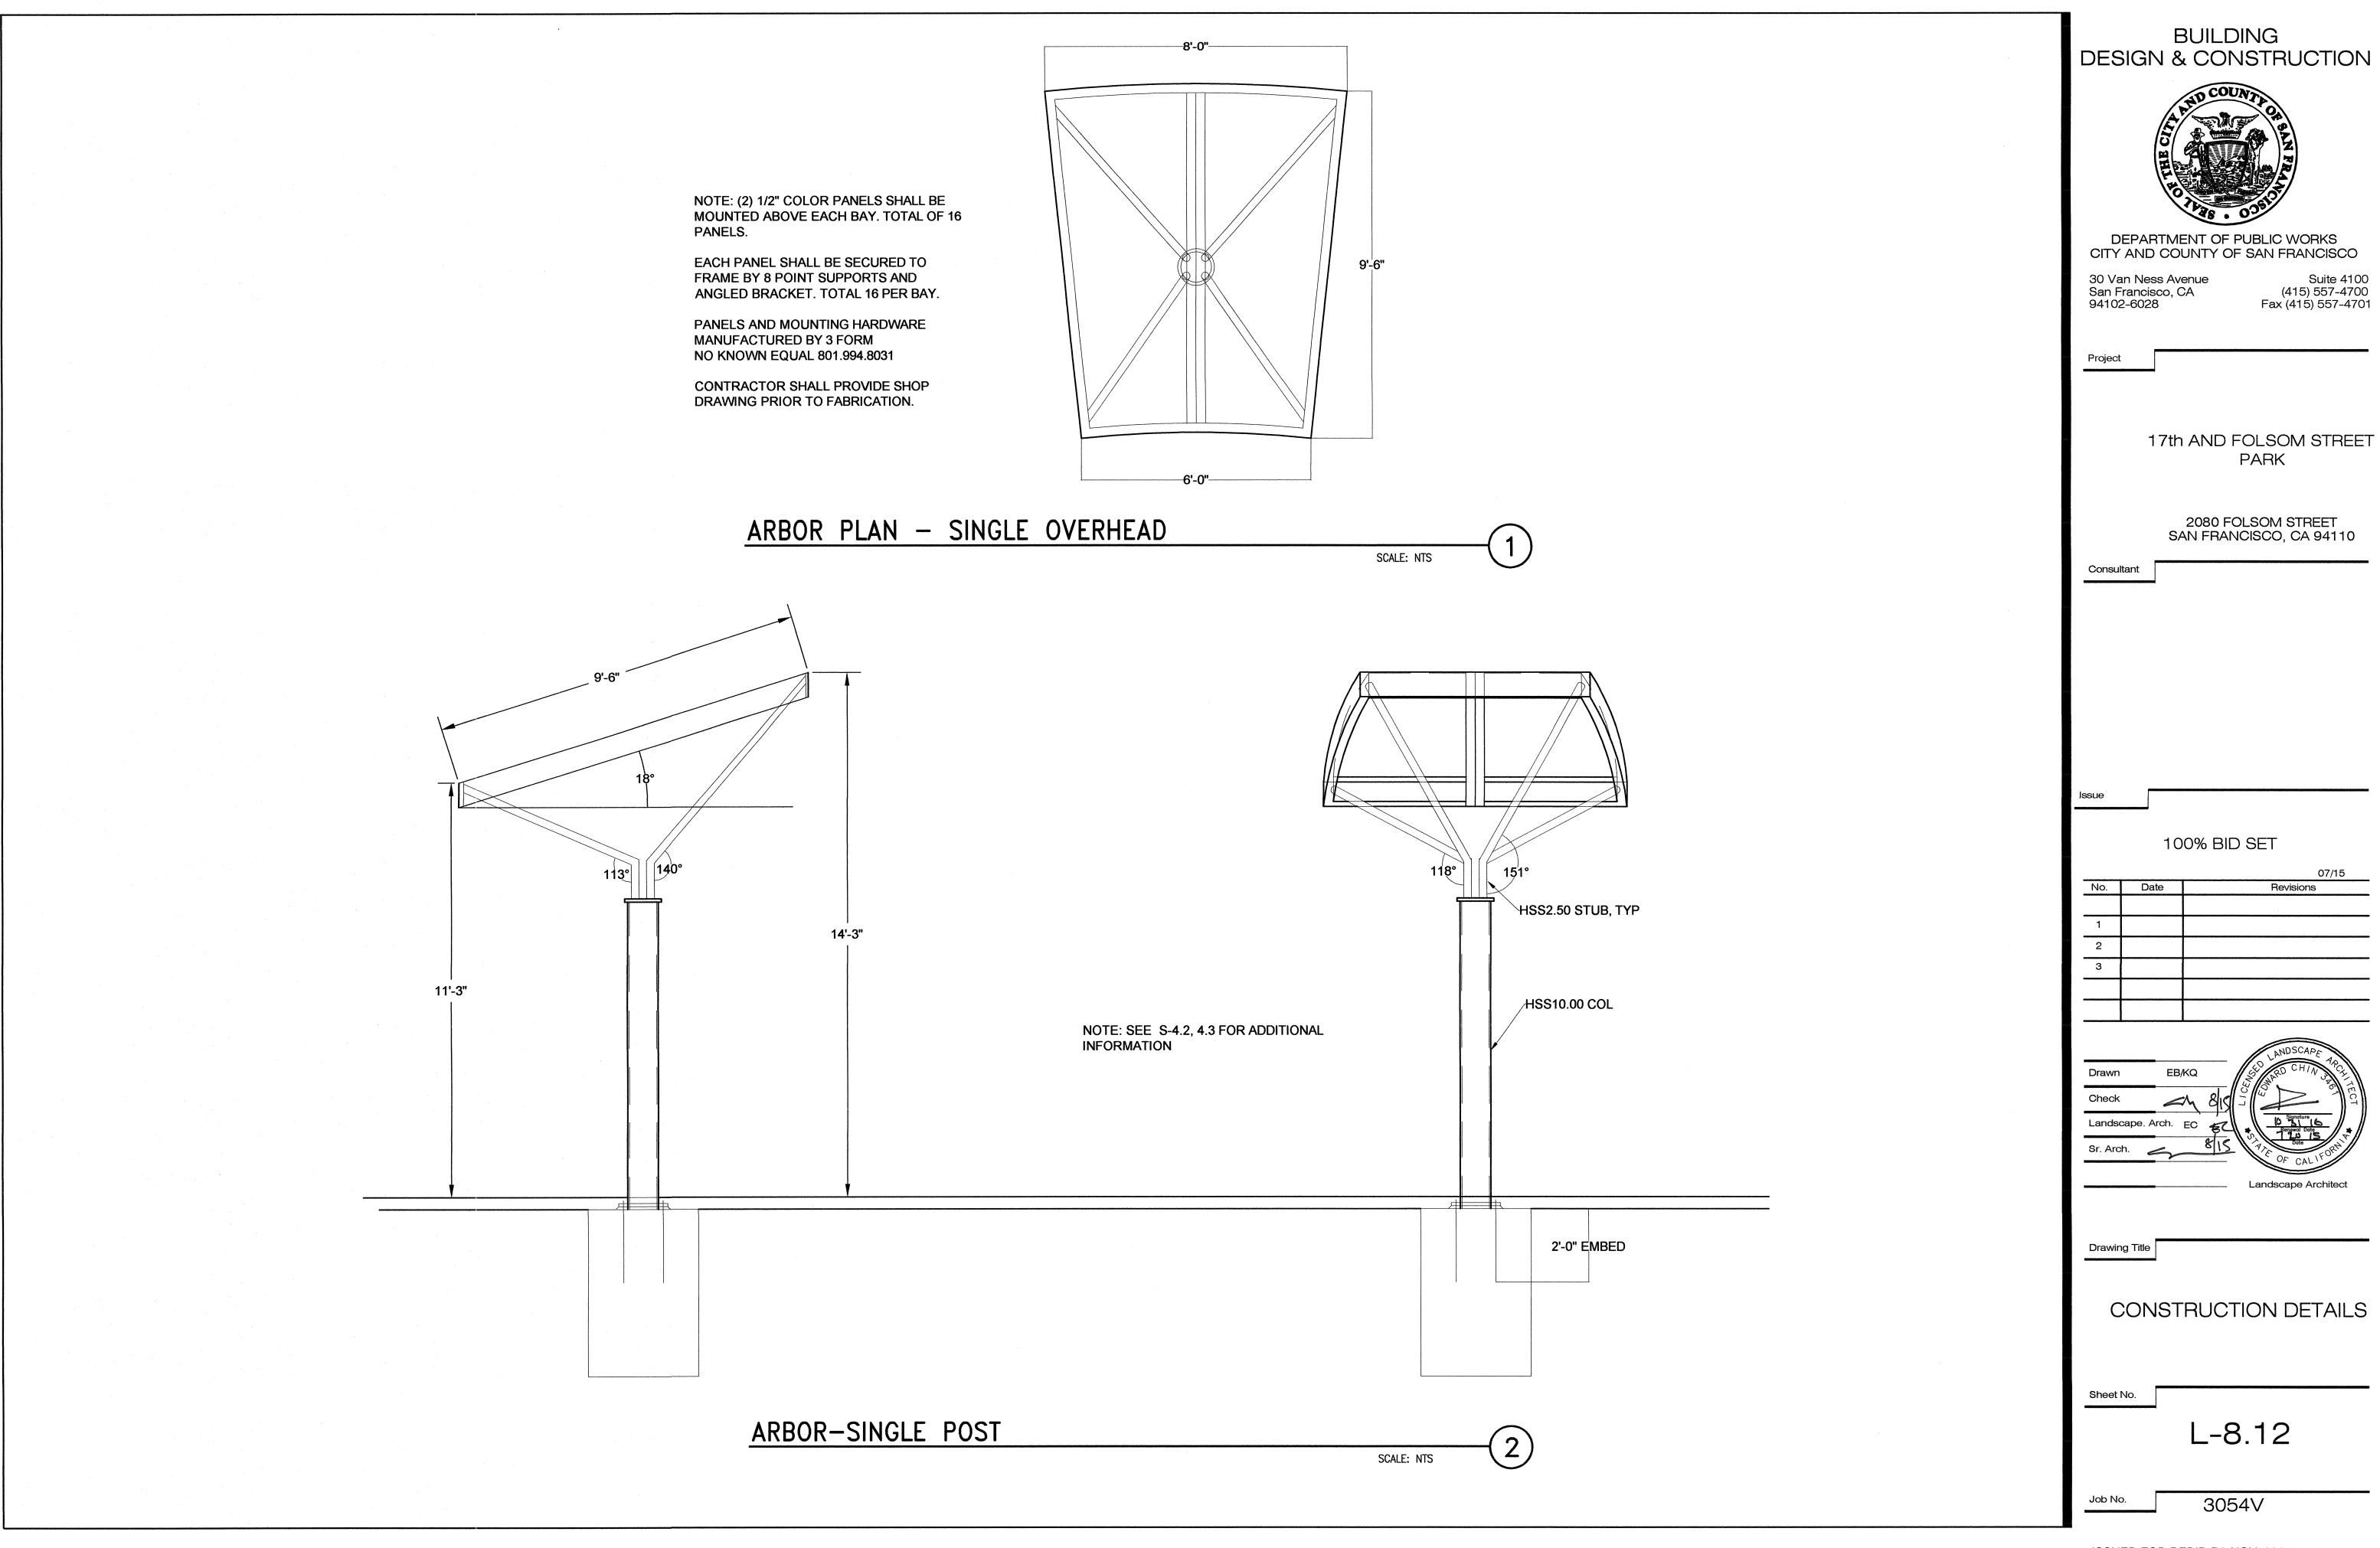



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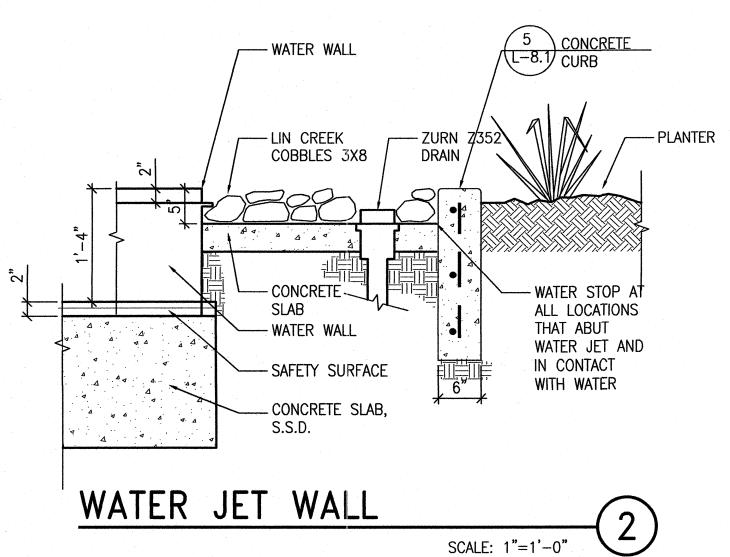
DESIGN & CONSTRUCTION










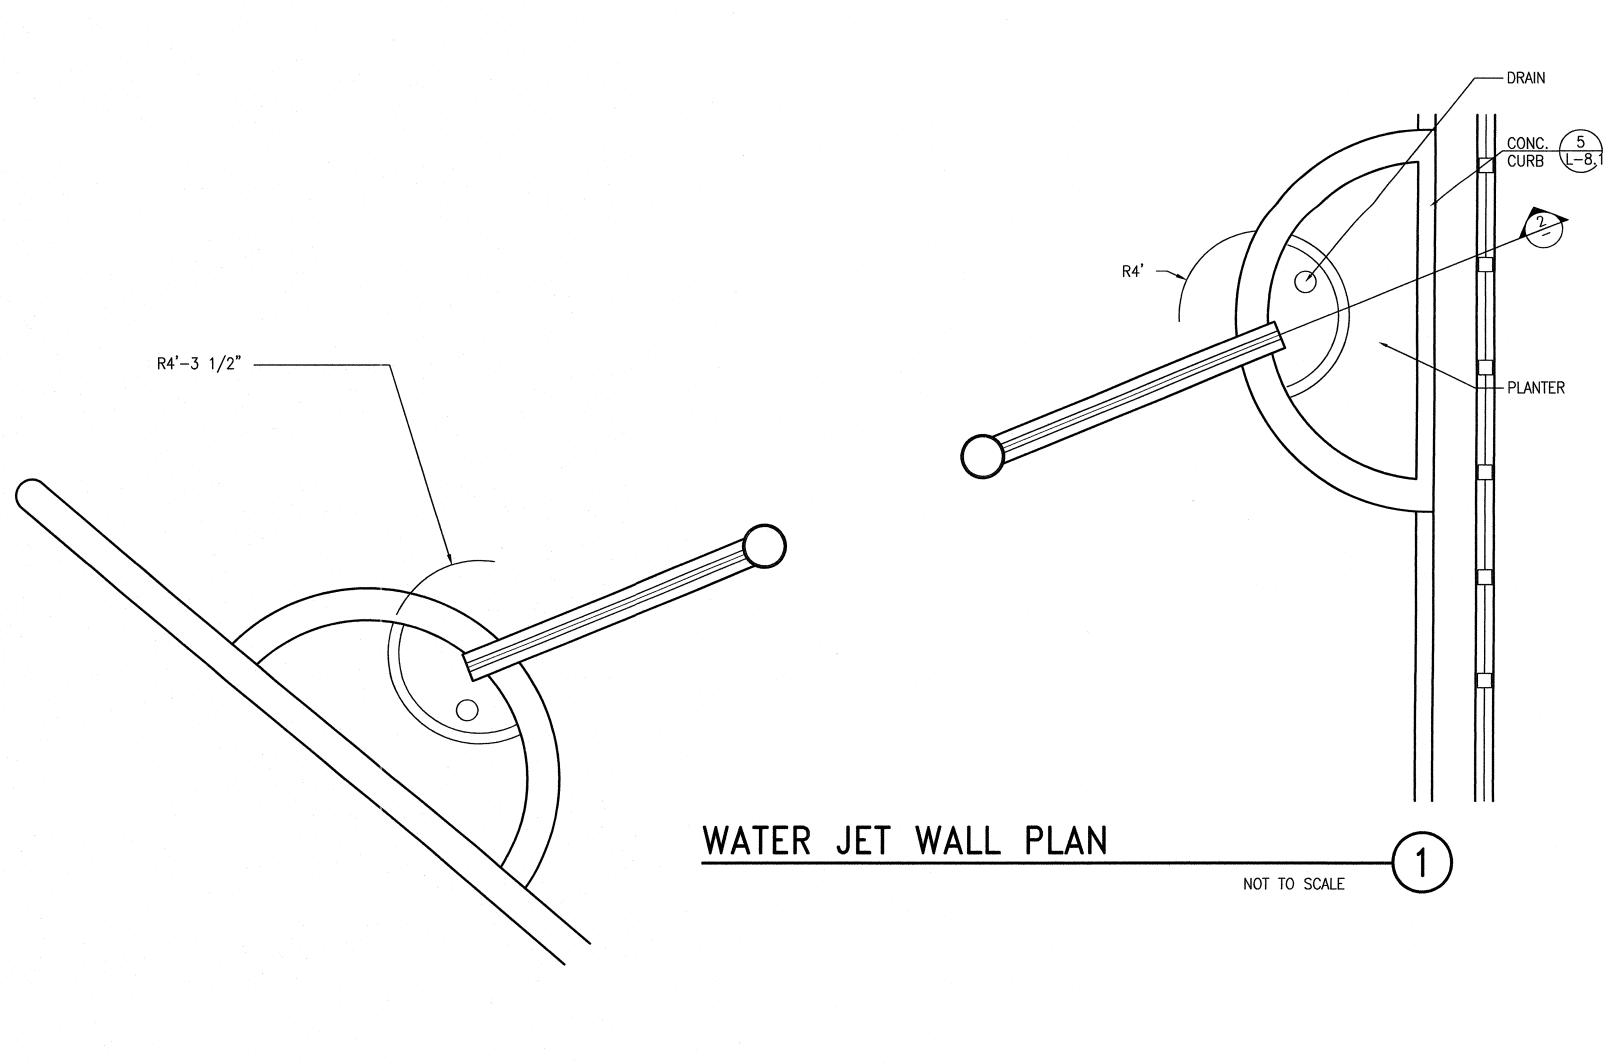

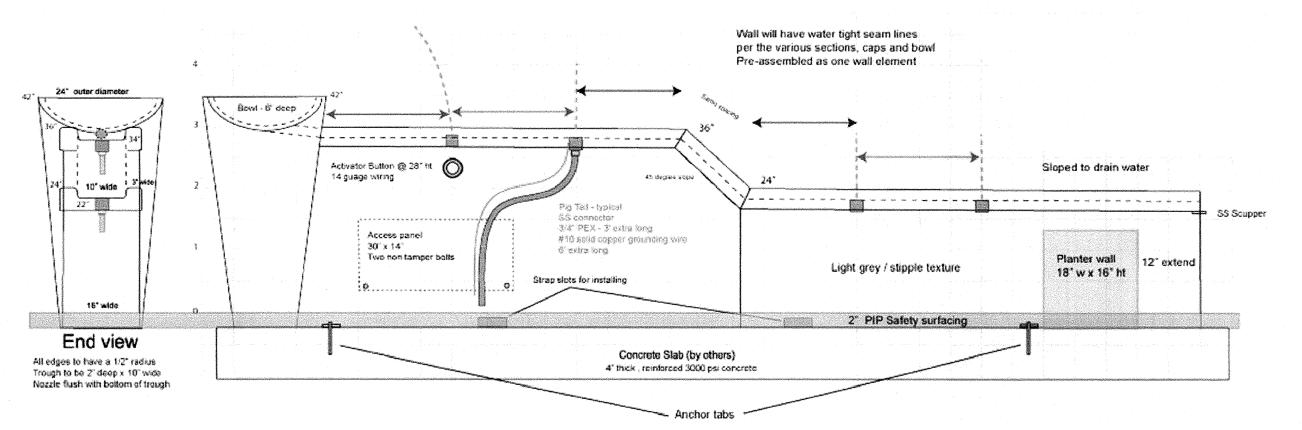

WATER JET WALL ELEVATION

NOT TO SCALE

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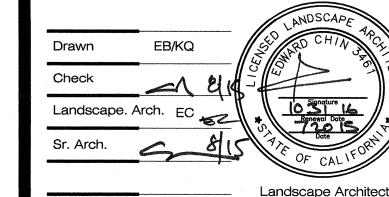
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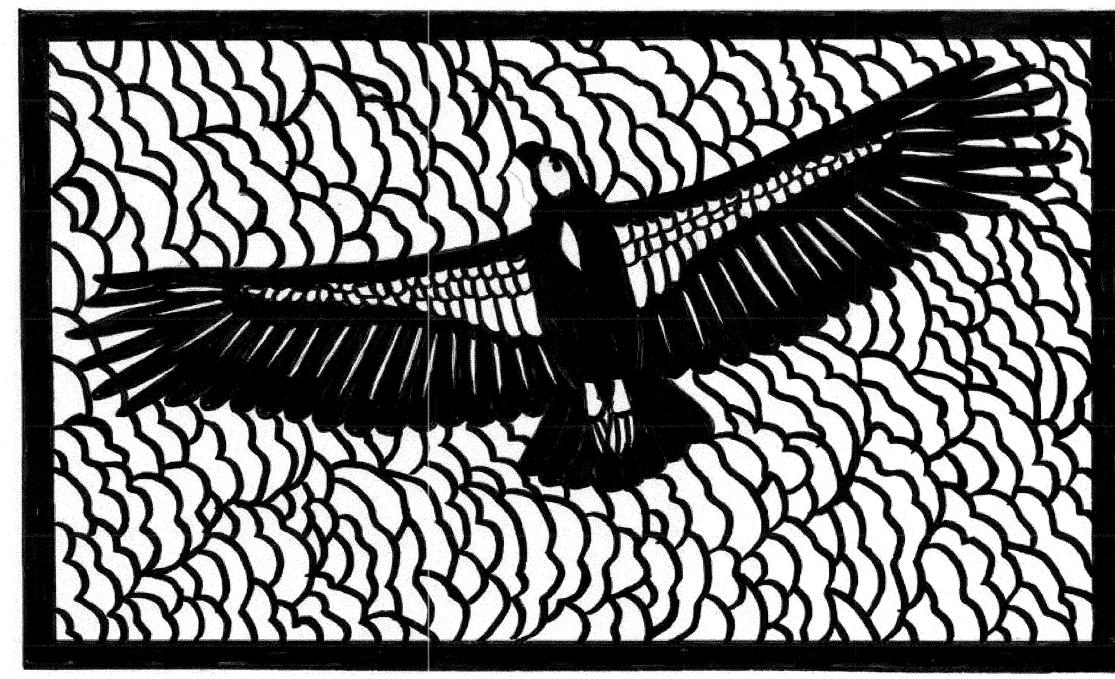
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Job No. 3054V

"Cycle of Life: California Condor"

Fence section on Folsom Street 17th & Folsom Street Park, San Francisco Arts Commission



Metal Cutout, powder coated, 6 ft. high x 10 ft. wide

Carmen Lomas Garza 315 Harvard Street, San Francisco, CA 94134-1345

"Cycle of Life: Great Blue Heron"
Fence section on 17th Street
17th & Folsom Street Park, San Francisco Arts Commission



Metal Cutout, powder coated, 6 ft. x 6 ft.

Carmen Lomas Garza 342 Prospect Ave. San Francisco, CA 94134-1345

BUILDING DESIGN & CONSTRUCTION



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CITY AND COUNTY OF SAN FRANCISCO 30 Van Ness Avenue San Francisco, CA 94102-6028 Suite 4100 (415) 557-4700 Fax (415) 557-4701

17th AND FOLSOM STREET PARK


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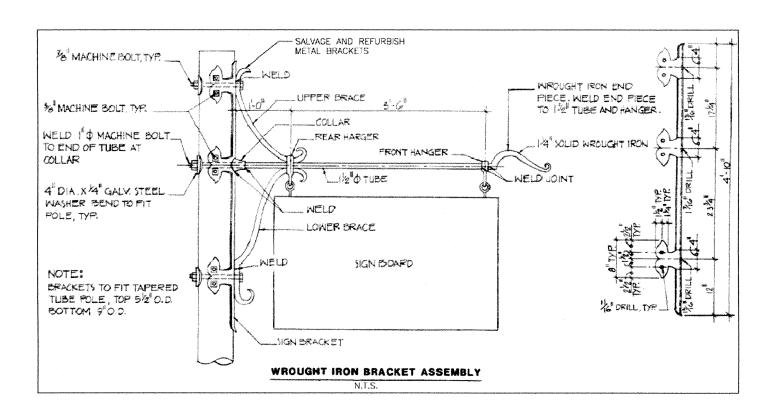
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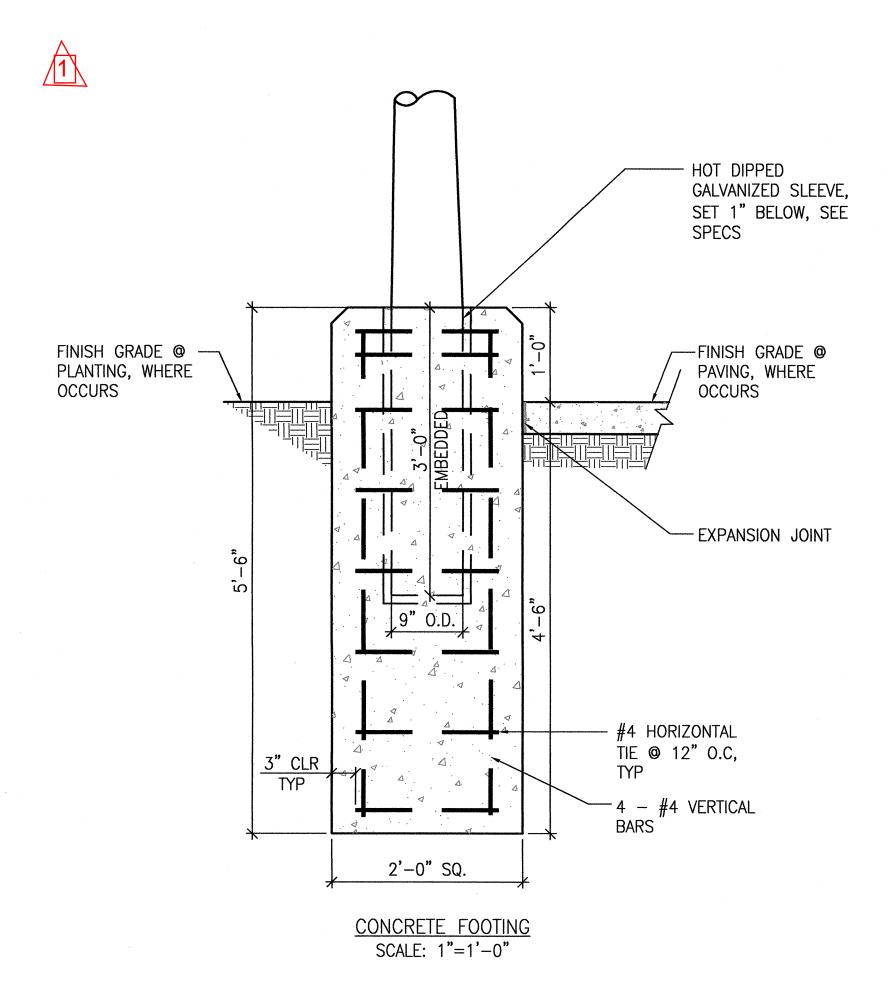
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WROUGHT IRON BRACKET ASSEMBLY NTS



PARK I.D. SIGN

SCALE: NTS

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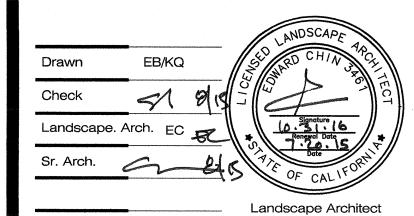
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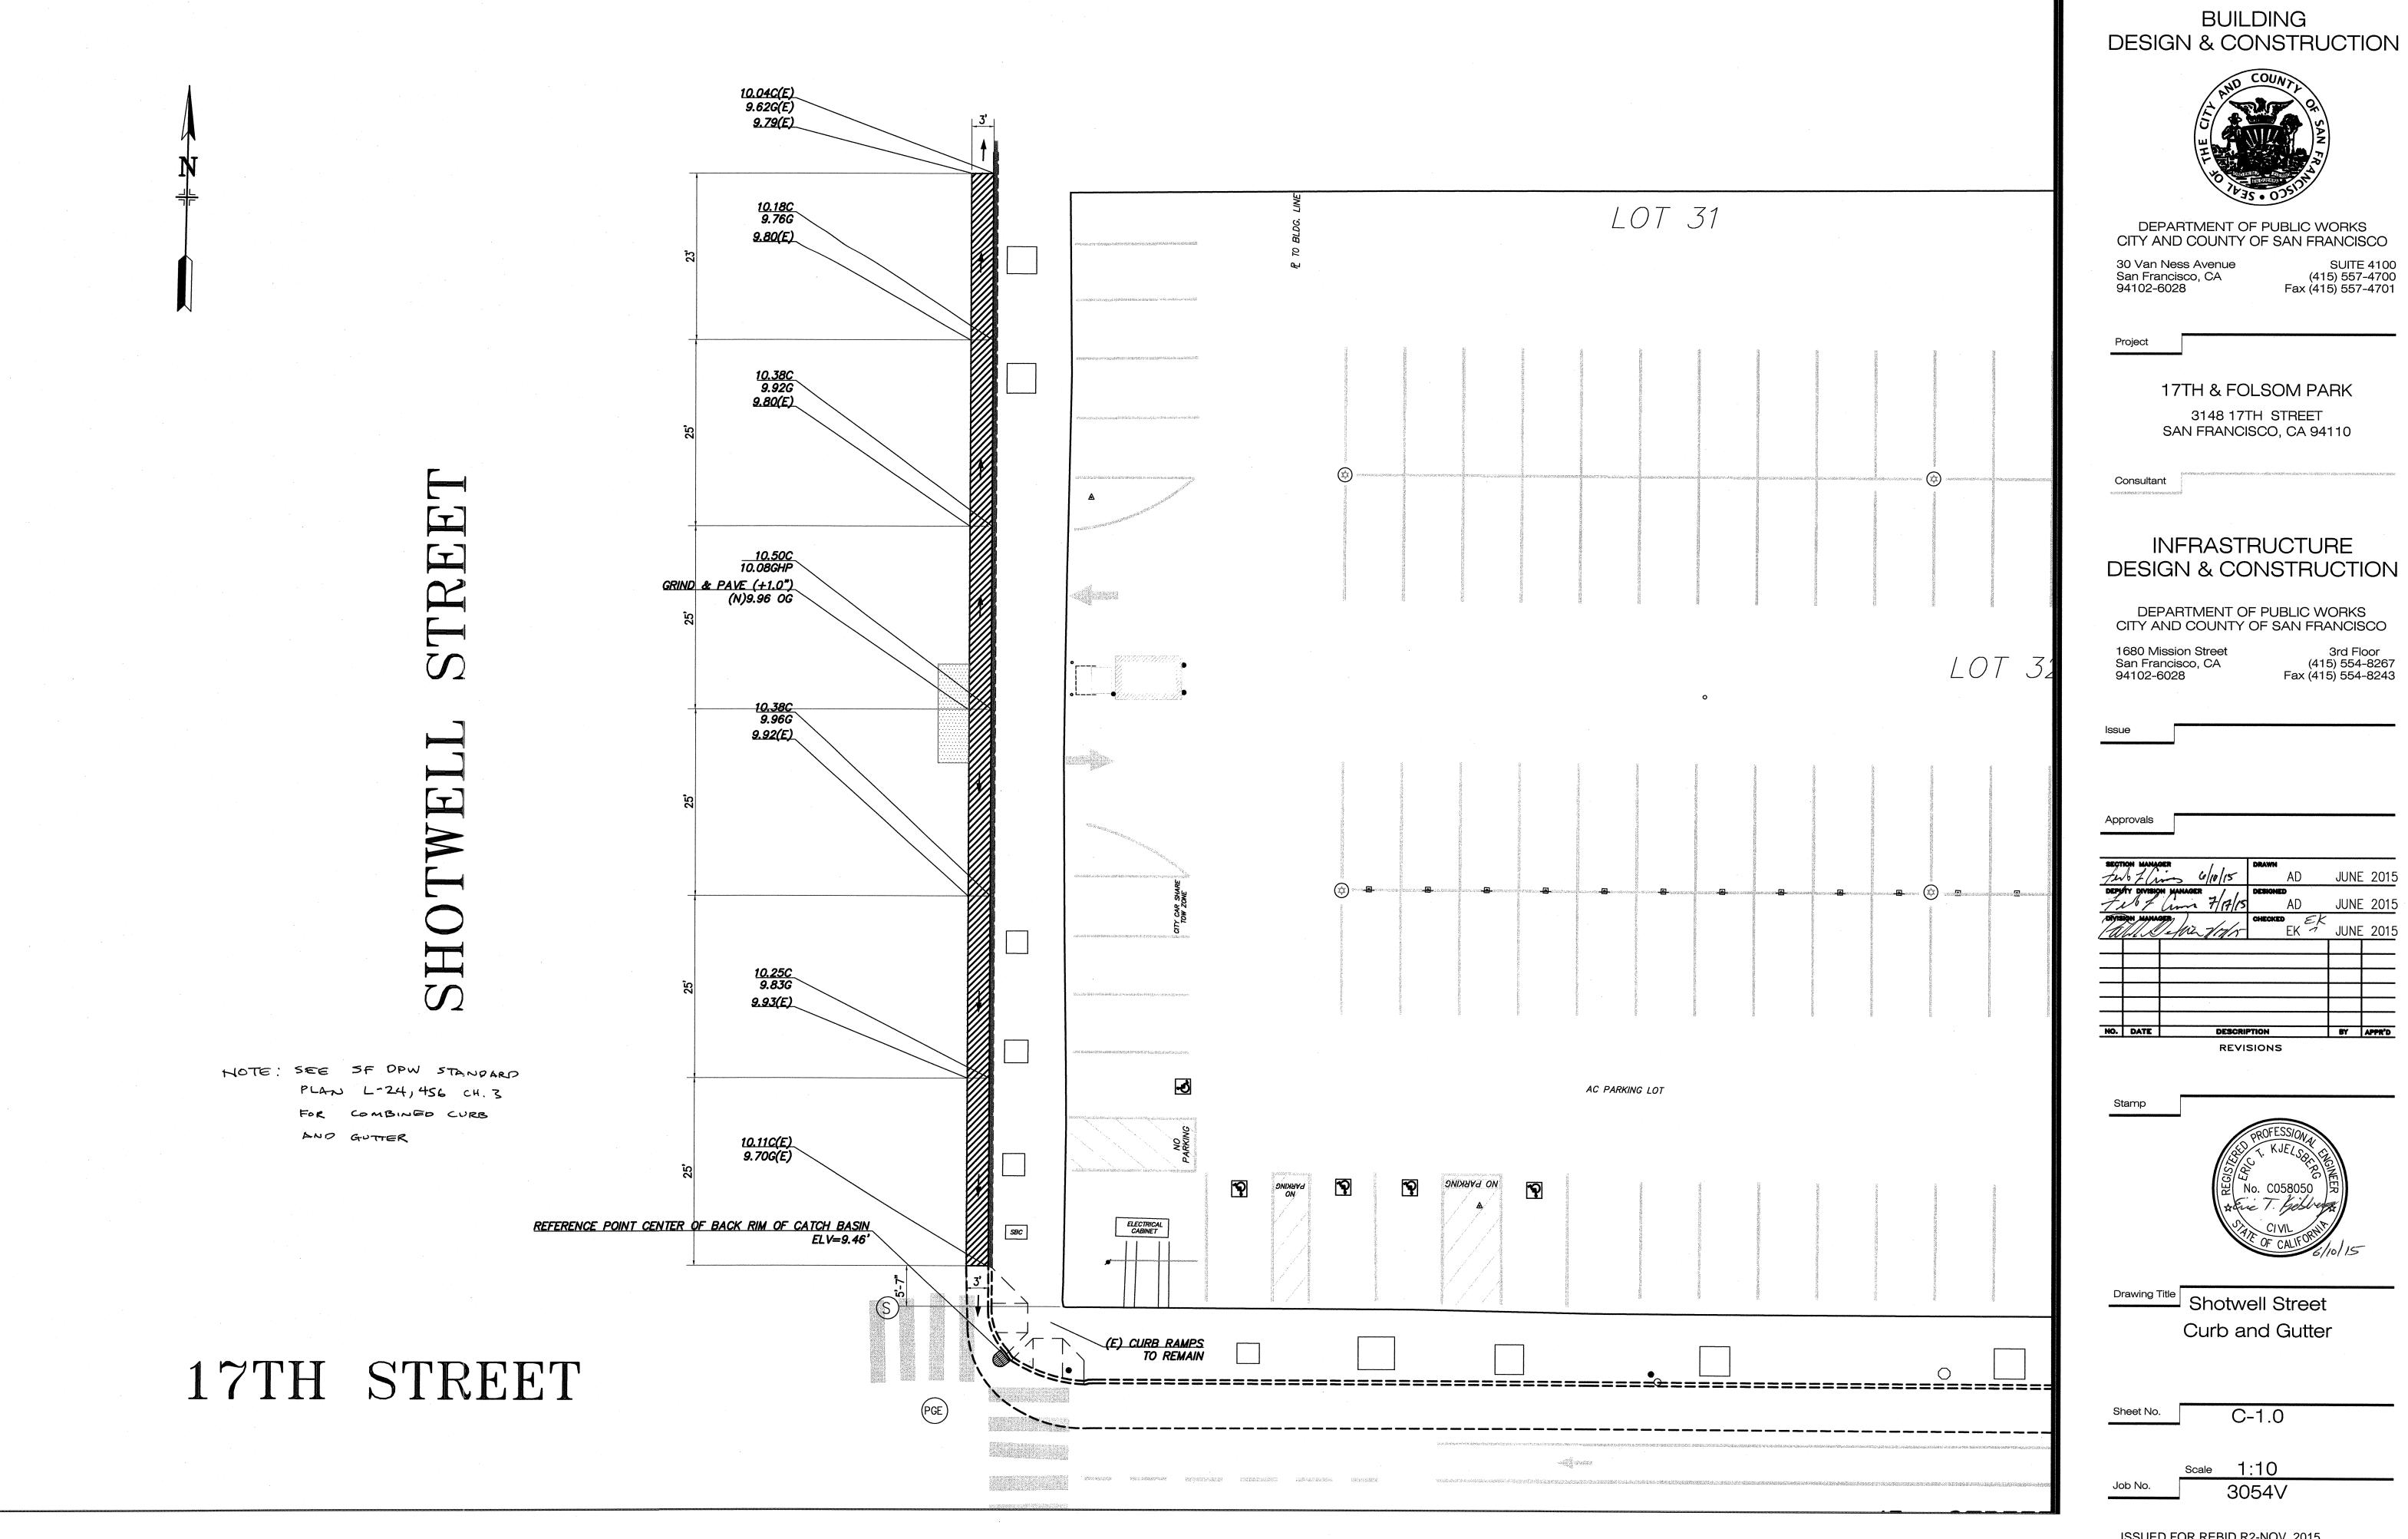
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CONSTRUCTION DETAILS
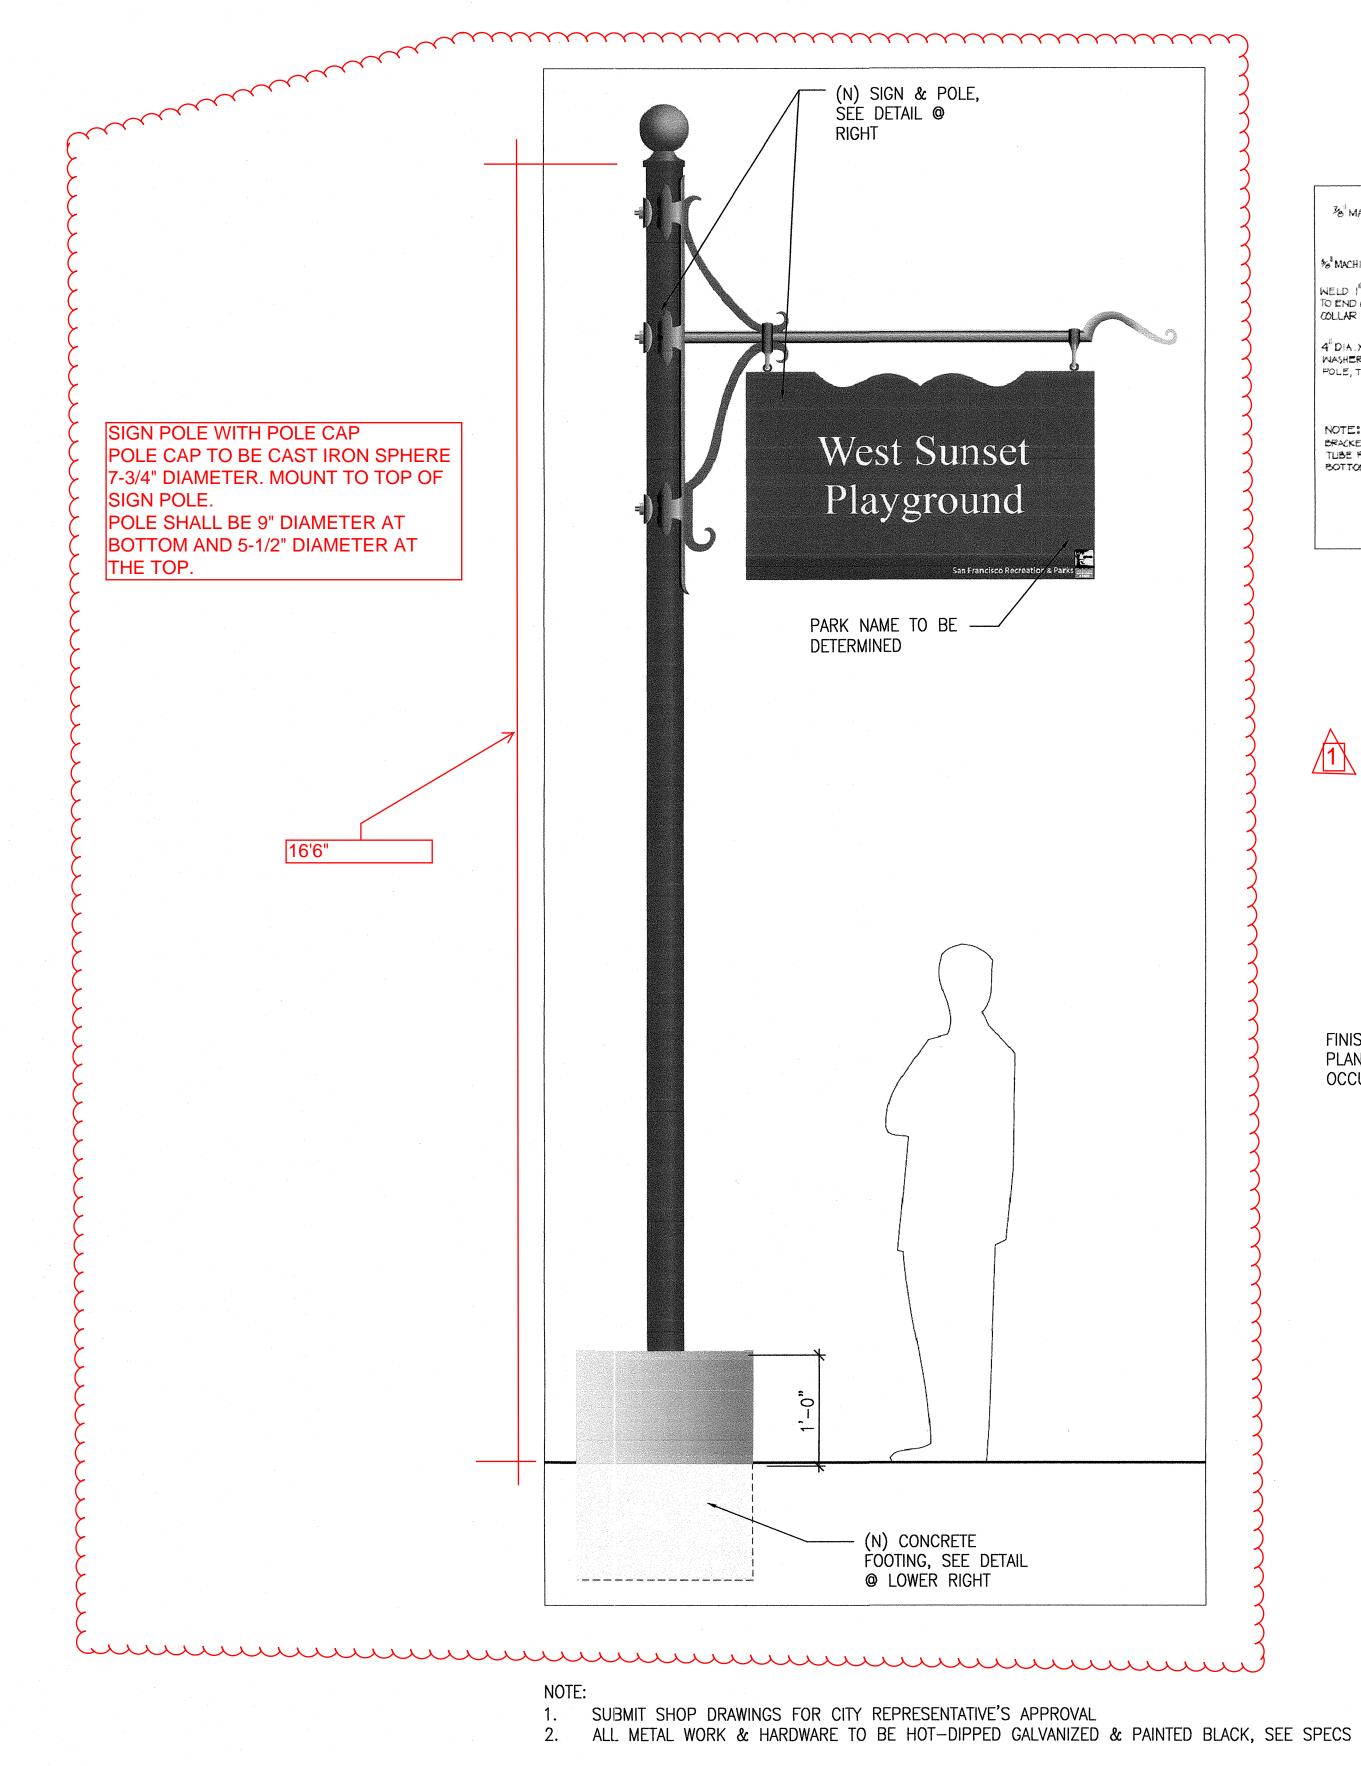
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PROJECT DESCRIPTION

- 1. THE STRUCTURAL WORK SHOWN ON THESE DRAWINGS COMPRISES:
 - CONSTRUCTION OF ARBOR (TRELLIS) STRUCTURE.
 - CONSTRUCTION OF SITE STRUCTURES, INCLUDING RETAINING WALLS AND FOOTINGS FOR PLAY FEATURES. ART PANELS, GATES, FENCES, AND LIGHT POLES.
 - CONSTRUCTION OF CONCRETE PAD FOR GREEN HOUSE AND WATER JET WALLS.

<u>GENERAL</u>

- THESE GENERAL NOTES APPLY THROUGHOUT ALL STRUCTURAL DRAWINGS EXCEPT WHERE SPECIFICALLY SHOWN BY NOTES ON DRAWINGS AND/OR DETAILS.
- 2. THE CONTRACTOR SHALL VERIFY ALL DIMENSIONS AND CONDITIONS PRIOR TO THE START OF CONSTRUCTION OR FABRICATION. THE CONTRACTOR SHALL BE RESPONSIBLE FOR THE REVIEW AND COORDINATION OF ALL DRAWINGS AND SPECIFICATIONS PRIOR TO THE START OF CONSTRUCTION OR FABRICATION. ANY DISCREPANCIES, INCONSISTENCIES, OR UNSOUND CONDITIONS SHALL BE REPORTED TO THE ENGINEER FOR RESOLUTION PRIOR TO THE START OF ANY CONSTRUCTION OR FABRICATION SO THAT A CLARIFICATION CAN BE ISSUED.
- DIMENSIONS IN THE STRUCTURAL DRAWINGS ARE AS NOTED. DO NOT USE DIMENSIONS SCALED FROM THE STRUCTURAL DRAWINGS.
- 4. ALL DRAWINGS ARE CONSIDERED TO BE A PART OF THE CONTRACT DOCUMENTS. ANY WORK PERFORMED IN CONFLICT WITH THE CONTRACT DOCUMENTS OR ANY CODE REQUIREMENTS SHALL BE CORRECTED BY THE CONTRACTOR AT THEIR OWN EXPENSE AND AT NO EXPENSE TO THE CITY AND COUNTY OF SAN FRANCISCO.
- 5. ALL TYPICAL DETAILS AND NOTES SHOWN ON DRAWINGS SHALL APPLY UNLESS OTHERWISE NOTED. TYPICAL DETAILS MAY NOT NECESSARILY BE INDICATED ON THE PLANS, BUT SHALL STILL APPLY AS SHOWN OR DESCRIBED IN THE DETAILS. WHERE TYPICAL DETAILS ARE NOTED ON THE DRAWINGS, THE SPECIFIED TYPICAL DETAIL SHALL BE USED. WHERE NO DETAILS ARE NOTED. CONSTRUCTION SHALL BE AS SHOWN FOR SIMILAR WORK. THE CONTRACTOR SHALL SUBMIT ALL PROPOSED ALTERNATE TYPICAL DETAILS TO THOSE PROVIDED WITH RELATED CALCULATIONS TO THE ENGINEER FOR APPROVAL PRIOR TO SHOP DRAWING PRODUCTION AND FIELD USE.
- 6. REFER TO OTHER DISCIPLINES' DRAWINGS AND COORDINATE INFORMATION RELATED TO THOSE DISCIPLINES' SYSTEMS FOR ITEMS SUCH AS:
 - FINISH GRADE ELEVATIONS, CHANGES IN ELEVATION, SLOPES, DRAINS, CURBS, PADS, INSERTS, ETC.
- WATERPROOFING AND WATERSTOPS.
- SIZE, LOCATION, ANCHORAGE, AND BRACING FOR MECHANICAL, ELECTRICAL, AND PLUMBING EQUIPMENT
- 7. FOR OPENINGS LARGER THAN 6"THAT ARE REQUIRED BUT NOT SHOWN ON THE STRUCTURAL DRAWINGS, THE CONTRACTOR SHALL SUBMIT DRAWINGS INDICATING OPENING LOCATIONS TO THE ENGINEER FOR APPROVAL PRIOR TO CONSTRUCTION.
- 8. THE CONTRACT STRUCTURAL DRAWINGS AND SPECIFICATIONS REPRESENT THE FINISHED STRUCTURE. THEY DO NOT INDICATE THE MEANS AND/OR METHODS OF CONSTRUCTION. ALTHOUGH THE NEED FOR SHORING MAY SOMETIMES BE INDICATED IN THE STRUCTURAL DRAWINGS. IT IS THE CONTRACTOR'S SOLE RESPONSIBILITY TO DESIGN, PROVIDE, AND MAINTAIN TEMPORARY BRACING, SHORING, GUYING, OR OTHER TEMPORARY SUPPORT AS REQUIRED FOR THE PROTECTION OF LIFE AND PROPERTY DURING CONSTRUCTION.
- 9. THE CONTRACTOR SHALL PROVIDE ALL NECESSARY PROTECTION OF ADJACENT STRUCTURES DURING CONSTRUCTION. THE CONTRACTOR SHALL BEAR ALL EXPENSE FOR REPAIR OR REPLACEMENT.
- 10. THE USE OF NEW CONSTRUCTION FOR TEMPORARY SUPPORT OR STORAGE OF CONSTRUCTION EQUIPMENT OR MATERIALS IS RESTRICTED TO THE DESIGN CAPACITY OF THE NEW CONSTRUCTION AT THE TIME IT IS TO BE USED. EQUIPMENT OR MATERIALS SHALL BE PLACED SO AS NOT TO EXCEED THE CAPACITY OF INDIVIDUAL ELEMENTS. PROVIDE ADEQUATE, ENGINEERED SHORING AND/OR BRACING WHERE DESIGN CAPACITY IS NOT SUFFICIENT.
- 11. SPECIFICATIONS AND DETAILING OF ALL WATERPROOFING AND DRAINAGE ITEMS, ALTHOUGH SOMETIMES INDICATED ON THE STRUCTURAL DRAWINGS FOR GENERAL INFORMATION PURPOSES ONLY, ARE SOLELY THE DESIGN RESPONSIBILITY OF OTHERS.
- 12. IT SHALL BE THE RESPONSIBILITY OF THE CONTRACTOR TO LOCATE ALL EXISTING PIPES, DUCTS, AND UTILITIES, WHETHER SHOWN HEREIN OR NOT, AND TO PROTECT THEM FROM DAMAGE. THE CONTRACTOR SHALL BEAR ALL EXPENSE FOR REPAIR OR REPLACEMENT.
- 13. ALL STRUCTURAL MEMBERS AND ELEMENTS SHOWN ON THE STRUCTURAL DRAWINGS ARE NEW UNLESS NOTED (E) FOR EXISTING CONDITIONS.

STRUCTURAL DESIGN CRITERIA

WIND DESIGN CRITERIA:

ANALYTICAL METHOD: BASIC WIND SPEED: **EXPOSURE:**

SIMPLIFIED METHOD 100 MPH

SEISMIC DESIGN CRITERIA:

PEAK GROUND ACCELERATION: SITE CLASSIFICATION: SITE COEFFICIENTS:

DESIGN SPECTRAL ACCELERATION:

Ss = 1.50G, S1 = 0.652G $F_0 = 1.0$, $F_V = 1.5$ $S_{MS} = 1.50G, S_{M1} = 0.977G$ MAXIMUM SPECTRAL ACCELERATION: $S_{DS} = 1.00G$, $S_{D1} = 0.652G$

OCCUPANCY CATEGORY: IMPORTANCE FACTOR: SEISMIC DESIGN CATEGORY:

I = 1.00

BASIS OF DESIGN

- 1. ALL NEW WORK SHALL CONFORM TO THE 2013 SAN FRANCISCO BUILDING CODE (SFBC) WHICH COMPRISES THE 2013 CALIFORNIA BUILDING CODE (CBC) AND 2013 SAN FRANCISCO AMENDMENTS
- 2. THE PUBLICATIONS LISTED BELOW ARE THE GOVERNING CODES AND STANDARDS REFERENCE BY THE CBC AND ARE REFERENCED HEREIN BY THEIR BASIC DESIGNATION. IN THE CASE OF CONFLICTING REQUIREMENTS. THE SFBC SHALL GOVERN.

AMERICAN CONCRETE INSTITUTE, "BUILDING CODE REQUIREMENTS FOR ACI 318-11 STRUCTURAL CONCRETE", 2011 EDITION

AISI AMERICAN IRON AND STEEL INSTITUTE, "NORTH AMERICAN SPECIFICATIONS FOR THE DESIGN OF COLD-FORMED STEEL STRUCTURAL MEMBERS", LATEST

ASCE 7-10 AMERICAN SOCIETY OF CIVIL ENGINEERS, "MINIMUM DESIGN LOADS FOR BUILDINGS AND OTHER STRUCTURES", 2010 EDITION

ASTM AMERICAN SOCIETY FOR TESTING AND MATERIALS

AWS D1.1 AMERICAN WELDING SOCIETY, "STRUCTURAL WELDING CODE - STEEL", 2010 AWS D1.3 AMERICAN WELDING SOCIETY, "STRUCTURAL WELDING CODE - SHEET STEEL",

AWS D1.4 AMERICAN WELDING SOCIETY, "STRUCTURAL WELDING CODE - REINFORCING

AMERICAN WELDING SOCIETY. "STRUCTURAL WELDING CODE - STAINLESS STEEL", 2007 EDITION

AWS D1.8 AMERICAN WELDING SOCIETY, "STRUCTURAL WELDING CODE — SEISMIC SUPPLEMENT", 2009 EDITION

STEEL", 2011 EDITION

FOUNDATIONS

- THE FOUNDATION DESIGN IS BASED UPON THE PROJECT GEOTECHNICAL MEMORANDUM "17TH AND FOLSOM STREET PARK", PREPARED BY SAN FRANCISCO PUBLIC WORKS, INFRASTRUCTURE DESIGN AND CONSTRUCTION, DATED MARCH 27. 2015.
- DESIGN SOIL PARAMETERS:

ALLOWABLE BEARING PRESSURE: 1,500 PSF FOR DEAD LOADS + LIVE LOADS

2.000 PSF FOR DEAD LOADS + LIVE LOADS + LATERAL LOADS

ACTIVE PRESSURE:

35 PCF

SEISMIC PRESSURE: 13H PSF. WHERE H IS THE HEIGHT OF RETAINED SOIL IN FEET

COEFFICIENT OF FRICTION:

0.35 BETWEEN CONCRETE AND SOIL

PASSIVE EARTH PRESSURE: 250 PCF EQUIVALENT FLUID PRESSURE

(IGNORE UPPER 12 INCHES UNLESS COVERED BY CONCRETE SLAB)

- 3. REFER TO THE GEOTECHNICAL REPORT FOR ADDITIONAL INFORMATION AND RECOMMENDATIONS NOT NOTED HERE.
- 4. THE GEOTECHNICAL ENGINEER SHALL VERIFY THE CONDITIONS AND/OR ADEQUACY OF ALL SUBGRADES. ENGINEERED FILLS, AND BACKFILLS BEFORE PLACEMENT OF FILLS, FOOTINGS, SLABS, OR OTHER CONSTRUCTION DEPENDENT UPON THEM.
- EXCAVATIONS FOR FOOTINGS SHALL BE OBSERVED BY THE GEOTECHNICAL ENGINEER PRIOR TO PLACING REINFORCING AND CONCRETE. THE CONTRACTOR SHALL NOTIFY THE GEOTECHNICAL ENGINEER WHEN THE EXCAVATIONS ARE READY FOR OBSERVATION BY THE GEOTECHNICAL ENGINEER.
- 6. SIDES OF FOUNDATIONS SHOWN STRAIGHT ARE FORMED. IF SITE CONDITIONS ALLOW AND GEOTECHNICAL ENGINEER CONCURS, SIDES OF FOUNDATION MAY BE FORMED OR NOT FORMED AT CONTRACTOR'S OPTION.
- CONTRACTOR SHALL PROVIDE FOR DE-WATERING IF WATER IS PRESENT IN THE EXCAVATION. DE-WATERING PLANS SHALL BE SUBMITTED FOR REVIEW. DE-WATERING PLANS MAY INCLUDE A MONITORING PROGRAM TO EVALUATE SETTLEMENT IN THE ADJACENT IMPROVEMENTS. SEE GEOTECHNICAL REPORT.
- THE CONTRACTOR IS SOLELY RESPONSIBLE FOR THE DESIGN AND INSTALLATION OF APPROPRIATE, ADEQUATE SHORING AND BRACING OF FOUNDATION EXCAVATION, AND UNDERPINNING OF EXISTING STRUCTURES TO ENSURE PROTECTION OF LIFE AND ADJACENT PROPERTY, STRUCTURES, STREETS, AND UTILITIES IN ACCORDANCE WITH APPLICABLE FEDERAL. STATE AND LOCAL ORDINANCES. UNDERPINNING, SHORING, LAGGING, ETC., SHALL BE DESIGNED BY A PROFESSIONAL ENGINEER REGISTERED IN THE STATE OF CALIFORNIA AND SHALL BE CONSTRUCTED UNDER SEPARATE PERMIT. SHORING PLAN TO BE SUBMITTED TO THE GEOTECHNICAL ENGINEER AND THE STRUCTURAL ENGINEER FOR REVIEW TO ENSURE CONFORMANCE WITH DESIGN DOCUMENTS.
- 9. THE CONTRACTOR SHALL NOT UNDERMINE EXISTING FOUNDATIONS AND STRUCTURES DURING EXCAVATION. IF UNDERMINING OCCURS, THE CONTRACTOR SHALL PROVIDE CORRECTIVE MEASURES FOR ENGINEER TO REVIEW AND APPROVE AT CONTRACTOR'S EXPENSE.
- 10. INSTALLATION OF CAST-IN DRILLED HOLE PILES (CIDH) SHALL BE PERFORMED WHILE UNDER THE OBSERVATION OF THE GEOTECHNICAL ENGINEER OF RECORD.

<u>CONCRETE</u>

- MIXING, BATCHING, TRANSPORTING, PLACING, AND CURING OF ALL CONCRETE AND SPECIFICATION OF CONCRETE MATERIALS, SHALL CONFORM TO ACI 301 "SPECIFICATION FOR STRUCTURAL CONCRETE", EXCEPT AS NOTED BELOW.
- CONCRETE SHALL BE READY-MIXED CONFORMING TO ASTM C94. CEMENT SHALL BE PORTLAND CEMENT TYPE II, CONFORMING TO ASTM C150. ALL CONCRETE USED IN SUSPENDED SLABS AND SLABS-ON-GRADE SHALL BE DESIGNED WITH A SHRINKAGE LIMITATION OF 0.04% AFTER 28 DAYS OF DRYING.
- CONCRETE MIX DESIGNS SHALL BE SUBMITTED TO THE ENGINEER AND APPROVED PRIOR TO USE. SELECTION OF CONCRETE MIX PROPORTIONS SHALL BE IN ACCORDANCE WITH ACI 301. MIX PROPORTIONS SHALL MEET OR EXCEED THE REQUIREMENTS LISTED BELOW FOR THE LOCATIONS NOTED. THE MORE STRINGENT OF THE REQUIREMENTS LISTED
- SUPPLEMENTARY CEMENTITIOUS MATERIALS (SCM), SUCH AS SLAG, FLY ASH, SILICA FUME, AND CALCINED CLAY, AS A PERCENTAGE OF TOTAL WEIGHT OF CEMENTITIOUS MATERIAL SHALL BE A MINIMUM OF 25 PERCENT AND A MAXIMUM OF 50 PERCENT. COAL FLY ASH, AS A PERCENTAGE OF TOTAL WEIGHT OF CEMENTITIOUS MATERIAL, SHALL BE A MAXIMUM OF 20 PERCENT. COAL FLY ASH SHALL BE CLASS F, MEETING ASTM C618 REQUIREMENTS. FINELY GROUND GRANULATED BLAST-FURNACE SLAG SHALL CONFORM TO ASTM C989. WATER/CEMENT RATIO SHALL BE BASED ON TOTAL CEMENTITIOUS MATERIAL. INCLUDING SUPPLEMENTARY CEMENTITIOUS MATERIALS.
- PROPORTIONS OF AGGREGATE TO CEMENTITIOUS PASTE SHALL BE SUCH AS TO PRODUCE A DENSE, WORKABLE MIX THAT CAN BE PLACED WITHOUT SEGREGATION OR EXCESS FREE SURFACE WATER. SUPERPLASTICIZERS MAY BE USED TO IMPROVE WORKABILITY IN THIN OR CONGESTED SECTIONS.
- CONCRETE SHALL HAVE THE FOLLOWING CHARACTERISTICS:

LOCATION	STRENGTH,	TEST AGE	MAXIMUM AGGREGATE SIZE	MAXIMUM WATER/CEMENT RATIO	MAX SLUM
FOOTINGS	4,000 PSI	28 DAYS	3/4"	0.45	4"
SLABS-ON-GRADE	4,000 PSI	28 DAYS	3/4"	0.45	4"
CIDH PILES	4,000 PSI	28 DAYS	3/4"	0.45	3 1/2
CURBS	3,000 PSI	28 DAYS	3/4"	0.45	3 ½

- PIPES OTHER THAN ELECTRICAL CONDUITS SHALL NOT BE EMBEDDED IN STRUCTURAL CONCRETE EXCEPT WHERE SPECIFICALLY APPROVED BY THE ENGINEER. OUTSIDE DIAMETER OF CONDUIT EMBEDDED IN CONCRETE SHALL NOT EXCEED 1/6 TIMES THE MEMBER THICKNESS, OR 1 1/4", WHICHEVER IS LESS, WITHOUT APPROVAL OF THE ENGINEER. MINIMUM CLEAR DISTANCE BETWEEN CONDUITS OR REBAR SHALL BE 3 TIMES CONDUIT-DIAMETER (LARGER CONDUIT) OR 1 INCH, WHICHEVER IS GREATER. CONDUIT EMBEDDED IN SLABS SHALL BE EMBEDDED IN ONE LAYER AT MID-DEPTH OF SLABS. CONDUITS SHALL BE FIRMLY CHAIRED AND TIED TO PREVENT DISPLACEMENT DURING CONCRETE PLACEMENT. CONDUIT CAN BE TIED TO REBAR WHEN ORIENTED PERPENDICULAR TO THEM, PROVIDE THE LOCATION OF THE REBAR IS NOT AFFECTED BY THE CONDUIT. PLACE #3 AT 12 INCHES ADDED REINFORCEMENT PERPENDICULAR TO CONDUITS WHERE REQUIRED TO SUPPORT CONDUIT. CONDUITS WITHOUT CLEARANCE NOTED ABOVE SHALL BE SUBMITTED TO THE ENGINEER FOR REVIEW PRIOR TO INSTALLATION. ADDED TRIM REINFORCEMENT WILL BE REQUIRED WHERE CLEARANCES CANNOT BE MET, SUCH AS ELECTRICAL PANEL ROOMS.
- SLEEVES, WHEN EMBEDDED IN CONCRETE, SHALL BE SPACED WITH ONE SLEEVE-DIAMETER (LARGER SLEEVE) CLEAR BETWEEN ADJACENT SLEEVES OR REBAR. OR 1 INCH. WHICHEVER IS GREATER. SLEEVES WITHOUT CLEARANCE NOTED ABOVE SHALL BE SUBMITTED TO THE ENGINEER FOR REVIEW PRIOR TO INSTALLATION. ADDED TRIM REINFORCEMENT WILL BE REQUIRED WHERE CLEARANCES CANNOT BE MET, SUCH AS ELECTRICAL PANEL ROOMS.
- 9. ALUMINUM PIPES, CONDUITS, AND SLEEVES SHALL NOT BE EMBEDDED IN STRUCTURAL CONCRETE.
- 10. THE CONTRACTOR SHALL INFORM THE ENGINEER AT LEAST 3 DAYS PRIOR TO POURING ANY STRUCTURAL CONCRETE SO THAT THE ENGINEER MAY HAVE THE OPPORTUNITY OF REVIEWING THE WORK PRIOR TO CONCRETE PLACEMENT.
- 11. ALL CONCRETE EXCEPT SLABS-ON-GRADE 6"THICK OR LESS SHALL BE MECHANICALLY VIBRATED AS TO COMPLETELY FILL THE FORM WITHOUT CAUSING UNDUF SEGREGATION.
- 12. FOR EACH CLASS OF CONCRETE, FOUR TEST CYLINDERS FROM EACH 150 CUBIC YARDS OR 5,000 SQUARE FEET OF SURFACE AREA FOR SLABS OR WALLS, PLACED IN ANY ONE DAY, SHALL BE SECURED AND TESTED BY BUILDING DESIGN & CONSTRUCTION TESTING LAB — ONE TO BE TESTED AT 7 DAYS, TWO AT 28 DAYS, AND THE FOURTH HELD IN RESERVE.
- 13. THE CONTRACTOR SHALL REMOVE AND REPLACE ANY CONCRETE WHICH FAILS TO ATTAIN SPECIFIED STRENGTH IN 28 DAYS IF SO DIRECTED BY THE ENGINEER. ANY DEFECTS IN THE HARDENED CONCRETE SHALL BE SATISFACTORILY REPAIRED OR THE HARDENED CONCRETE SHALL BE REPLACED.
- 14. PROJECTING CORNERS SHALL BE FORMED WITH A 3/2" CHAMFER UNLESS OTHERWISE NOTED ON THE DRAWINGS.
- 15. ALL CONSTRUCTION JOINTS SHALL BE CONSTRUCTED IN ACCORDANCE WITH ACI 318 AND THE TYPICAL CONSTRUCTION JOINT DETAILS SHOWN ON THE STRUCTURAL DRAWINGS. ALL SURFACES OF CONSTRUCTION JOINTS SHALL BE CLEANED TO REMOVE DUST, CHIPS, OR OTHER FOREIGN MATTER PRIOR TO PLACING THE ADJACENT CONCRETE. THE CONTRACTOR SHALL SUBMIT THE PROPOSED LOCATIONS OF CONSTRUCTION JOINTS TO THE ENGINEER FOR REVIEW PRIOR TO START OF CONSTRUCTION.
- 16. WHERE NEW CONCRETE IS TO BE CAST AGAINST EXISTING CONCRETE, THE EXISTING CONCRETE SURFACE SHALL BE ROUGHENED TO A MINIMUM OF 1/4" AMPLITUDE BY SANDBLASTING OR BUSH HAMMERING. THE EXISTING SURFACE SHALL BE CLEANED AND LAITANCE REMOVED. APPLY "SIKADUR 32. HI-MOD" EPOXY BONDING ADHESIVE. AS MANUFACTURED BY SIKA CORPORATION, LYNDHURST, NEW JERSEY, OR APPROVED EQUAL, TO EXISTING CONCRETE SURFACE PRIOR TO PLACEMENT OF NEW CONCRETE.

BUILDING **DESIGN & CONSTRUCTION**



CITY AND COUNTY OF SAN FRANCISCO

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Project

17th & FOLSOM STREET PARK 2080 FOLSOM STREET

SAN FRANCISCO, CA 94110

Consultant

INFRASTRUCTURE **DESIGN & CONSTRUCTION**

DEPARTMENT OF PUBLIC WORKS CITY AND COUNTY OF SAN FRANCISCO

30 Van Ness Avenue San Francisco, CA 94102-6028

(415) 558-4000 Fax (415) 558-4093

BY APPR'D

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DESCRIPTION

REVISIONS

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Drawing Title


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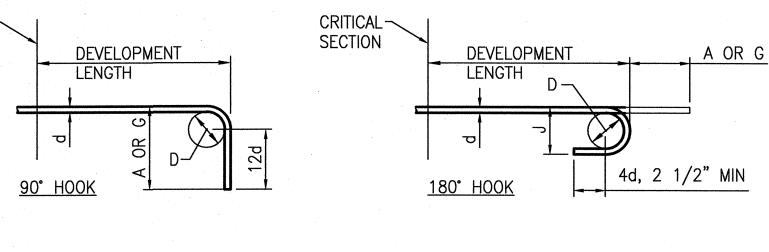
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GENERAL NOTES - 1

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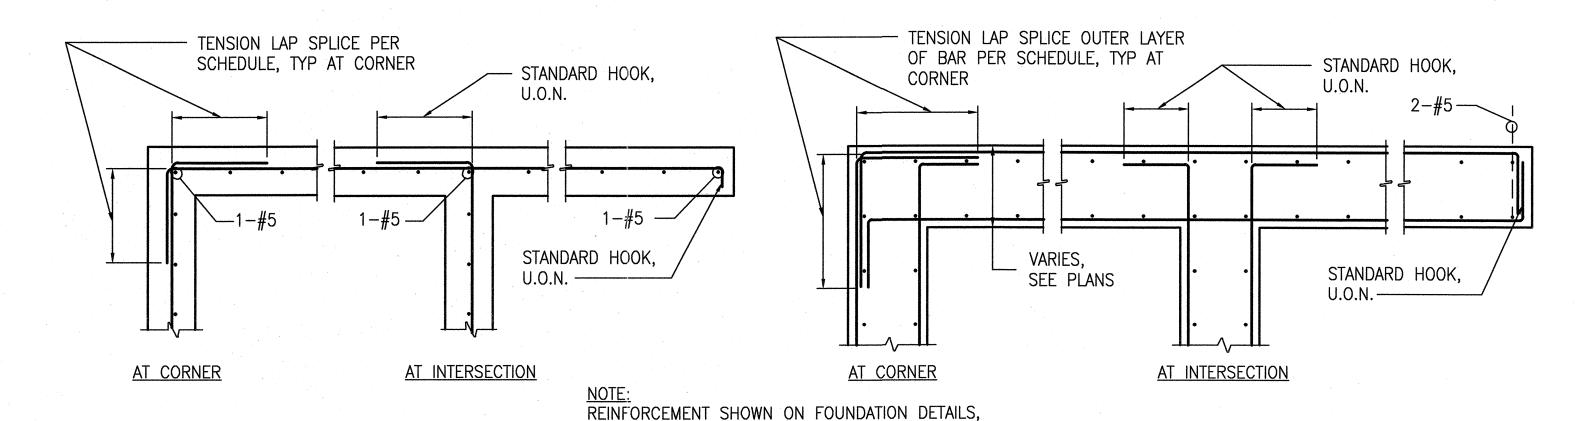


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l			MAI	N REBAR HOOK	•	
ſ	BAR SIZE	D	90° HOOKS	180° H	HOOKS	DEVELOPMENT LENGTH
ŀ	DAIL SIZE	·	A OR G	". J.	A OR G	DEVELOPMENT LENGTH
. [#3	21/2"	6 "	3"	5 "	0'-8"
	#4	3"	8"	4"	6"	0'-10"
	# 5	33/4"	10"	5"	7"	1'-0"
ſ	#6	4½"	1'-0"	6"	8"	1'-3"
I	#7	51/4"	1'-2"	7"	10"	1'-5"
	#8	6"	1'-4"	8"	11"	1'-7"
ſ	# 9	9½"	1'-7"	11¾"	1'-3"	1'-10"
	#10	10¾"	1'-10"	1'-1¼"	1'-5"	2'-1"
	#11	1'-0"	2'-0"	1'-2¾"	1'-7"	2'-3"

TYPICAL REINFORCEMENT BAR HOOKS AND BENDS

1'-4"

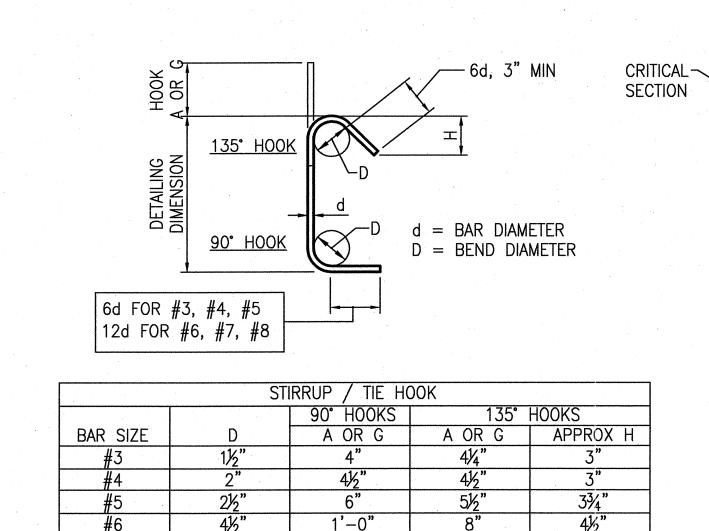SCALE: N.T.S.



WALL ELEVATIONS, AND OTHER SPECIFICALLY


REINFORCEMENT SHOWN HERE.

REFERENCED DETAILS TAKE PRECEDENCE OVER

TYPICAL CONCRETE REINFORCEMENT AT CORNERS AND INTERSECTIONS

S-1.3


DOUBLE CURTAIN REINF. DETAILS

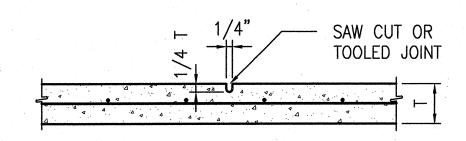

SINGLE CURTAIN REINF. DETAILS

SCALE: N.T.S.

WEAKENED PLANE JOINT (W.P.J.)

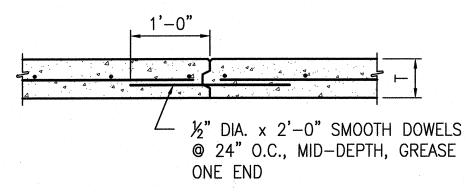

SHRINKAGE JOINT (S.J.)


FOR SLAB THICKNESS AND REINFORCEMENT, SEE PLANS.

- 2. CONTRACTOR TO DETERMINE CONTROL JOINT LOCATIONS AND SUBMIT TO ENGINEER FOR REVIEW.
- 3. LOCATE WEAKENED PLANE JOINTS (W.P.J.) TO ENCLOSE APPROXIMATE AREAS OF 600 SQUARE FEET AND SPACE 20'-0" O.C. MAXIMUM.
- 4. LOCATE SHRINKAGE JOINTS (S.J.) TO ENCLOSE APPROXIMATE AREAS OF 3,600 SQUARE FEET MAXIMUM.
- 5. S.J. MAY BE USED AS CONSTRUCTION JOINTS (C.J.) FOR SLABS ON GRADE WHERE REQUIRED.
- 6. FOR SAW CUT, CUT SLAB IMMEDIATELY AFTER INITIAL CONCRETE SET AND BEFORE FINAL CURING.
- 7. S.J. MAY BE FORMED BY USING WOOD EDGE FORM WITH BEVELED 1x KEYS x 12" LONG AT 24" O.C. OR CONTINUOUS "BURKE" KEYED KOLD JOINT, OR APPROVED EQUAL.

TYPICAL SLAB-ON-GRADE CONTROL JOINTS

SCALE: N.T.S.



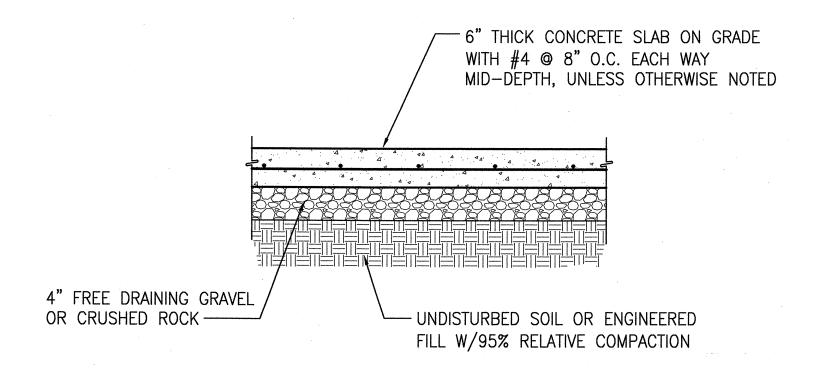


REFER TO GEOTECHNICAL REPORT FOR ADDITIONAL INFORMATION ON SUB-GRADE PREPARATION AND SLAB-ON-GRADE CONSTRUCTION.

TYPICAL CONCRETE SLAB-ON-GRADE SCALE: N.T.S.

S-1.3


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S-1.3

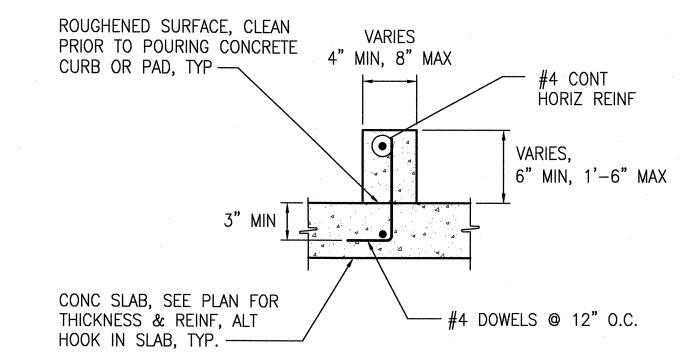

TYPICAL CONCRETE CURB

SCALE: N.T.S.

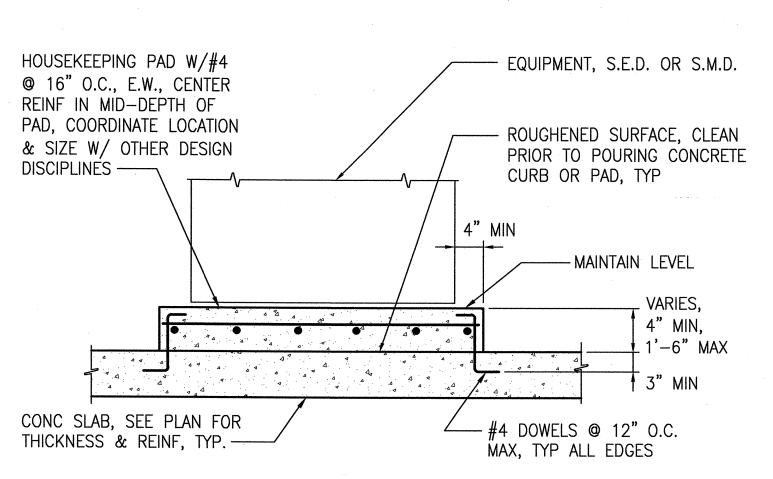

FOR EQUIPMENT ANCHORAGE, SEE ELECTRICAL, MECHANICAL, AND ADDITIONAL DRAWINGS FOR INFORMATION

TYPICAL CONCRETE HOUSEKEEPING PAD

SCALE: N.T.S.

S-1.3

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2080 FOLSOM STREET SAN FRANCISCO, CA 94110

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INFRASTRUCTURE **DESIGN & CONSTRUCTION**

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07/15 Approvals WLW JUL 2015

DIVISION MANAGER SC SC JUL 2015 NO. DATE BY APPR'D DESCRIPTION REVISIONS


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Job No.

TYPICAL CONCRETE DETAILS

Sheet No. S-1.3

3054V

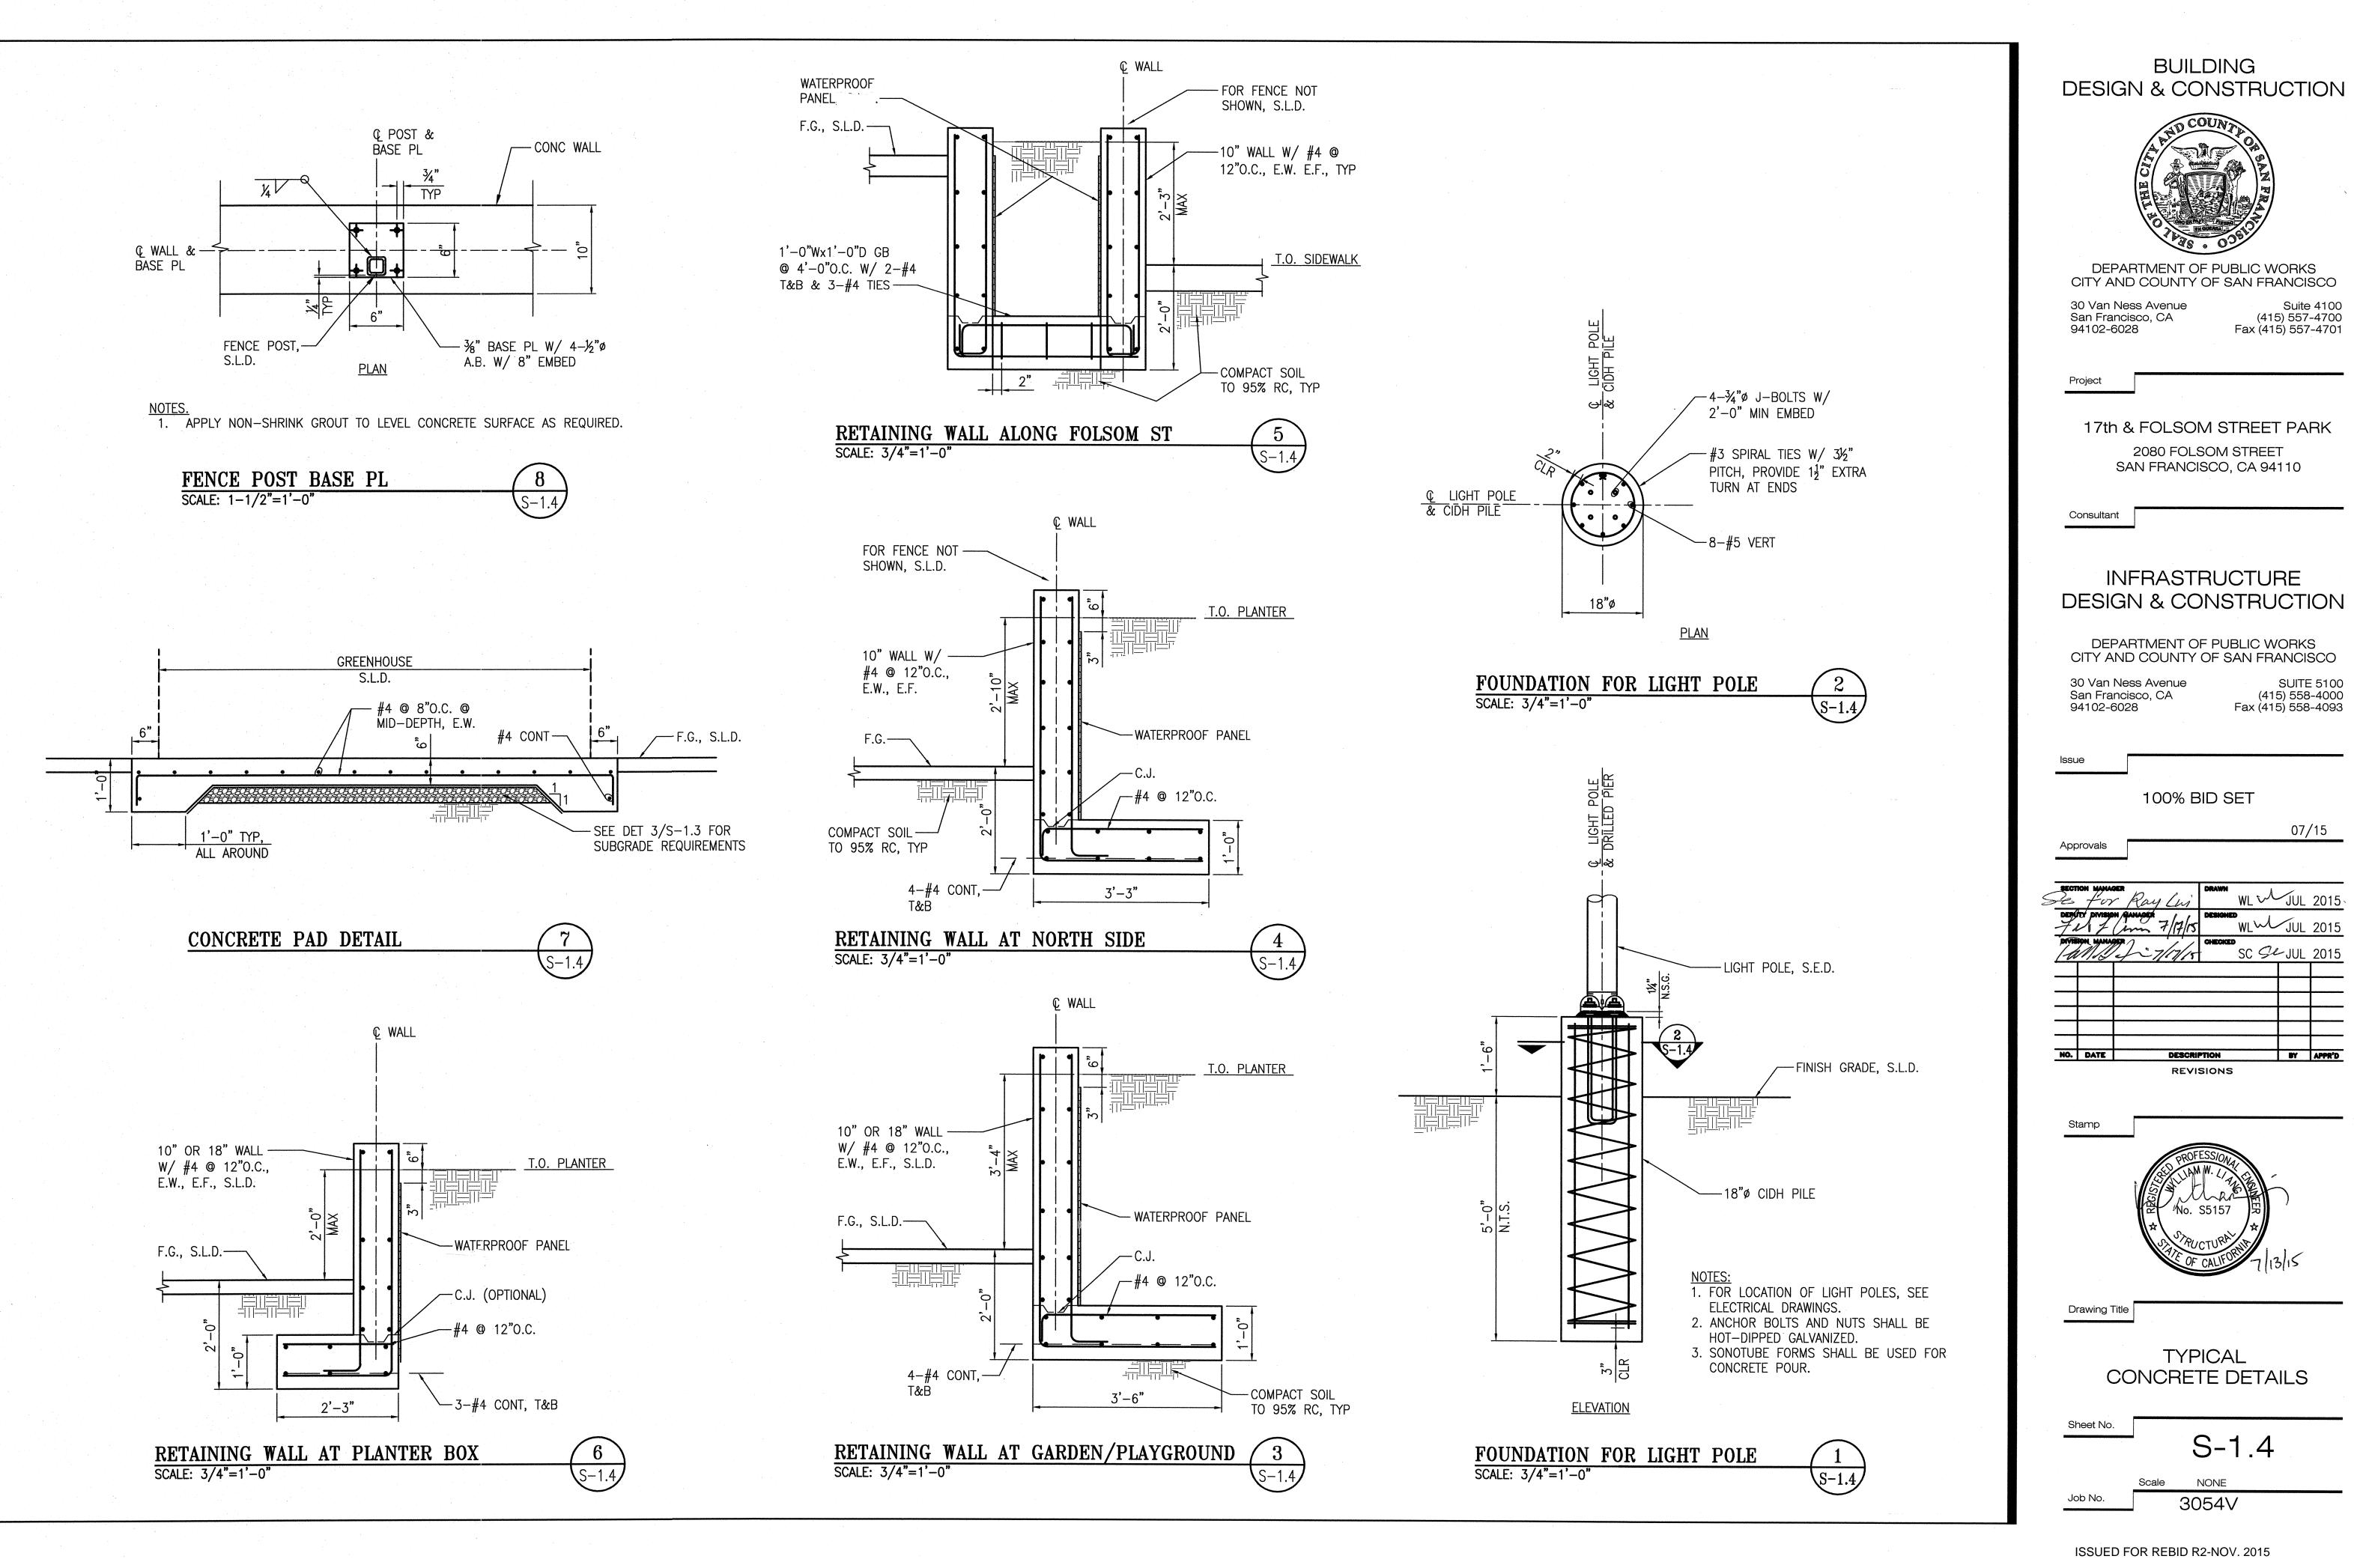

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BUILDING

DEPARTMENT OF PUBLIC WORKS

17th & FOLSOM STREET PARK

2080 FOLSOM STREET

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INFRASTRUCTURE

DEPARTMENT OF PUBLIC WORKS

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CONCRETE DETAILS

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S-1.4


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100% BID SET

Approvals 07/15

DESCRIPTION

SECTION MANAGER

FOR PLAY (LLV)

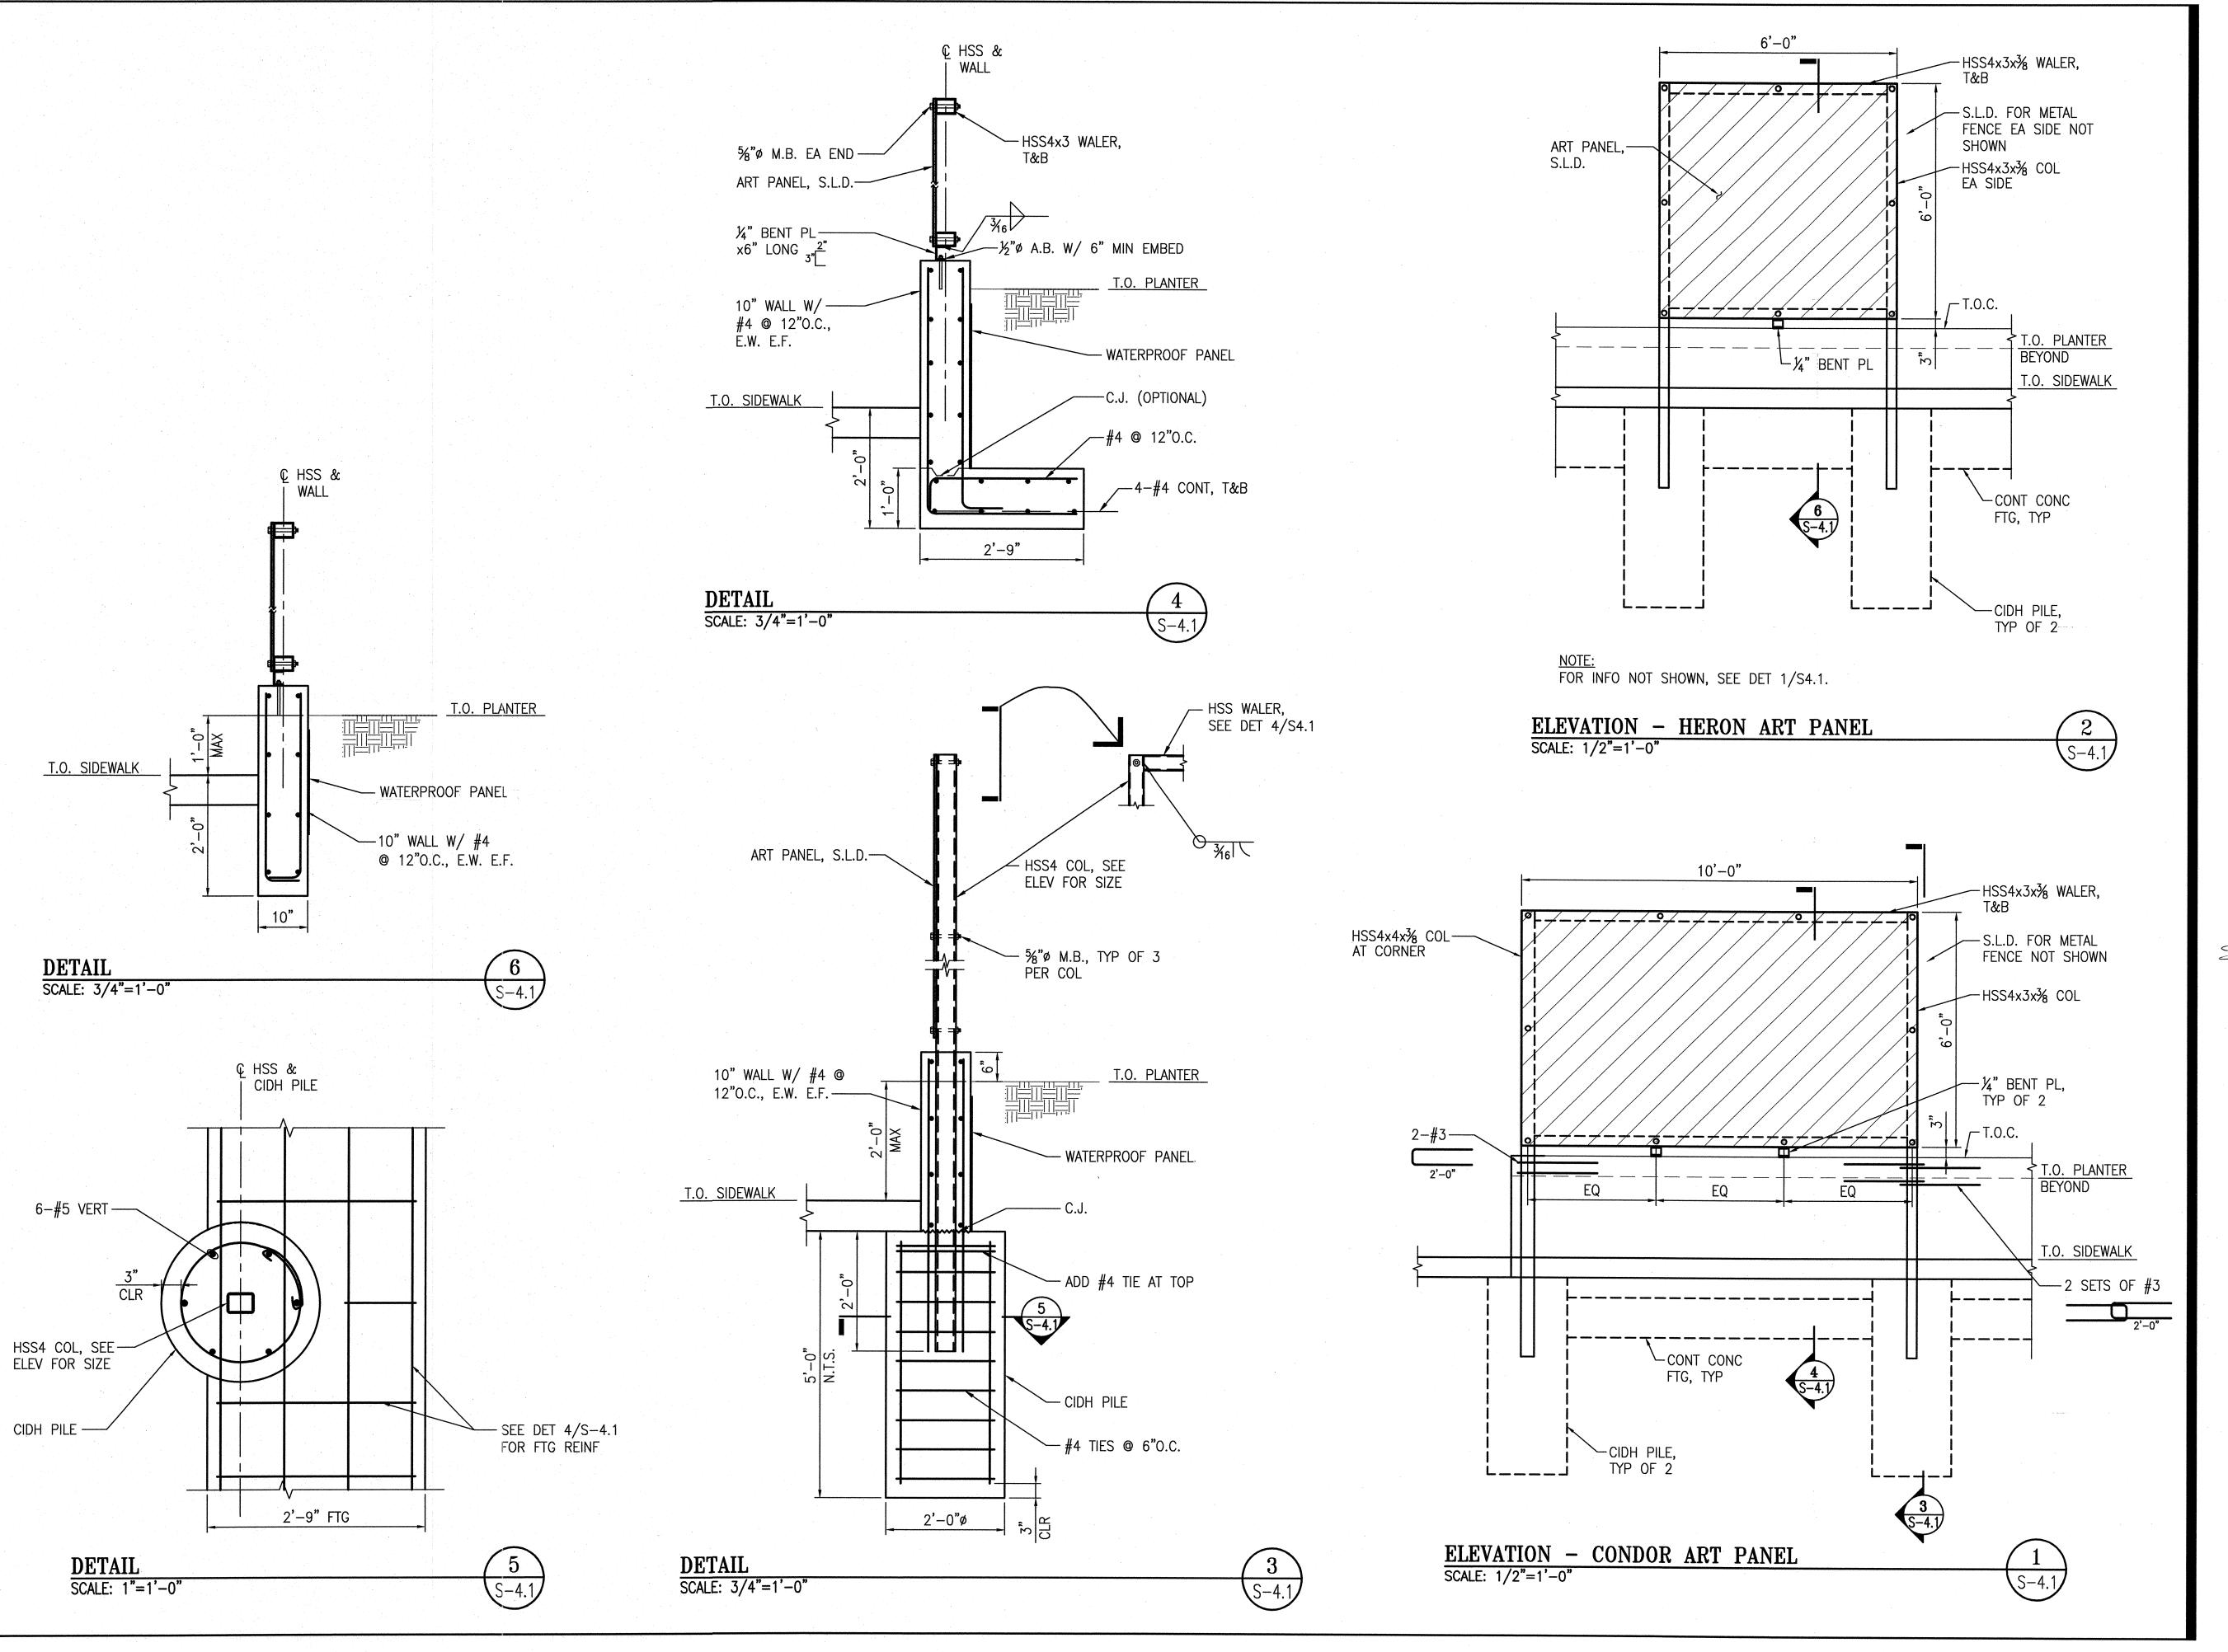DESIGNED

WL JUL 2015

DESIGNED

WL JUL 2015

CHECKED

SC SC JUL 2015

NO. DATE

DESCRIPTION

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ELEVATIONS AND DETAILS

Sheet No.


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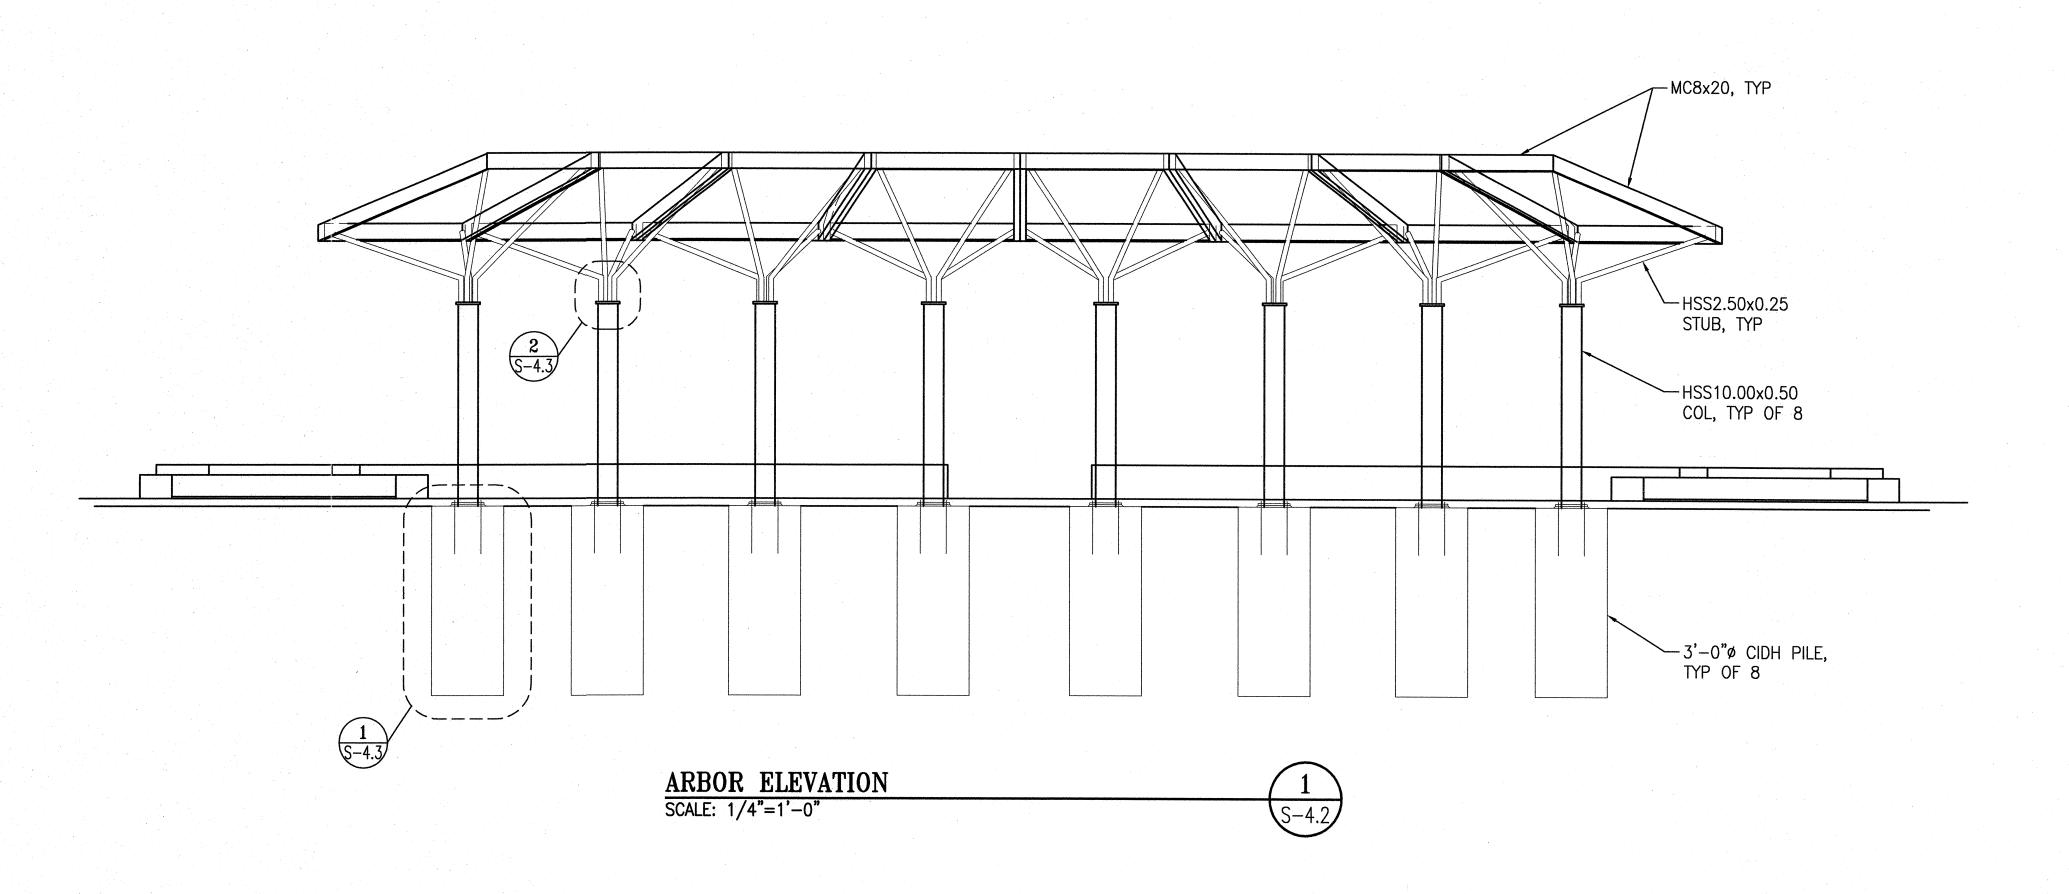
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Job No.

3054V

SHEET NOTES: 1. S.L.D. FOR ALL DIMENSIONS NOT SHOWN. 2. INTERMEDIATE MC8's ARE NOT SHOWN ON ELEVATION VIEW FOR CLARITY.



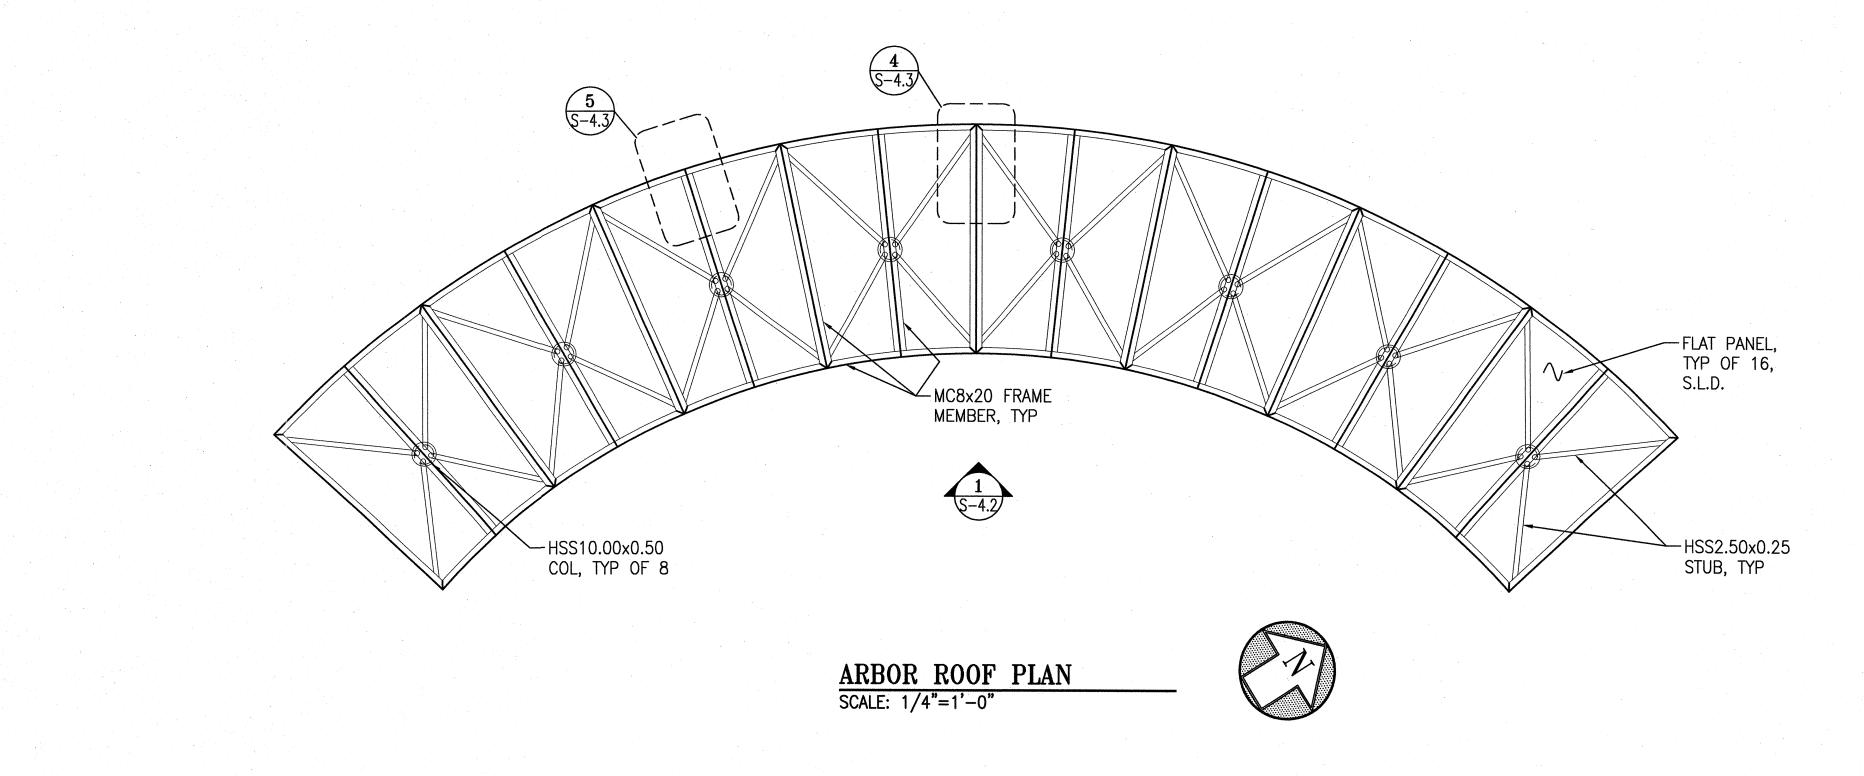

BUILDING **DESIGN & CONSTRUCTION**



DEPARTMENT OF PUBLIC WORKS CITY AND COUNTY OF SAN FRANCISCO

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17th & FOLSOM STREET PARK

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Consultant

INFRASTRUCTURE **DESIGN & CONSTRUCTION**

DEPARTMENT OF PUBLIC WORKS
CITY AND COUNTY OF SAN FRANCISCO

30 Van Ness Avenue San Francisco, CA


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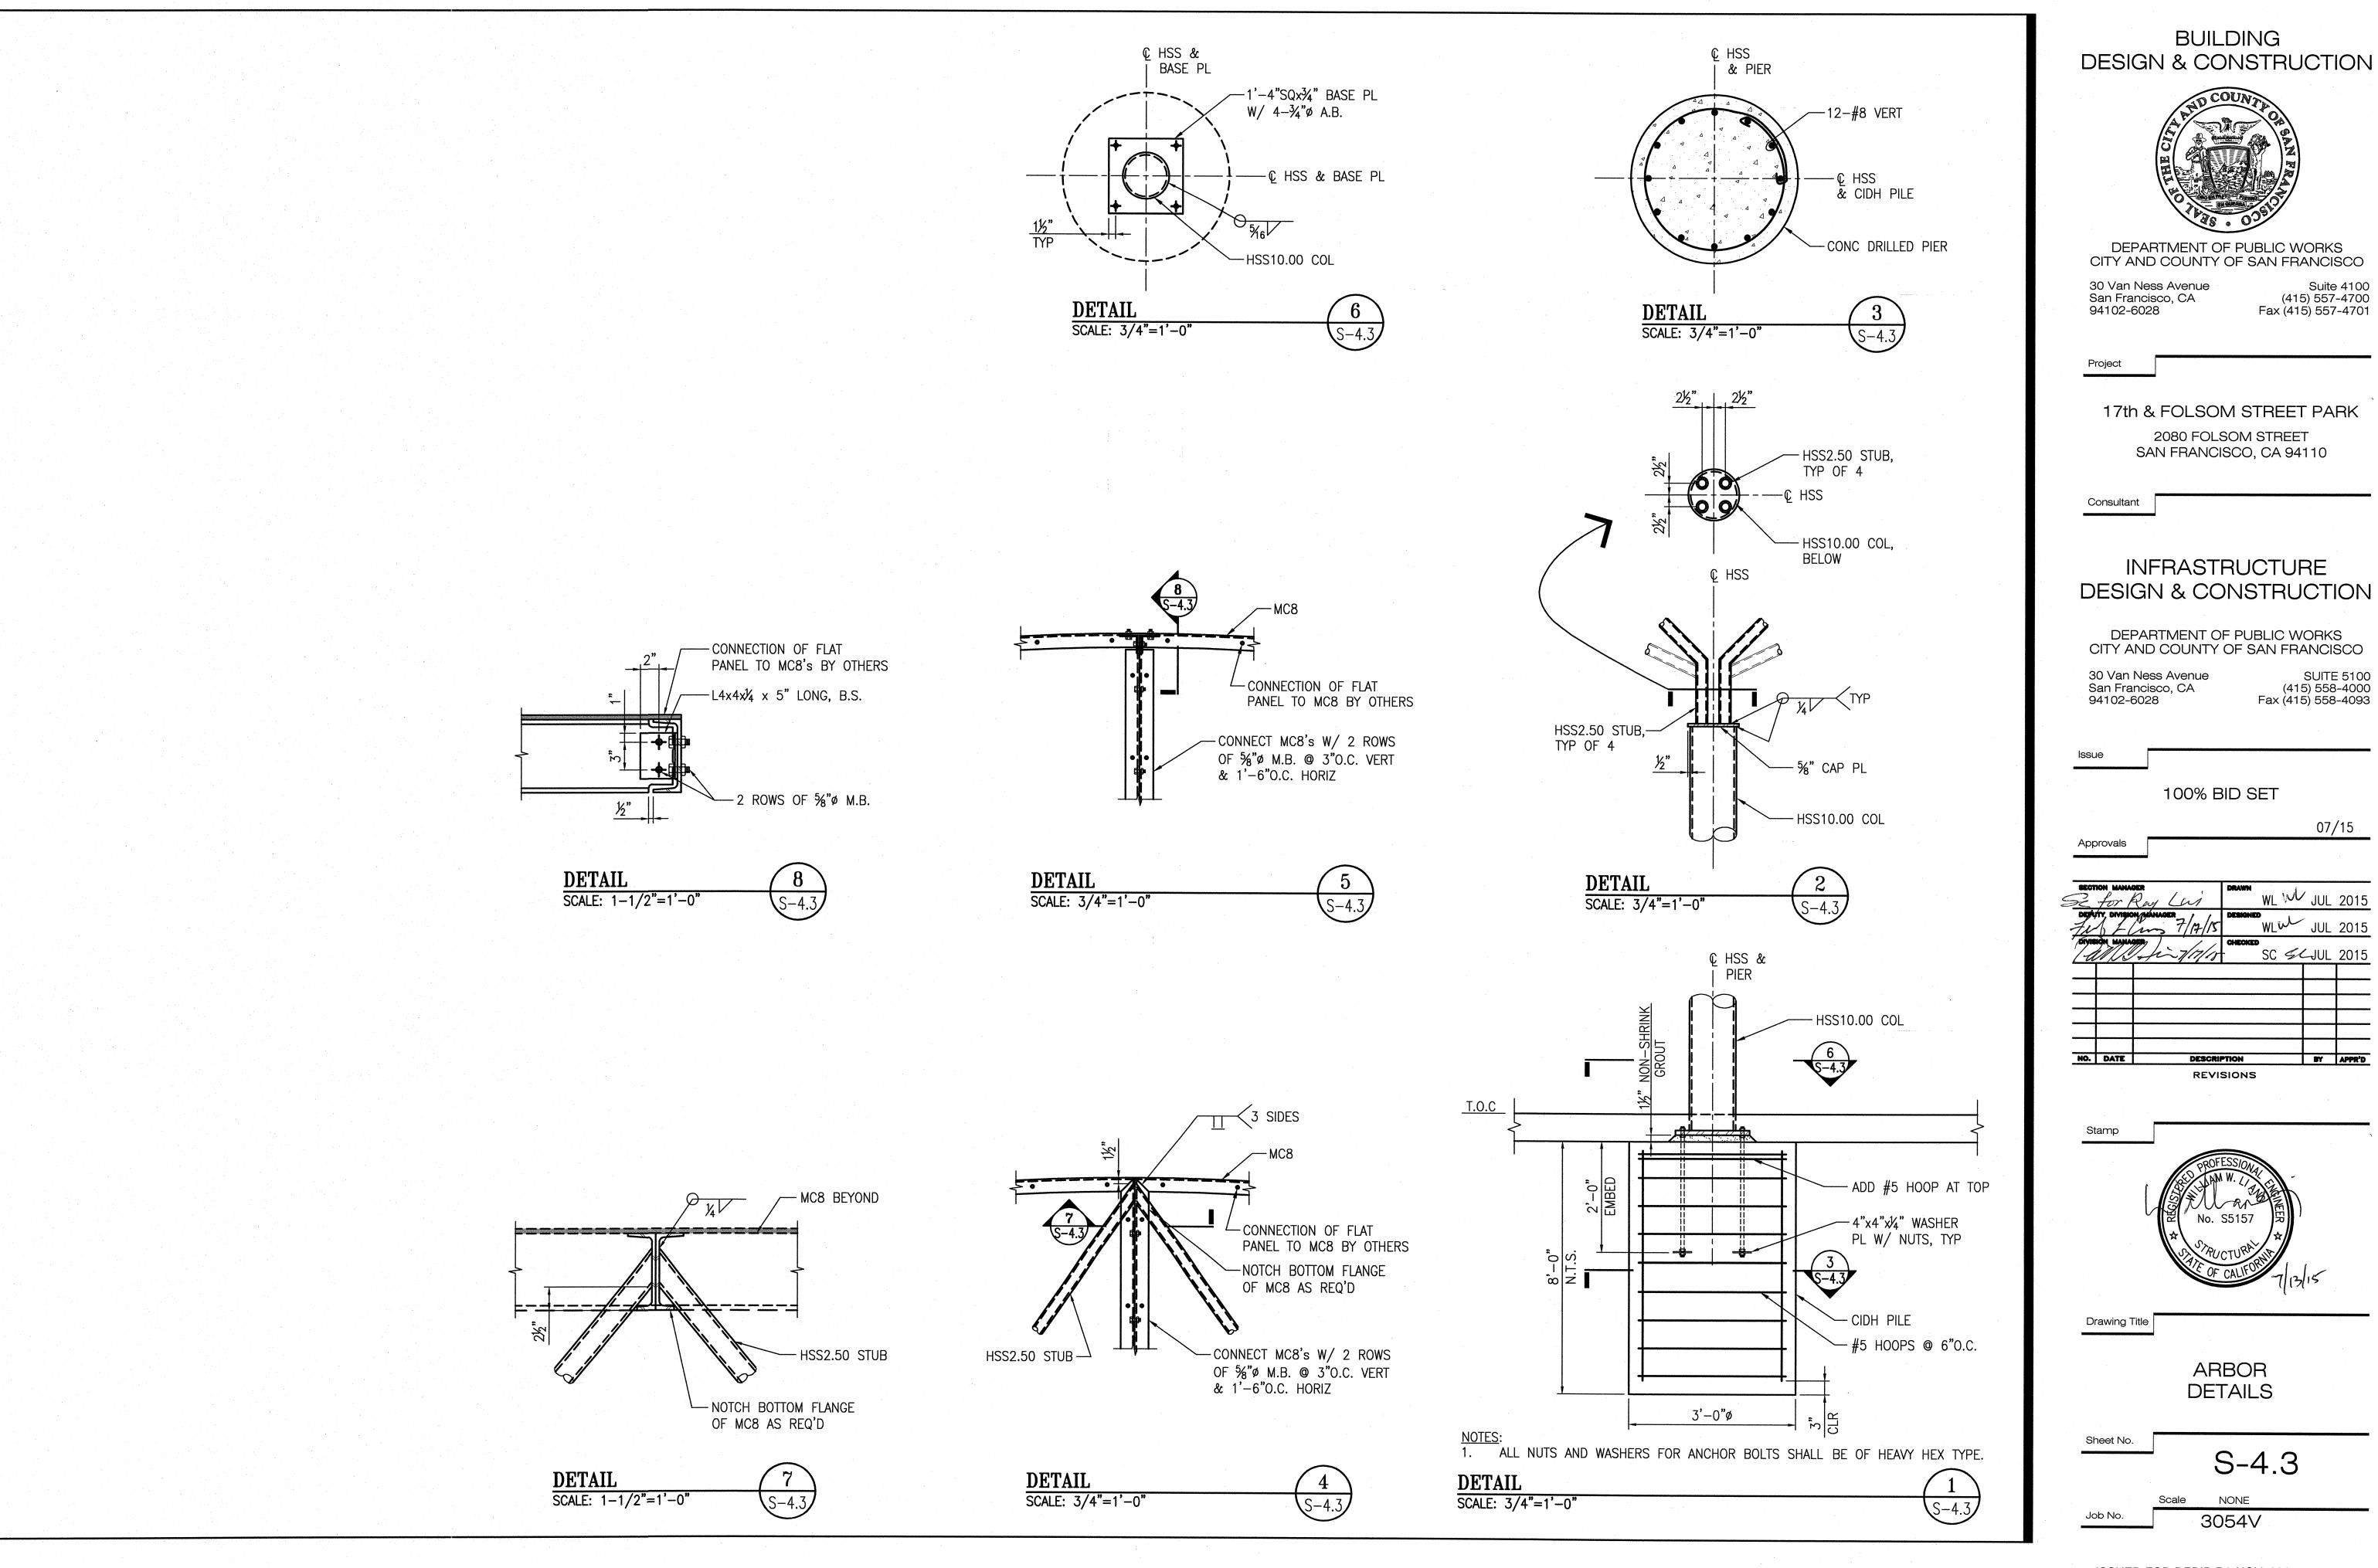


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ARBOR PLAN & ELEVATION

S-4.2

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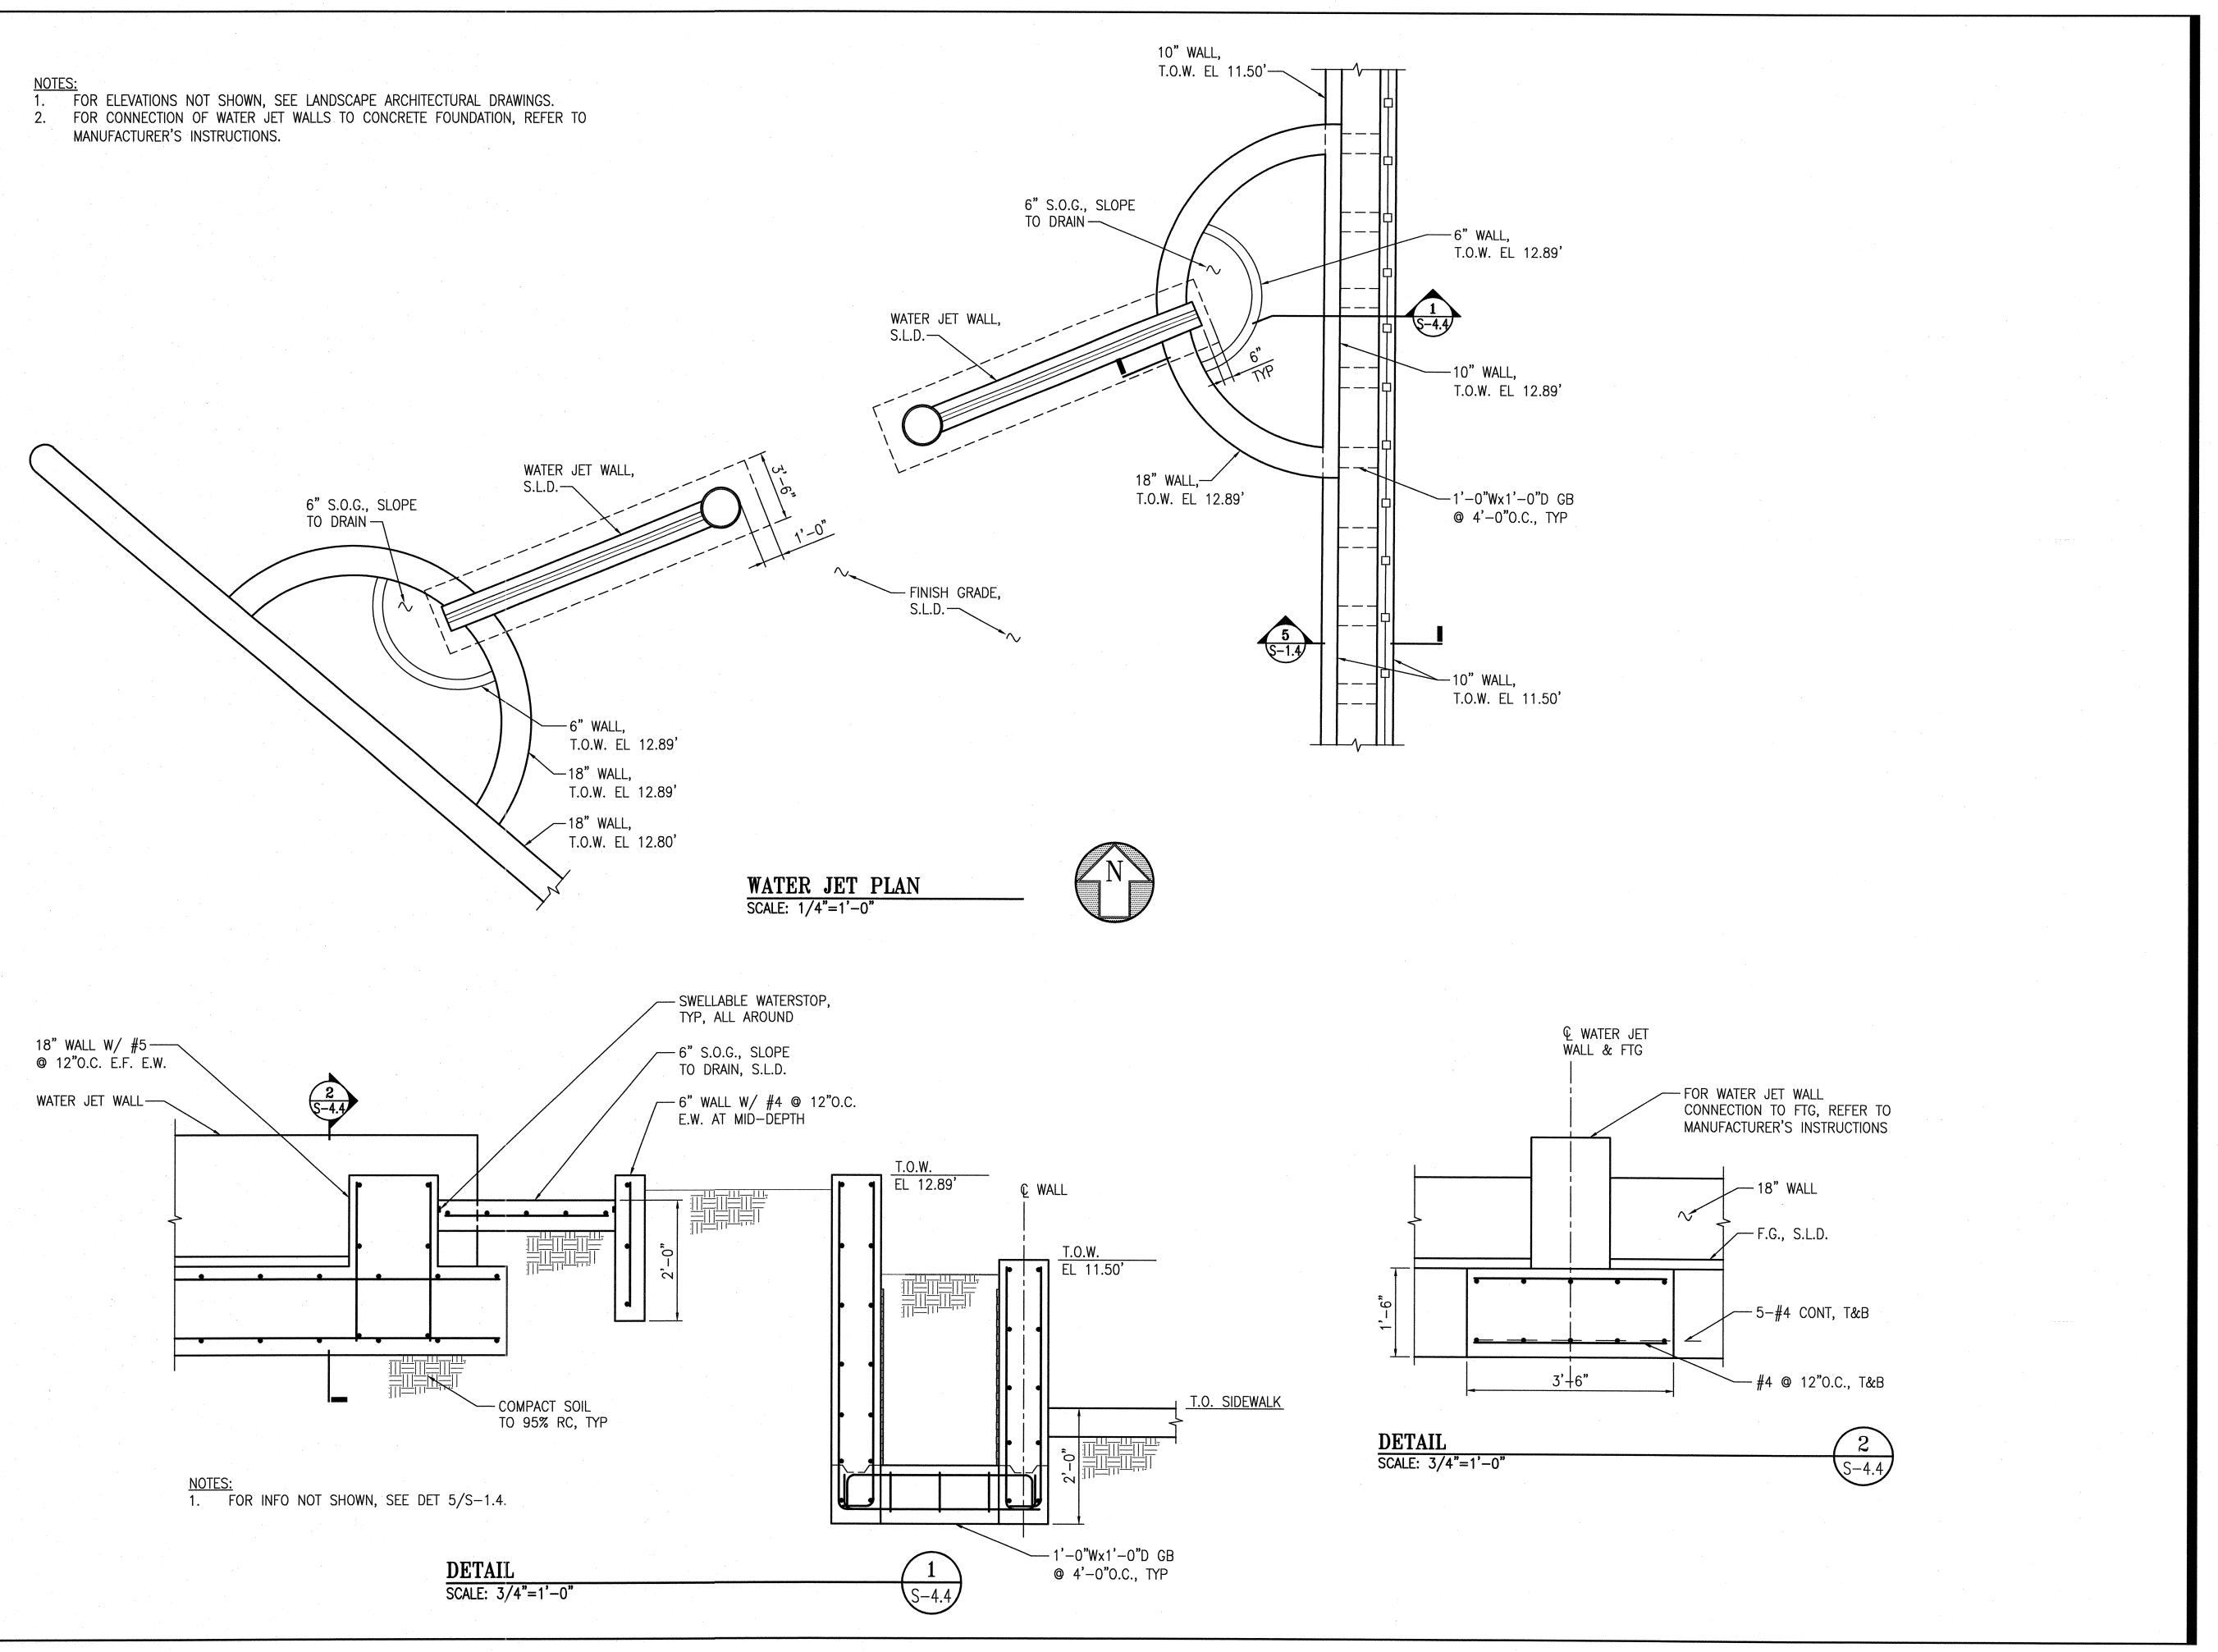
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BUILDING DESIGN & CONSTRUCTION

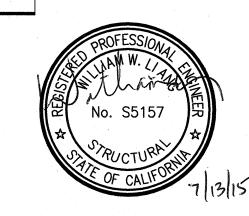

DEPARTMENT OF PUBLIC WORKS CITY AND COUNTY OF SAN FRANCISCO

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17th & FOLSOM STREET PARK

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INFRASTRUCTURE DESIGN & CONSTRUCTION

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BY APPR'D

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SECTION MANAGER

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REVISIONS

Drawing Title

WATER JET PLAN & DETAILS

Sheet N

S-4.4

Job No. Scale NONE 3054V

	ABBREY	VIATIO	ONS	NOTES		DRAWING INDEX	BUILDING DESIGN & CONSTRUCTION
ABBR	DESCRIPTION	ABBR	DESCRIPTION	GENERAL NOTES		MECHANICAL	_ DEDICING COUNTS
ALT	ALTERNATE	МН	MANHOLE	PERFORM WORK AND CONFORM TO APPLICABLE CODES AND ORDINANCES OF GOVERNMENTAL	M-0.1	ABBREVIATIONS, DRAWING INDEX, AND NOTES	
BOP	BOTTOM OF PIPE	MIN.	MINIMUM	AGENCIES HAVING JURISDICTION OVER THE PROJECT INCLUDING REQUIREMENTS OF THE SAN FRANCISCO PUBLIC UTILITIES COMMISION FOR "SAN FRANCISCO'S WATER EFFICIENT IRRIGATION	M-0.2	MECHANICAL LEGEND	
BFP CB	BACKFLOW PREVENTER CATCH BASIN	MIPT (N)	MALE IRON PIPE THREAD NEW	REQUIREMENTS".	M-0.3	EQUIPMENT SCHEDULE	
CCSF	CITY & COUNTY OF SAN FRANCISCO	N.C.	NORMALLY CLOSED	2. PROTECT EXISTING UTILITIES, IMPROVEMENTS, AND STRUCTURES WHETHER SHOWN ON THE DRAWINGS OR NOT, AND RESTORE TO NEW CONDITION AT NO ADDITIONAL COST TO THE CITY, IF DAMAGED	M-1.0	IRRIGATION WATER SUPPLY/STORAGE TANK SYSTEM — SITE PLAN	THE PROPERTY OF THE PROPERTY O
CL	CENTER LINE CAST IRON	NEC NIC	NATIONAL ELECTRICAL CODE NOT IN CONTRACT	DURING THE COURSE OF WORK.	M-1.1	SANITARY SEWER — SITE PLAN	DEPARTMENT OF PUBLIC WORKS CITY AND COUNTY OF SAN FRANCISCO
CO COTG	CLEANOUT CLEANOUT TO GRADE	N.O.	NORMALLY OPEN NUMBER	3. COORDINATE WORK TO PREVENT CONFLICTS BETWEEN TRADES AND REPORT CONFLICTS BETWEEN NEW IMPROVEMENTS AND EXISTING FACILITIES TO THE ENGINEER IMMEDIATELY.	M-2.0	MECHANICAL DETAILS 1 OF 3	30 Van Ness Avenue SUITE 4100 San Francisco, CA (415) 557-4700 94102-6028 Fax (415) 557-4701
CU	CUBIC	NO. NPT	NATIONAL PIPE THREAD	4. CLEAR AND REMOVE ORGANIC MATTER, DEBRIS, AND RUBBISH FROM WITHIN THE LIMIT OF WORK. SEE SPECIFICATIONS AND DEMOLITION NOTES FOR STOCKPILING AND DISPOSAL.	M-2.1	MECHANICAL DETAILS 2 OF 3	94102-6028 Fax (415) 557-4701
DCW	DOMESTIC COLD WATER DUCTILE IRON	NTS POC	NOT TO SCALE POINT OF CONNECTION	5. INSPECT THE SITE WITH THE ENGINEER AND MARK ALL IRRIGATION HEADS TO BE RELOCATED WITHIN	M-2.2	MECHANICAL DETAILS 3 OF 3	Project
DIA.	DIAMETER	PRV	PRESSURE REDUCING VALVE	THE AREA TO RECEIVE WORK. RELOCATE UNMARKED IRRIGATION HEADS ENCOUNTERED WITHIN THE AREA TO RECEIVE WORK DURING THE COURSE OF THE WORK AT NO EXPENSE TO THE CITY.			17th & FOLSOM STREET PARK
DIP DW	DUCTILE IRON PIPE DOMESTIC WATER	PSI PVC	POUNDS PER SQUARE INCH POLY-VINYLCHLORIDE (PIPE)	6. PROTECT EXISTING TREES AND VEGETATION WHICH ARE TO REMAIN. PREVENT FROM DAMAGE DUE TO CONSTRUCTION. REFER TO LANDSCAPE DWGS AND THE SPECIFICATIONS.			2080 FOLSOM STREET
DWG	DRAWING	QCV	QUICK COUPLING VALVE				SAN FRANCISCO, CA 94110
DPW (E)	DEPARTMENT OF PUBLIC WORKS EXISTING	R/C	REMOVE AS CONTRACTOR'S PROPERTY	DEMOLITION NOTES			Consultant
EL	ELEVATION	R/S RCV	REMOVE AND SALVAGE REMOTE CONTROL VALVE	1. DISPOSE OF NATIVE SOIL, ASPHALT PAVING, CONCRETE FOOTINGS, THRUST BLOCKS, DEBRIS AND RUBBISH AS THE CONTRACTOR'S OWN PROPERTY AND IN A LEGAL MANNER. SAW CUT EDGES AT			
ELL EQPT	ELBOW EQUIPMENT	REF.	REFERENCE	EXISTING PAVING: STRAIGHT, CLEAN AND TO A FULL DEPTH. REMOVE AND SALVAGE ALL QUICK COUPLERS, SPRINKLERS, REMOTE CONTROL VALVES, VALVE BOXES ON ALL LINES SHOWN TO BE			INFRASTRUCTURE
FAVT	FRESH AIR VENT TRAP	REQ'D RPBP	REQUIRED REDUCED PRESSURE BACKFLOW PREVENTER	REMOVED OR IN AREA OF (N) WORK. REMOVE RISER PIPE TO 12 INCHES BELOW EXISTING FINISHED GRADE FOR LINES CALLED OUT TO BE ABANDONED—IN—PLACE. DELIVER ALL ITEMS TO BE SALVAGED			DESIGN & CONSTRUCTION
F/I	FURNISH AND INSTALL	RPM	REVOLUTIONS PER MINUTE	TO THE SAN FRANCISCO RECREATION AND PARK DEPARTMENT OR AS DIRECTED BY THE ENGINEER.			DEPARTMENT OF PUBLIC WORKS CITY AND COUNTY OF SAN FRANCISCO
FIPT G.I.	FEMALE IRON PIPE THREAD GALVANIZED IRON	RW SCH	RECLAIMED WATER SCHEDULE	LAYOUT NOTES			30 Van Ness Avenue SUITE 5100 San Francisco, CA (415) 558-4000
GPM	GALLONS PER MINUTE	SD	STORM DRAIN	VERIFY DIMENSIONS IN THE FIELD PRIOR TO BEGINNING CONSTRUCTION AND REPORT AND DISCREPANCIES TO THE ENGINEER.			94102-6028 Fax (415) 558-4093
GS HP	GALVANIZED STEEL HORSEPOWER	SF SFRPD	SQUARE FOOT SAN FRANCISCO RECREATION AND PARK	2. WRITTEN DIMENSIONS SUPERCEDE SCALED DIMENSIONS PROCEEDING.			Issue
HR	HOUR		DEPARTMENT	3. MEASURE DIMENSIONS HORIZONTALLY.			100% BID SET
HT IN.	HEIGHT INCHES	SFWD SPECS	SAN FRANCISCO WATER DEPARTMENT SPECIFICATIONS	4. STAKE IRRIGATION SYSTEM AND PIPE ROUTING FOR REVIEW BY THE ENGINEER BEFORE PROCEEDING WITH TRENCHING.			07/15
IN/HR	INCHES/HOUR	STD	STANDARD TYPICAL	TROOLEDING WITH TRENGTING.			Approvals
INV IPS	INVERT IRON PIPE SIZE	TYP TOP	TOP OF PIPE	RESTORATION OF LANDSCAPE AREA			SECTION MANAGER 1 / 0 1/93/1) DRAWN MAC JULY 2015
IPT	IRON PIPE THREAD	VAC	VOLTS ALTERNATING CURRENT VITRIFIED CLAY PIPE	SEE NOTES ON LANDSCAPE DRAWINGS.			DESIGNED MANAGER 7/23/15 MAC JULY 2015
LBS. MAX.	POUNDS MAXIMUM	VCP YD	YARD	GRADING NOTES	6		Palk Den 1/29/15 MC JULY 2015
MCV	MASTER CONTROL VALVE (ASSEMBLY)			OTTABILITY TYOTES	·		
				1. VERIFY GRADES IN THE FIELD BEFORE PROCEEDING WITH WORK, INCLUDING EXISTING IMPROVEMENTS. EXISTING GRADES SHOWN ARE APPROXIMATE. FIELD VERIFY AND REPORT DISCREPANCIES TO THE ENGINEER IMMEDIATELY.			NO. DATE DESCRIPTION BY APPR'D
				2. PROVIDE SURFACE DRAINAGE IN PAVING AND PLANTING AREAS. FINISH GROUND SURFACES TO UNIFORM GRADE, DRAINING PROPERLY AND FREE OF STANDING WATER.			REVISIONS
				3. PROVIDE A SMOOTH TRANSITION BETWEEN EXISTING AND NEW GRADES IN PLANTING AREAS.			Stamp
				4. WHERE NEW PAVEMENT ABUTS EXISTING PAVEMENT, FINISH GRADES ARE FLUSH UNLESS OTHERWISE NOTED.			PROFESSIONAL DE CE CONTRACTOR DE CONTRACTOR
				5. EASE TOP AND TOE OF SLOPES TO PROVIDE SMOOTH TRANSITIONS BETWEEN GROUND PLANES.			SS MINISTER SERVICE SE
				6. THE ENGINEER RESERVES THE RIGHT TO MAKE ADJUSTMENTS IN THE FINISH GRADES AS THE WORK PROGRESSES.			No. M926610 07 23 15 男 Exp.9/30/2016
				7. ELEVATIONS ARE BASED ON CITY AND COUNTY OF SAN FRANCISCO DATUM, UNLESS OTHERWISE INDICATED.			OF CALIFORN
							Drawing Title
							ABBREVIATIONS, MECHANICAL
							DRAWING INDEX, AND NOTES
							Sheet No.
							IVI-U. I
							Scale Job No.
							3054V

	LEGEND			LEGEND	
SYMBOL	DESCRIPTION	DETAIL NO.	SYMBOL	DESCRIPTION	DETAIL NC
- 8	PRESSURE REGULATING REMOTE CONTROL VALVE AND VALVE BOX/MASTER REMOTE CONTROL VALVE AND VALVE BOX	4 L-6,1		LATERAL LINE PIPE (DOWNSTREAM OF REMOTE CONTROL VALVE):	
	COMBINATION AIR VALVE (1" FIPT) AND VALVE BOX	3 M−2.0		PVC SCHEDULE 40 PLASTIC PIPE WITH SCHEDULE 40 PVC SOLVENT WELD FITTINGS. COVER: 24 INCHES UNLESS OTHERWISE NOTED.	
₹	FLOW SENSOR			NOTE: PVC PLASTIC PIPE: PURPLE MOLDED PLASTIC PIPE AND FITTINGS — NO PAINTED/STAINED PURPLE PIPE.	
	TWO-PIECE QUICK COUPLING VALVE (1 INCH FIPT)	SEE LANDSCAPE	<u> </u>	SLEEVING: COVER TO BE AS INDICATED IN SPECIFICATIONS OR AS INDICATED ABOVE FOR PIPE DEPTH OF COVER. NO SLEEVING REQUIRED FOR DUCTILE IRON PIPE.	6 M−2.0
	TWO-PIECE QUICK COUPLING VALVE AND CONCRETE BLOCK	DWGS		(E) PIPING — MAINLINE AND LATERAL	
\bowtie	GATE VALVE (FIPT CONNECTIONS — 3 INCH AND SMALLER; PUSH—ON GASKETED OR FLANGED CONNECTIONS 4 INCH AND LARGER) AND VALVE BOX. VALVE SHALL BE LINE SIZE.	3 L-6.1	BFP	BACKFLOW PREVENTER	$\frac{7}{M-2.1}$, $\frac{9}{M-2.1}$
	PIPE REDUCER			BOOSTER PUMP	8 M-2.1
	MAIN LINE PIPE (UPSTREAM OF REMOTE CONTROL VALVE):			FRESH AIR VENT TRAP	$\frac{4}{M-2.0}$
	4 INCH DIA. AND LARGER: DUCTILE IRON PIPE WITH DUCTILE IRON PUSH-ON GASKETED OR FLANGED ENDS UNLESS DIRECTED BY THE ENGINEER. REFER TO PLAN DWGS AND SPECS FOR PIPE TYPE. MINIMUM COVER TO BE 30 INCHES.			CATCH BASIN	5 M-2.0
	3 INCH DIA. AND SMALLER (UPSTREAM OF REMOTE CONTROL VALVE):				
	GALVANIZED STEEL PIPE WITH THREADED (NPT) OR FLANGED ENDS AND FITTINGS OR COPPER TUBING AND FITTINGS. MINIMUM COVER TO BE 30 INCHES.				

BUILDING **DESIGN & CONSTRUCTION**



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Consultant

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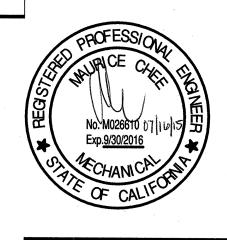
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MAC JULY 2015 DEPUTY DIVISION MANAGER

LLages . 7/20/15 CHECKED MC JULY 2015

REVISIONS



Drawing Title

MECHANICAL LEGEND

3054V

	IRRIGATION BOOSTER PUMP SCHEDULE										
	CAPACITY		CAPACITY MOTOR				INLET X DISCHARGE		REF. DWG		
SERVICE	FLOW GPM	HEAD FT. WATER	HP	VOLT	PHASE	ТҮРЕ	(IN)	MANUFACTURER AND MODEL NO.	#	REMARKS	
SUBSURFACE IRRIGATION	20	100	1	110	1	GROUND LEVEL BOOSTER PUMP	2 X 1-1/2	RAIN BIRD LC1000 OR APPROVED EQUAL	M-1.0	123	

- 1) PUMP START RELAY SHUTDOWN PROTECTION
- 2 NEMA 4X ENCLOSURE
- 3 SEE SPECIFICATION 32 82 13 IRRIGATION BOOSTER PUMP AND TANK PACKAGE FOR DETAILS

					VORTEX	FILTER SCHEDU	JLE		
EQPT TAG	SERVICE	HOUSING DIMENSIONS DIA, HT (IN)	PIPE	DISCHARGE PIPE DIA (IN)	DRAIN PIPE DIA (IN)	MANUFACTURER AND MODEL NO.	MAX FLOW RATE (GPM)	REMARKS	
VTX 1	FOUNTAIN DRAIN	12 ¾, 19	4	4	4	WISY WFF-100	66	123	

NOTES:

- 1) SHALL BE INSTALLED WITH MINIMUM STRAIGHT RUN OF 40" FROM THE INLET.
- 2 SHALL BE PROVIDED WITH 36" MIN CLEARANCE ABOVE FOR MAINTENANCE.
- 3 DRAIN INLET AND CLEAN WATER OUTLET SHALL TURN INTO THE REQUIRED DIRECTIONS TO MEET THE RELEVANT PIPES.

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Approvals

SECTION MANAGER

MAC JULY 2015

CHECKED

MC JULY 2015

NO. DATE

DESCRIPTION

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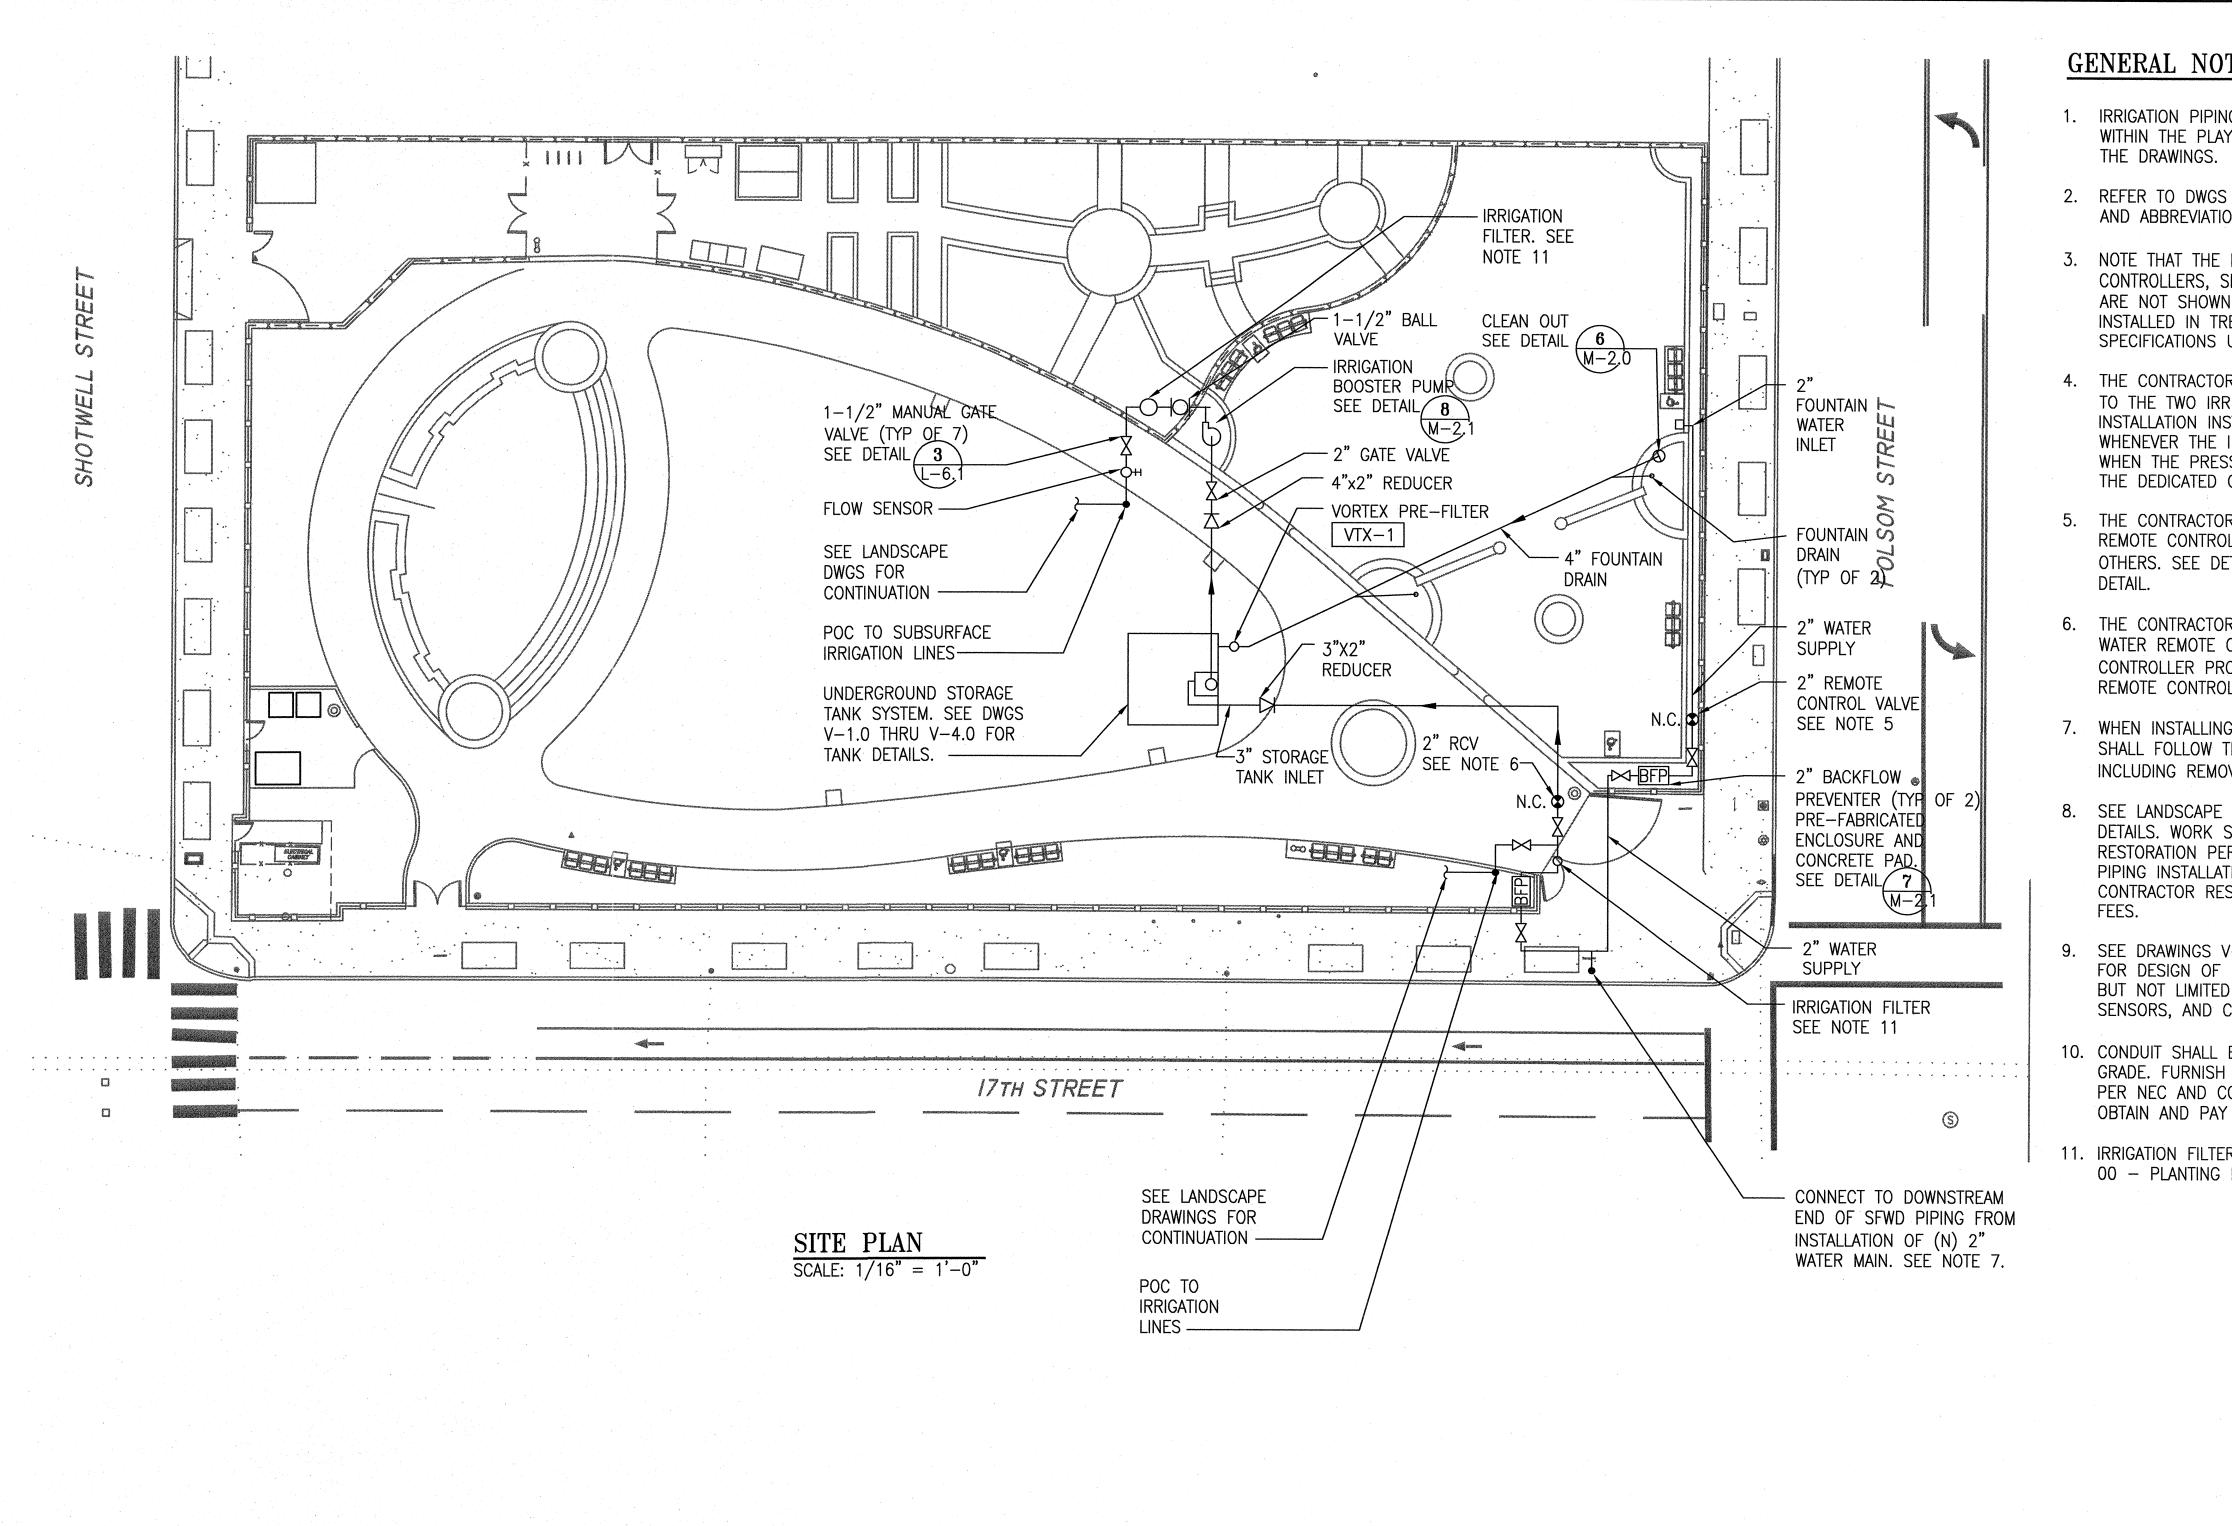
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EQUIPMENT SCHEDULE

Sheet No. M-O.

Job No.

3054V



GENERAL NOTES

- 1. IRRIGATION PIPING/CONDUITS/WIRING SHALL NOT BE INSTALLED WITHIN THE PLAYGROUND AREA UNLESS SHOWN SPECIFICALLY ON
- 2. REFER TO DWGS M-0.1 AND M-0.2 FOR GENERAL NOTES, LEGEND, AND ABBREVIATIONS.
- 3. NOTE THAT THE REQUIRED CONDUITS/WIRING BETWEEN CONTROLLERS, SENSORS, PUMP AND REMOTE CONTROL VALVES ARE NOT SHOWN ON THE DRAWINGS. CONDUITS SHALL BE INSTALLED IN TRENCHES WITH THE IRRIGATION PIPING AS PER THE SPECIFICATIONS UNLESS APPROVED BY THE ENGINEER.
- 4. THE CONTRACTOR SHALL CONNECT THE BOOSTER PUMP CONTROLS TO THE TWO IRRIGATION CONTROLLERS PER THE MANUFACTURER'S INSTALLATION INSTRUCTIONS FOR OPERATING THE BOOSTER PUMP WHENEVER THE IRRIGATION LATERAL STATION ARE IN SERVICE AND WHEN THE PRESSURE DROPS PER AN APPROVED SETPOINT, WHEN THE DEDICATED QC STATION ARE USED IN THE FIELD.
- 5. THE CONTRACTOR SHALL CONNECT THE FOUNTAIN SUPPLY WATER REMOTE CONTROL VALVE TO FOUNTAIN CONTROLLER PROVIDED BY OTHERS. SEE DETAIL 4/L-6.1 FOR REMOTE CONTROL VALVE
- 6. THE CONTRACTOR SHALL CONNECT THE STORAGE TANK SUPPLY WATER REMOTE CONTROL VALVE TO THE STORAGE TANK CONTROLLER PROVIDED BY OTHERS. SEE DETAIL 4/L-6.1 FOR REMOTE CONTROL VALVE DETAIL.
- 7. WHEN INSTALLING PIPE UNDER THE SIDEWALK, THE CONTRACTOR SHALL FOLLOW THE CCSF SFDPW REQUIREMENTS FOR TRENCHING INCLUDING REMOVAL/REPLACING ENTIRE SIDEWALK FLAGS.
- 8. SEE LANDSCAPE DRAWING L-6.0 FOR WATER MAIN LOCATION AND DETAILS. WORK SHALL INCLUDE PAVEMENT DEMOLITION AND RESTORATION PER CITY STANDARDS AS REQUIRED FOR METER AND PIPING INSTALLATION. REFER TO SPECIFICATIONS REGARDING CONTRACTOR RESPONSIBILITIES FOR WATER METER PERMITS AND
- 9. SEE DRAWINGS V-1.0 THRU V-4.0, PROVIDED BY MANUFACTURER, FOR DESIGN OF UNDERGROUND STORAGE TANK SYSTEM INCLUDING BUT NOT LIMITED TO MODULAR TANK, FILTER, SUMP PUMP, LEVEL SENSORS, AND CONTROLS.
- 10. CONDUIT SHALL BE INSTALLED A MINIMUM OF 30" BELOW FINISHED GRADE. FURNISH AND INSTALL PULL BOXES AND TRACER WIRES PER NEC AND CCSF ELECTRICAL CODES. THE CONTRACTOR SHALL OBTAIN AND PAY FOR ALL PERMIT COSTS.
- 11. IRRIGATION FILTER SHALL BE 120 MESH. SEE SPECIFICATION 32 84 00 - PLANTING IRRIGATION

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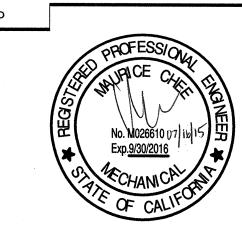
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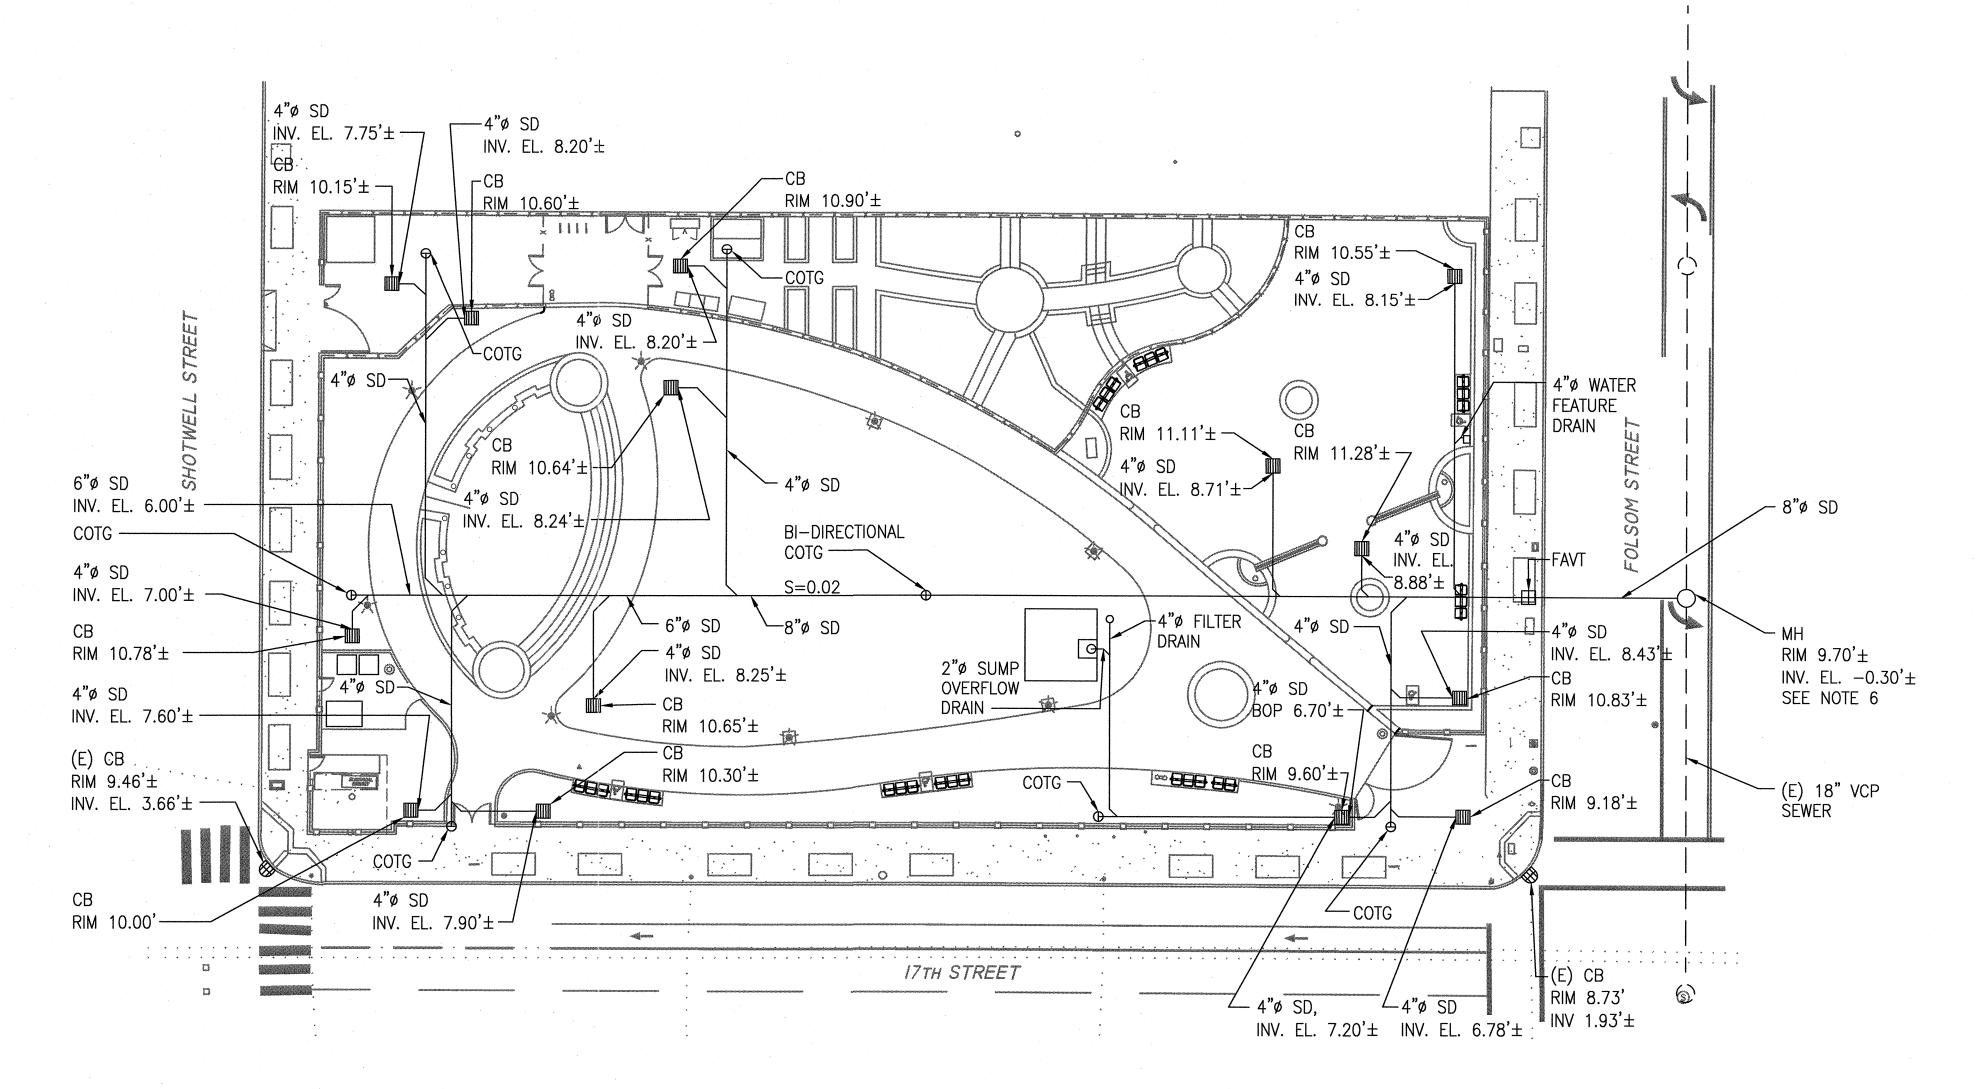
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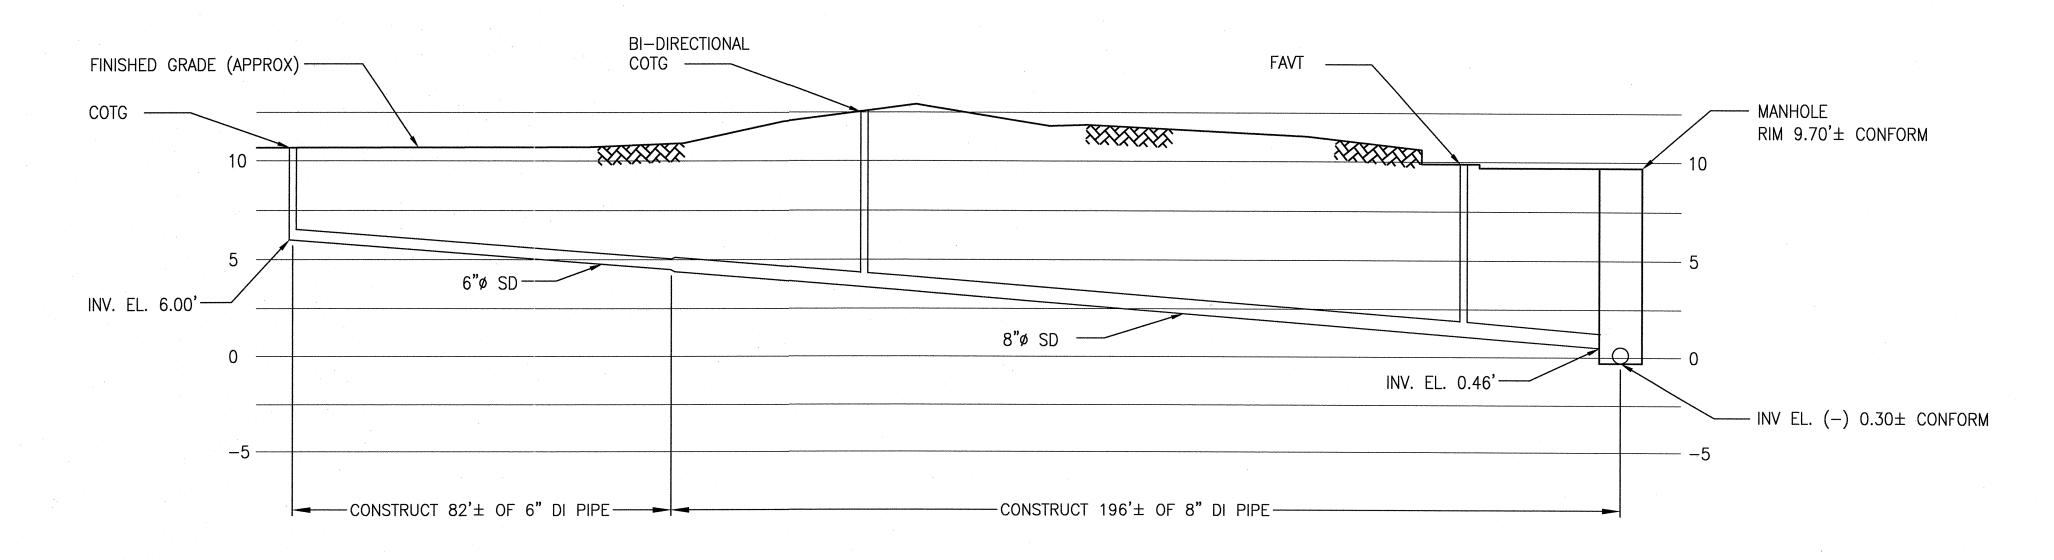
IRRIGATION WATER SUPPLY/ STORAGE TANK SYSTEM SITE PLAN

-M-1.0

3054V



NEW WORK PLAN - STORM DRAIN



PROFILE OF NEW STORM DRAIN LINE TO (N) MANHOLE SCALE: 1" = 20' X-AXIS, 1" = 5' Y-AXIS

GENERAL NOTES

- 1. ALL NEW PIPING WITHIN PROPERTY LINE SHALL HAVE A MINIMUM OF 2 FT COVER. BELOW NEW LAWN ELEVATION AND HAVE A MINIMUM SLOPE OF 2%. CONTRACTOR SHALL VERIFY DIMENSIONS IN FIELD PRIOR TO BEGINNING CONSTRUCTION AND REPORT ANY DISCREPANCIES TO THE ENGINEER.
- 2. LOCAL SEWER CLEANOUTS AT MAXIMUM OF EVERY 50-FEET, AT ALL CHANGES OF DIRECTIONS, AND AS REQUIRED BY THE SF PLUMBING CODE. CATCH BASINS QUALIFY AS CLEANOUTS. NOT ALL REQUIRED CLEANOUTS ARE SHOWN.
- 3. REFER TO LANDSCAPE PLAYGROUND DWGS IN THE CONTRACT PACKAGE AND VERIFY IN FIELD FOR EXACT LOCATION/ELEVATION OF CONNECTION POINT FOR DRAIN LINE. SLOPE DRAIN PIPE MINIMUM 1/8" PER FOOT FROM CONNECTION POINT TO NEAREST DOWNSTREAM WYE.
- 4. ALL NEW PIPING SHALL BE DUCTILE IRON PIPING.
- 5. ALL NEW PIPING AND EQUIPMENT SHALL BE NEW UNLESS INDICATED AS EXISTING.
- 6. NEW MANHOLE SHALL BE CONSTRUCTED PER DPW STANDARD DRAWING 87,181
- 7. ALL CATCH BASIN RIM ELEVATIONS SHALL CONFORM TO FINISH GRADE.

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DEPUTY DIVISION MANAGER

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DEPUTY DIVISION MANAGER

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MC JULY 2015

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JULY 2015

REVISIONS

No. M026610 07 29 15 Exp. 9/30/2016

Drawing Title

SANITARY SEWER SITE PLAN

Sheet No.

Job No.

3054V

S Y M B O L S CONDUIT AND WIRING AS NOTED. SHORT LINES INDICATE NUMBER OF #12 AWG CONDUCTORS. LONG LINE INDICATES #12 NEUTRAL WIRE, AWG, UON. • "INDICATES GROUND, #10 INDICATES WIRE SIZE. ALL CONDUIT SHALL BE CONCEALED IN CEILING, WALL OR SLAB WHEREVER POSSIBLE. MINIMUM 3/4"C FOR BUILDING HOMERUN TO ELECTRICAL PANELBOARD, A-1 CIRCUIT NUMBER IDENTIFIED FOR EACH ARROW. EXISTING UNDERGROUND CONDUIT GRS UNDERGROUND CONDUIT SHALL BE 1"C. UON. -////// R/C (E) CONDUIT WITH WIRING OR AS NOTED. INTERCEPT AND CUT EX CONDUIT. COUPLE NEW CONDUIT OF SAME SIZE TO EXISTING AND SPLICE AND MATCH NEW WIRES TO EXISTING WIRES. LED LIGHTING FIXTURE. WITH OUTSIDE LAMPS CONTROLLED BY SWITCH 'a' AND CENTER LAMP CONTROLLED BY SWITCH 'b'. 14' HIGH POST TOP PEDESTRIAN POLE WITH LED FIXTURE AND CONCRETE FOUNDATION POWER PEDESTAL WITH DUAL PG&E METER JUNCTION BOX WITH NEOPRENE GASKET TYPE 1 CONCRETE PULL BOX WITH BOLT DOWN COVER FOR SITE LIGHTING WORKS. PGE, PG&E PACIFIC GAS AND ELECTRIC COMPANY EXISTING PULL BOX EXISTING PG&E SERVICE PULL BOX REC/RCPT GROUND ROD-3/4" Ø X10'-0" DIGITAL LIGHTING CONTROLLER, REFER DLC SHEET NOTE "1" INDICATES NOTE. DETAIL REFERENCE, SEE DETAIL '1' ON PLAN WHM PG&E WATT HOUR METER LIGHTING FIXTURE TAG"A" INDICATES FIXTURE $\langle XX \rangle$ TYPE"XX" INDICATES FIXTURE WATTAGE DIMMING SWITCH. MOUNTING HEIGHT +42" AFF, 3-BUTTON LOW VOLTAGE DIMMER. MOUNTING HEIGHT +42" AFF, UON. WHILE IN USE RECEPTACLE, QUADPLEX 20A, 3PG, 125V, GFCI. +18" UON. SEE SPEC FOR PRODUCT SPECIFICATION. RECEPTACLE, QUADPLEX 20A, 3PG, 125V, GFCI, +18" UON. WEATHER PROOF, VANDAL AND CORROSION RESISTANT, LOCKABLE AND WHILE-IN-USE, STEEL COVER PER NEC REQUIREMENTS. COLE LIGHTING: TL310-WCS

ABBREVIATIONS GENERAL NOTES

AMPERE INTERRUPTING CAPACITY

AMERICAN WIRE GAGE

CBC CALIFORNIA BUILDING CODE

DLC DIGITAL LIGHTING CONTROLLER

FURNISH & INSTALL UNDER THIS CONTRACT

GROUND FAULT CIRCUIT INTERRUPTER

GALVANIZED RIGID STEEL (CONDUIT)

CONDUIT

CKT CIRCUIT

DWG DRAWING

ELECTRICAL

GROUND

JUNCTION BOX

KILO VOLT AMPERE

MAIN LUGS ONLY

MAIN SWITCHBOARD

NEC NATIONAL ELECTRICAL CODE

NATIONAL FIRE PROTECTION AGENCY

SPDPWSF STANDARD PLAN DEPARTMENT OF PUBLIC

UL UNDERWRITERS LABORATORIFS

XFMR TRANSFORMER (POWER DISTRIBUTION)

R/C REMOVE FROM SITE OF WORK AS CONTRACTOR'S

REMOVE AND SALVAGE AS CITY'S PROPERTY, RETURN

UON UNLESS OTHERWISE NOTED

WORKS CITY AND COUNTY OF SAN FRANCISCO

HZ HERTZ

(E)

ELECT

G, GND

MSBD

(N) NEW

PNL PANEL

PWR POWER

NTS NOT TO SCALE

RECEPTACLE

S/N SOLID NEUTRAL

SWBD SWITCHBOARD

TEL TELEPHONE

U/G UNDERGROUND

WP WEATHERPROOF

PROPERTY.

TO OWNER

TYP TYPICAL

V VOLTS

W/O WITHOUT

CONDUIT ONLY

BSCW BARE STRANDED COPPER WIRE

- 1. THESE PLANS ARE DIAGRAMMATIC AND ARE CORRECT ALTERNATING CURRENT FOR GENERAL DESIGN ONLY. EXACT LOCATIONS TO BE COORDINATED IN THE FIELD WITH ARCHITECTURAL AND MECHANICAL DRAWINGS TO AVOID AMERICANS WITH DISABILITIES ACT ANY CONFLICT. CONFLICT TO BE CORRECTED AT NO ADDITIONAL COST TO THE CITY. ABOVE FINISHED FLOOR
 - 2. ALL WIRING SHALL BE COPPER AND SHALL BE INSTALLED IN CONDUIT. CONDUIT SIZE SHALL BE ACCORDING TO CODE. MINIMUM CONDUIT SIZE IS 3/4". ALL CONDUITS AND JUNCTION BOXES SHALL BE CONCEALED IN FURRED SPACES, CONCRETE WALLS / FLOORS, OR ABOVE ACOUSTIC CEILING, U.O.N. ALL JUNCTION BOXES SHALL BE ACCESSIBLE.
 - 3. THIS IS A GENERAL LEGEND. NOT ALL SYMBOLS ARE USED.
 - 4. LIGHTING AND RECEPTACLE SYSTEM CONTRACTOR SHALL PROVIDE AND INSTALL ALL NECESSARY CONDUITS. FITTINGS. JUNCTION BOXES AND ALL NECESSARY COMPONENTS SHOWN OR NOT SHOWN ON THE DRAWINGS TO MAKE ELECTRICAL INSTALLATION COMPLETE AND OPERATIONAL TO MEET ALL CODES REQUIREMENTS.
 - 5. ALL OUTDOOR AND ANTICIPATED WET AREA SHALL HAVE GFCI OUTLETS. ALL OUTDOOR DEVICES SHALL HAVE WET WEATHERPROOF VANDAL RESISTANT METTALIC LOCKABLE COVERS WHILE IN USE.
 - 6. PROVIDE UL LISTED FIRE RATED SEALS FOR ALL CONDUIT AND RACEWAY PENETRATIONS THROUGH FIRE RATED WALLS AND FLOORS. SEALED AND MAINTAIN FIRE SEPARATION RATING.
 - 7. ALL PANEL CIRCUIT DIRECTORIES SHALL BE UPDATED IN ACCORDANCE WITH THE LATEST CIRCUITRY INCLUDING ACTUAL ROOM NUMBER WHERE LOAD IS LOCATED. DIRECTORIES SHALL BE TYPEWRITTEN.
 - 8. PROVIDE SEPARATE GROUND WIRE IN ALL CONDUITS.
 - 9. ALL ELECTRICAL EQUIPMENT, PANELBOARDS, CONTROL DEVICES. SHALL BE IDENTIFIED WITH ENGRAVED NAMEPLATES.
 - 10. CONTRACTOR SHALL LABEL EACH NEW ELECTRICAL OUTLET WITH PERMANENT FELT-TIP MARKER, SHOWING PANEL NUMBER AND CIRCUIT BREAKER NUMBER FEEDING THE CIRCUIT ON THE BACK OF COVER PLATE OF THE CONVENIENCE OUTLET AND LIGHT SWITCH.
 - 11. ALL WIRING INSIDE PULL BOXES SHALL BE TAGGED TO IDENTIFY THE CIRCUIT (BOTH PANEL AND CIRCUIT NO.) EACH BUNDLE OF WIRING RUNNING IN EACH CONDUIT SHALL BE TIE-WRAPPED SO THAT THEY REMAIN IN INDIVIDUAL GROUPINGS.
 - 12. ALL EXPOSED CONDUIT SHALL RUN AS HIGH AS POSSIBLE AND AVOID INTERFERENCE AND EQUIPMENT FRAME STRUCTURE. CEILING INSERTS AND MECHANICAL DUCT WORK.
 - 13. ALL PENETRATION THROUGH CONCRETE WALL SHALL BE CORE DRILLED AND GROUTED AROUND CONDUIT AFTER CONDUIT INSTALLATION. USE RIGID STEEL CONDUIT ONLY.
 - 14. ALL ELECTRICAL EQUIPMENT, ELECTRICAL SUPPORTS, CONDUIT AND FITTINGS, AND LIGHTING FIXUTRES SHALL BE BRACED ACCORDING TO SMACNA DETAILS, AND PER IBC/CBC SEISMIC MOUNTING REQUIREMENTS AND PER CALIFORNIA TITLE 24 AND LOCAL JURISDICTION. PROVIDE ALL AT NO ADDITIONAL COST TO THE CITY.
 - 15. THERE SHALL BE NO MORE THAN THREE CIRCUIT HOME RUNS IN EACH CONDUIT. U.O.N.
 - 16. PAINT ALL BLANK COVER PLATES AND EXPOSED CONDUIT TO MATCH WALL OR CEILING.
 - 17. THERE SHALL BE NO MORE THAN 270° CONDUIT TURN IN EACH CONDUIT RUN.
 - 18. ALL ELECTRICAL DEVICES SHALL BE UL LISTED WHERE APPLICABLE.
 - 19. INSTALL A NYLON PULLING ROPE AND END PLUGS WITH PULL TAB IN ALL EMPTY CONDUITS.
 - 20. PRIOR TO SUBMISSION OF BID, VISIT THE SITE AND BECOME FAMILIAR WITH ALL EXISTING CONDITIONS. NO EXTRA COST WILL BE ALLOWED FOR WORK RESULTING FROM LACK OF PROPER APPRAISAL OF EXISTING CONDITIONS.
 - 21. WHERE EXISTING CONDUIT IS TO BE ABANDONED, THE CONDUIT SHALL BE REMOVED IF IT IS EXPOSED. WHERE IT IS IMPOSSIBLE TO REMOVE THE CONDUIT, IT SHALL BE CUT BELOW 3" FROM FLOOR/WALL OR CEILING AND CAPPED OR PLUGGED.
 - 22. EXAMINE ARCHITECTURAL, STRUCTURAL AND MECHANICAL DRAWINGS AND SPECIFICATIONS TO DETERMINE ANY CONFLICT AND THE SEQUENCE OF CONSTRUCTION THROUGH OUT THE PROJECT, INCLUDING EXISTING, TEMPORARY REMODELED AND NEW AREAS, WHERE APPLICABLE.
 - 23. GROUT AROUND CONDUIT TIE-INS. WHERE CONDUIT ENTERS BUILDINGS. SEAL OPENINGS WITH APPROVED DUCT SEAL TO PREVENT CIRCULATION OF AIR OR MOISTURE.

- 24. USE SPLIT BOLT CONNECTORS FOR COPPER CONDUCTOR SPLICES AND TAPS, 6 AWG AND LARGER, TAPE UNINSULATED CONDUCTORS AND CONNECTOR WITH ELECTRICAL TAPE TO 150 PERCENT OF INSULATION RATING OF CONDUCTOR SPLIT BOLT TYPE SPLICING DEVICES (i.e.KEARNIES) SHALL BE COPPER PER DPW STANDARD PLAN APRIL 2007 DWG. NO. 87,204.
- 25. PULL BOXES NOT IN CONCRETE OR PAVED AREA. CONTRACTOR TO PROVIDE 4" OF CONCRETE AROUND THE BOX FOR MAINTENANCE. PROVIDE AT LEAST 8" BEDROCK OF DRAINAGE GRAVEL AND CONDUIT SHALL EXTEND AT LEAST 6" ABOVE THE BEDROCK.
- 26. EMT FITTINGS SHALL BE STEEL SET SCREW WHEN INDOOR, COMPRESSION FITTING WHEN OUTDOOR.
- 27. CONDUTLET SHALL BE WITH CLIP COVERS, CROUSE-HIND FORM 7 OR APPLETON.
- 28. EXPOSED CONDUIT SHALL BE STRAP NOT EXCEEDING 5 FEET INTERVAL.
- 29. NO METAL CLAD CABLE SHALL BE USED.
- 30. ALL LIGHTING FIXTURE SHALL BE UL LISTED.
- 31. ALL PULLBOXES SHALL HAVE BOLT DOWN GALVANIZED STEEL SLIP RESISTANT COVERS.
- 32. ALL WORK DONE BY DESIGN-BUILT CONTRACTOR TO BE SIGNED AND STAMPED BY AN APPROVED CA. LICENSE ENGINEER.

DEMOLITION NOTES

- 1. CONTRACTOR SHALL COORDINATE WITH UTILITY COMPANIES (i.e. PG&E, SBC, DPT, etc) FOR ALL EXISTING OVERHEAD/UNDERGROUND UTILITIES THAT NEED TO BE DISCONNECTED. REMOVED, REROUTED AND RECONNECTED.
- 2. THE CONTRACTOR SHALL EMPLOY QUALIFIED AND EXPERIENCED WORKMEN FOR THIS WORK. ALL RESTORATION WORK SHALL BE SUBJECT TO THE APPROVAL OF THE ARCHITECT AND/OR THE OWNER.
- 3. ALL TEMPORARY AND REMODELED WORK SHALL BE CONSIDERED AS PART OF THIS CONTRACT AND NO EXTRA CHARGES WILL BE ALLOWED. THIS SHALL INCLUDE MINOR ITEMS OF MATERIAL OR EQUIPMENT NECESSARY TO MEET THE REQUIREMENTS AND INTENT OF THE PROJECT.
- 4. ALL ELECTRICAL CONNECTIONS REQUIRING AN OUTAGE SHALL BE MADE DURING AN APPROVED TIME LIMIT. CHANGEOVERS SHALL BE AS SHORT A DURATION AS POSSIBLE AND SHALL NOT INTERFERE WITH NORMAL OPERATION OF THE OWNER'S FACILITIES. NOTICE SHALL BE REQUIRED IN ADVANCE OF A SHUTDOWN OF ANY ELECTRICAL CIRCUIT FOR CHANGEOVER AND SUCH A CHANGEOVER SHALL BE DONE DURING HOURS AS DIRECTED BY THE OWNER. WORK SHALL BE SCHEDULED SO THAT AT NO TIME WILL ANY EMERGENCY FEEDER, CIRCUIT OR FIRE ALARM ZONE BE OUT OF SERVICE. PROVIDE NECESSARY TEMPORARY FEEDERS TO ACCOMPLISH THIS REQUIREMENT.
- 5. TEST ALL SYSTEMS AFFECTED BY THIS PROJECT WHEN COMPLETED TO ASSURE ALL NEW AND EXISTING DEVICES ARE IN OPERABLE CONDITION.
- 6. ALL DEVICES BROKEN DURING DEMOLITION MUST BE REPLACED TO MATCH WITH THE EXISTING DEVICES.
- 7. CONTRACTOR SHALL REFER TO LANDSCAPE DRAWINGS FOR ALL DEMOLITION WORK. REINSTALL ALL EXISTING ELECTRICAL DEVICES, EQUIPMENTS AND FIXTURES AFFECTED BY THESE UPGRADE TO COMPLY WITH CALIFORNIA SEISMIC BRACING.
- 8. CONTRACTOR TO COORDINATE WITH ENGINEER TO PROVIDE AN ALTERNATE FEASIBLE SOLUTION FOR REVIEW WHEN ENCOUNTERING AN EXISTING CIRCUIT THAT IS TO REMAIN AND RECONNECTED DURING DEMOLITION.

DESIGN BUILT CONTRACTOR FOR PARKING LOT AND PAY STATION SYSTEM SHALL COORDINATE WITH CONTRACTOR, MANUFACTURER AND VENDOR FOR THEIR SPECIFIC DESIGN AND INSTALLATION PRIOR TO CONSTRUCTION.

LOW VOLTAGE CONTRACTOR FOR VORTEX SYSTEM, IRRIGATION CONTROLLER SYSTEM. BOOSTER PUMP SYSTEM AND PUMP START RELAY SHALL COORDINATE AMONG VENDORS TO PROVIDE SPECIFIC DESIGN REQUIREMENTS PRIOR TO INSTALLATION.

BUILDING **DESIGN & CONSTRUCTION**



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Approvals

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ELECTRICAL LEGEND, ABBREVIATIONS, AND GENERAL NOTES

Sheet No.

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Job No. 3054V


MAX. SQUARE HANDHOLE

ANCHOR PLATE DETAIL


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LIGHTING FIXTURE SCHEDULES

TAG	DESCRIPTION	MANUFACTURER	LAMPS	VOLT	MOUNTING
A 117	FIXTURE: 14' HIGH 117W LED POST TOP FIXTURE WITH PHOTOCELL, FIBER GLASS TOP SHADE, INJECTION MOLDED CLEAR POLYCARBONATE HOUSING, ANTI—GLARE RING, HEAT SINK, 0—10V DIMMABLE DRIVER, 120—277V INPUT, INLINE FUSE, GRAPHITE GRAY COLOR UON WITH ANTI—GRAFFITI COATING, IP66. POLE: 14 FEET HOT DIP GALVANIZED ROUND STRAIGHT STEEL WITH CAST IRON BASE, HAND HOLE, ANCHOR BASE AND BOLTS, RAL FINISH COLOR TO MATCH THE FIXTURE FINISH COLOR WITH ANTI—GRAFFITI COATING. PROVIDE DISSIMILAR METAL CORROSION PROTECTION.	FIXTURE: LOUIS POULSEN: ALBERTSLUND MAXI POST LED CAT# ALB-MAX-PT-117WLED-4000K-120-277V-GRAPHITE GRAY-T-GRAPHITE GRAY-4.5-DM, UON, POLE: NAFCO INTERNATIONAL: ROUND STRAIGHT STEEL LIGHT POLE CAT# RSS14-4545C-GV-GRAPHITE GRAY-4.5"-14', UON, SEE LANDSCAPE AND STRUCTURE DRAWINGS FOR FOOTING DETAIL.	1-117W LED 4000°K	MULTI TAP VOLT	POLE
B 35	5"W X 5"D X 4'L WALL/CELING MOUNTED 35W, 4000K LED LUMINAIRE WITH STEEL HOUSING, WRAP AROUND ACRYLIC PRISMATIC LENS, POLYESTER POWDER FINISH, SUPER SAVER AND 0-10V DIMMING DRIVER, 120-277V INPUT, FINISH COLOR PER ARCHITECT, WIRE GUARD, UL LISTED FOR DAMP LOCATION.	LSI INDUSTRIES CROSSOVER CAT # W442-LED-SS-NW-UE-DIM- WIRE GUARD OR APPROVED EQUAL	35W LED	MULTI TAP VOLT	WALL/ CEILING



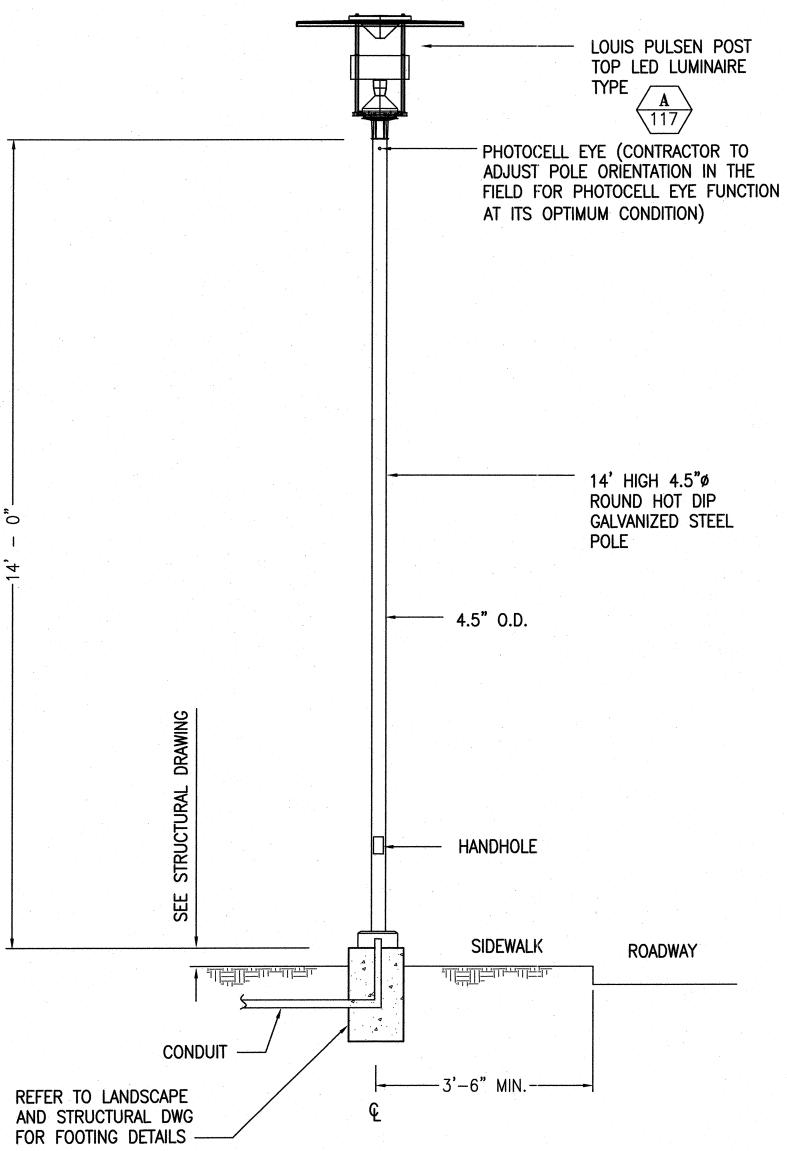

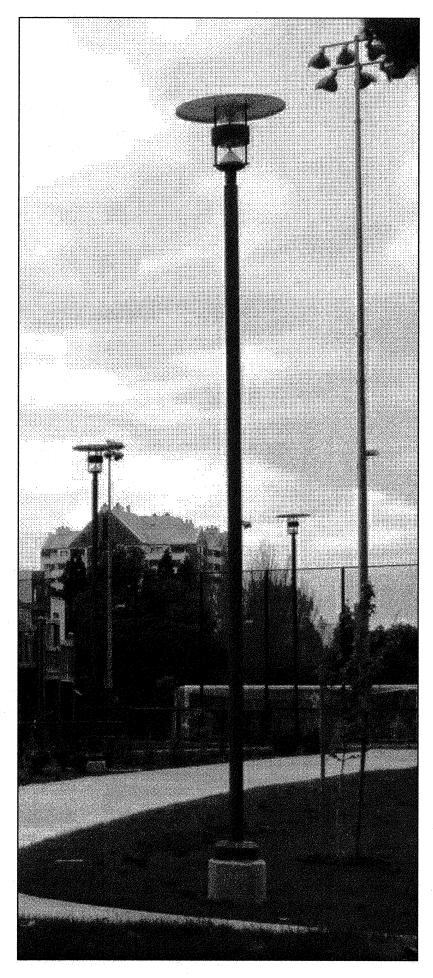

SAMPLE	РНОТО	\bigcirc 3
SCALE NONE		_

DIGITAL LIGHTING CONTROLLER PANEL (GREEN MAX): DLC	LOCATION: POWER PEDESTAL MOUNTING: SURFACE FEED FROM PANEL "A"	S	IEMA 1 ENC SIZE: 21" H OLTAGE: 12	, 22"W, 4"D
CHANNEL #	CIRCUIT #	CIRCUIT LOAD	(VA)	LOAD DESCRIPTION
a (DIMMING RELAY)	A-3	468		SITE LIGHT (FRONT LAWN)
b (DIMMING RELAY)	A-5	468		SITE LIGHT (STAGE)
c (DIMMING RELAY)	A-3	117		SITE LIGHT (ENTRANCE)
d (DIMMING RELAY)	SPARE	-		
e (DIMMING RELAY)	SPARE			
f (SWITCHING RELAY)	SPARE		**************************************	
g (SWITCHING RELAY)	SPARE		en e	
h (SWITCHING RELAY)	SPARE			
	TOTAL LOAD	1053 VA	······································	

DIGITAL LIGHTING CONTROLLER "DLC" 4



BUILDING DESIGN & CONSTRUCTION



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CITY AND COUNTY OF SAN FRANCISCO

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Approvalo

SECTION MANAGER

7/19/15

DEPUTY DIVISION MANAGER

DESIGNED

THEORED


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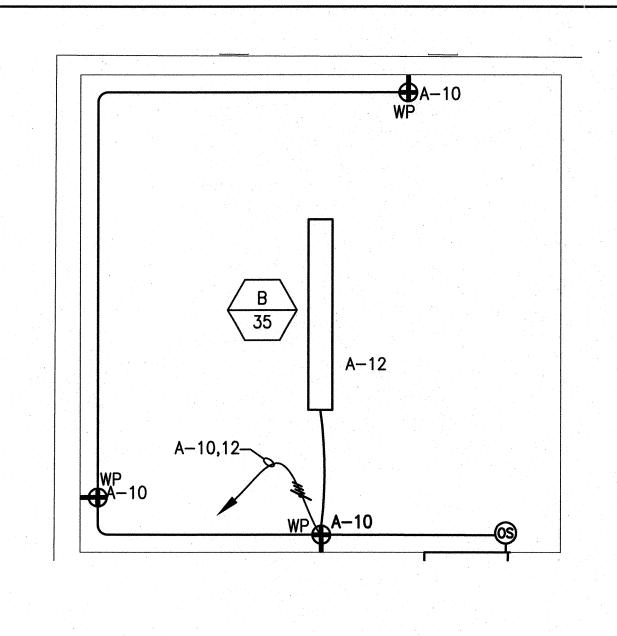
LIGHTING DETAILS AND FIXTURE SCHEDULE

Sheet No.


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(E) PARKING LOT AND CONTROLLER ON PG&E POLE TO BE REMOVED


SCALE: NTS

ENLARGED STORAGE ROOM PLAN 2

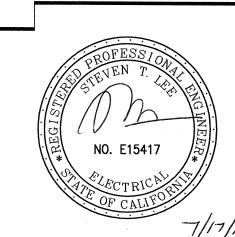SCALE: 1*=2'-0*

山(E) KIOSK &

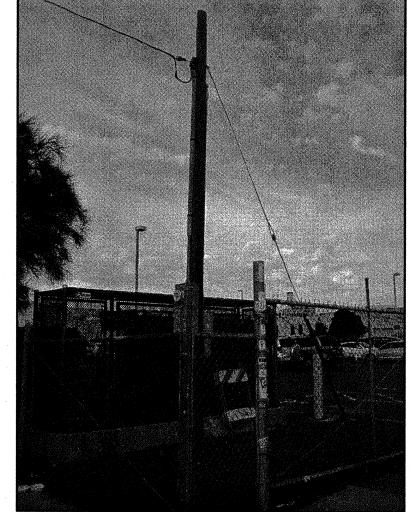EXISTING SFPUC PUMP STATION 3

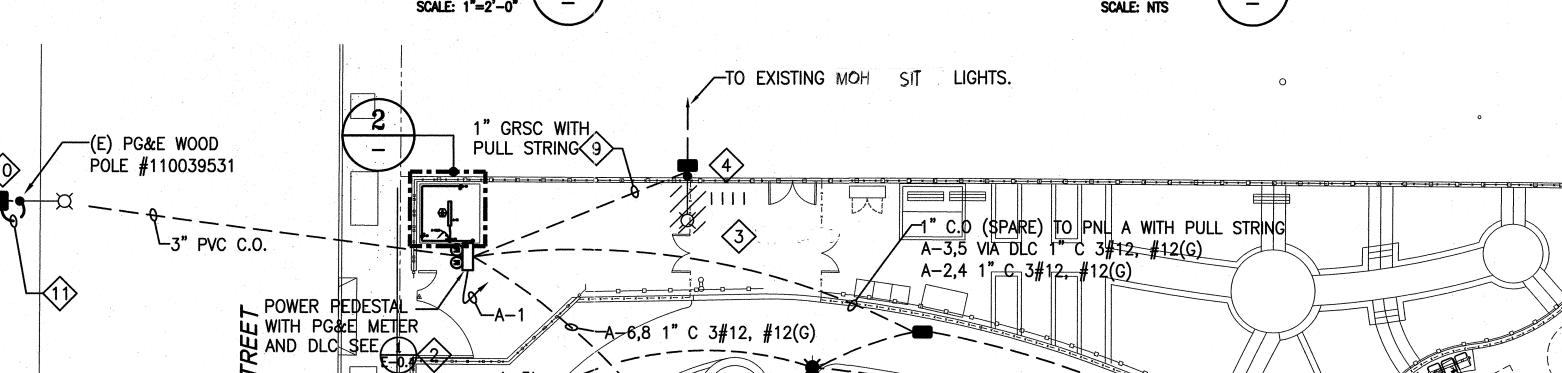

A-5b
A-6
A-30

A-5b


A-8

TYP OF 9

(E) PG&E POLE METER AND
ASSOCIATED EQUIPMENT AND
TIME CLOCK TO BE REMOVED.

(E) PG&E METER #21P590 IN (E) SFPUC PUMP STATION TO REMAIN.

ELECTRICAL SITE PLAN

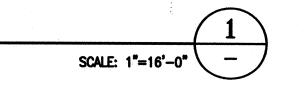

17TH STREET

00

SHEET NOTES

- CONTRACTOR TO COORDINATE EXACT LOCATION WITH LANDSCAPE ARCHITECT.
- CONTRACTOR TO COORDINATE WITH PG&E FOR CONDUIT ROUTING AND SERVICE CONNECTIONS: TEN WORKING DAYS IN ADVANCE.
- R/C LIGHTS (INCLUDING POLE AND FOUNDATION) LOCATED WITHIN PROJECT AREA AND ASSOCIATE CONDUITS AND WIRES BACK TO SOURCE; AND RECONNECT MOH SITE CIRCUITS TO NEW PANEL B. CONTRACTOR SHALL FIELD INVESTIGATE THE EXISTING CONNECTIONS. REMOVE AND RECONNECT FIXTURES CIRCUITS AND CONTROLS TO THE NEW PANEL "B" AND NEW DIGITAL ASTRONOMICAL MOH SITE, CONTROL AND OVERRIDE SWITCHES. REFER TO LANDSCAPE DRAWING FOR NUMBER OF FIXTURES TO BE REMOVED. PROVIDE TEMPORARY LIGHTING AS REQUIRED.
- PULL BOX LOCATION IS TENTATIVE.

 TO FIELD VERIFY EXISTING CONDUIT TO INTERCEPT WITH NEW CONDUIT AND PULL BOX.
- CONTRACTOR TO FIELD VERIFY AND MAINTAIN ALL EXISTING SFPUC CIRCUITS TO REMAIN. RESTORE FOR A COMPLETE OPERATIONAL SYSTEM IF DAMAGED BY CONTRACTOR AT NO COST TO THE CITY.
- CONTRACTOR TO FIELD VERIFY AND COORDINATE WITH PG&E AND OWNER VIA RESIDENT ENGINEER FOR REMOVAL OF PG&E POLE AND METER, INCLUDING BUT NOT LIMITED TO INTERMATIC TIME CLOCK AND ALL ASSOCIATED EQUIPMENT TO A NEW AGREED UPON LOCATION.
- SEE LANDSCAPE DWG FOR DEMOLITION WORK, ALL COST .
 ASSOCIATED WITH DEMOLITION WORK SHALL BE CONSIDERED INCIDENTAL.
- 8 NOT USED.
- SIZE PER NEC CODE.
- (10) COORDINATE WITH PG&E FOR PG&E PULL BOX.
- CONDUIT RISER PER PG&E REQUIREMENT, COORDINATE WITH PG&E FOR CONDUIT ROUTING AND SKETCH PRIOR TO INSTALLATION.
- RECESSED MOUNTED EXTERIOR WHILE—IN—USE RECEPTACLE. SEE LANDSCAPE DRAWING FOR MOUNTING DETAIL.

 MANUFACTURE: COLE LIGHTING

 CAT#: TL310—WCS

16 0 16 32 1"=16'-0" BUILDING DESIGN & CONSTRUCTION



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Issue

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Approvals 07/15

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ELECTRICAL SITE PLAN

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