A. GENERAL

# 1. THE CONTRACT DOCUMENTS INCLUDE THESE DRAWINGS AND THE

SPECIFICATIONS. 2. THE INTENT OF THESE DRAWINGS AND SPECIFICATIONS IS THAT THE NEW WORK IS TO BE IN ACCORDANCE WITH TITLE 24, CALIFORNIA CODE OF REGULATIONS. NOTHING IN THE CONTRACT DOCUMENTS IS TO BE CONSTRUED TO PERMIT WORK NOT CONFORMING TO THESE CODES. WHERE CONFLICT OCCURS, THE DIRECTIVES SHALL GOVERN, EXCEPT WHERE SUPERIOR WORK IS SPECIFIED OR INDICATED. SUCH CONFLICTS SHALL BE BROUGHT TO THE CITY REPRESENTATIVE'S ATTENTION FOR CLARIFICATION, PRIOR TO PROCEEDING WITH THE WORK. SHOULD ANY EXISTING CONDITIONS SUCH AS DETERIORATION OR NON-COMPLYING CONSTRUCTION BE DISCOVERED WHICH IS NOT COVERED BY THE CONTRACT DOCUMENTS WHEREIN THE FINISHED WORK WILL NOT COMPLY WITH TITLE 24, CALIFORNIA CODE OF REGULATIONS, NOTIFY THE ARCHITECT TO RECEIVE

3. USE OF ANY MATERIAL CONTAINING ASBESTOS IS PROHIBITED. 4. EXISTING CONSTRUCTION MAY CONTAIN HAZARDOUS MATERIALS. REVIEW THE OWNER'S HAZARDOUS MATERIALS REPORT FOR INFORMATION. REMOVE ANY

HAZARDOUS MATERIALS PRIOR TO COMMENCING WORK. 5. CONTRACTOR SHALL VISIT THE SITE PRIOR TO SUBMISSION OF BIDS TO REVIEW EXISTING CONDITIONS OF AREA OF THE WORK

AT ALL TIMES, THE CONTRACTOR SHALL BE SOLELY AND COMPLETELY RESPONSIBLE FOR THE CONDITIONS OF THE JOB SITE, INCLUDING SAFETY OF ALL PERSONS AND PROPERTY. THE ARCHITECT'S JOBSITE REVIEW IS NOT INTENDED TO CONSTRUCTION CLEAN AND FREE OF ALL SOIL, DEBRIS, TRASH, ETC., ON A DAILY INCLUDE REVIEW OF THE ADEQUACY OF THE CONTRACTOR'S SAFETY MEASURES. 7. MEANS AND METHODS: CONTRACTOR IS RESPONSIBLE FOR THE MEANS AND METHODS OF CONSTRUCTION. CONTRACTOR SHALL SELECT AND USE TOOLS, SCAFFOLDING, SHORING, EQUIPMENT AND LABOR AND METHODS THAT ARE APPROPRIATE AND ADEQUATE TO COMPLETE THE WORK. CONTRACTOR SHALL BE RESPONSIBLE FOR SEQUENCING THE WORK.

8. PERFORM ALL WORK IN AN ORDERLY MANNER WITHOUT DAMAGE TO OTHER PARTS OF THE BUILDING OR ADJACENT PROPERTIES. PROTECT ANY ADJACENT COMPLETED WORK OR PARTS OF THE BUILDING TO REMAIN WITH MEANS AVAILABLE TO CONTRACTOR INCLUDING BUT NOT LIMITED TO: BARRICADES, PROTECTION BOARDS, DROPCLOTHS, OR TEMPORARY REMOVAL FOR REINSTALLATION, IF PERMITTED BY THE CITY, ANY RESULTING DAMAGE OR LOSS SHALL BE REPAIRED OF CORRECTED BY THE CONTRACTOR AT NO EXPENSE TO THE OWNER. 9. THE CONTRACTOR SHALL BARRICADE THE WORK AREA TO PREVENT ACCESS BY UNAUTHORIZED PERSONS.

## **B. DOCUMENTS**

1. THE INTENT OF THESE DRAWINGS AND SPECIFICATIONS IS TO DESCRIBE LABOR, MATERIALS, EQUIPMENT, AND SERVICES NECESSARY FOR WORK UNDER THIS CONTRACT. INCLUDE ALL WORK SHOWN, PRESCRIBED, OR REASONABLY IMPLIED BY THE CONTRACT DOCUMENTS. WHERE WORK OR EQUIPMENT IS INDICATED "NOT IN CONTRACT", SUCH WORK AND/OR EQUIPMENT SHALL BE PROVIDED BY OTHERS. CONTRACTOR SHALL COORDINATE AND COOPERATE TO EFFECT SUCH

2. THE CONTRACT DOCUMENTS, INCLUDING THE SPECIFICATIONS AND PLANS AND DRAWINGS, ARE COMPLIMENTARY AND WHAT IS CALLED FOR BY ANY ONE SHALL BE AS BINDING AS IF CALLED FOR BY ALL. SUBSEQUENT ADDENDA, INTERPRETATIONS, OR CHANGE ORDERS SHALL GOVERN OVER THE ORIGINAL DOCUMENTS, UNLESS A DIFFERENT ORDER OF PRECEDENCE IS NOTED ELSEWHERE IN CONJUNCTION WITH A

SPECIFIC PORTION OF THE DOCUMENTS. 3. THE DRAWINGS ARE DIAGRAMMATIC IN NATURE. ELEMENTS WITHIN THE DRAWINGS ARE DESCRIBED USING ABSTRACT GRAPHIC SYMBOLS AND CONVENTIONS, WHICH REPRESENT BUILDING ELEMENTS.

4. ALL ITEMS INDICATED ARE NEW WORK UNLESS NOTED AS EXISTING OR (E). 5. THESE GENERAL NOTES APPLY TO THE ENTIRE WORK OF THIS CONTRACT 6. WITHIN THE DRAWINGS, OTHER GENERAL NOTES OCCUR WHICH DESCRIBE SPECIFIC TYPES OF WORK OR PROCEDURES, SUCH AS "DEMOLITON GENERAL NOTES". THESE NOTES APPLY TO ALL SIMILAR TYPES OF WORK OR PROCEDURES WITHIN THE ENTIRE CONTRACT.

7. SHEET NOTES APPLY TO THE DRAWING SHEET ON WHICH THEY OCCUR. KEYNOTES REFER TO SPECIFIC ITEMS ON THE DRAWINGS, AND A KEYNOTE NUMBER ON ONE SHEET SHALL HAVE THE SAME MEANING ON EVERY SHEET. 8. ALL REQUESTS FOR CLARIFICATIONS OF THESE DRAWINGS SHALL BE DIRECTED TO THE CITY REPRESENTATIVE. REVIEW THE DOCUMENTS IN ADVANCE OF SCHEDULING THE WORK, AND MAKE REQUESTS FOR CLARIFICATION SUFFICIENTLY

IN ADVANCE TO AVOID DELAY. 9. DO NOT SCALE DRAWINGS

NO. DATE

10. CONTRACTOR SHALL FIELD VERIFY ALL DIMENSIONS PRIOR TO DEMOLITION, FABRICATION, ASSEMBLY, OR INSTALLATION OF ANY WORK.

11. ITEMS INDICATED TO BE VERIFIED OR FIELD VERIFIED ARE REQUIRED TO BE VERIFIED PRIOR TO ORDERING MATERIALS OR PROCEEDING WITH THE WORK. ITEMS SHALL BE VERIFIED FOR DESIGN INTENT AND COMPATIBILITY WITH APPROPRIATE BUILDING CODES.

12. NOT IN USE. 13. VERIFY ALL EXISTING CONDITIONS AND PROPOSED DIMENSIONS AT JOB SITE. EXISTING DIMENSIONS GIVEN ARE TAKEN FROM INFORMATION PROVIDED BY THE OWNER'S SURVEY. REVIEW ALL DRAWINGS AND DIMENSIONS BEFORE COMMENCING CONSTRUCTION MATERIAL AND AFFECTED CONSTRUCTION IN EXISTING OCCUPIED WORK AND NOTIFY CITY REPRESENTATIVE OF ANY DISCREPANCIES. DO NOT PROCEED WITH WORK UNTIL DISCREPANCIES ARE RESOLVED.

14. WHERE ON ANY DRAWING A PORTION OF THE WORK IS DRAWN OUT AND THE REMAINDER IS INDICATED IN OUTLINE, THE DRAWN-OUT PARTS SHALL APPLY TO ALL 11. ALL FIRE ALARM INITIATING DEVICES (ALARM BOXES) TO BE MOUNTED PER T-24 OTHER LIKE PORTIONS OF THE WORK. WHERE ORNAMENT OR OTHER DETAIL IS INDICATED AS STARTING, SUCH DETAIL SHALL BE CONTINUED THROUGHOUT THE COURSES OR PARTS IN WHICH IT OCCURS AND SHALL ALSO APPLY TO OTHER

SIMILAR PARTS IN THE WORK, UNLESS OTHERWISE INDICATED. 15. IN CASE OF CONFLICT BETWEEN THE DOCUMENTS, THE DOCUMENT CONTAINING ADDITIONAL QUANTITIES SHALL GOVERN IN MATTERS OF QUANTITY, AND THE DOCUMENT REQUIRING A HIGHER DEGREE OF QUALITY SHALL GOVERN IN MATTERS 14. PROVIDE ONE CIRCUIT FOR ANY NEW EXIT SIGNS TO CONFORM TO CBC OF QUALITY. IN CASE OF CONFLICT WITHIN THE DRAWINGS INVOLVING QUANTITIES SECTION 1003.2.8.4. AND 1003.2.8.5. OR WITHIN THE SPECIFICATIONS INVOLVING QUALITY, THE GREATER QUANTITY AND 15. ALL CEILING AND MECHANICAL EQUIPMENT PLENUMS THAT ARE NEW OR TO THE HIGHER QUALITY SHALL BE FURNISHED. THE CONTRACTOR SHALL NOTIFY THE RECEIVE NEW WORK SHALL BE CLEAN AND FREE OF DEBRIS PRIOR TO CLOSING IN ARCHITECT OF ALL SUCH QUANTITY AND QUALITY CONFLICTS AND SHALL AGREE UPON RESOLUTION, IN WRITING, PRIOR TO PROCEEDING.

16. STRUCTURAL DRAWINGS GOVERN FOR SPACING AND SIZING FOR ALL STRUCTURAL MEMBERS, REINFORCING AND INSTALLATION DETAILS. VERIFY ANY CONFLICT BETWEEN STRUCTURAL AND OTHER DOCUMENTS WITH THE ARCHITECT PRIOR TO PROCEEDING.

**DESCRIPTION** 

TABLE OF REVISIONS

17. WORK NOT DETAILED, MARKED OR SPECIFIED IN PARTICLUAR, WILL BE AS SIMILAR WORK THAT IS DETAILED, MARKED, OR SPECIFIED. ALL TYPICAL DETAILS SHALL BE USED WHERE APPLICABLE UNLESS NOTED OTHERWISE. ALL DETAILS SHALL BE CONSIDERED TYPICAL AT SIMILAR CONDITIONS.

18. THE TERM "TYPICAL" (TYP) SHALL MEAN APPLYING TO ALL LIKE OR SIMILAR CONDITIONS IN THE AREAS DESIGNATED FOR WORK. 19. DIMENSIONS GIVEN AS NOMINAL ARE FOR REFERENCE ONLY. ACTUAL

DIMENSIONS MUST BE VERIFIED THROUGH FIELD LAYOUT 20. ALL PLAN DIMENSIONS ARE GIVEN TO FACE OF FINISH AND CENTERLINE OF WINDOWS UNLESS OTHERWISE NOTED. VERTICAL DIMENSIONS GIVEN TO TOP OF SLAB AND TOP OF PLYWOOD FLOOR OR ROOF SHEATHING UNLESS OTHERWISE

21. ALL DOORS ARE DIMENSIONED FROM ADJACENT WALL TO HINGE SIDE OF FRAME ACCORDING TO TYPICAL DOOR FRAME DETAIL, UNLESS OTHERWISE NOTED. 2. ALL FAUCET CONTROLS AND OPERATING MECHANISMS SHALL BE OPERABLE 22. SEE DOOR AND WINDOW SCHEDULES FOR UNIT DIMENSIONS. SEE THE SCHEDULE OF KEYNOTES FOR A LIST OF KEYNOTES FOR THIS PROJECT. IF ANY KEYNOTE ON ANY ARCHITECTURAL SHEET IS ILLEGIBLE OR MISING REFER TO THE BE NO MORE THAN FIVE POUNDS. SCHEDULE OF KEYNOTES.

23. MATCH LINES ARE INDICATORS OF WHERE ADJOINING FLOOR PLANS MEET. SEE CCR TITLE 24 AT ACCESSIBLE TOILET FACILITIES. PLANS ON BOTH SIDES OF MATCH LINES FOR WORK OVERLAPPING MATCH LINE.

1. THE CONTRACTOR SHALL MAINTAIN THE PUBLIC RIGHTS OF WAY AFFECTED BY BASIS. MAINTAIN SIDEWALKS, MEANS OF EGRESS, CORRIDORS, STAIRS, ETC., CLEAR, UNOBSTRUCTED AND FREE OF ALL SOIL, DEBRIS, TRASH, ETC., ON A DAILY BASIS. CLEAN EGRESS SHALL BE MAINTAINED AT ALL TIMES FOR ALL BUILDING OCCUPANTS.

2. THE CONTRACTOR SHALL SECURE PERMIT FROM GOVERNING AGENCIES FOR WORK IN RIGHTS OF WAY AND/OR SCAFFOLDING.

3. LOCATIONS OF ALL UTILITIES SHOWN ARE APPROXIMATE AND CONTRACTOR SHALL EXERCISE EXTREME CAUTION IN EXCAVATING AND TRENCHING ON THIS SITE TO AVOID INTERCEPTING EXISTING PIPING OR CONDUITS. IT SHALL BE THE RESPONSIBILITY OF THE CONTRACTOR TO LOCATE EXISTING UTILITIES WHETHER OR NOT SHOWN ON THESE DRAWINGS AND TO PROTECT THEM FROM DAMAGE. THE CITY IS NOT RESPONSIBLE FOR THE LOCATION OF UNDERGROUND UTILITIES OR STRUCTURES WHETHER OR NOT SHOWN OR DETAILED AND INSTALLED BY H. ROOFING AND INSULATION ANY OTHER CONTRACT. THE CONTRACTOR SHALL IMMEDIATELY NOTIFY THE CITY REPRESENTATIVE SHOULD ANY UNIDENTIFIED CONDITIONS BE DISCOVERED. THE CONTRACTOR SHALL BEAR ALL EXPENSE OF REPLACEMENT OF UTILITIES OR OTHER PROPERTY DAMAGED BY OPERATIONS IN CONJUNCTION WITH PROSECUTION OF THIS WORK 4. EXISTING UTILITIES AND IMPROVEMENTS DAMAGED DURING THE COURSE OF THE WORK SHALL BE PROMPTLY REPAIRED. EXISTING UTILITIES AND IMPROVEMENTS DAMAGED, FOR WHICH LOCATIONS WERE UNKNOWN, SHALL BE IMMEDIATELY BROUGHT TO THE OWNER'S AND ARCHITECT'S ATTENTION AND PROMPTLY REPAIRED AT HIS/HER DIRECTION. THE WORK REQUIRED TO REPAIR DAMAGED EXISTING

# D. FIRE SAFETY

1. GENERAL: FIRE SAFETY DURING CONSTRUCTION SHALL COMPLY WITH CALIFORNIA FIRE CODE (CFC) CALIFORNIA CODE OF REGULATIONS (CCR) TITLE 24. PART 9 ARTICLE 87.

UTILITIES AND IMPROVEMENTS FOR WHICH LOCATIONS WERE UNKNOWN

WILL BE REVIEWED AND TAKEN UNDER CONSIDERATION AS EXTRA WORK.

2. ACCESS ROADS: FIRE DEPARTMENT ACCESS ROADS SHALL BE ESTABLISHED AND MAINTAINED IN ACCORDANCE SECTION 902. 3. WATER SUPPLY: WATER MAINS AND HYDRANTS SHALL BE OPERATIONAL IN ACCORDANCE WITH SECTION 903.

4. BUILDING ACCESS: ACCESS TO BUILDINGS FOR THE PURPOSE OF FIREFIGHTING SHALL BE PROVIDED. CONSTRUCTION MATERIAL SHALL NOT BLOCK ACCESS BUILDINGS, HYDRANTS OR FIRE APPLIANCES. 6. DEMOLITION OF BUILDINGS: SHALL COMPLY WITH SECTION 8706 AND APPLICABLE PROVISIONS OF SECTIONS 8704 AND 8705.

7. FIRE WATCH: MAINTAIN FIRE WATCH WHEN REQUIRED BY THE BUILDING ARCHITECT OR PROFESSIONAL ENGINEER WHO HAS BEEN DELEGATED OFFICIAL AND WHEN EXISTING FIRE PROTECTION SYSTEMS ARE SHUT DOWN FOR ALTERATIONS. FIRE WATCH SHALL REMAIN IN EFFECT UNTIL EXISTING PROTECTION SYSTEMS ARE RETURNED TO SERVICE OR AS ALLOWED BY THE BUILDING OFFICIAL

8. PENETRATIONS OF FIRE RATED MATERIALS OR ASSEMBLIES SHALL BE RESTORED TO EQUAL RATING. FIRE STOP SYSTEMS AS LISTED BY UNDERWRITERS LABORATORIES SHALL BE INSTALLED PER FIRE RESISTANCE DIRECTORY. FIRE STOP SYSTEMS SHALL BE AS SPECIFIED. 9. OBTAIN APPROVAL FROM LOCAL FIRE AUTHORITY PRIOR TO STORAGE OF

BUILDING. 10. PROTECT SMOKE DETECTORS NEAR CONSTRUCTION AREAS WITH A VISQUEEN OR SIMILAR WRAP. REMOVE PROTECTION AT END OF EACH WORKING DAY. CCR PART 3 ARTICLE 760-9.

12. ALL FIRE DAMPER ASSEMBLIES, INCLUDING SLEEVES AND INSTALLATION PROCEDURES SHALL BE APPROVED BY THE BUILDING INSPECTOR PRIOR TO THE INSTALLATION. 13. ANY NEW EXIT SIGN SHALL BE INTERNALLY ILLUMINATED AND THE WORD 'EXIT'

SHALL BE GREEN ON OPAQUE BACKGROUND PER CBC SECTION 1002.8.3.

AND PRIOR TO RETURN AIR FAN START-UP.

# **E. EXTERIOR ACCESSIBILITY**

1. ALL NEW WALKS AND SIDEWALKS SHALL HAVE A CONTINUOUS COMMON SURFACE, NOT INTERRUPTED BY STEPS OR BY ABRUPT CHANGES IN LEVEL, AND SHALL BE A MINIMUM OF 48" WIDE.

2. ALL NEW SURFACES WITH A SLOPE LESS THAN 6 PERCENT GRADIENT SHALL BE AT LEAST AS SLIP RESISTANT AS THAT DESCRIBED AS A MEDIUM BROOM FINISH.

3. ALL NEW SURFACES WITH A SLOPE GREATER THAN 6 PERCENT GRADIENT SHALL BE AT LEAST AS SLIP RESISTANT AS THAT DESCRIBED AS A HEAVY BROOM FINISH. 4. ALL NEW SURFACE CROSS SLOPES SHALL NOT EXCEED 1/4 INCH PER FOOT. 5. ALL WALKS WITH CONTINUOUS GRADIENTS SHALL HAVE AT LEAST 5 FEET IN LANDING LENGTH AT INTERVALS OF EVERY 30 INCHES IN VERTICAL RISE. 6. SURFACE SLOPE FOR ACCESSIBLE PARKING SPACES FOR THE PHYSICALLY DISABLED SHALL NOT EXCEED 1/4 INCH PER FOOT IN ANY DIRECTION.

## F. INTERIOR ACCESSIBILITY

1. ALL HOT WATER AND DRAINPIPES UNDER LAVATORIES SHALL BE INSULATED OR OTHERWISE COVERED. THERE SHALL BE NO SHARP OR ABRASIVE SURFACES UNDER LAVATORIES.

WITH ONE HAND AND SHALL NOT REQUIRE TIGHT GRASPING, PINCHING OR TWISTING OF THE WRIST. THE FORCE REQUIRED TO ACTIVATE CONTROLS SHALL 3. ACCESSIBLE TOILET ROOM IDENTIFICATION SYMBOLS ARE TO BE PROVIDED PER

4. ANY NEW DRINKING FOUNTAIN SHALL BE ACTIVATED BY A CONTROL WHICH IS EASILY OPERATED BY A PHYSICALLY CHALLENGED PERSON SUCH AS A HAND-OPERATED LEVER TYPE CONTROL LOCATED WITHIN 6 INCHES OF THE FRONT OF THE DRINKING FOUNTAIN, ETC. THE BUBBLER SHALL BE SUBSTANTIALLY PARALLEL TO THE FRONT EDGE OF THE DRINKING FOUNTAIN.

# G. CONSTRUCTION

1. PENETRATIONS IN FIRE RATED ASSEMBLIES AND BEARING WALLS SHALL BE PROTECTED AS REQUIRED BY CBC CHAPTER 7

2. ALL NEW FINISH MATERIALS SHALL BE MAINTAINED IN A FLAME RETARDANT CONDITION. (CCR T-19, SEC, 1.14, 3.08, 3.21). 3. ANY NEW FURRED CEILINGS SHALL BE CONSTRUCTED AS REQUIRED IN CBC SEC

2504 AND TABLE 25A. 4. ANY NEW SUSPENDED ACOUSTICAL CEILING BOARD SHALL BE NON-COMBUSTIBLE.

5. ALL NEW WALL AND CEILING MATERIALS IN EXIT CORRIDORS SHALL COMPLY WITH CBC SEC. 1005.

1. WHERE CEILING OR ROOF MOUNTED EQUIPMENT/ PENETRATIONS ARE REQUIRED TO BE REMOVED OR INSTALLED/ RE-INSTALLED, PROVIDE ROOFING AND FLASHING TO ACCOMMODATE THE CONDITION.

2. ALL INSULATION MATERIAL SHALL MEET THE CALIFORNIA QUALITY STANDARD PER SECTION 2.5311 B.E.E.S.-1986. ROOF INSULATION SHALL MEET CBC SECTION 1510 AND WALL INSULATION SHALL MEET CBC SECTION 1807.2. 3. ALL ROOFING SHALL BE CLASS A FIRE RETARDANT.

## 1. DEMOLITION

 DEMOLISH AND REMOVE FROM THE PREMISES ALL PARTS OF THE EXISTING BUILDING INDICATED FOR DEMOLITION OR REQUIRED TO BE DEMOLISHED FOR THE INSTALLATION OF NEW WORK. 2. ALL ITEMS NOTED TO BE SALVAGED SHALL BE RETURNED TO THE OWNER. THE OWNER RETAINS THE RIGHT TO SALVAGE ANY EXISTING MATERIAL INDICATED OR

REQUIRED TO BE REMOVED OR DEMOLISHED. 3. THE CONTRACTOR IS RESPONSIBLE FOR REVIEWING AND FIELD VERIFYING DEMOLITION REQUIREMENTS IN RELATION TO CONSTRUCTION DRAWINGS. THE ARCHITECT IS TO BE NOTIFIED OF ANY CONFLICTS, DISCREPANCIES OR PROBLEMS 4. CONSTRUCTION DEBRIS AND WASTES SHALL BE DEPOSITED AT AN APPROPRIATE

SITE. THE CONTRACTOR SHALL AT ALL TIMES KEEP PREMISES FREE FROM ACCUMULATION OF DEBRIS CAUSED BY ITS OPERATIONS. AT THE COMPLETION OF THE WORK, CONTRACTOR SHALL CLEAN ALL GLASS SURFACES AND LEAVE THE WORK IN A CLEAN CONDITION READY FOR OCCUPANCY.

# J. DEFERRED APPROVAL ITEMS:

INSTALLATION OF DEFERRED APPROVAL ITEMS SHALL NOT BE STARTED UNTIL DETAILED PLANS, SPECIFICATIONS, AND ENGINEERING CALCULATIONS HAVE BEEN ACCEPTED AND SIGNED BY THE ARCHITECT OR ENGINEER IN GENERAL RESPONSIBLE CHARGE OF DESIGN AND SIGNED BY A CALIFORNIA REGISTERED. RESPONSIBILITY COVERING THE WORK SHOWN ON A PARTICULAR PLAN OR SPECIFICATION AND APPROVED BY THE SAN FRANCISCO DEPARTMENT OF BUILDING INSPECTION.

	AND ANGLE	E.	EAST	JAN.	JANITOR	S	SOUTH
	CENTERLINE	(E) EA.	EXISTING EACH	JST.	JOIST	S.A.D.	SEE ARCHITECTURAL
) )	DIAMETER OR ROUND	E.B.	EXPANSION BOLT	JT.	JOINT	SB	DRAWINGS SPLASH BLOCK
		E.J.	EXPANSION JOINT	K.O.	KNOCKOUT	S.C.D.	SEE CIVIL DRAWINGS
	ANCHOR BOLT	ELEC.	ELECTRIC	14.0.	THEOTICOT	SCD	SEAT COVER DISPENSER
	ABOVE	ELEV.	ELEVATION	LAM.	LAMINATE	SCHED.	
	ACCESSIBLE	EMER.	EMERGENCY	LAV.	LAVATORY	S.E.D.	SEE ELECTRICAL
	ACOUSTICAL CEILING THE	E.Q.	EQUAL	LBL.	LABEL		DRAWINGS
CT /C	ACOUSTICAL CEILING TILE AIR CONDITIONED			LBS.	POUNDS	SHT.	SHEET
	AREA DRAIN	E.W. EXH.	EACH WAY EXHAUST	L.P. LT.	LOW POINT LIGHT	SHTG. SIM.	SHEATHING SIMILAR
	ADJUSTABLE	EXP.	EXPANSION	LI.	LIGHT	S.L.D.	SEE LANDSCAPE
	ABOVE FINISHED FLOOR	EXT.	EXTERIOR	MAX.	MAXIMUM	J.L.D.	DRAWINGS
	AGGREGATE			M.B.	MACHINE BOLT	S.M.D.	SEE MECHANICAL
	ALUMINUM	F.A.	FIRE ALARM	MECH.	MECHANICAL		DRAWINGS
	ALUMINUM	F.D.	FLOOR DRAIN	MET.	METAL	S.M.S.	SHEET METAL SCREW
	ALTERNATIVE ANCHOR	FDN.	FOUNDATION	MFR.	MANUFACTURER	SND	SANITARY NAPKIN
	ACCESS PANEL	FEC	FIRE EXTINGUISHER CABINET	MICRO.	MICROWAVE	0.0.0	DISPOSAL
	APPROXIMATE	F.H.C.	FIRE HOSE CABINET	MIN. MIR	MINIMUM MIRROR	S.P.D.	SEE PLUMBING DRAWINGS
	ARCHITECTURAL		FLAT HEAD METAL	MISC.	MISCELLANEOUS	SPEC.	SPECIFICATION
SPH.	ASPHALT		SCREW	MTD.	MOUNTED	SQ.	SQUARE
.T.R.D.	ABOVE TOP OF ROOF DECK	F.H.W.S.	FLAT HEAD WOOD	MTL.	METAL	S.S.D.	SEE STRUCTURAL
	ATTACHMENT		SCREW	MUL.	MULLION		DRAWINGS
UTO.	AUTOMATIC	FIN.	FINISH			SST.	STAINLESS STEEL
- D	DOADD	F.G.	FINISH GRADE	N.	NORTH	ST.	STREET
D. ITUM	BOARD BITUMINOUS	FIXT.	FIXTURE	(N)	NEW	STD.	STANDARD
	BUILDING	FL. FLR.	FLUSH FLOOR (ING)	N.I.C.	NOT IN CONTRACT	STL.	STEEL
	BLOCK	FLASH.		NO. OR #	# NUMBER NOMINAL	STRUC. SYM.	
LKG.	BLOCKING	FLUOR.	FLUORESCENT	NOW. NR.	NON-RATED	STIVI.	SYMMETRICAL
	BEAM	F.O.	FACE OF	N.T.S.	NOT TO SCALE	T.	TREAD
	BOTTOM	F.O.C.	FACE OF CONCRETE			TEMP	TEMPERED
	BRACKET	F.O.F.	FACE OF FINISH	O/	OVER	T&G	TONGUE AND GROOVE
s.U.	BUILT-UP	FPRF.	FIREPROOF	O.A.	OVERALL	THK.	THICKNESS
۸D	CABINET	F.R.	FIRE RESISTIVE	O.C.	ON CENTER	THRES.	THRESHOLD
	CATCH BASIN	F.S.	FULL SIZE	O.D.	OUTSIDE DIMENSION		TOP OF CURB
	CENTER TO CENTER	F.T. FT.	FIRE TREATED FOOT OR FEET	O.H.	OVAL HEAD	T.O.P.	TOP OF PAVEMENT
	CEMENT	FTG.	FOOTING	OPER. OPNG.	OPERABLE OPENING	T.O.S. T.O.ST.	TOP OF SLAB TOP OF STEEL
	CERAMIC TILE	FURR.	FURRING	OPNG. OPP.	OPPOSITE	T.O.W.	TOP OF STEEL TOP OF WALL
	CONTROL JOINT	FUT.	FUTURE	OZ.	OUNCE	TPD	TOILET PAPER
	CEILING	FXD.	FIXED	-			DISPENSER
	CLEAR	_		PL.	PLATE	TS	TUBULAR STEEL
	COLUMN	G	GAS	P/L	PROPERTY LINE	TYP.	TYPICAL
	CARPET COLD WATER	GALV	GAUGE	PLAS.	PLASTER		
	COMBINATION	GALV. G.B.	GALVANIZED GRAB BAR	PLUMB.		U.B.C.	UNIFORM BUILDING
ONC.	CONCRETE	G.b. GL.	GLASS	PLY.	PLYWOOD PLYWOOD	UL	CODE UNDERWRITERS
ONN.	CONNECTION	GSM.	GALVANIZED SHEET	PR.	PAIR	OL	LABORATORY
	CONSTRUCTION		METAL	PT.	POINT	U.O.N.	UNLESS OTHERWISE
	CONTINUOUS	GYP.	GYPSUM	P.T.	PRESSURE TREATED		NOTED
	COUNTER	GWB.	GYPSUM WALLBOARD	PTD	PAPER TOWEL		
TR.	CENTER		LIGOE DID		DISPENSER	VERT.	VERTICAL
TSK.	COUNTERSUNK	H.B. HDR.	HOSE BIB HEADER	OT\/	OLIANITITY/	V.I.F.	VERIFY IN FIELD
BL.	DOUBLE		HARDWOOD	QTY.	QUANTITY	١٨/	WEST
	DIAPER CHANGE STATION		HARDWARE	R.	RISE	W. W/	WEST WITH
EPT.	DEPARTMENT	H.M.	HOLLOW METAL	RAD.	RADIUS	WC	WATER CLOSET
ET.	DETAIL	HORIZ.	HORIZONTAL	R.D.	ROOF DRAIN	WD	WOOD
).F.	DRINKING FOUNTAIN	H.P.	HIGH POINT	REC	RECESSED	WF	WIDE FLANGE
IA.	DIAMETER	HR.	HOUR	REF.	REFERENCE	WH	WATER HEATER
IAG. IM.	DIAGONAL DIMENSION	HT.	HEIGHT		REFRIGERATOR	W.O.	WHERE OCCURS
ISP	DISPOSAL	H.W.	HOT WATER	REQ.	REQUIRED	W/O	WITHOUT
N	DOWN	I.D. IN	SIDE DIAMETER	RES.	RESILIENT	WSCT	WAINSCOT
).S.P.	DRY STANDPIPE	INFO.	INFORMATION	RET. R.H.	RETAINING ROUND HEAD	WR WT	WASTE RECEPTACLE WEIGHT
	DETAIL	INSUL.	INSULATION	R.H. RM.	ROOM	VVI	VVLIOI11
W	DISHWASHER		ITERIOR	RND.	ROUND		
WG.	DRAWING			RWL	RAINWATER LEADER		
	ALL ATORY OOD	$\mathcal{L}_{\mathcal{C}}$					
KEG	ULATORY CODI	<b>_</b> 3					

**LEGEND** 

/ A.1 <sup>'</sup>

**ROOM NAME** 

201

X/A4.X

**(7'-6")** 

**CASEWORK** 

**DESIGNATION** 

COLUMN LINES

**ELEVATION** 

SECTION

drawing number on sheet

DETAIL REFERENCE

drawing number on sheet

MATCH LINE

DIMENSION OR

-ROOM NUMBER

DOOR NUMBER

PARTITION TYPE

—partition number

REFERENCE

—interior elevation reference

—multiple door designation

special treatment indication

REVISION DESIGNATION

SPOT ELEVATION IN FEET

G = GRADE, I = INVERT

KEYNOTE REFERENCE

**CEILING HEIGHT** 

Above Finish Floor

-Keynote Number.

—corresponds to room #

WINDOW SCHEDULE

**WORK POINT** 

-drawing number on sheet

INTERIOR ELEVATION

drawing number on sheet

-sheet on which elevation occ

—sheet on which section occurs

—sheet on which section occurs

-sheet on which elevation occur

# REGULATURY CODES

LIST OF APPLICABLE CODES - CALIFORNIA CODE OF REGULATIONS

1.1 2010 CALIFORNIA BUILDING STANDARDS ADMINISTRATIVE CODE, PART 1 TITLE 24 C.C.R. 1.2 2010 CALIFORNIA BUILDING CODE (IBC), PART 2, TITLE 24 C.C.R. 2006 INTERNATIONAL BUILDING CODE VOLUMES 1-3 W/ 2007

**ABBREVIATIONS** 

CALIFORNIA AMENDMENTS)

1.3 2010 CALIFORNIA ELECTRICAL CODE (CEC), PART 3 TITLE 24 C.C.R. 1.4 2010 CALIFORNIA MECHANICAL CODE (CMC), PART 4, TITLE 24 C.C.R

1.5 2010 CALIFORNIA PLUMBING CODE (CPC), PART 5, TITLE 24 C.C.R 1.6 2010 CALIFORNIA ENERGY CODE (CEC) PART 6,TITLE 24 C.C.R.

1.7 2010 CALIFORNIA ELEVATOR SAFETY CONSTRUCTION CODE PART 7. TITLE 24 C.C.R

1.8 2010 CALIFORNIA FIRE CODE, PART 9, TITLE 24 C.C.R.

1.9 2010 CALIFORNIA EXISTING BUILDING CODE, PART 10, TITLE 24 C.C.R. 1.10 2010 CALIFORNIA REFERENCED STANDARDS, PART 12, TITLE 24 C.C.R

1.11 TITLE 19 C.C.R. PUBLIC SAFETY, STATE FIRE MARSHAL REGULATIONS

4/26/13	60% DELIVERABLE 4.26.13		REFERENCE INFORMATION	
6/21/13	90% SET 6.21.13		& FILE NO. OF SURVEYS	
6/21/13	PERMIT SET 6.21.13			
8/02/13	100% COORDINATION SET 8.02.13			1

BY APF





# **Building Design & Construction DEPARTMENT OF PUBLIC WORKS** CITY AND COUNTY OF SAN FRANCISCO


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TL/ EC 08/2013	
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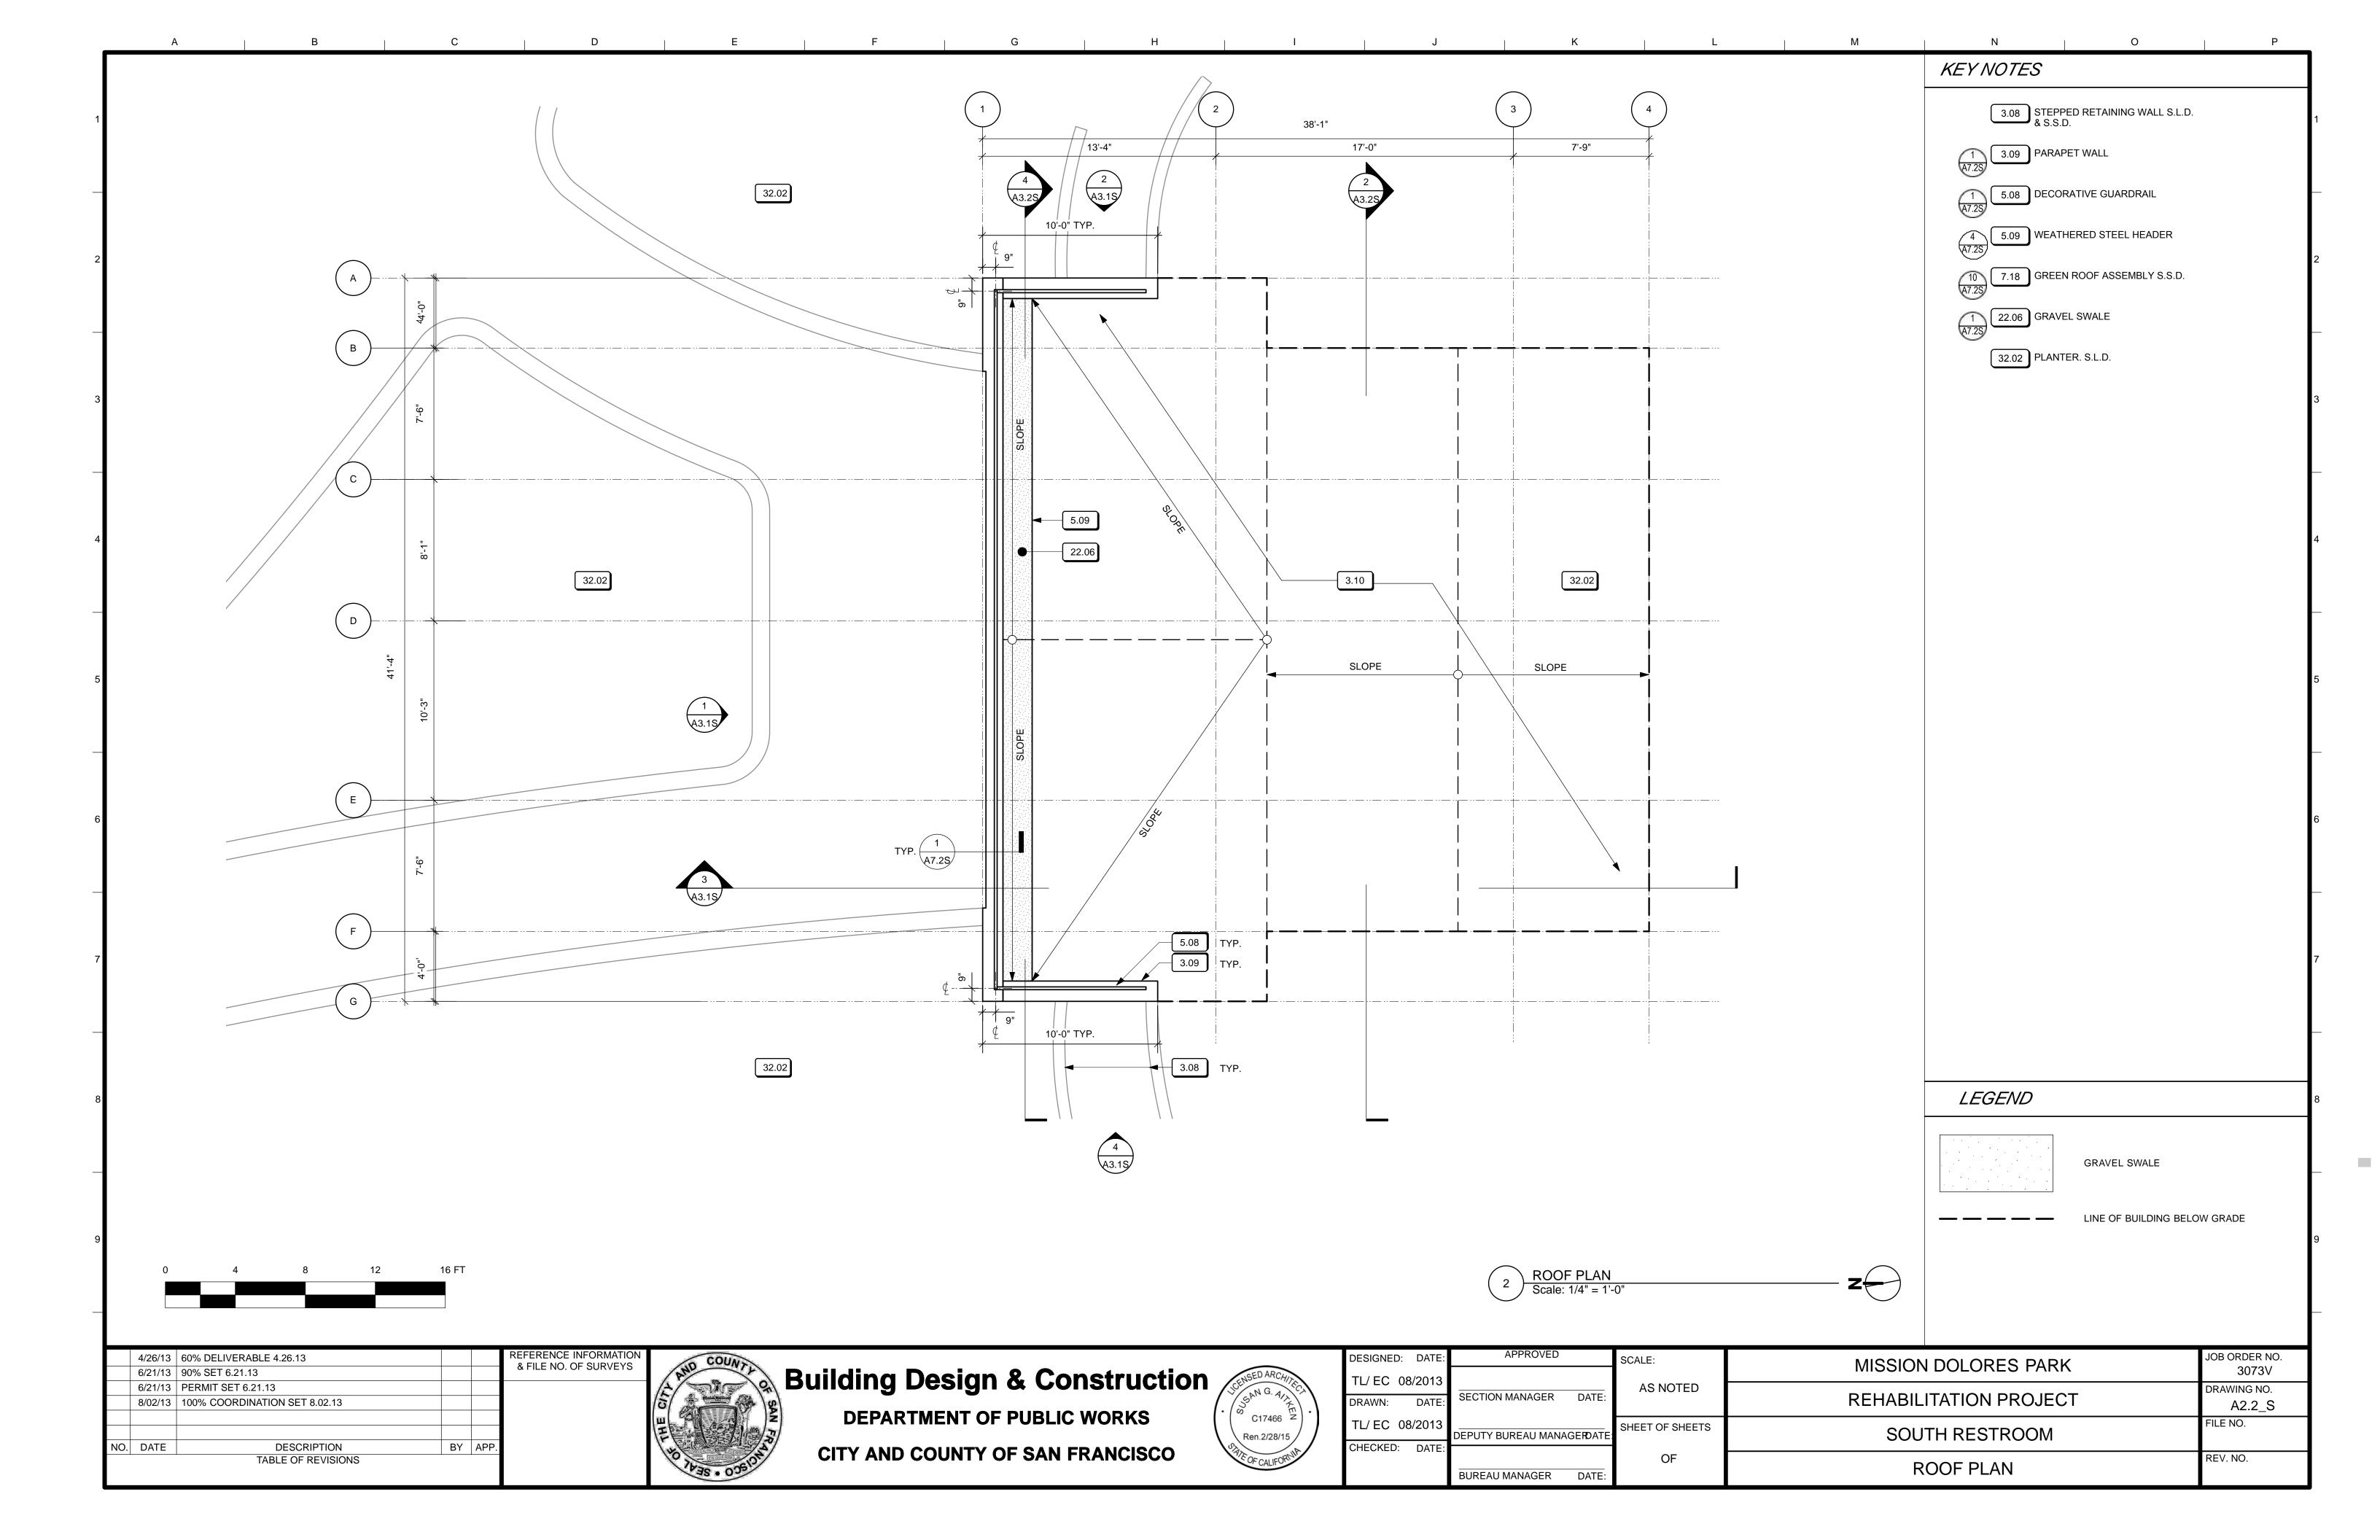
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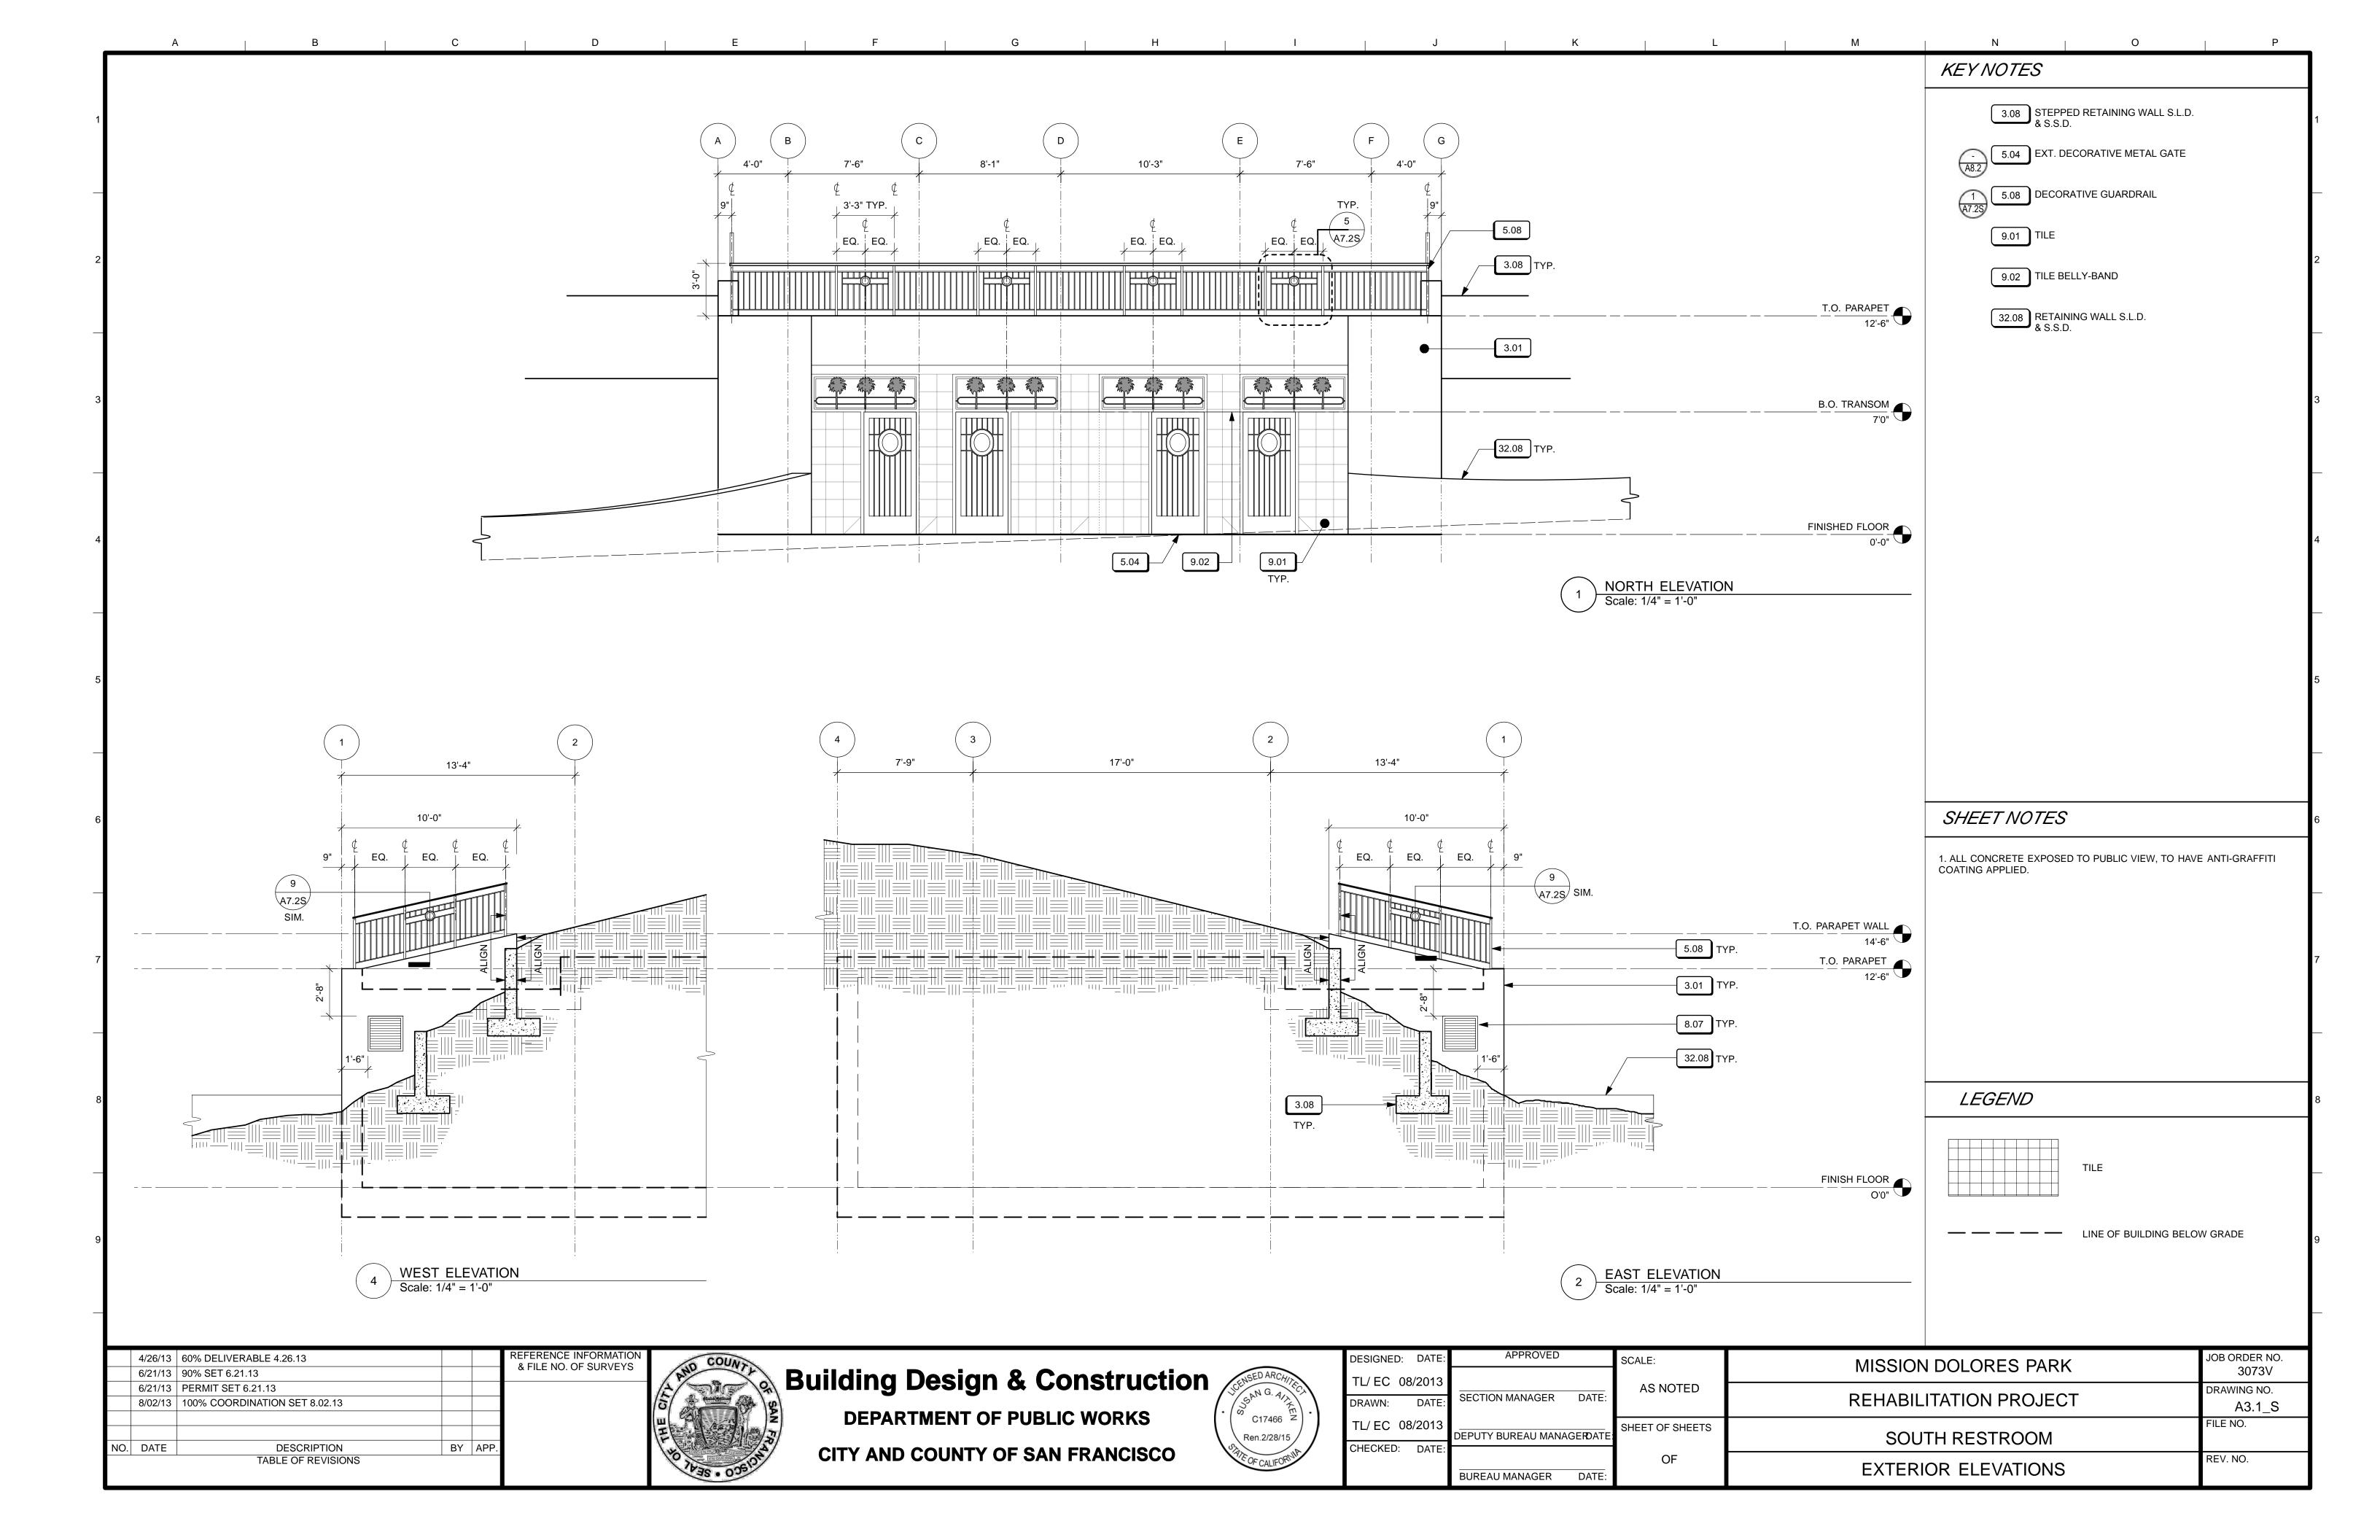
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•	SECTION MANAGER DATE:	AS NOTED	REHABILITATION PROJECT	DRAWING NO. A0.0S
3	DEPUTY BUREAU MANAGERDATE:	SHEET OF SHEETS	SOUTH RESTROOM	FILE NO.
•	BUREAU MANAGER DATE:	OF	ABBREVIATIONS, GENERAL NOTES, AND LEGEND	REV. NO.







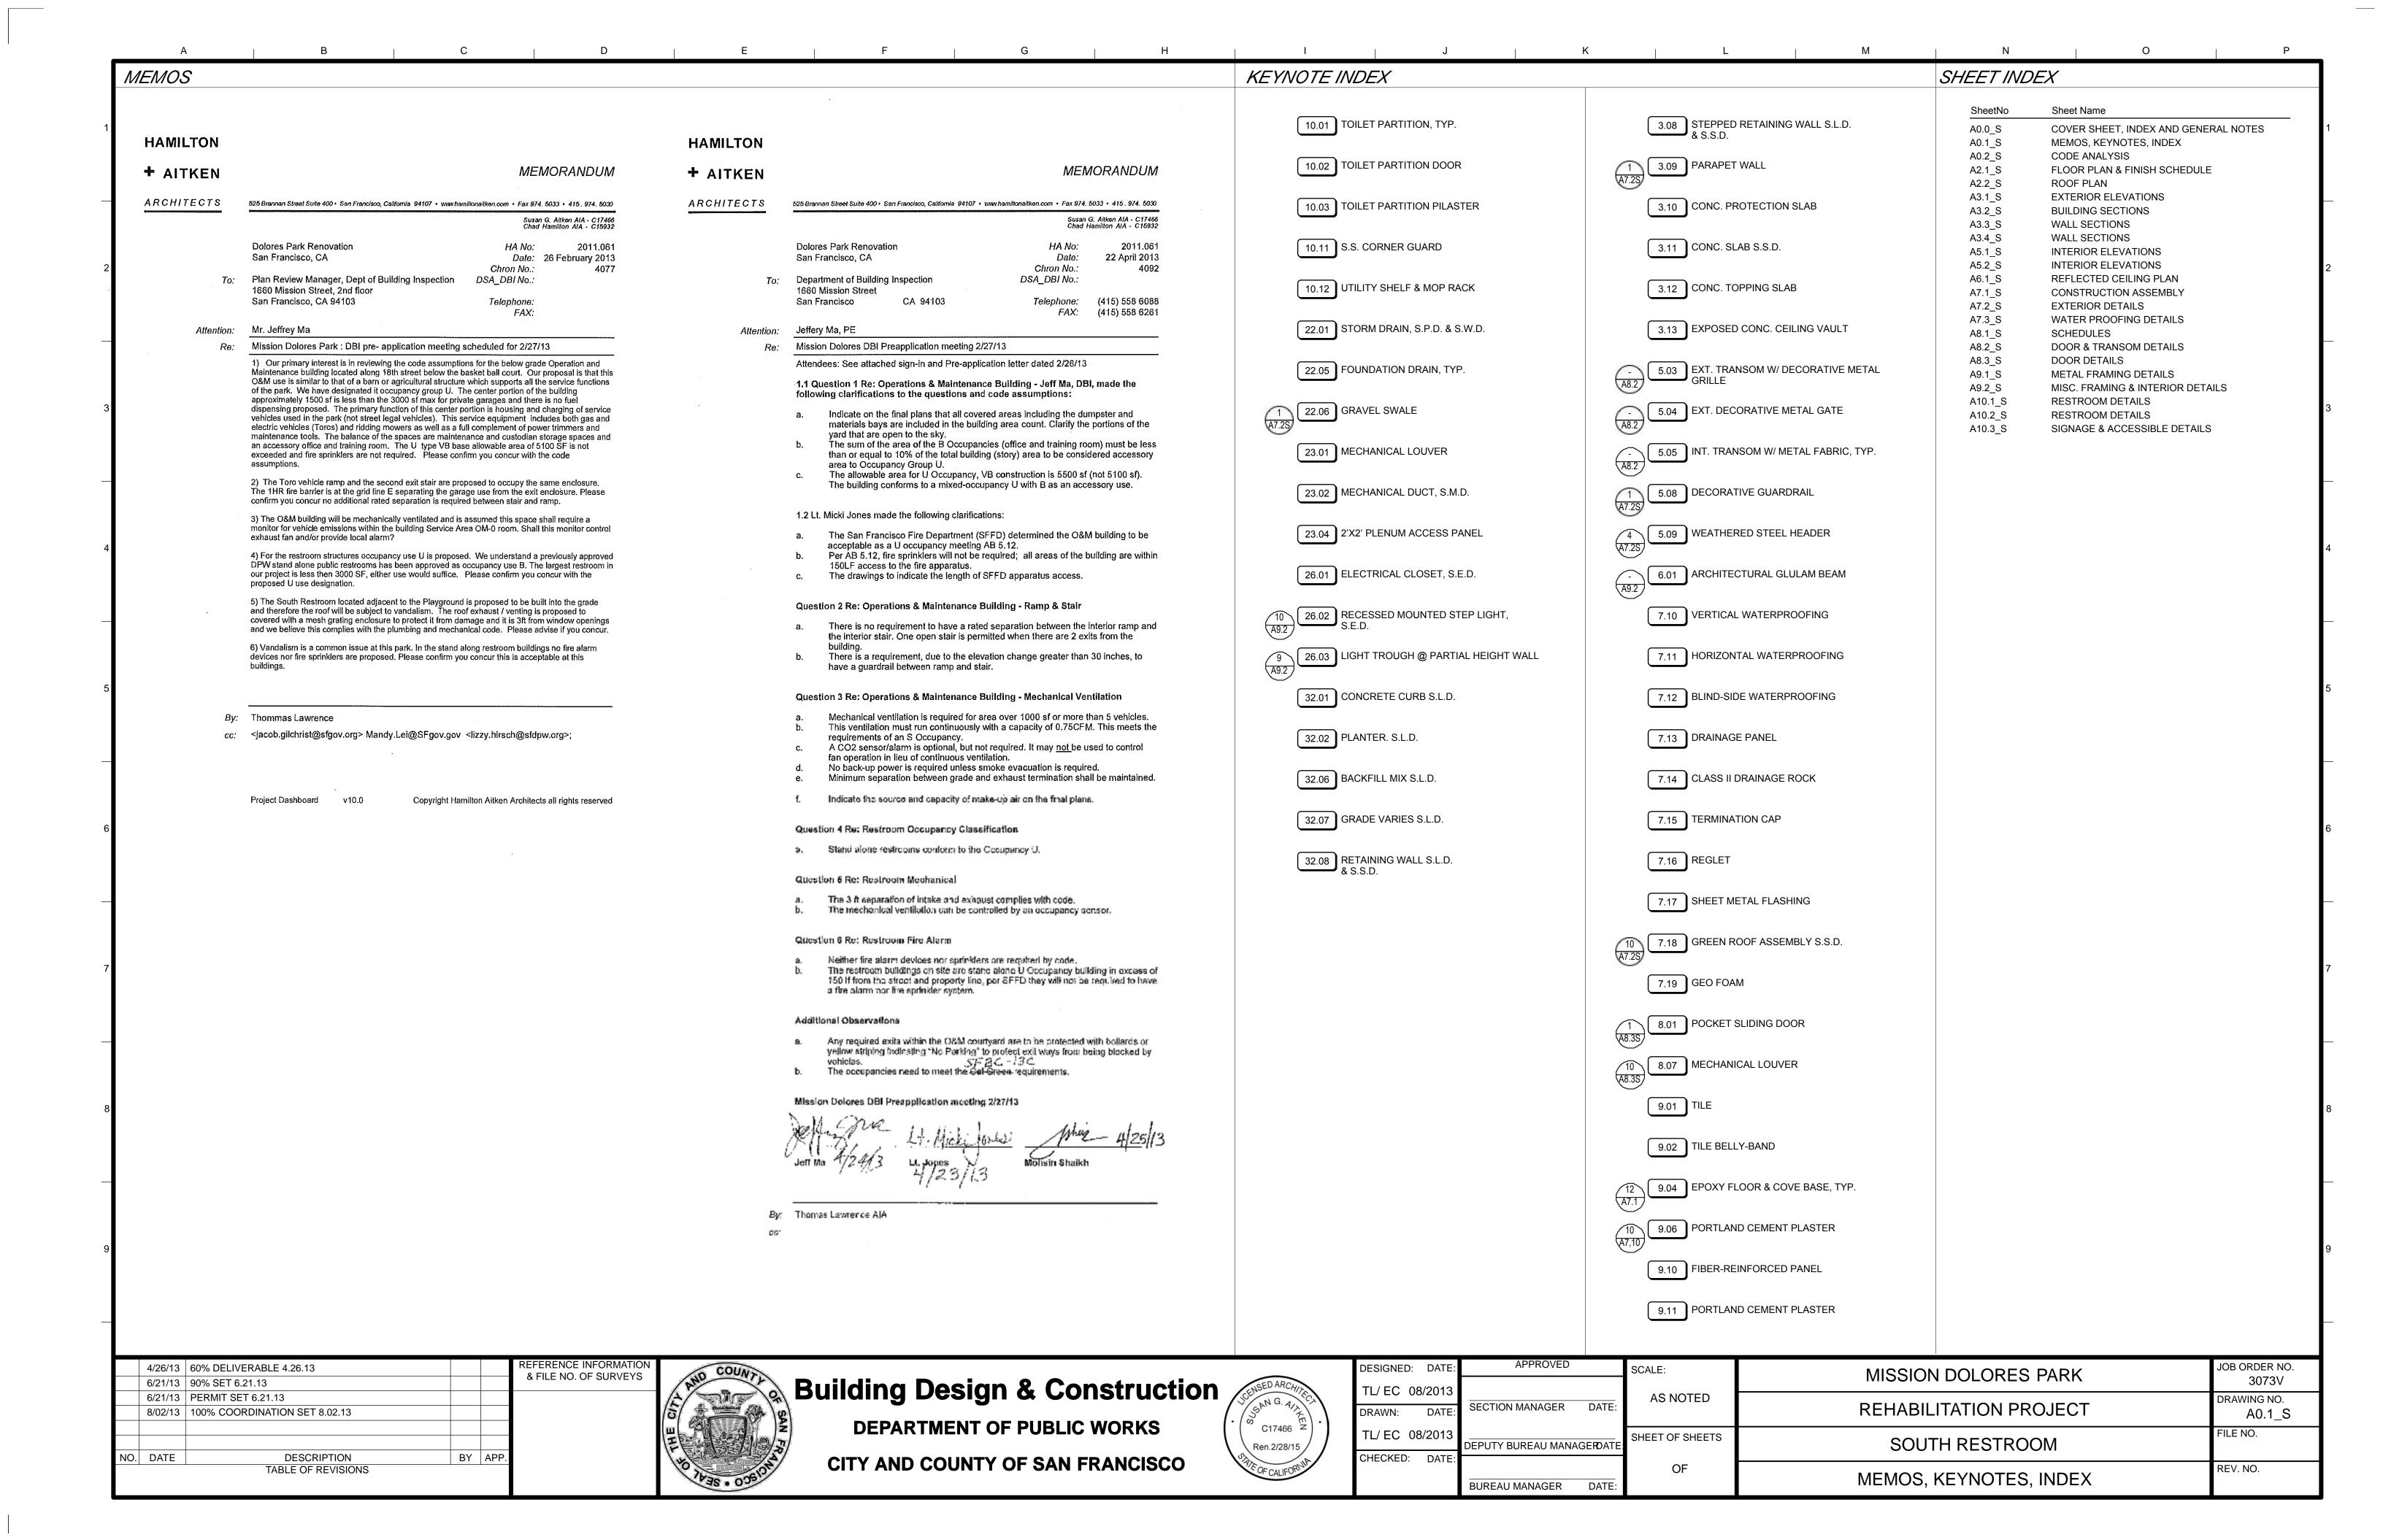


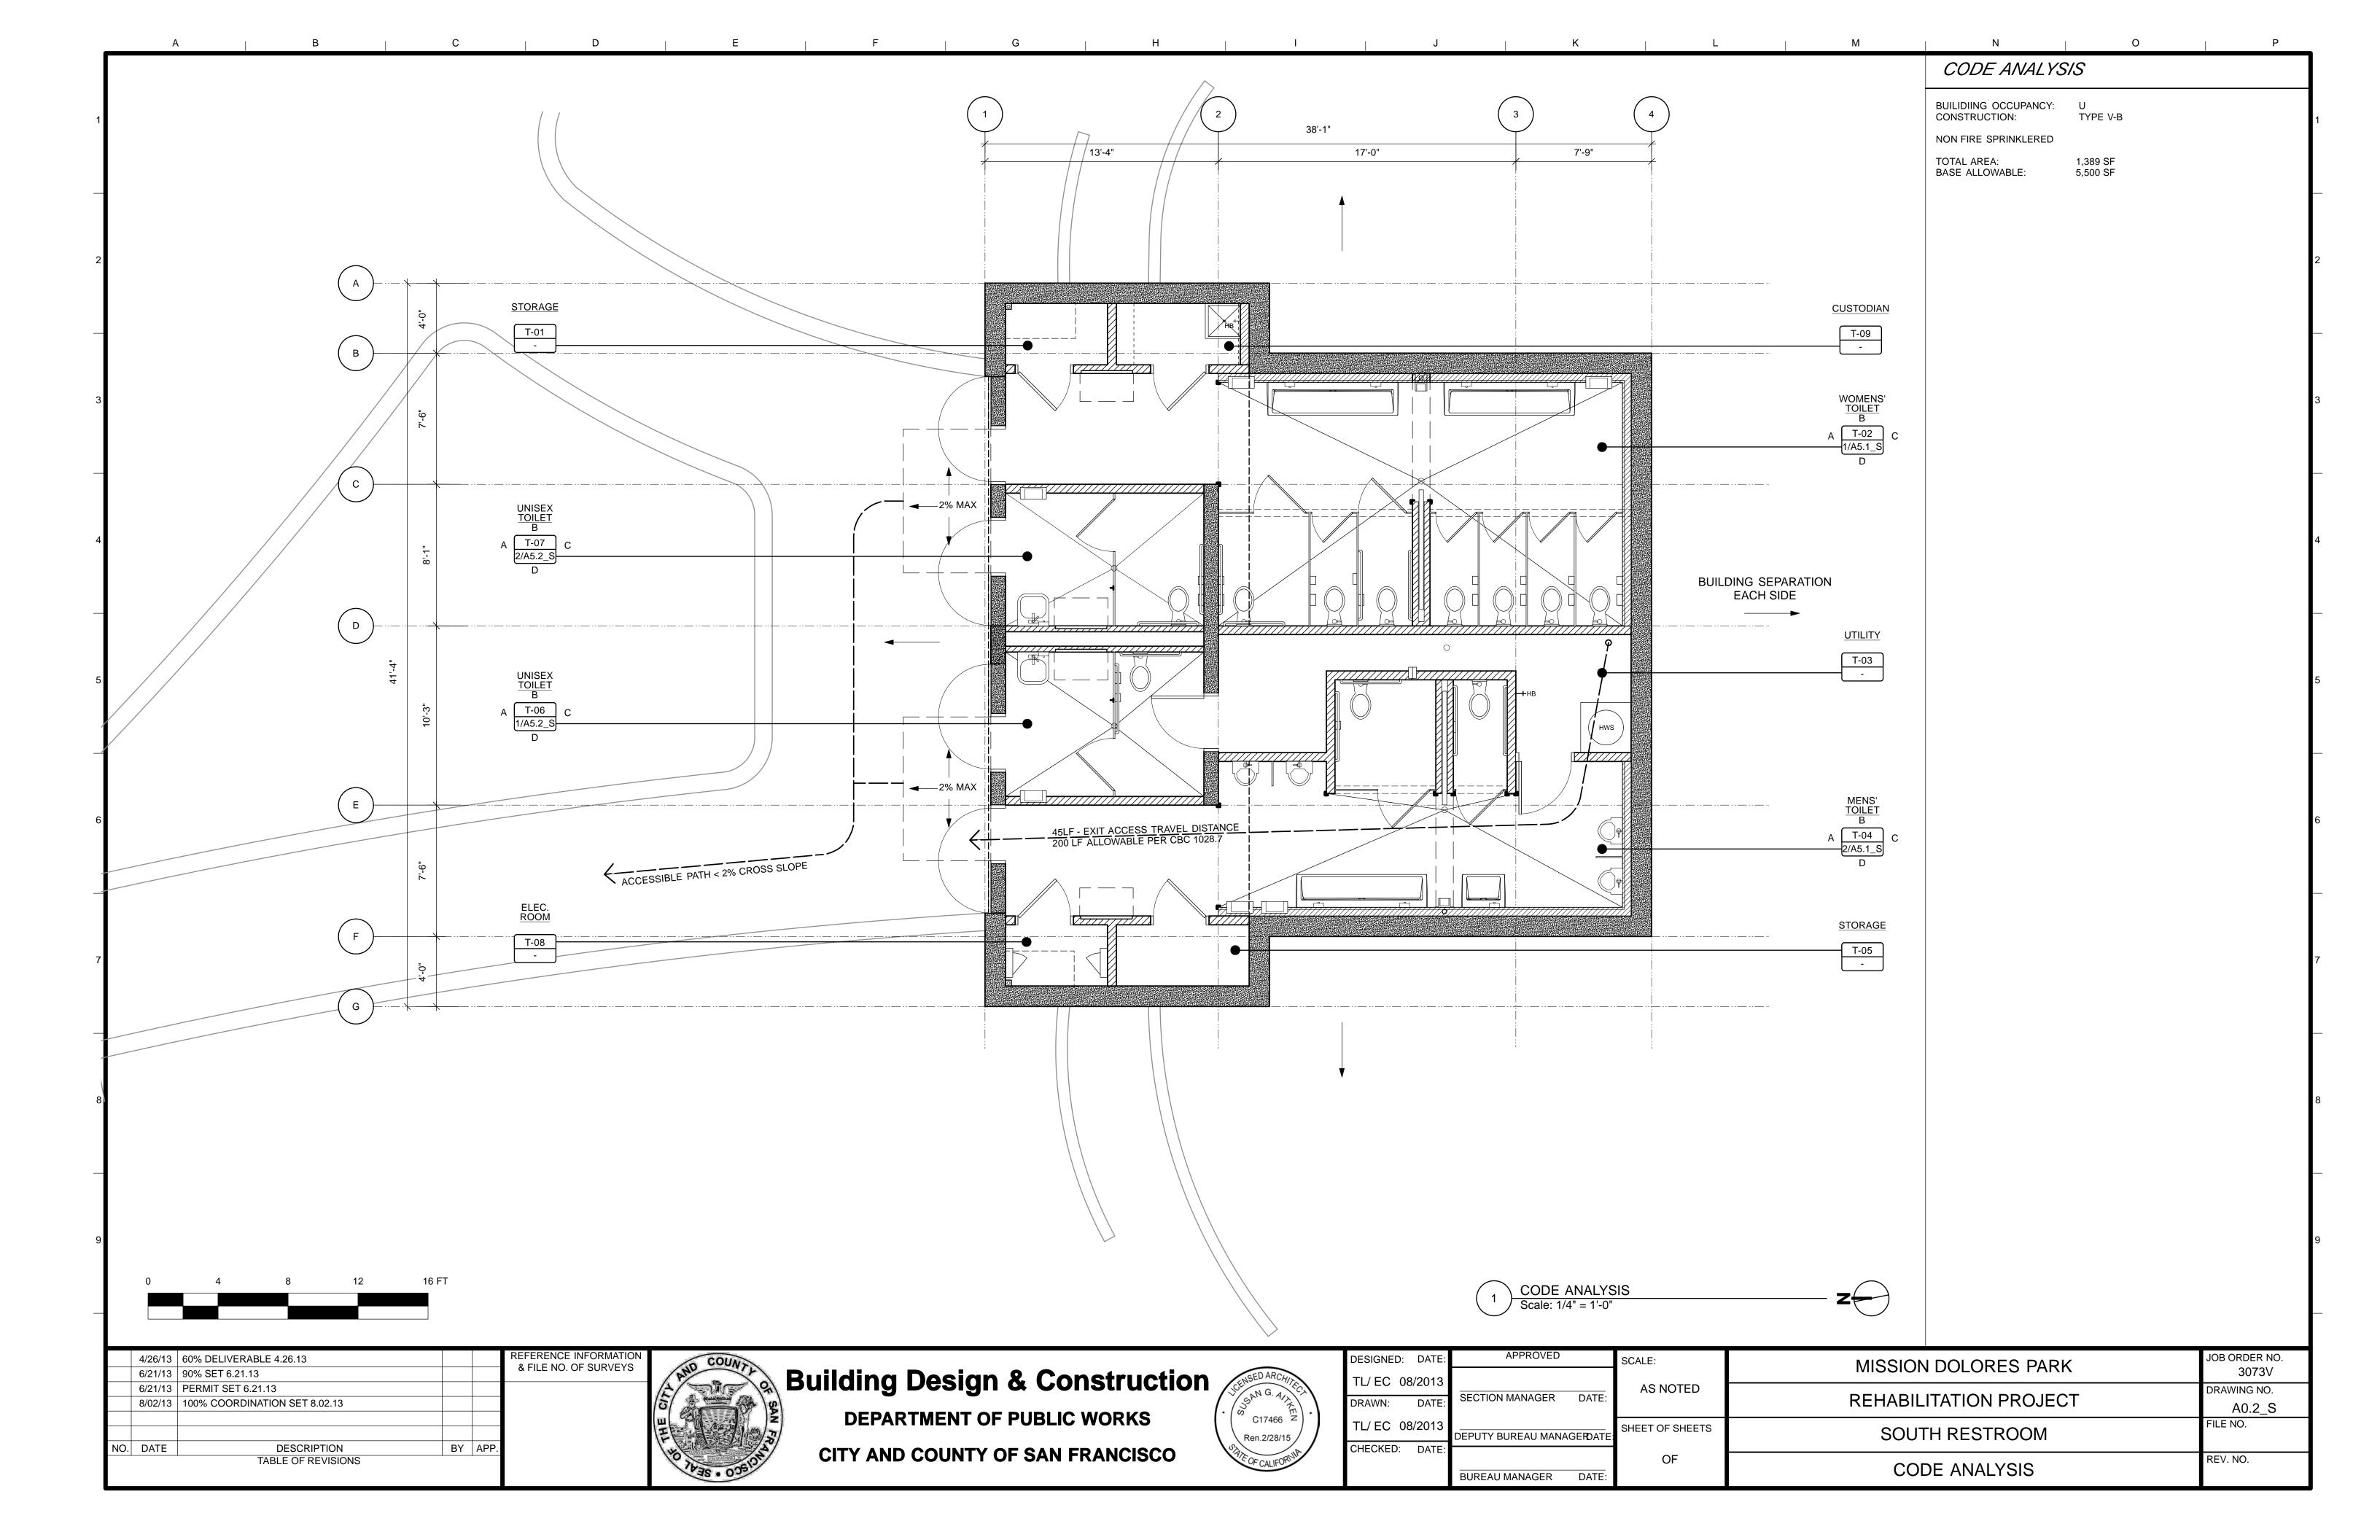


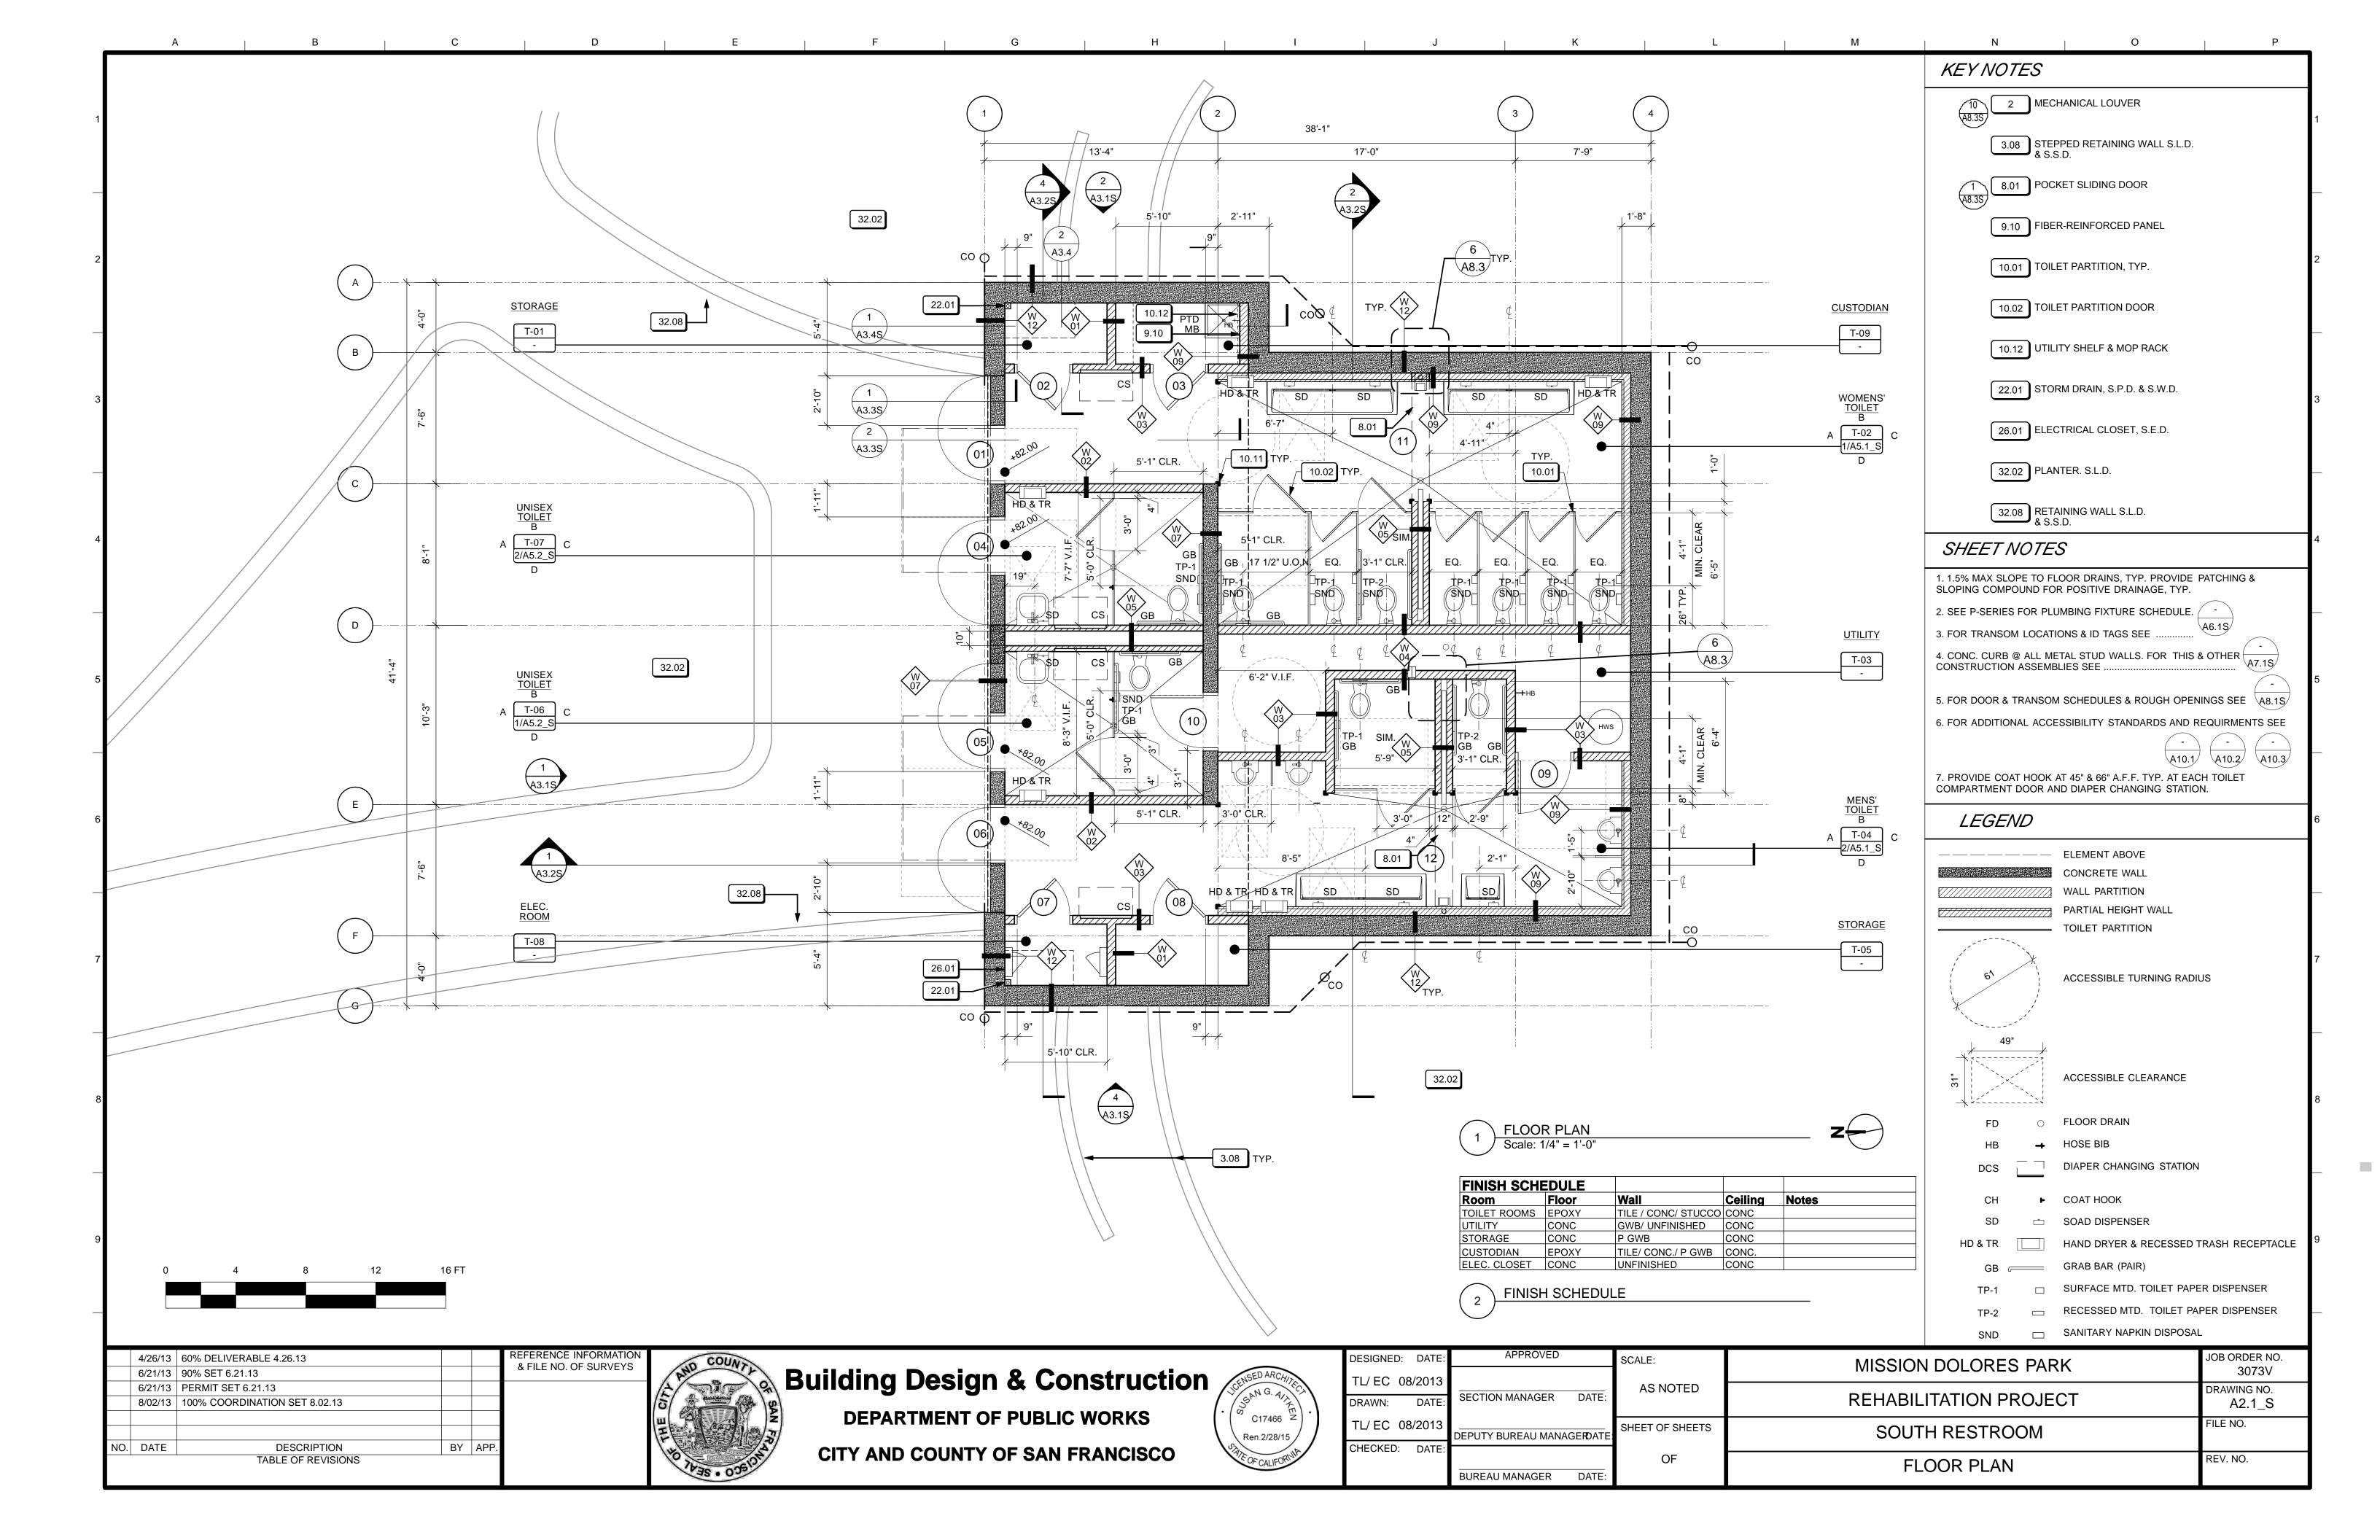


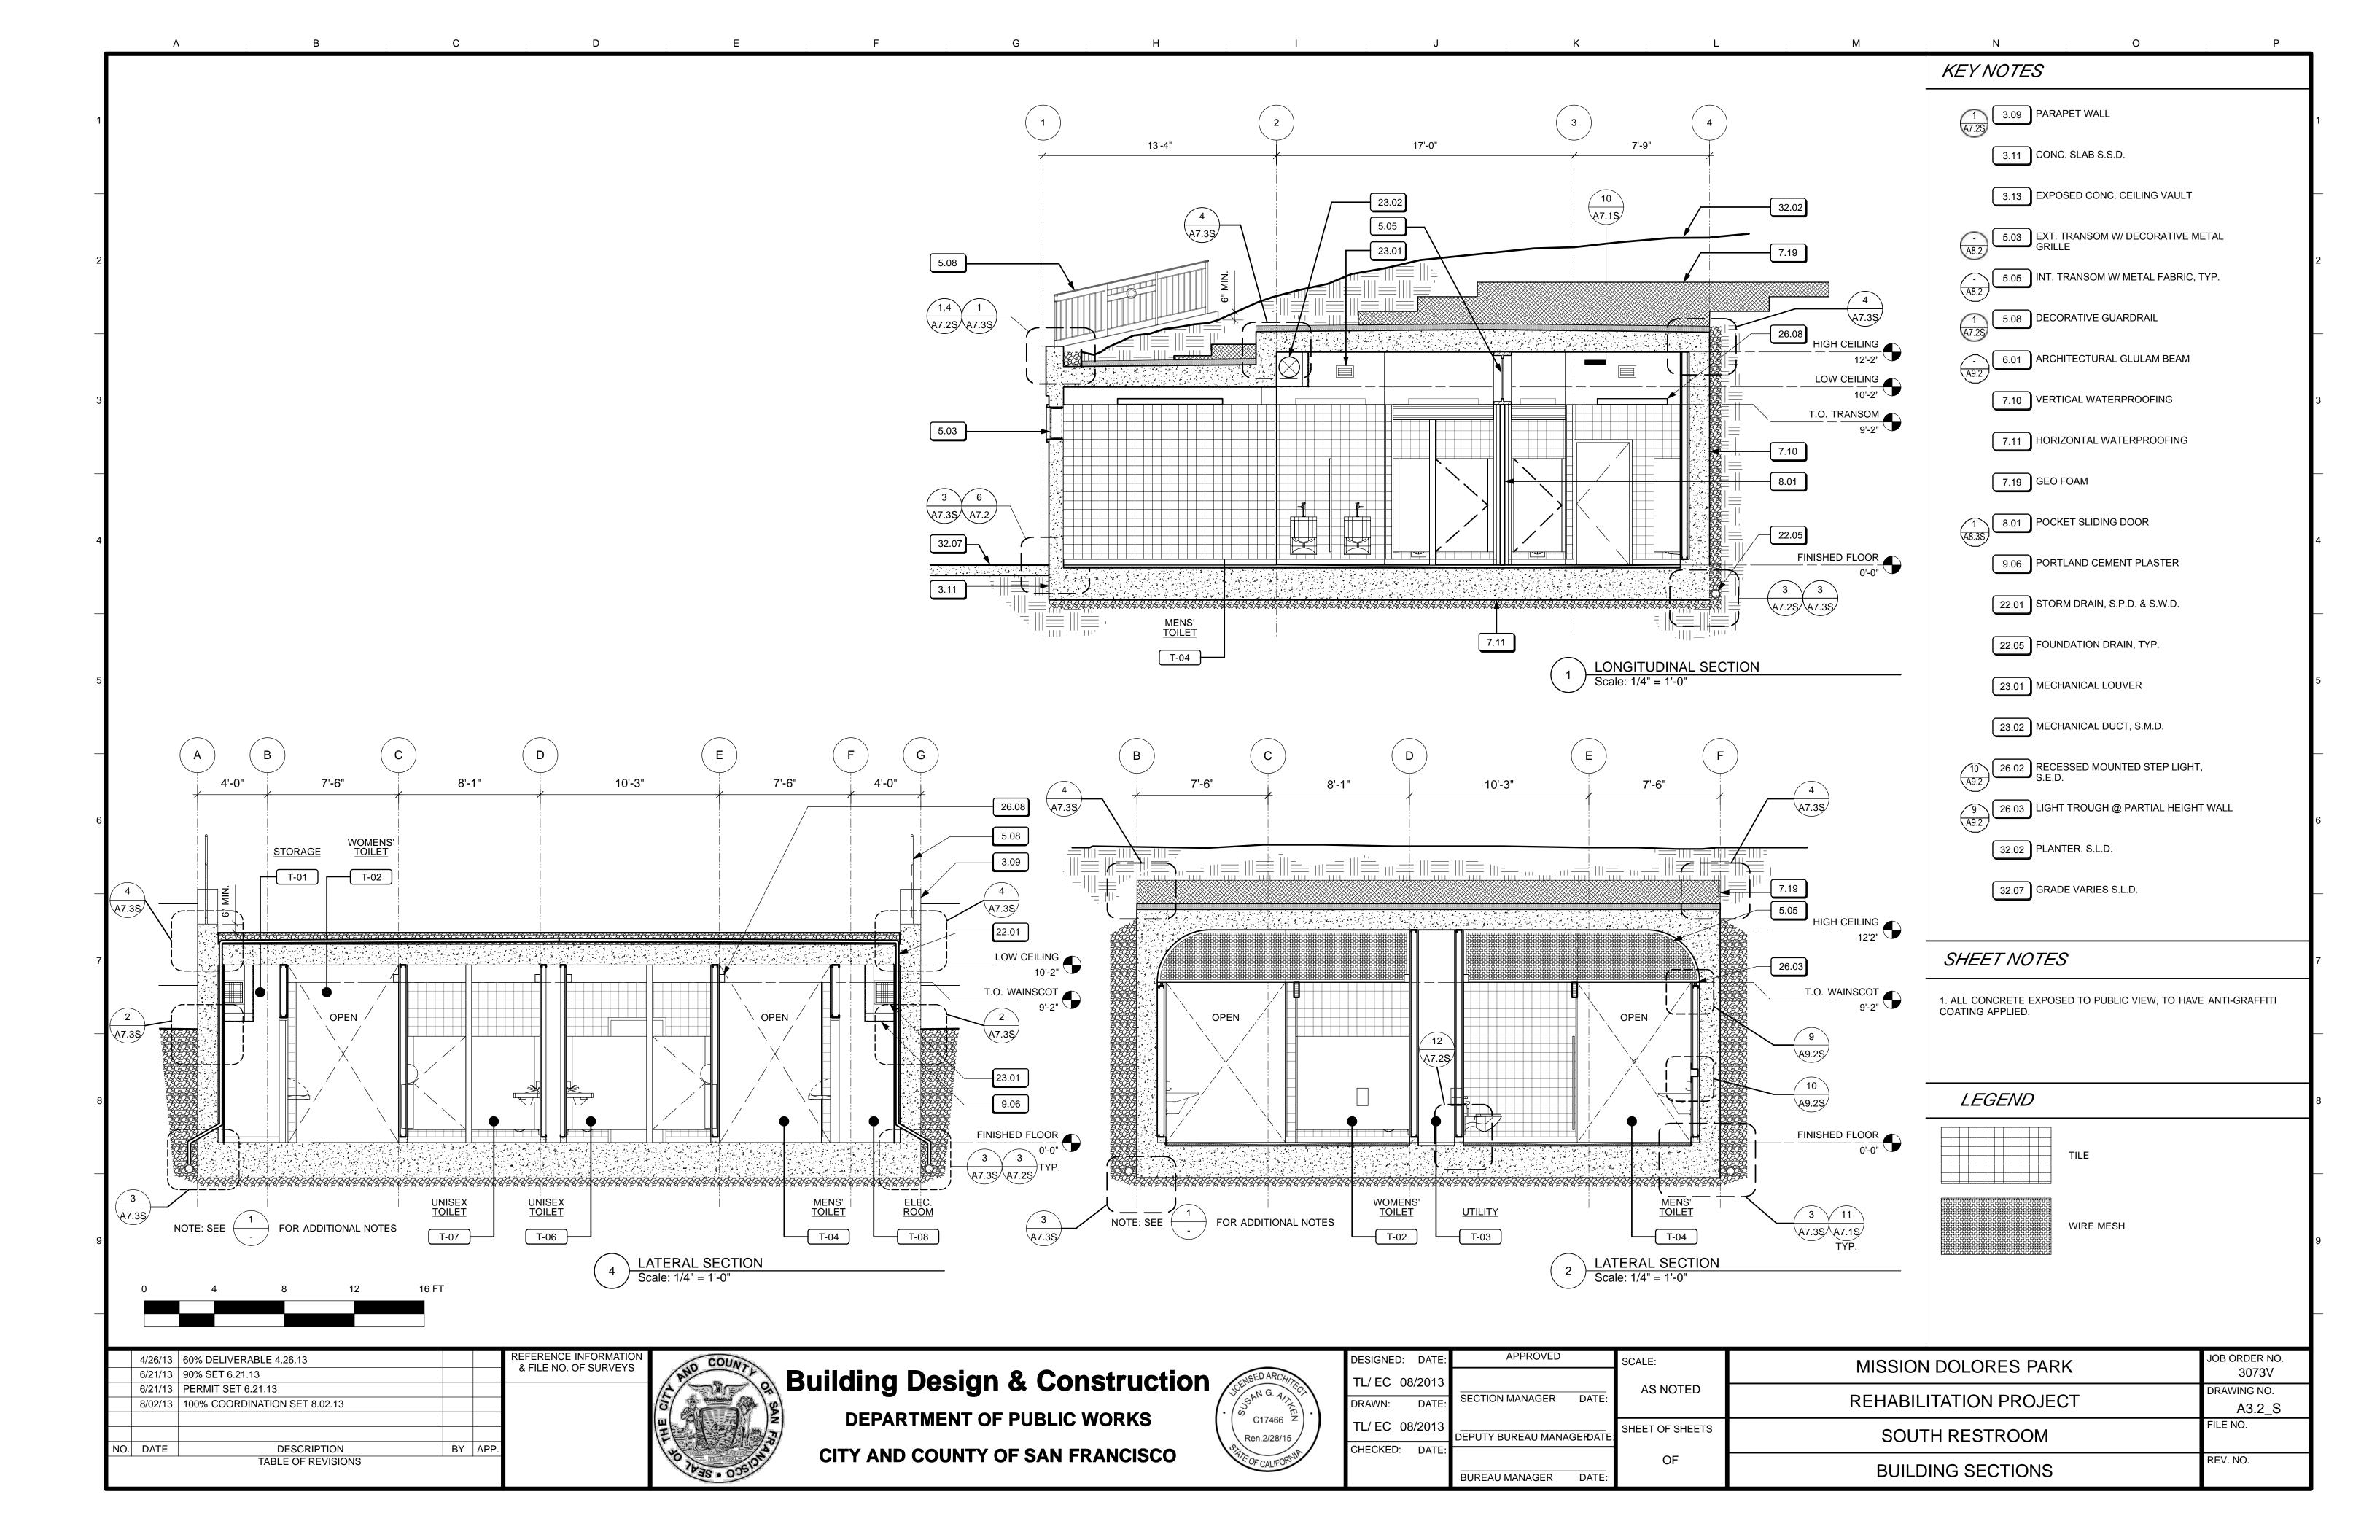


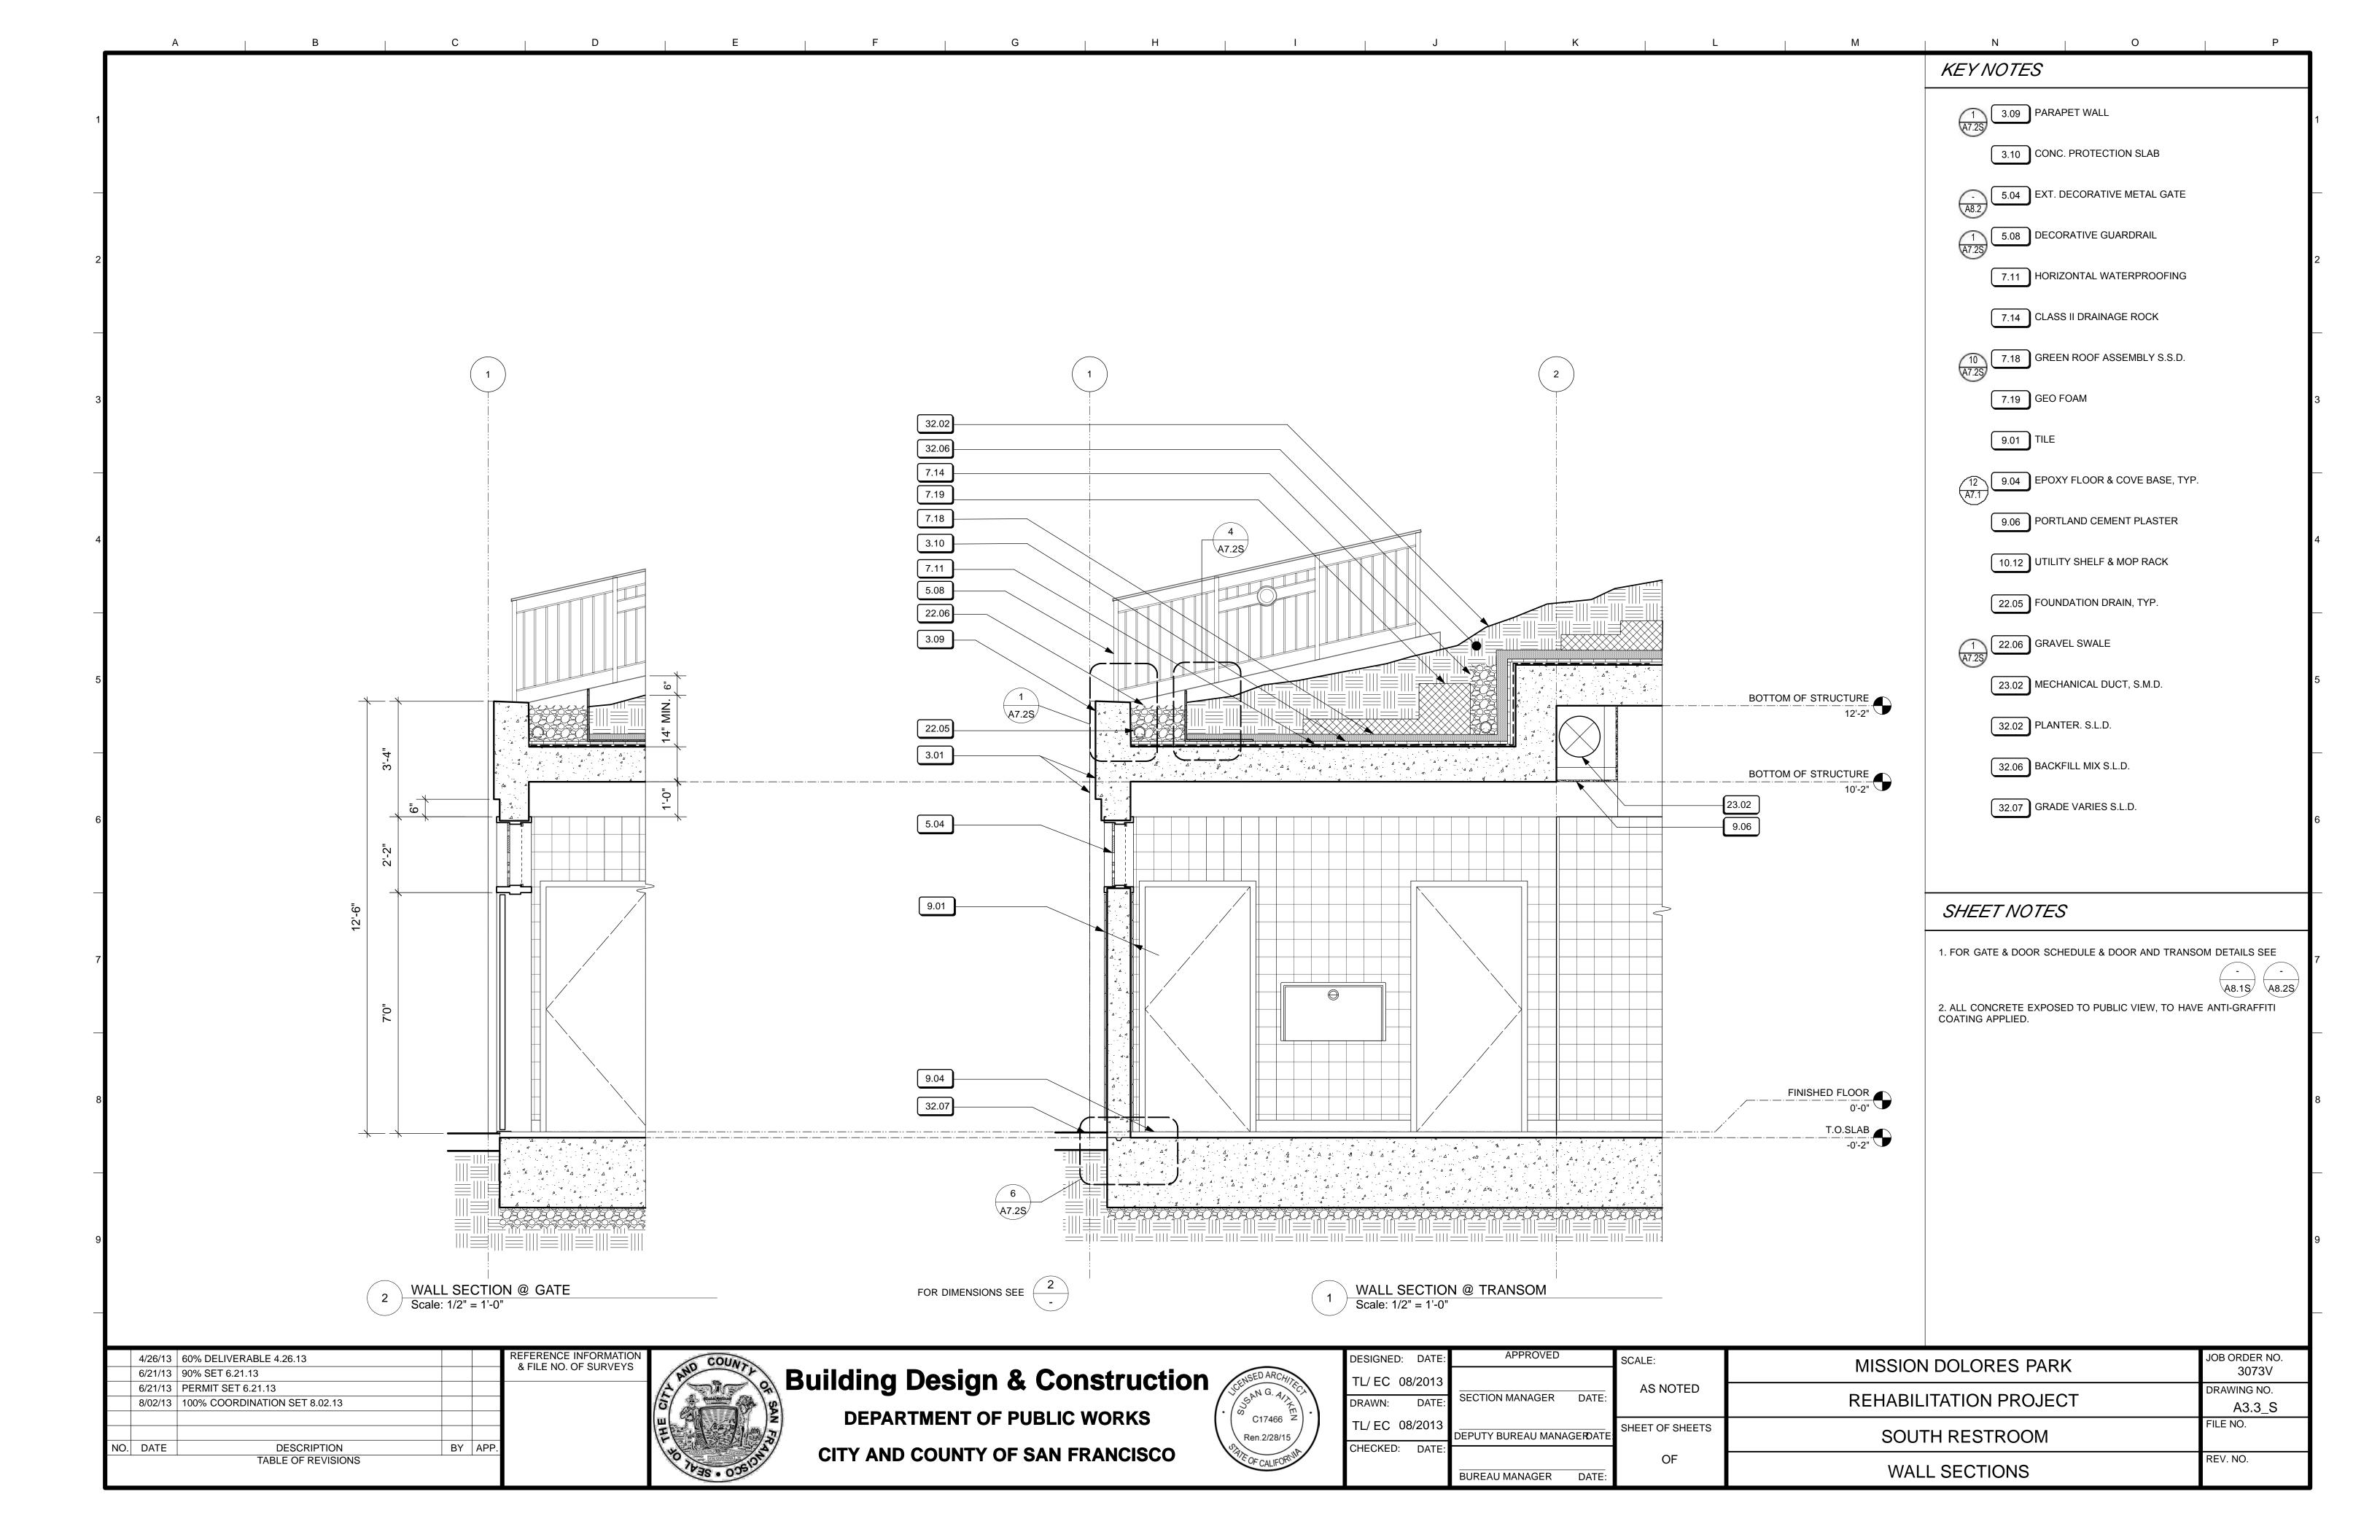


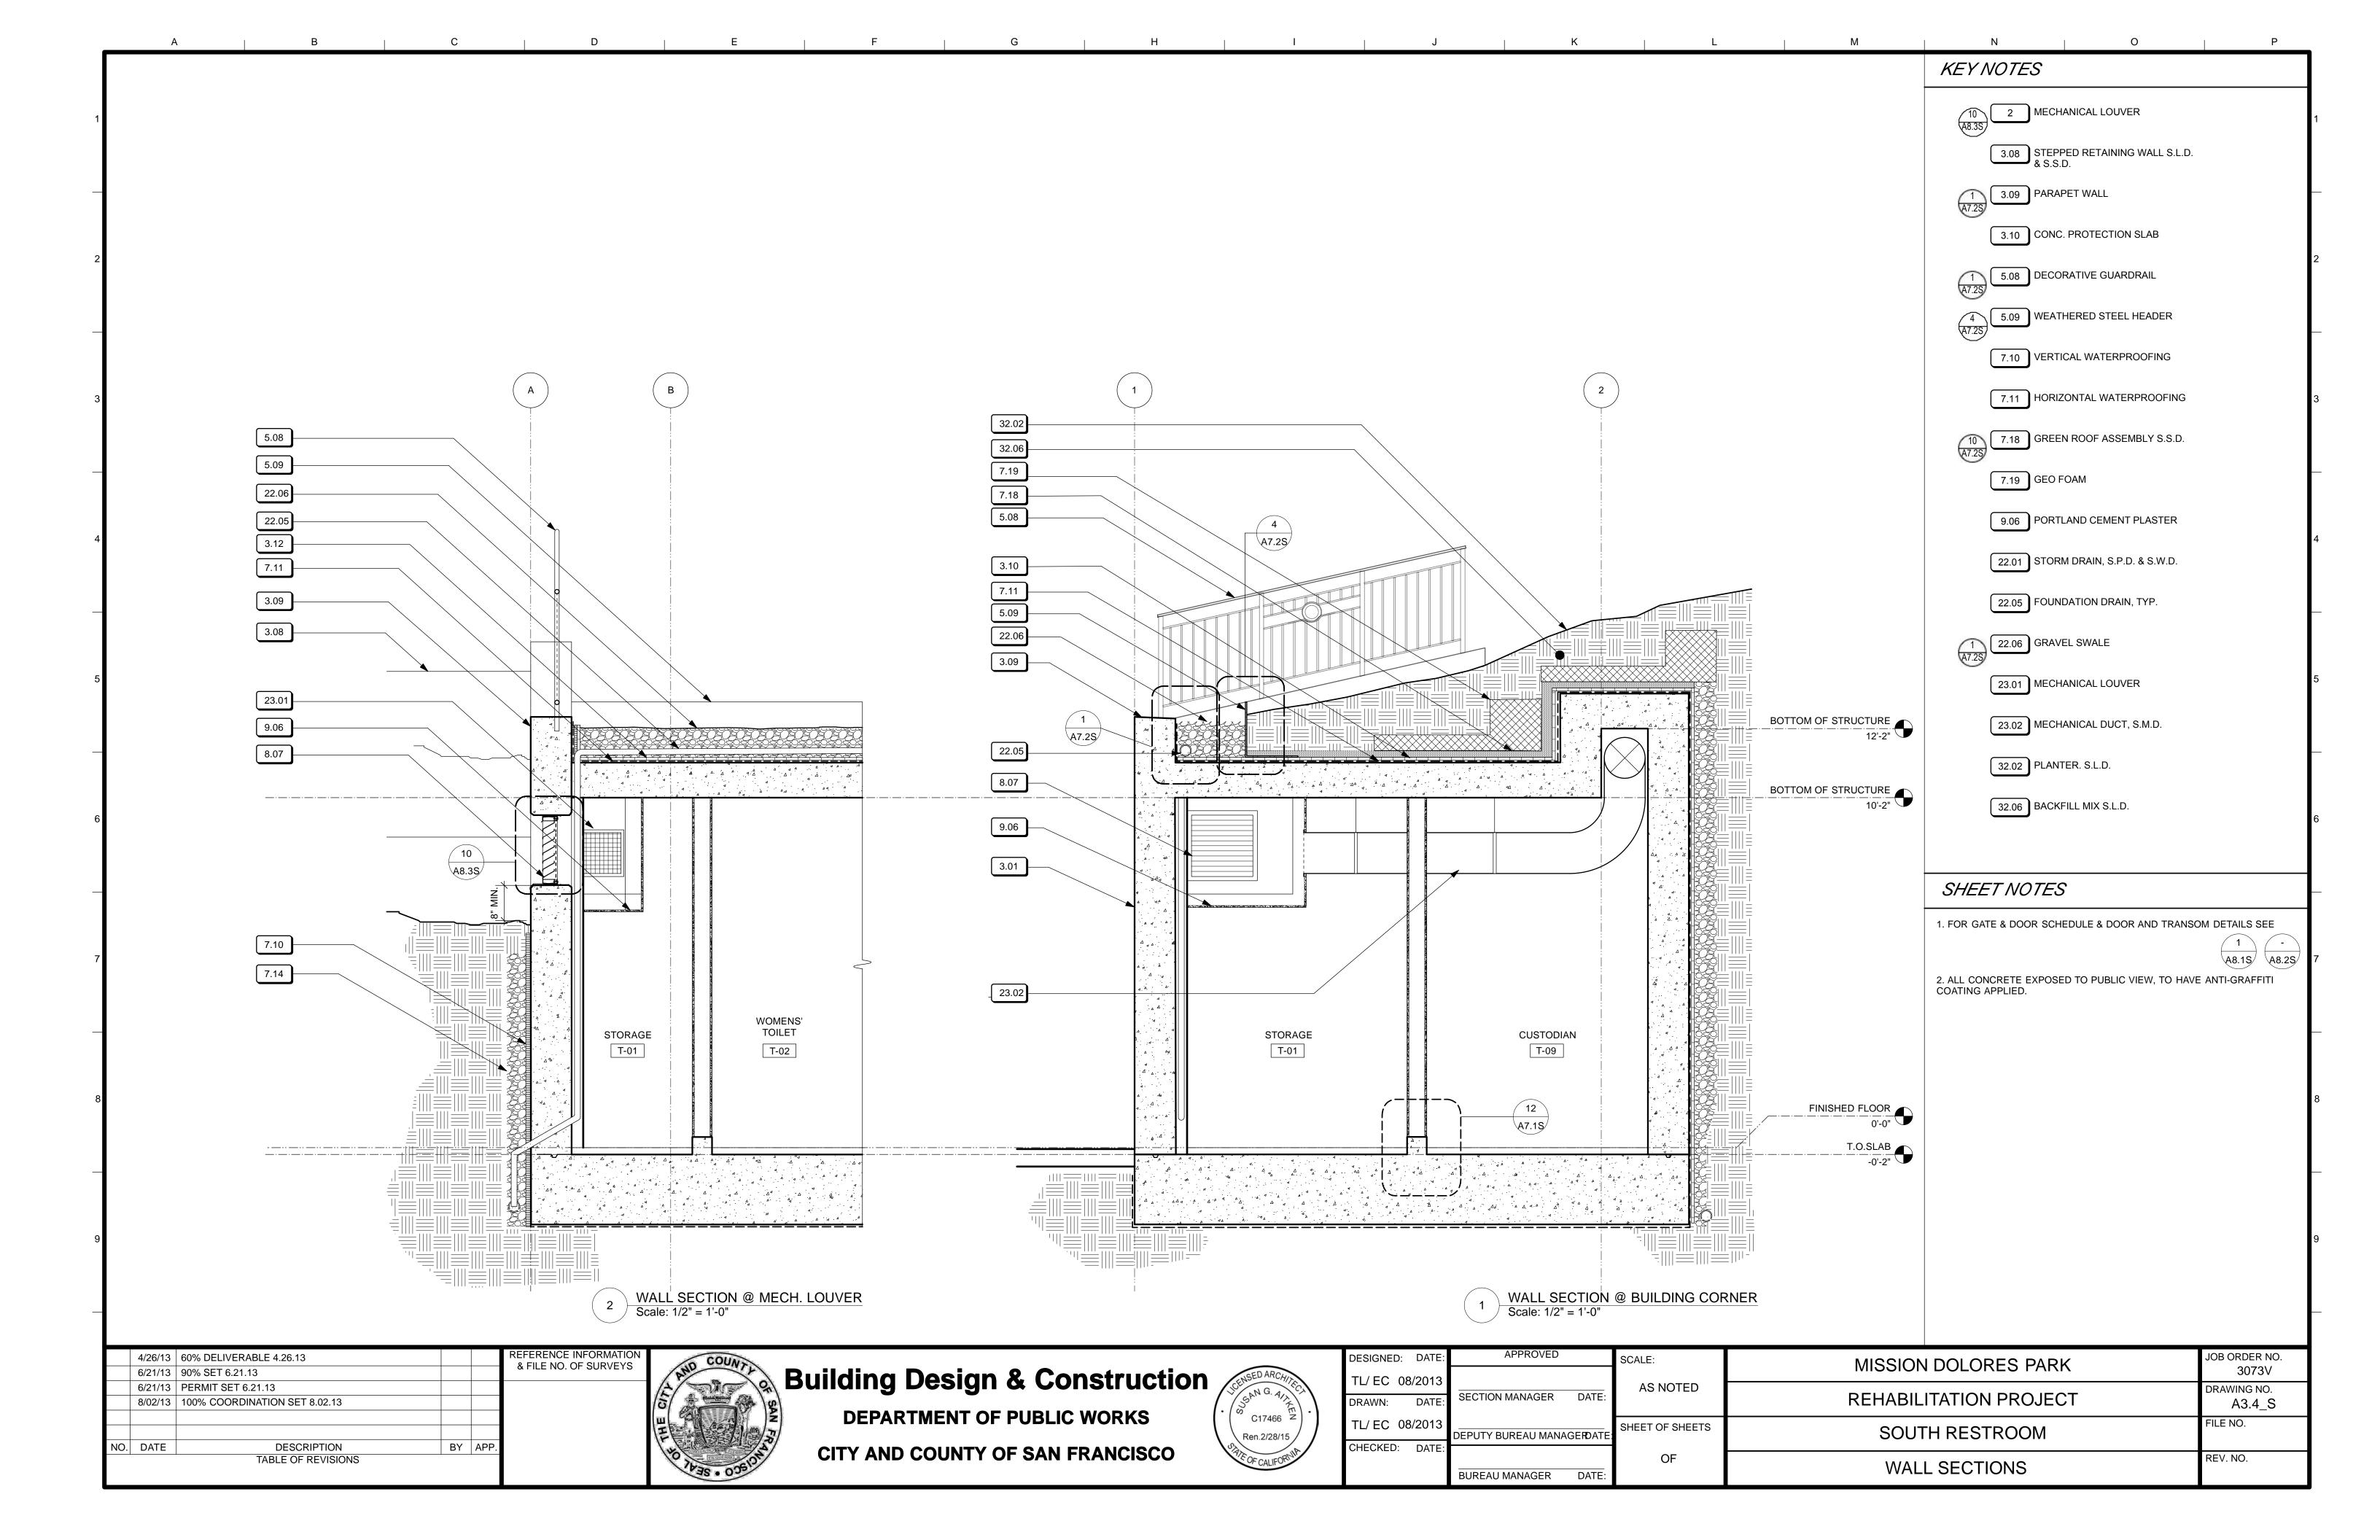


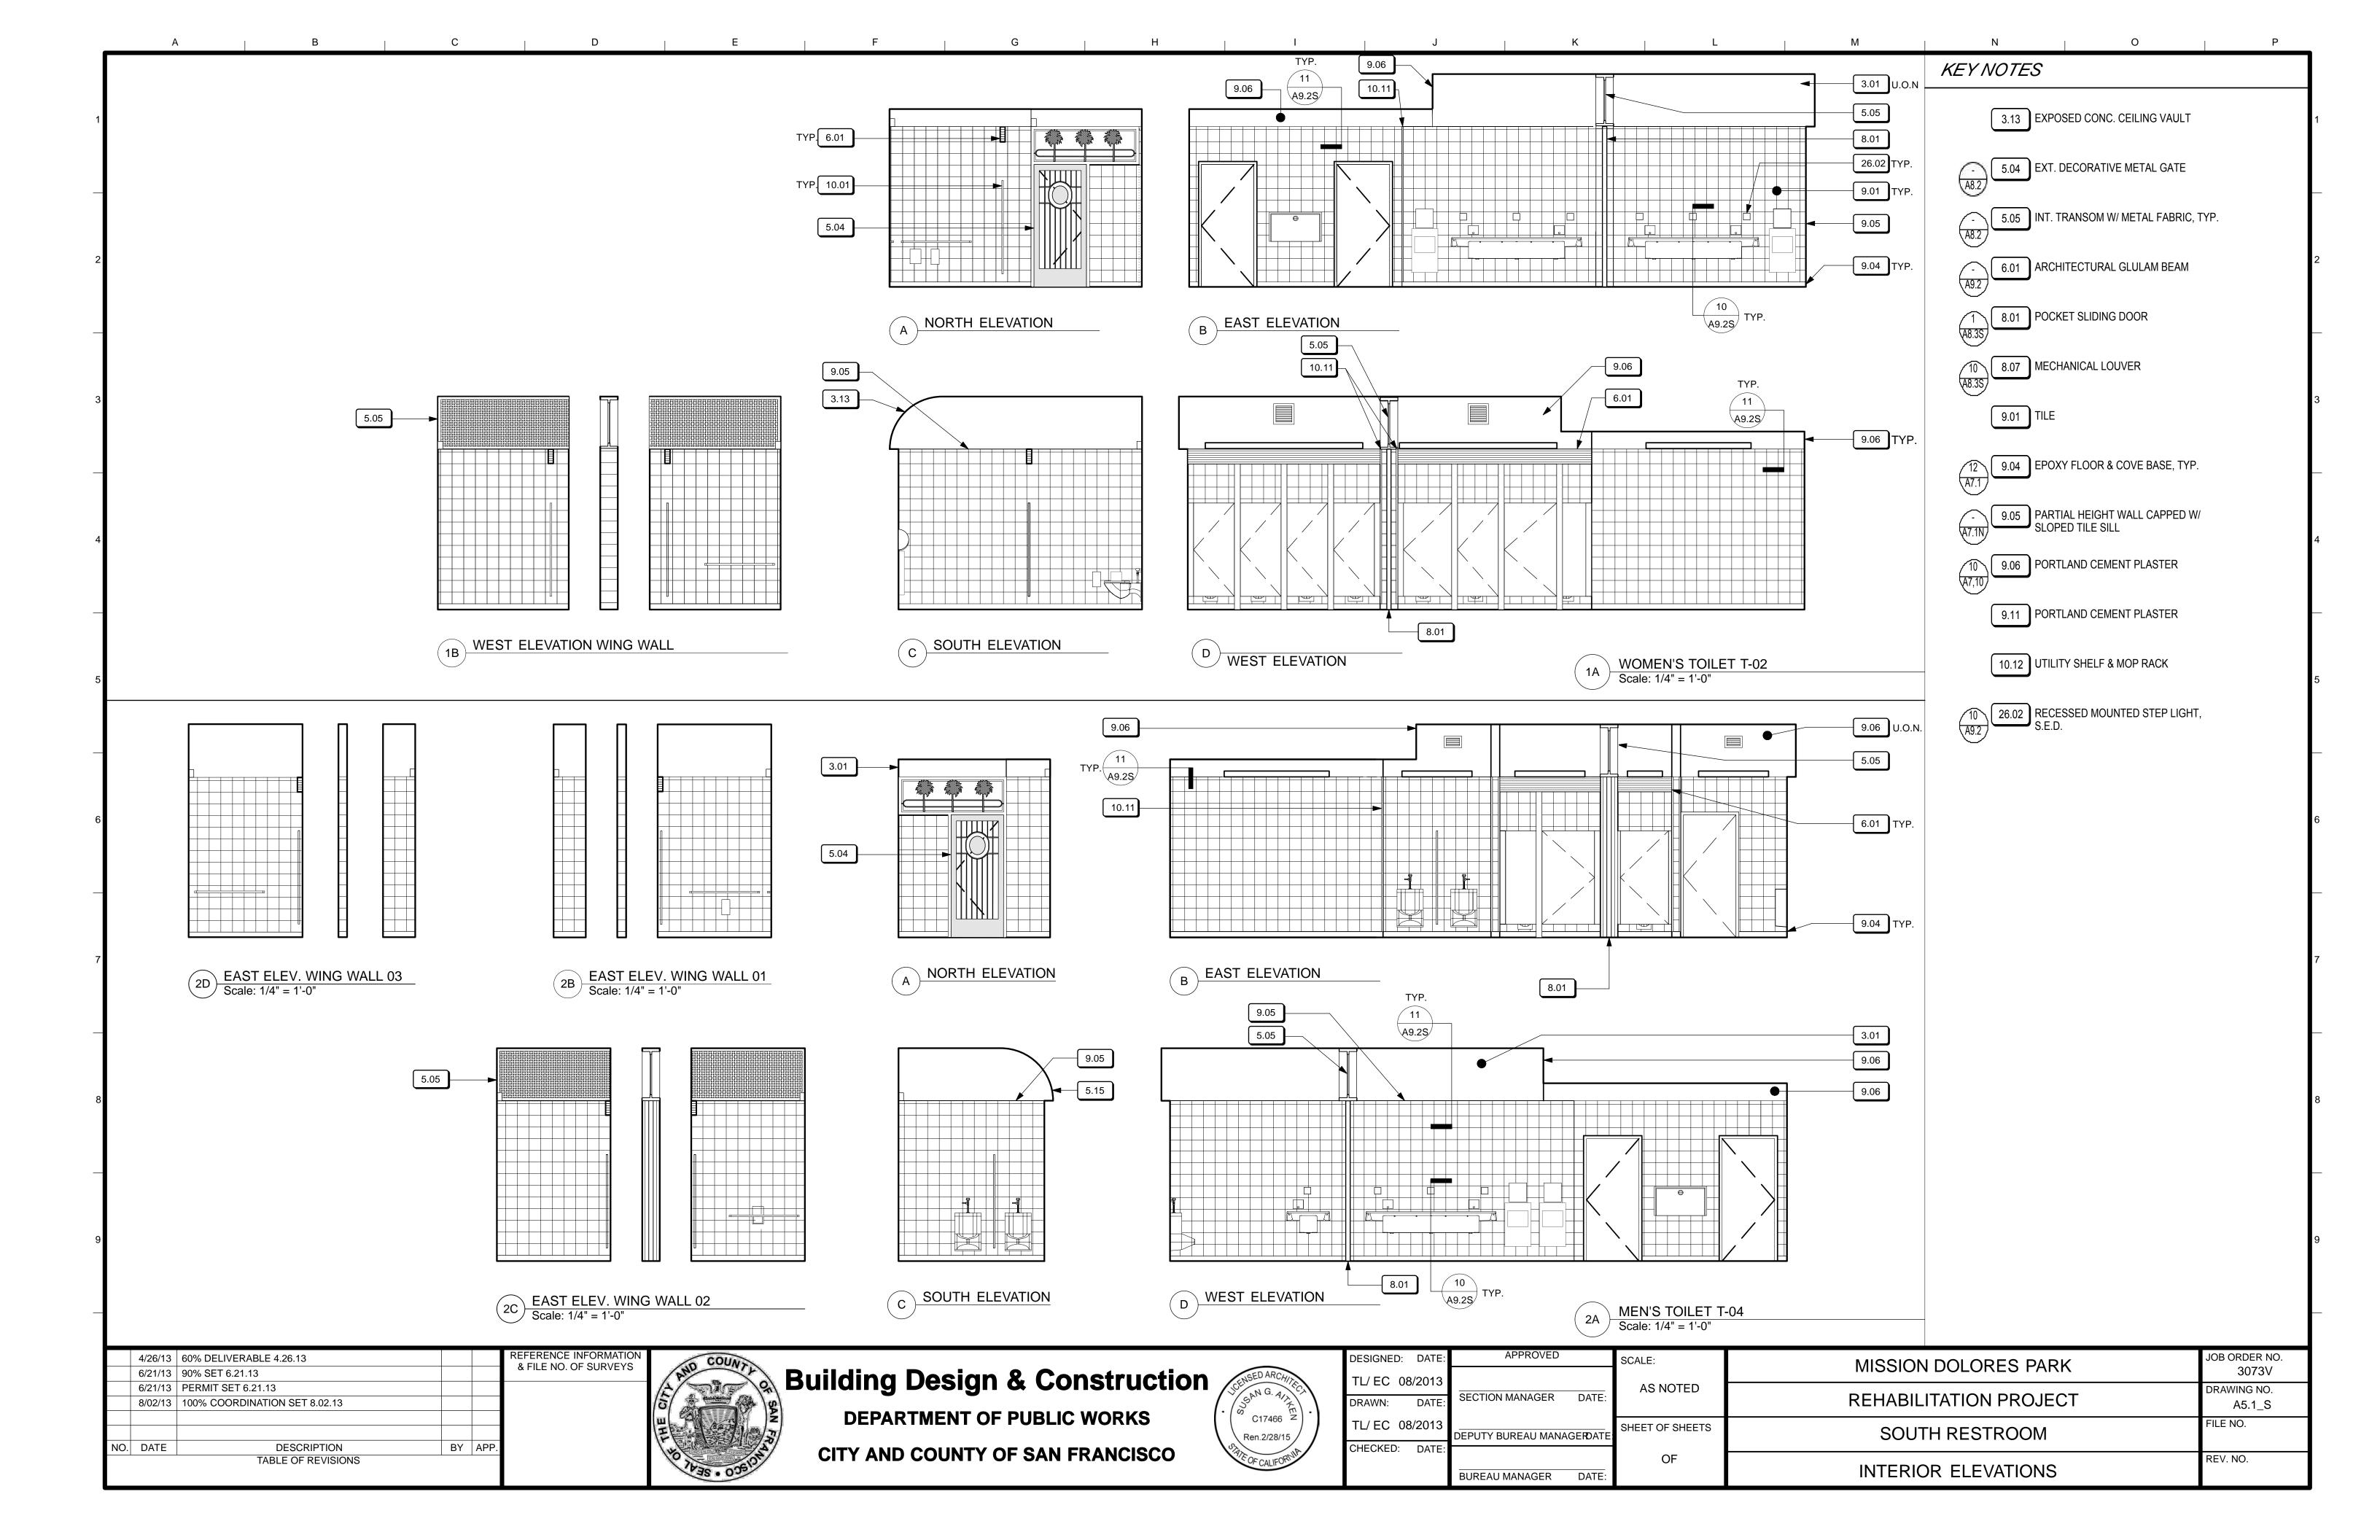


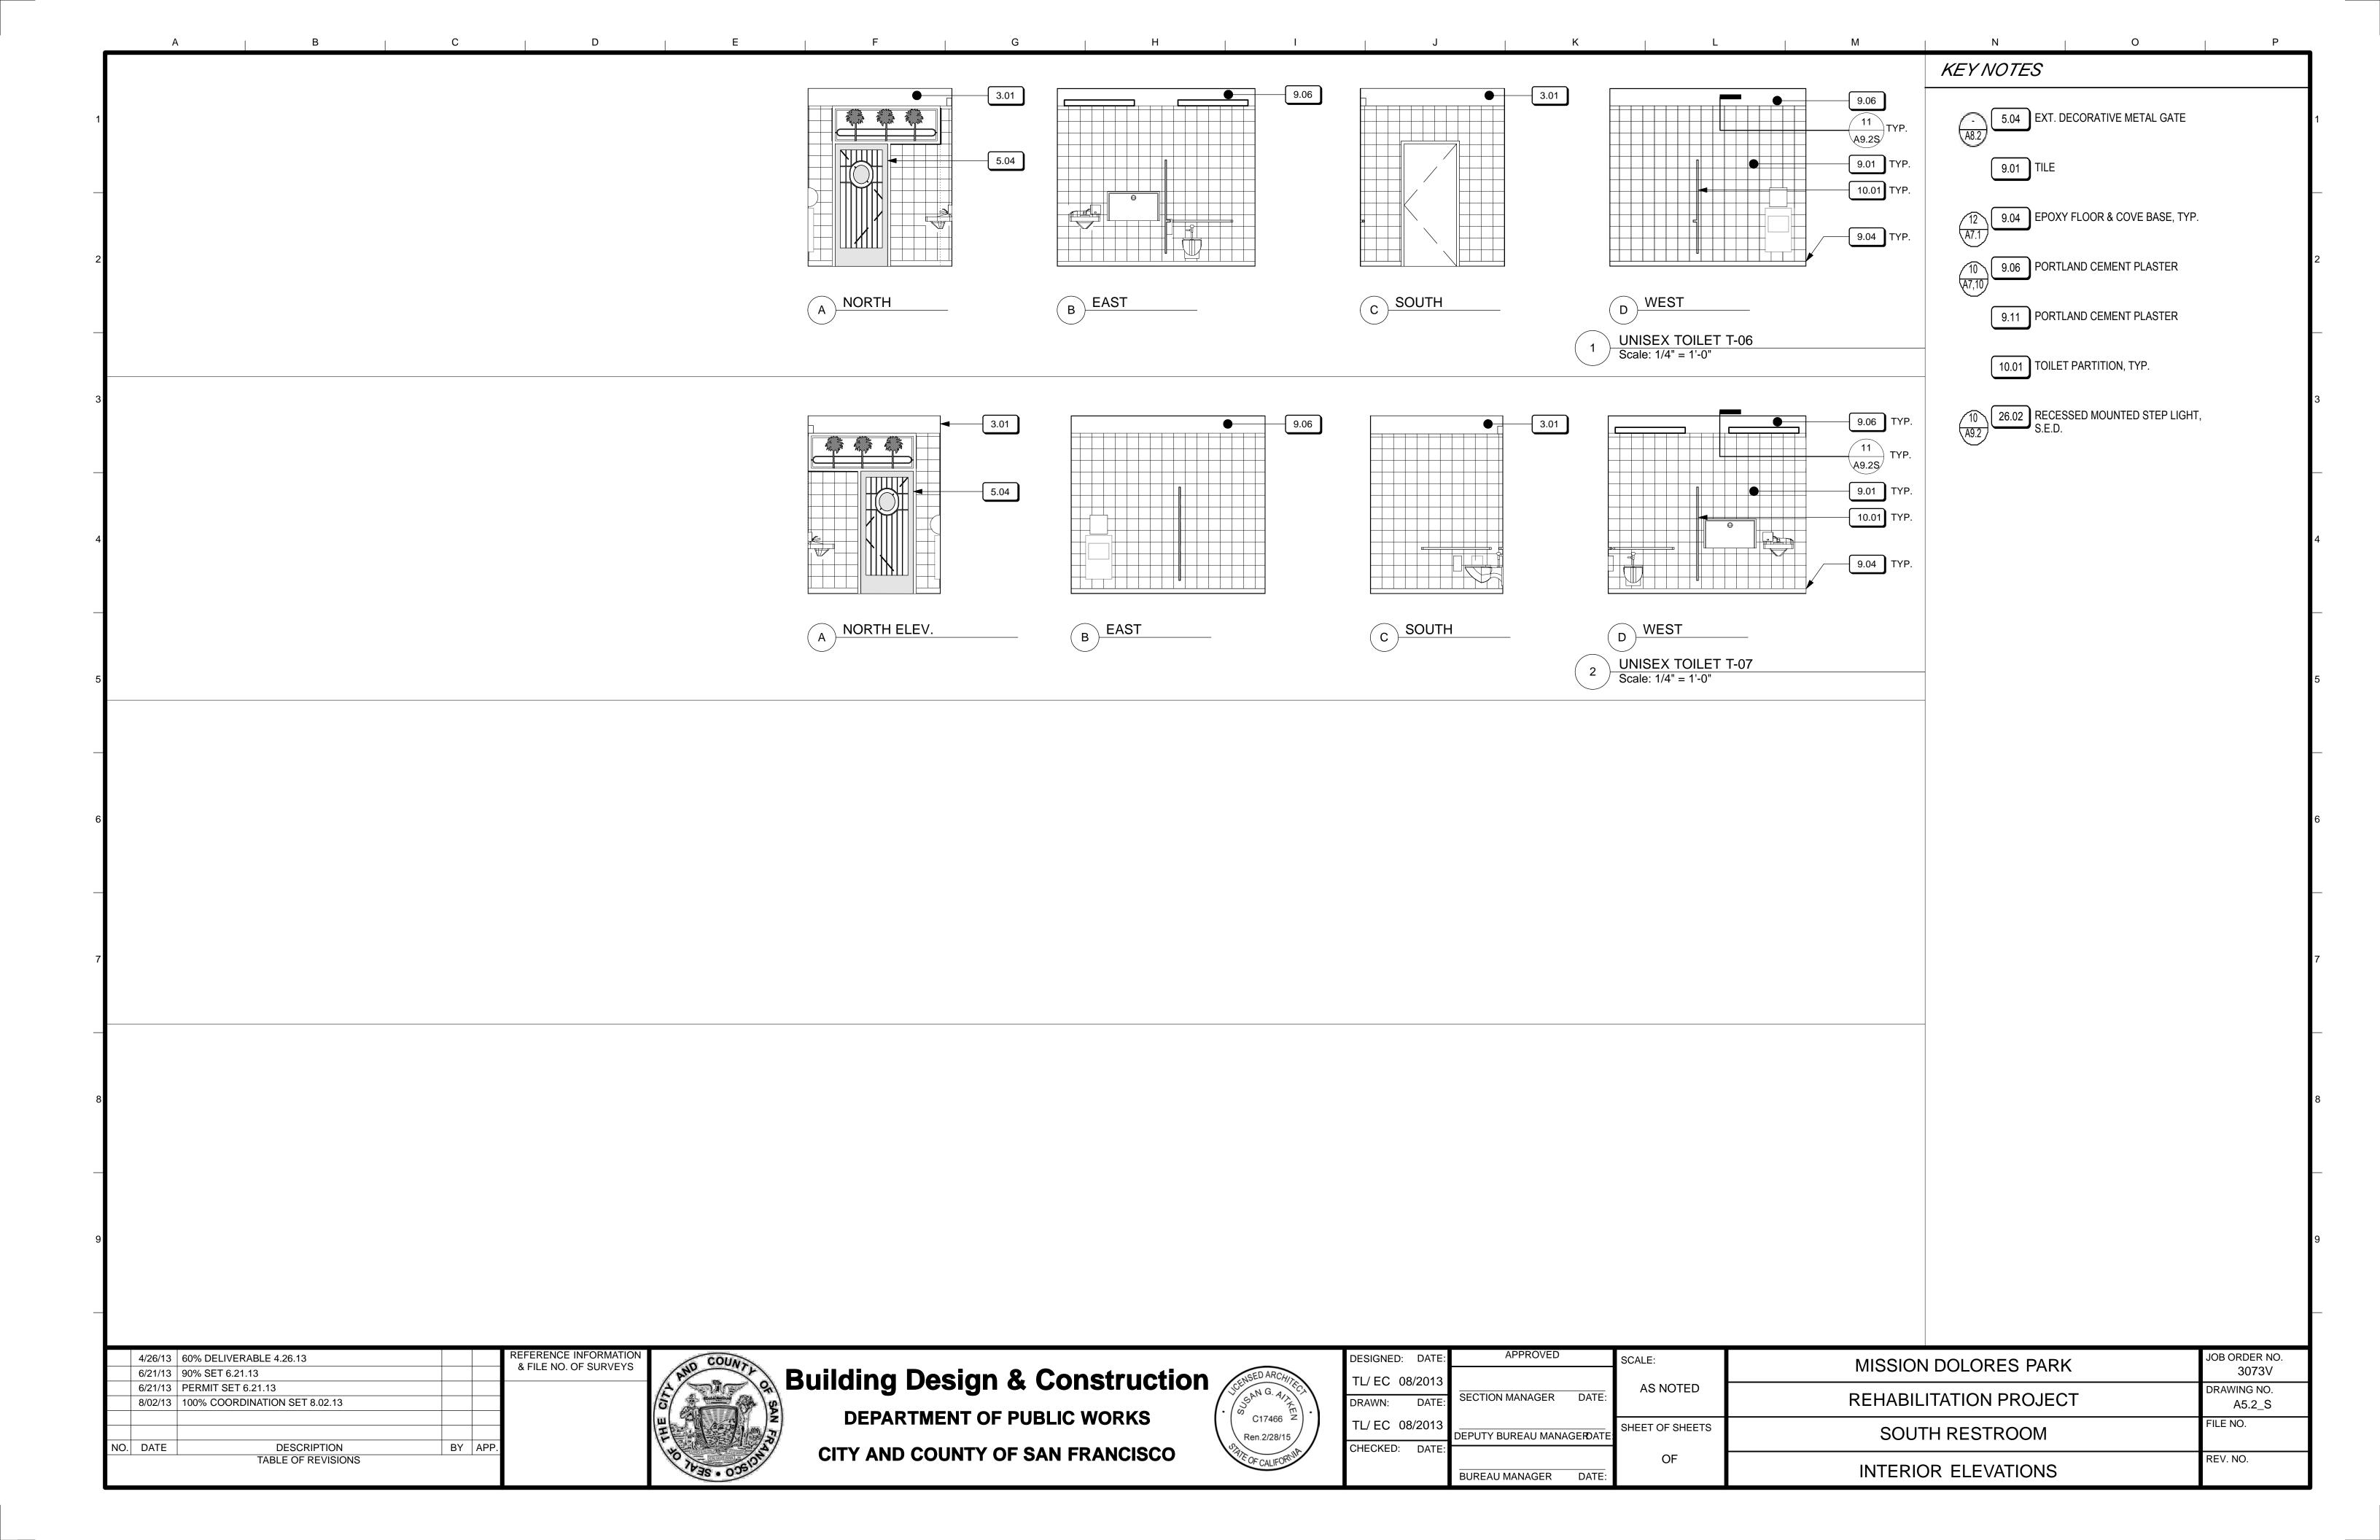

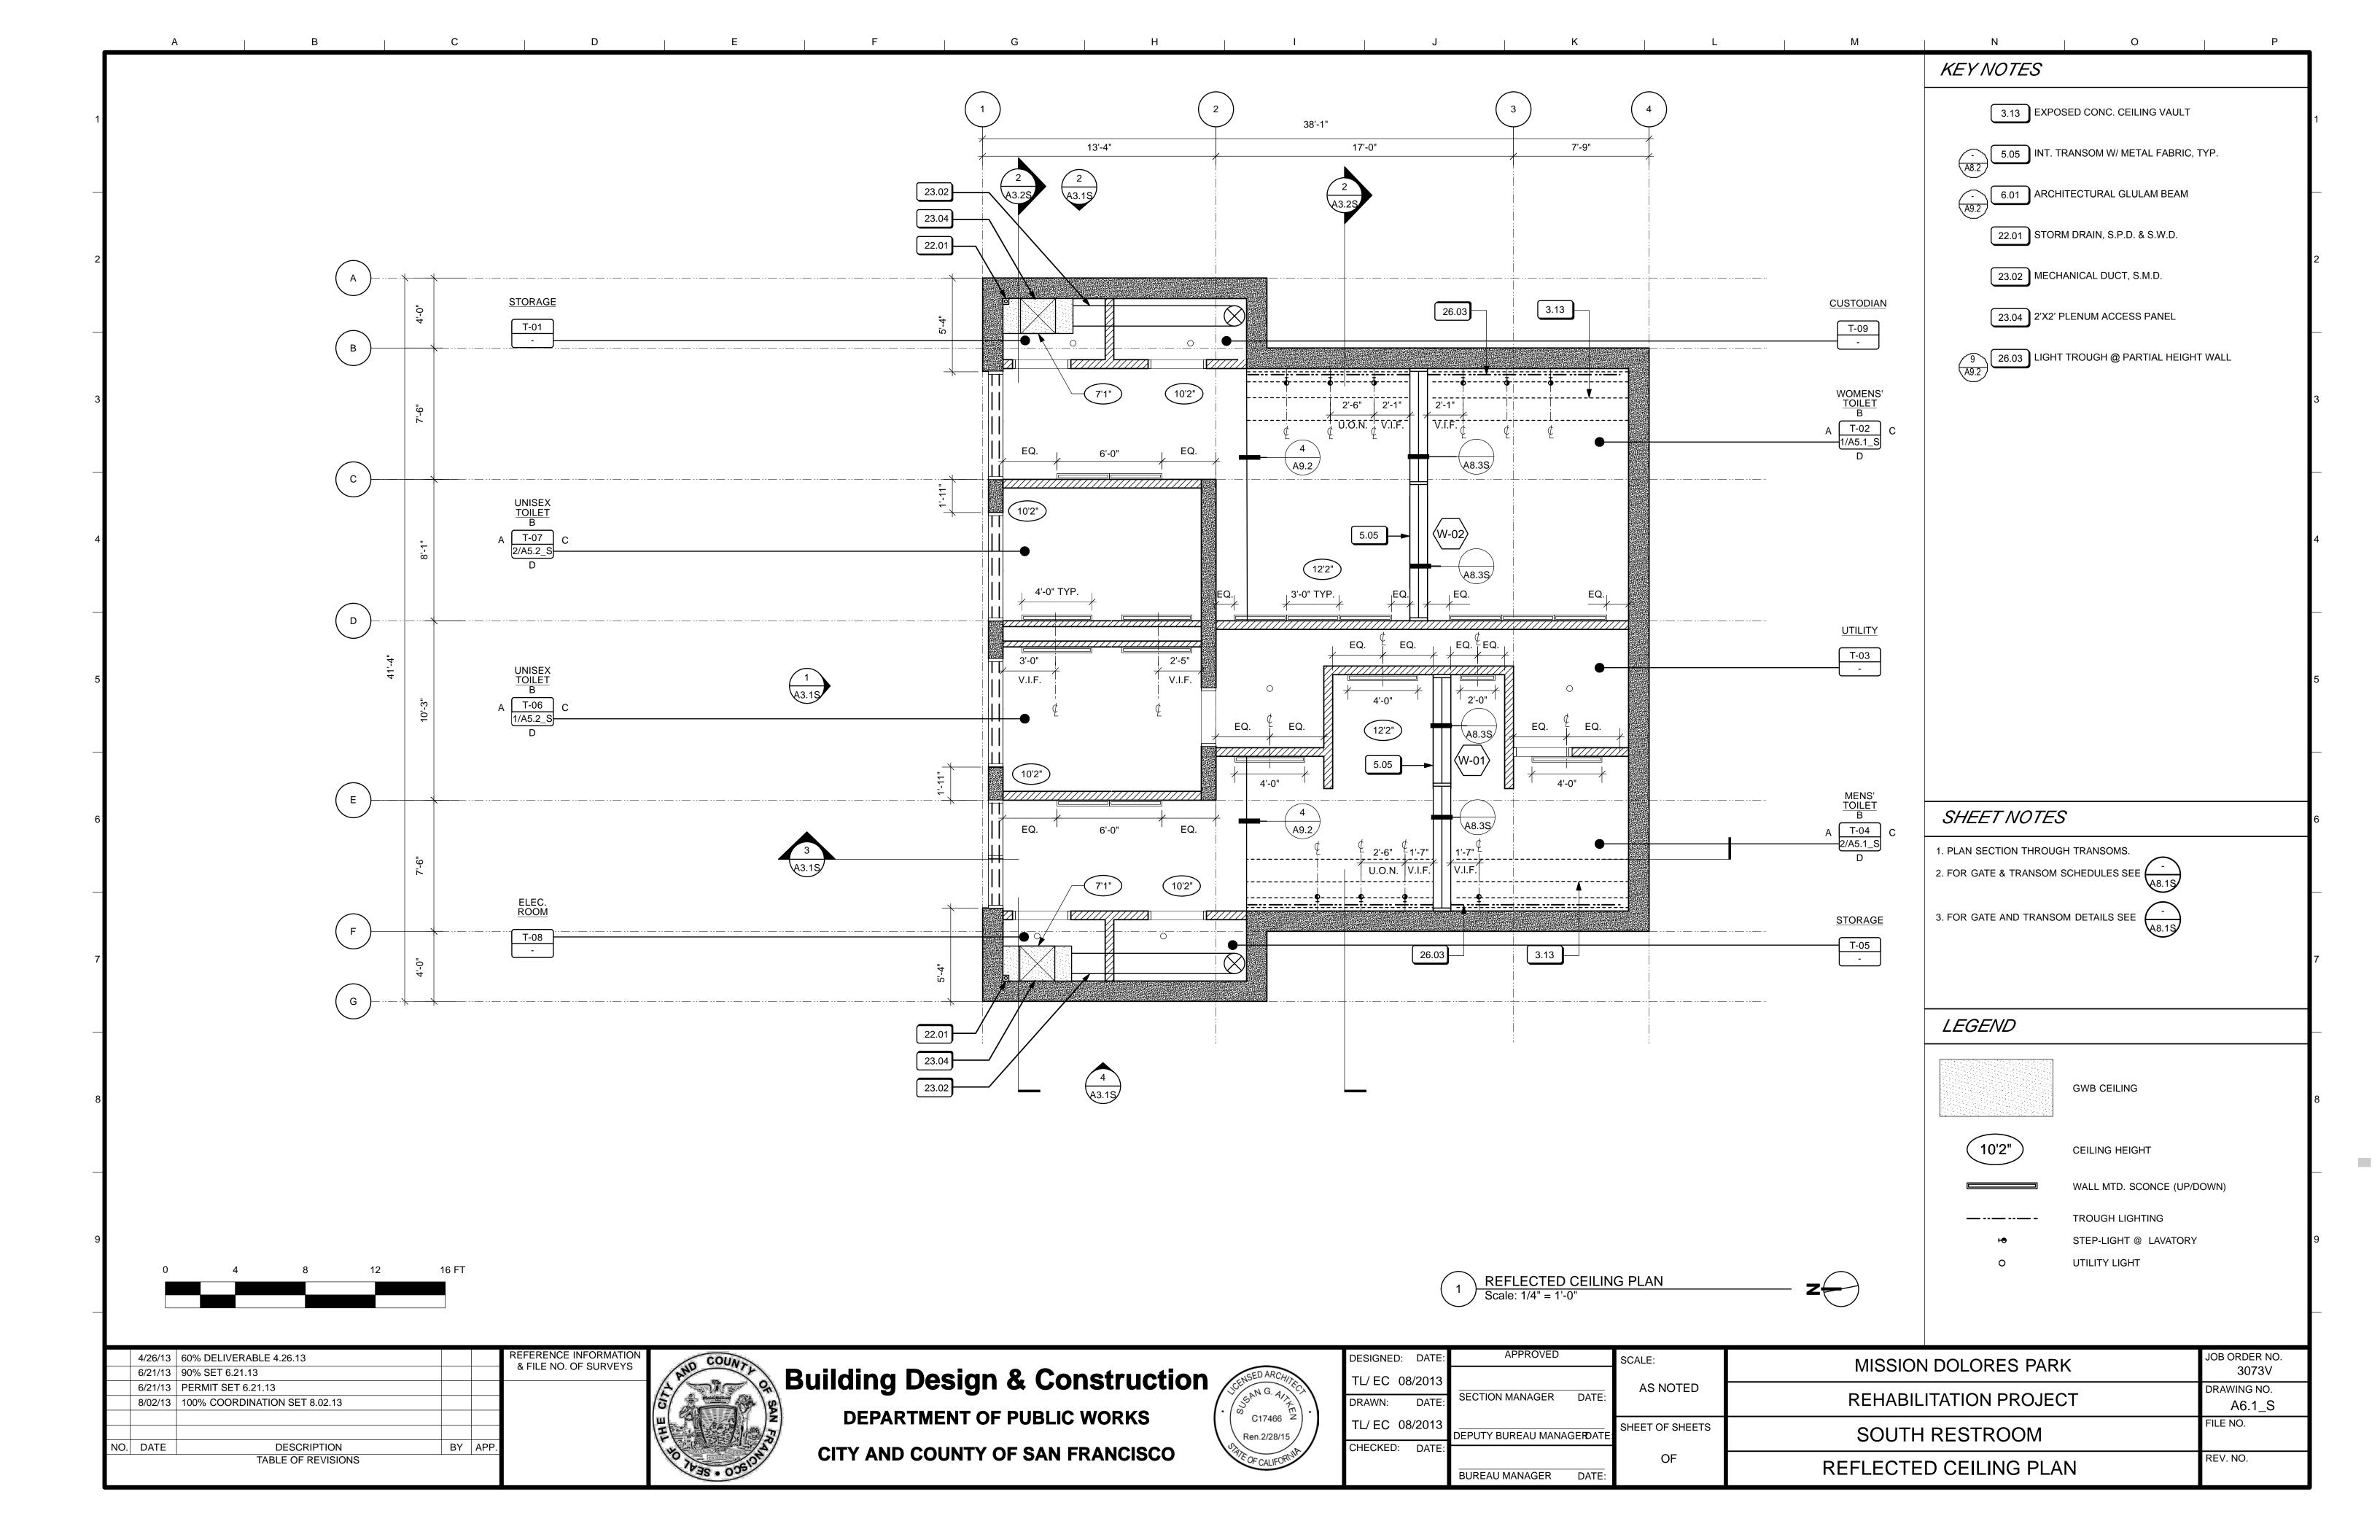

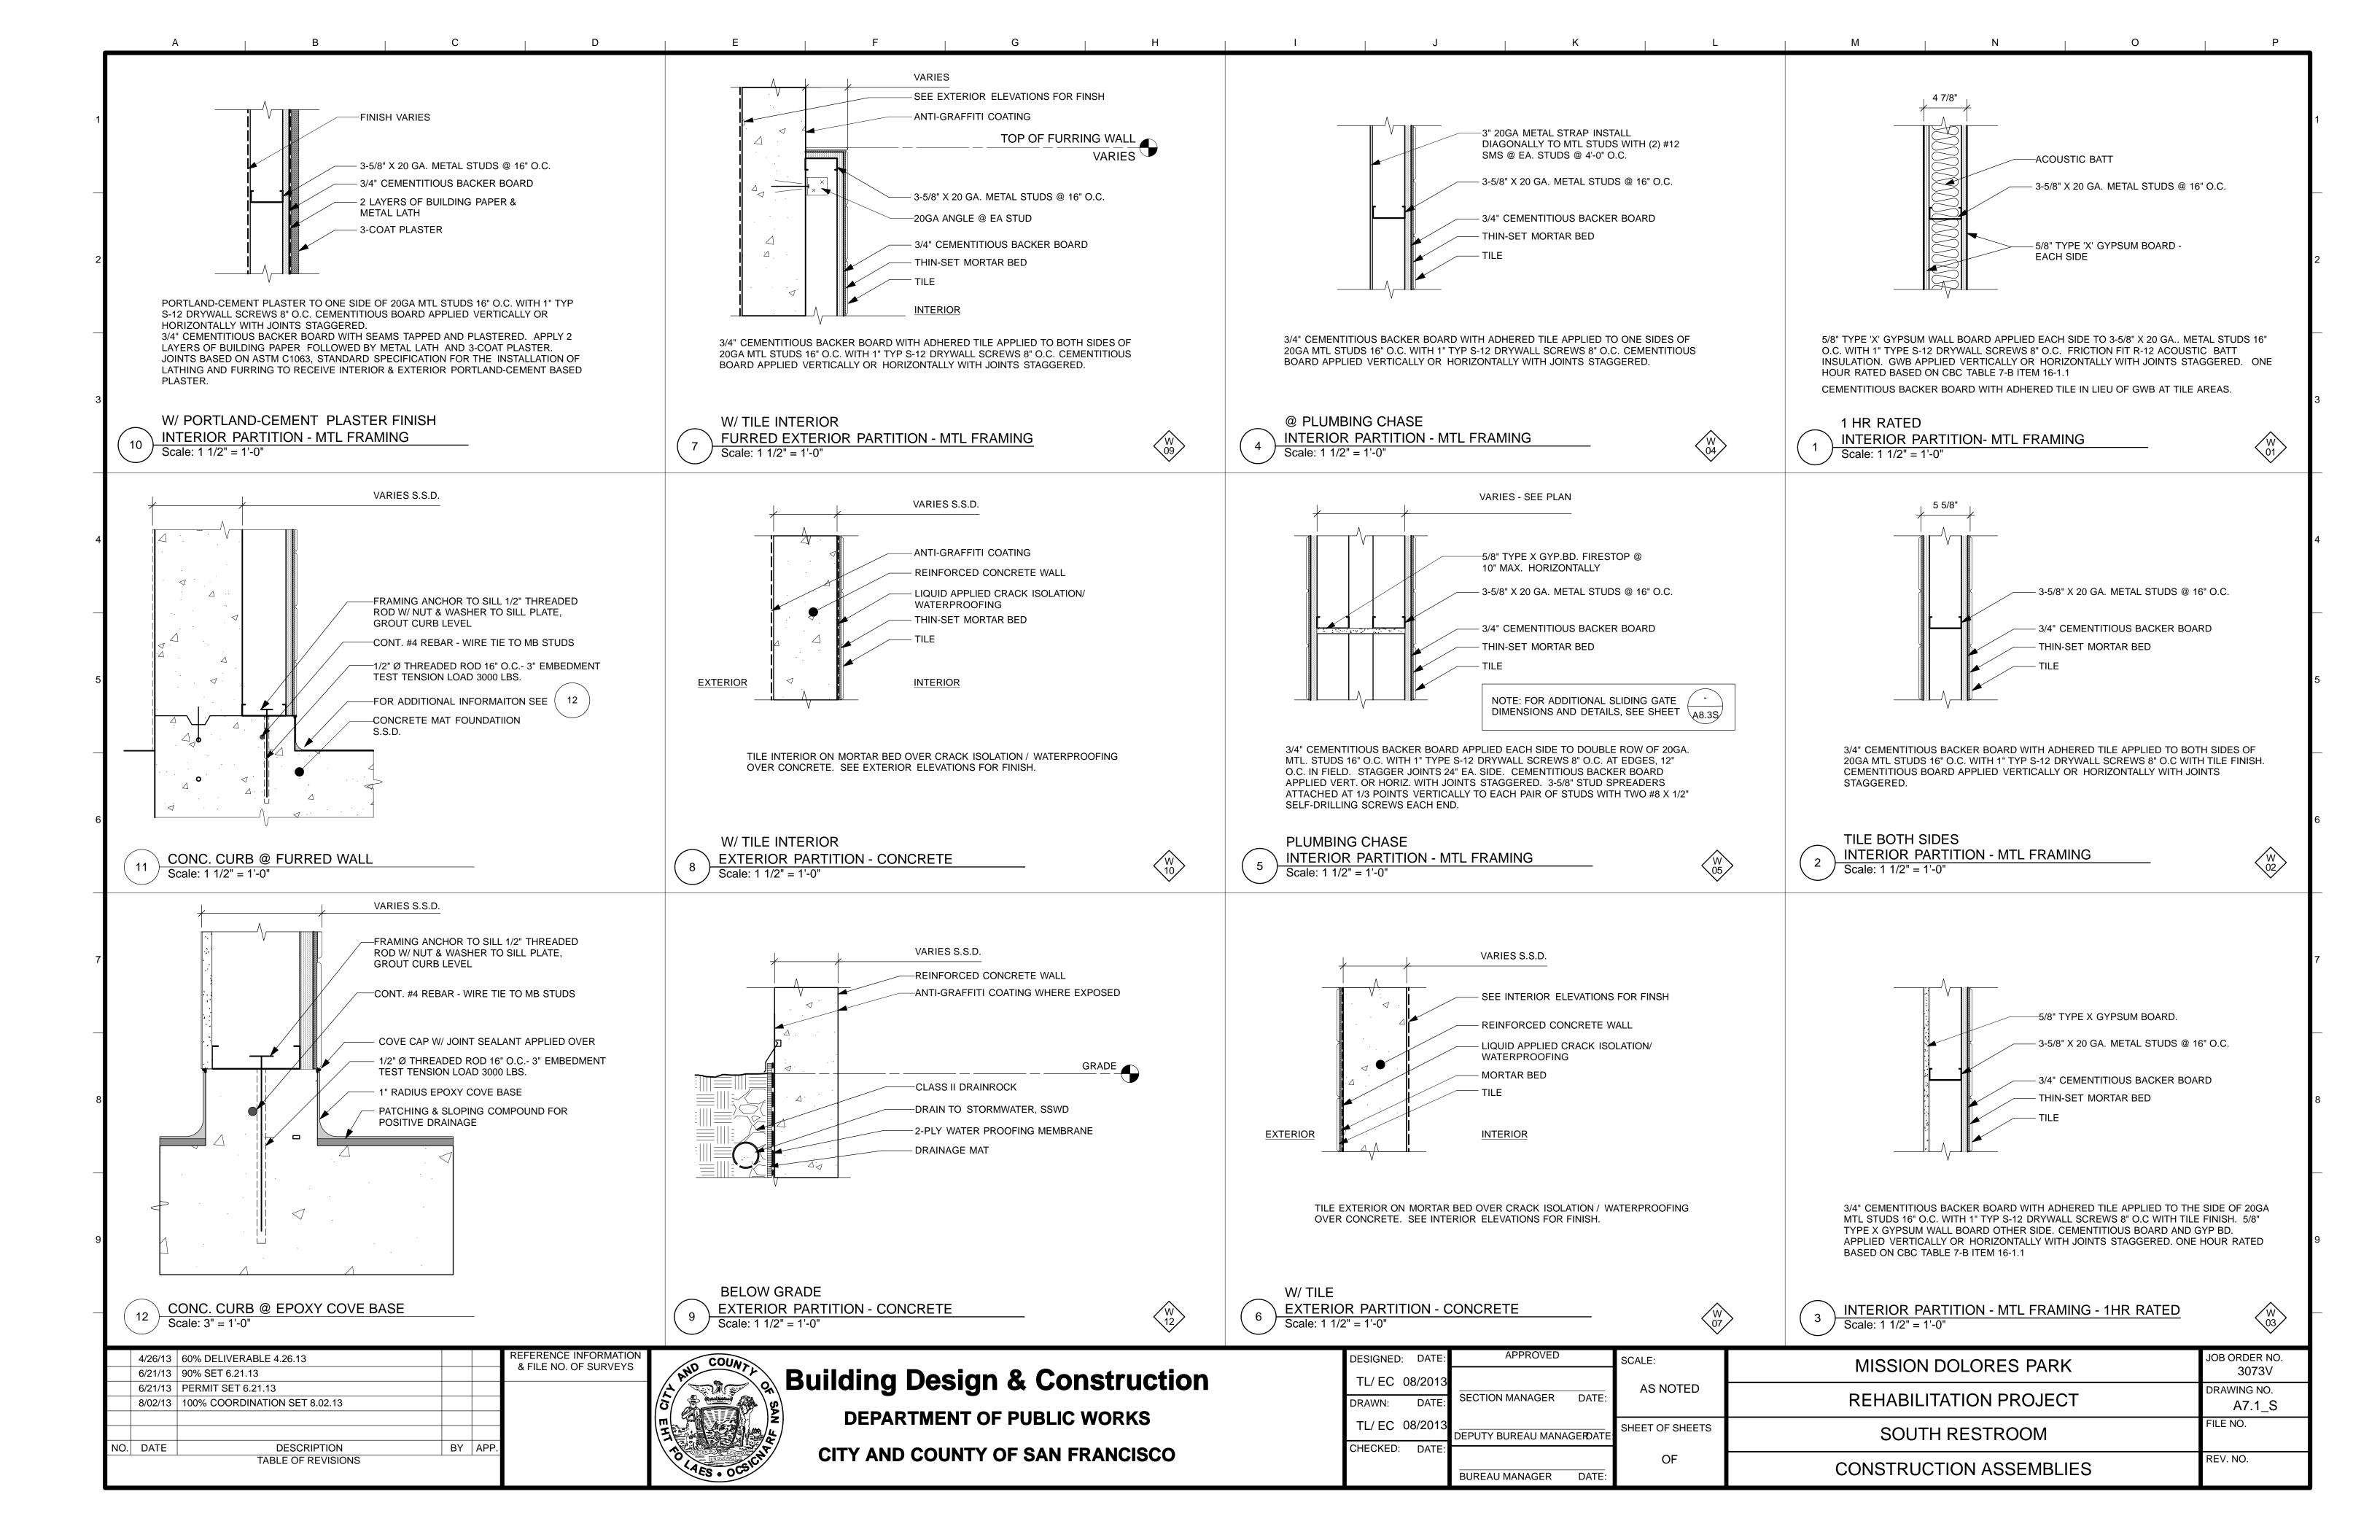

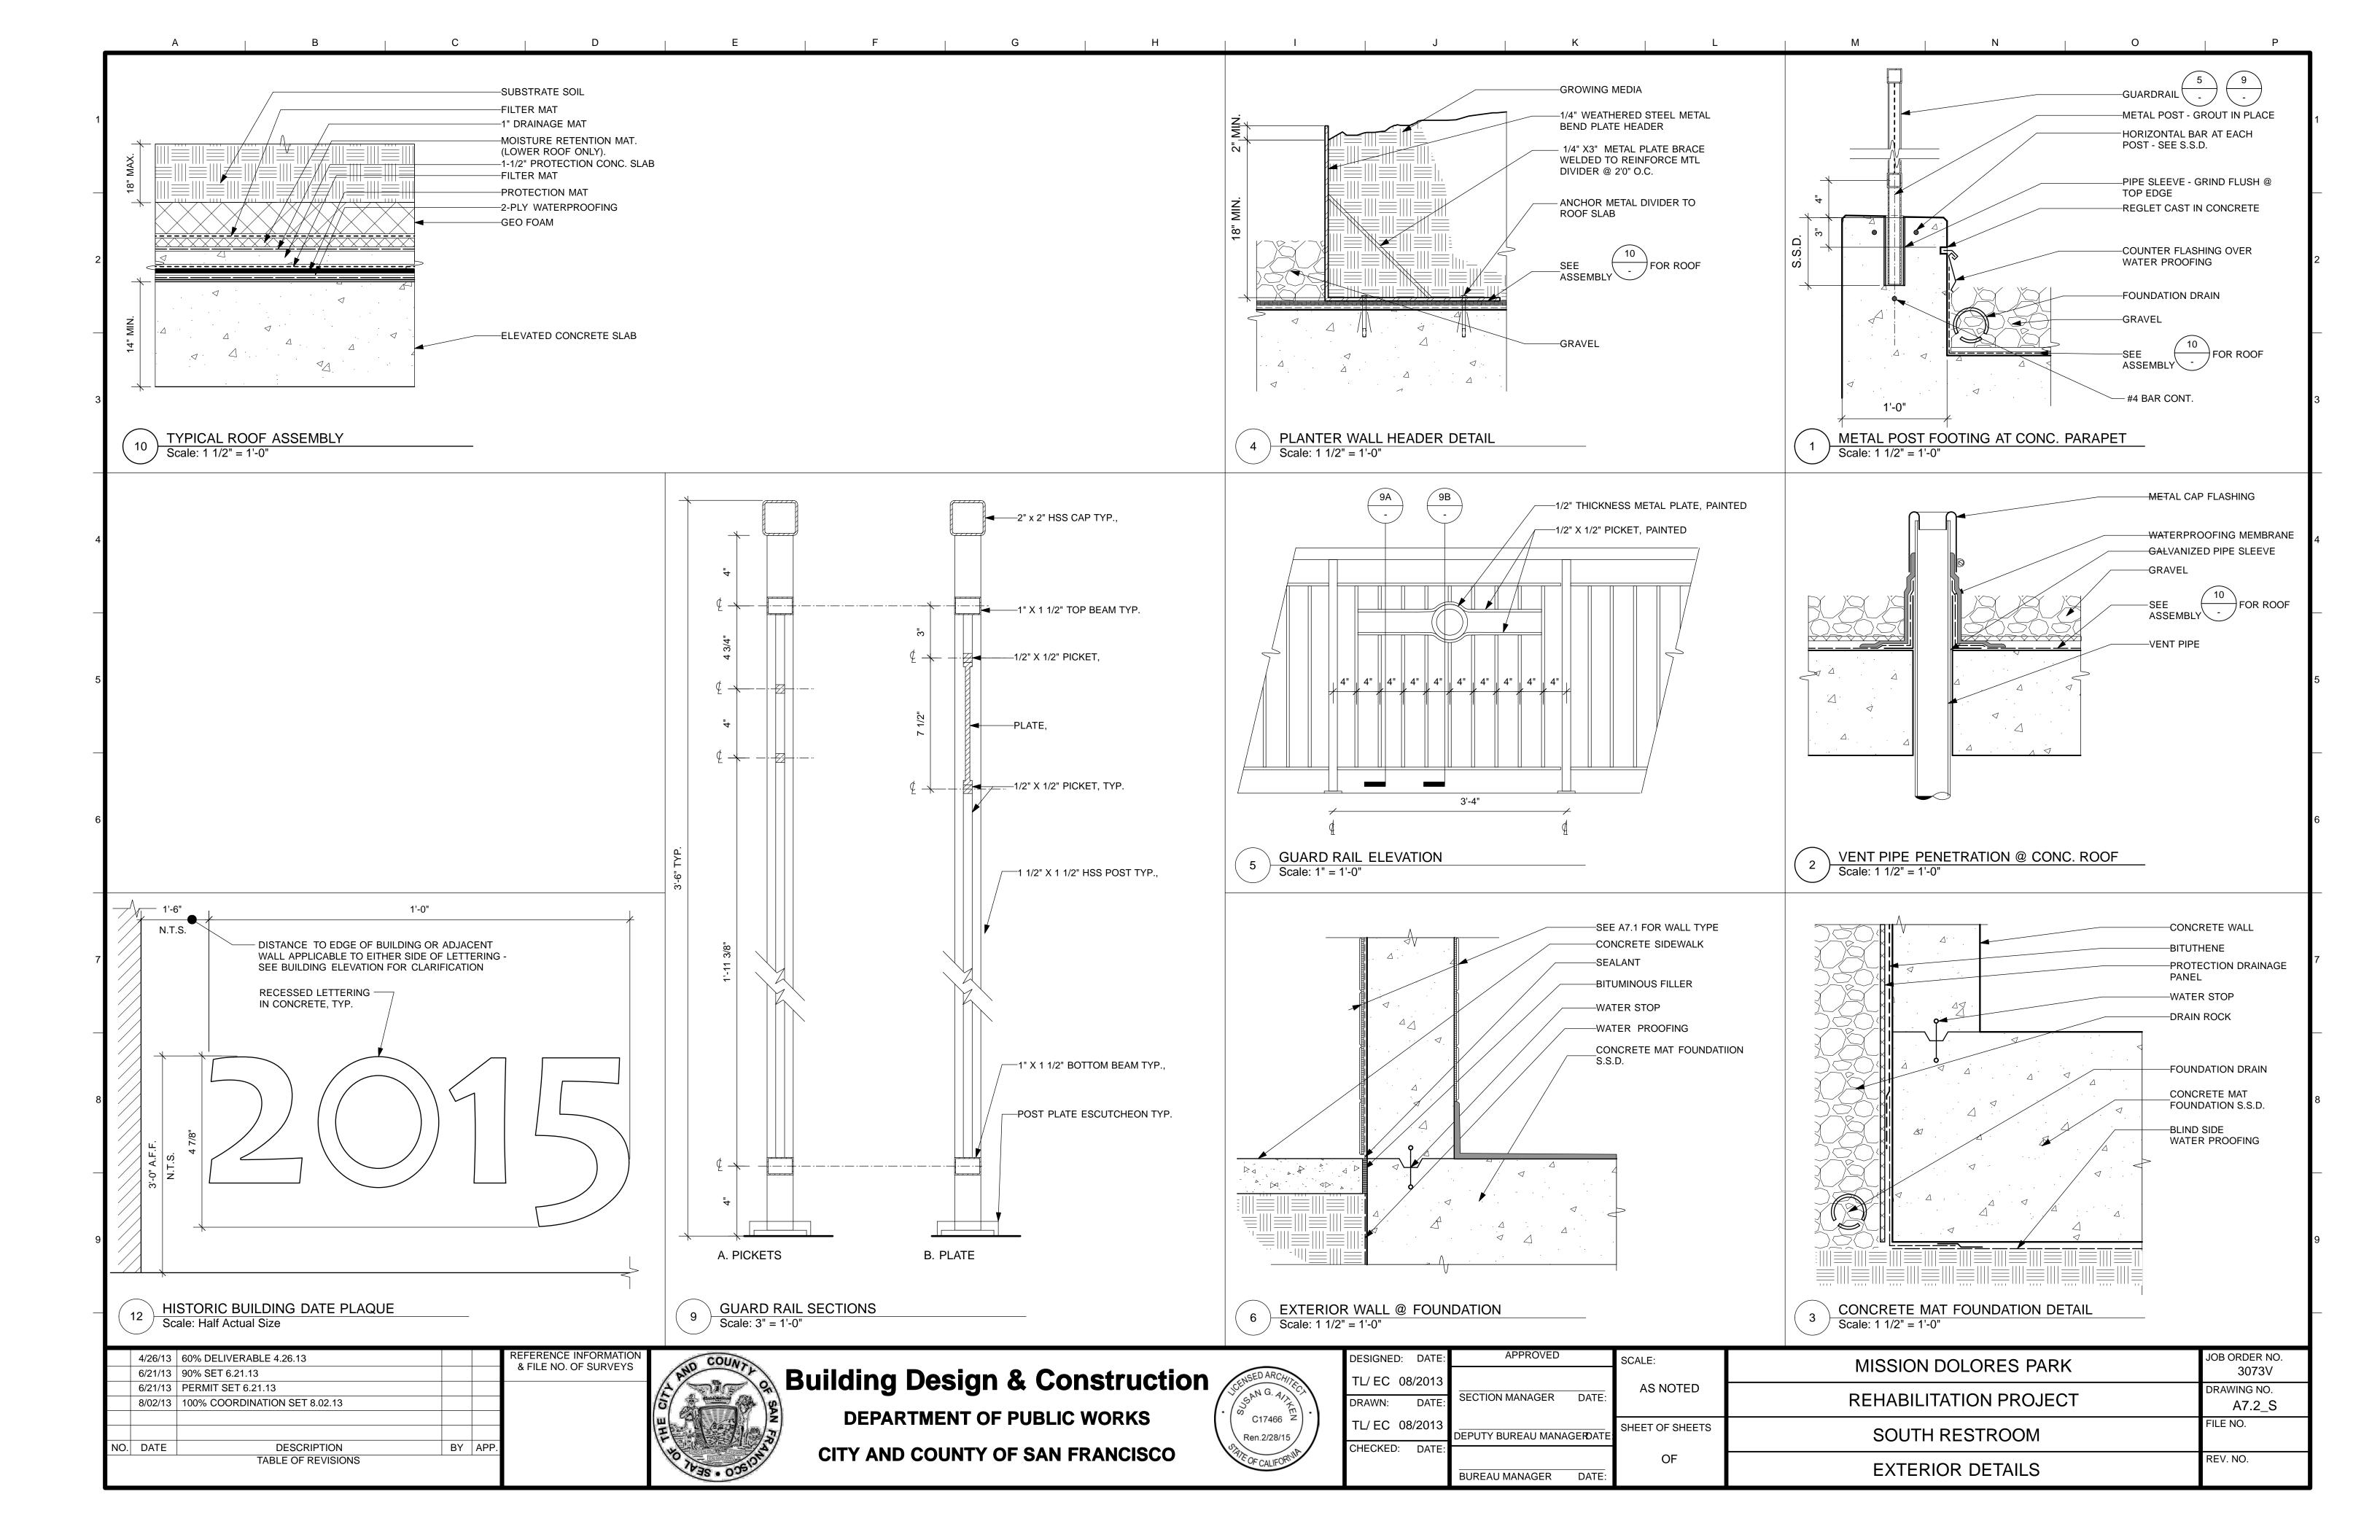

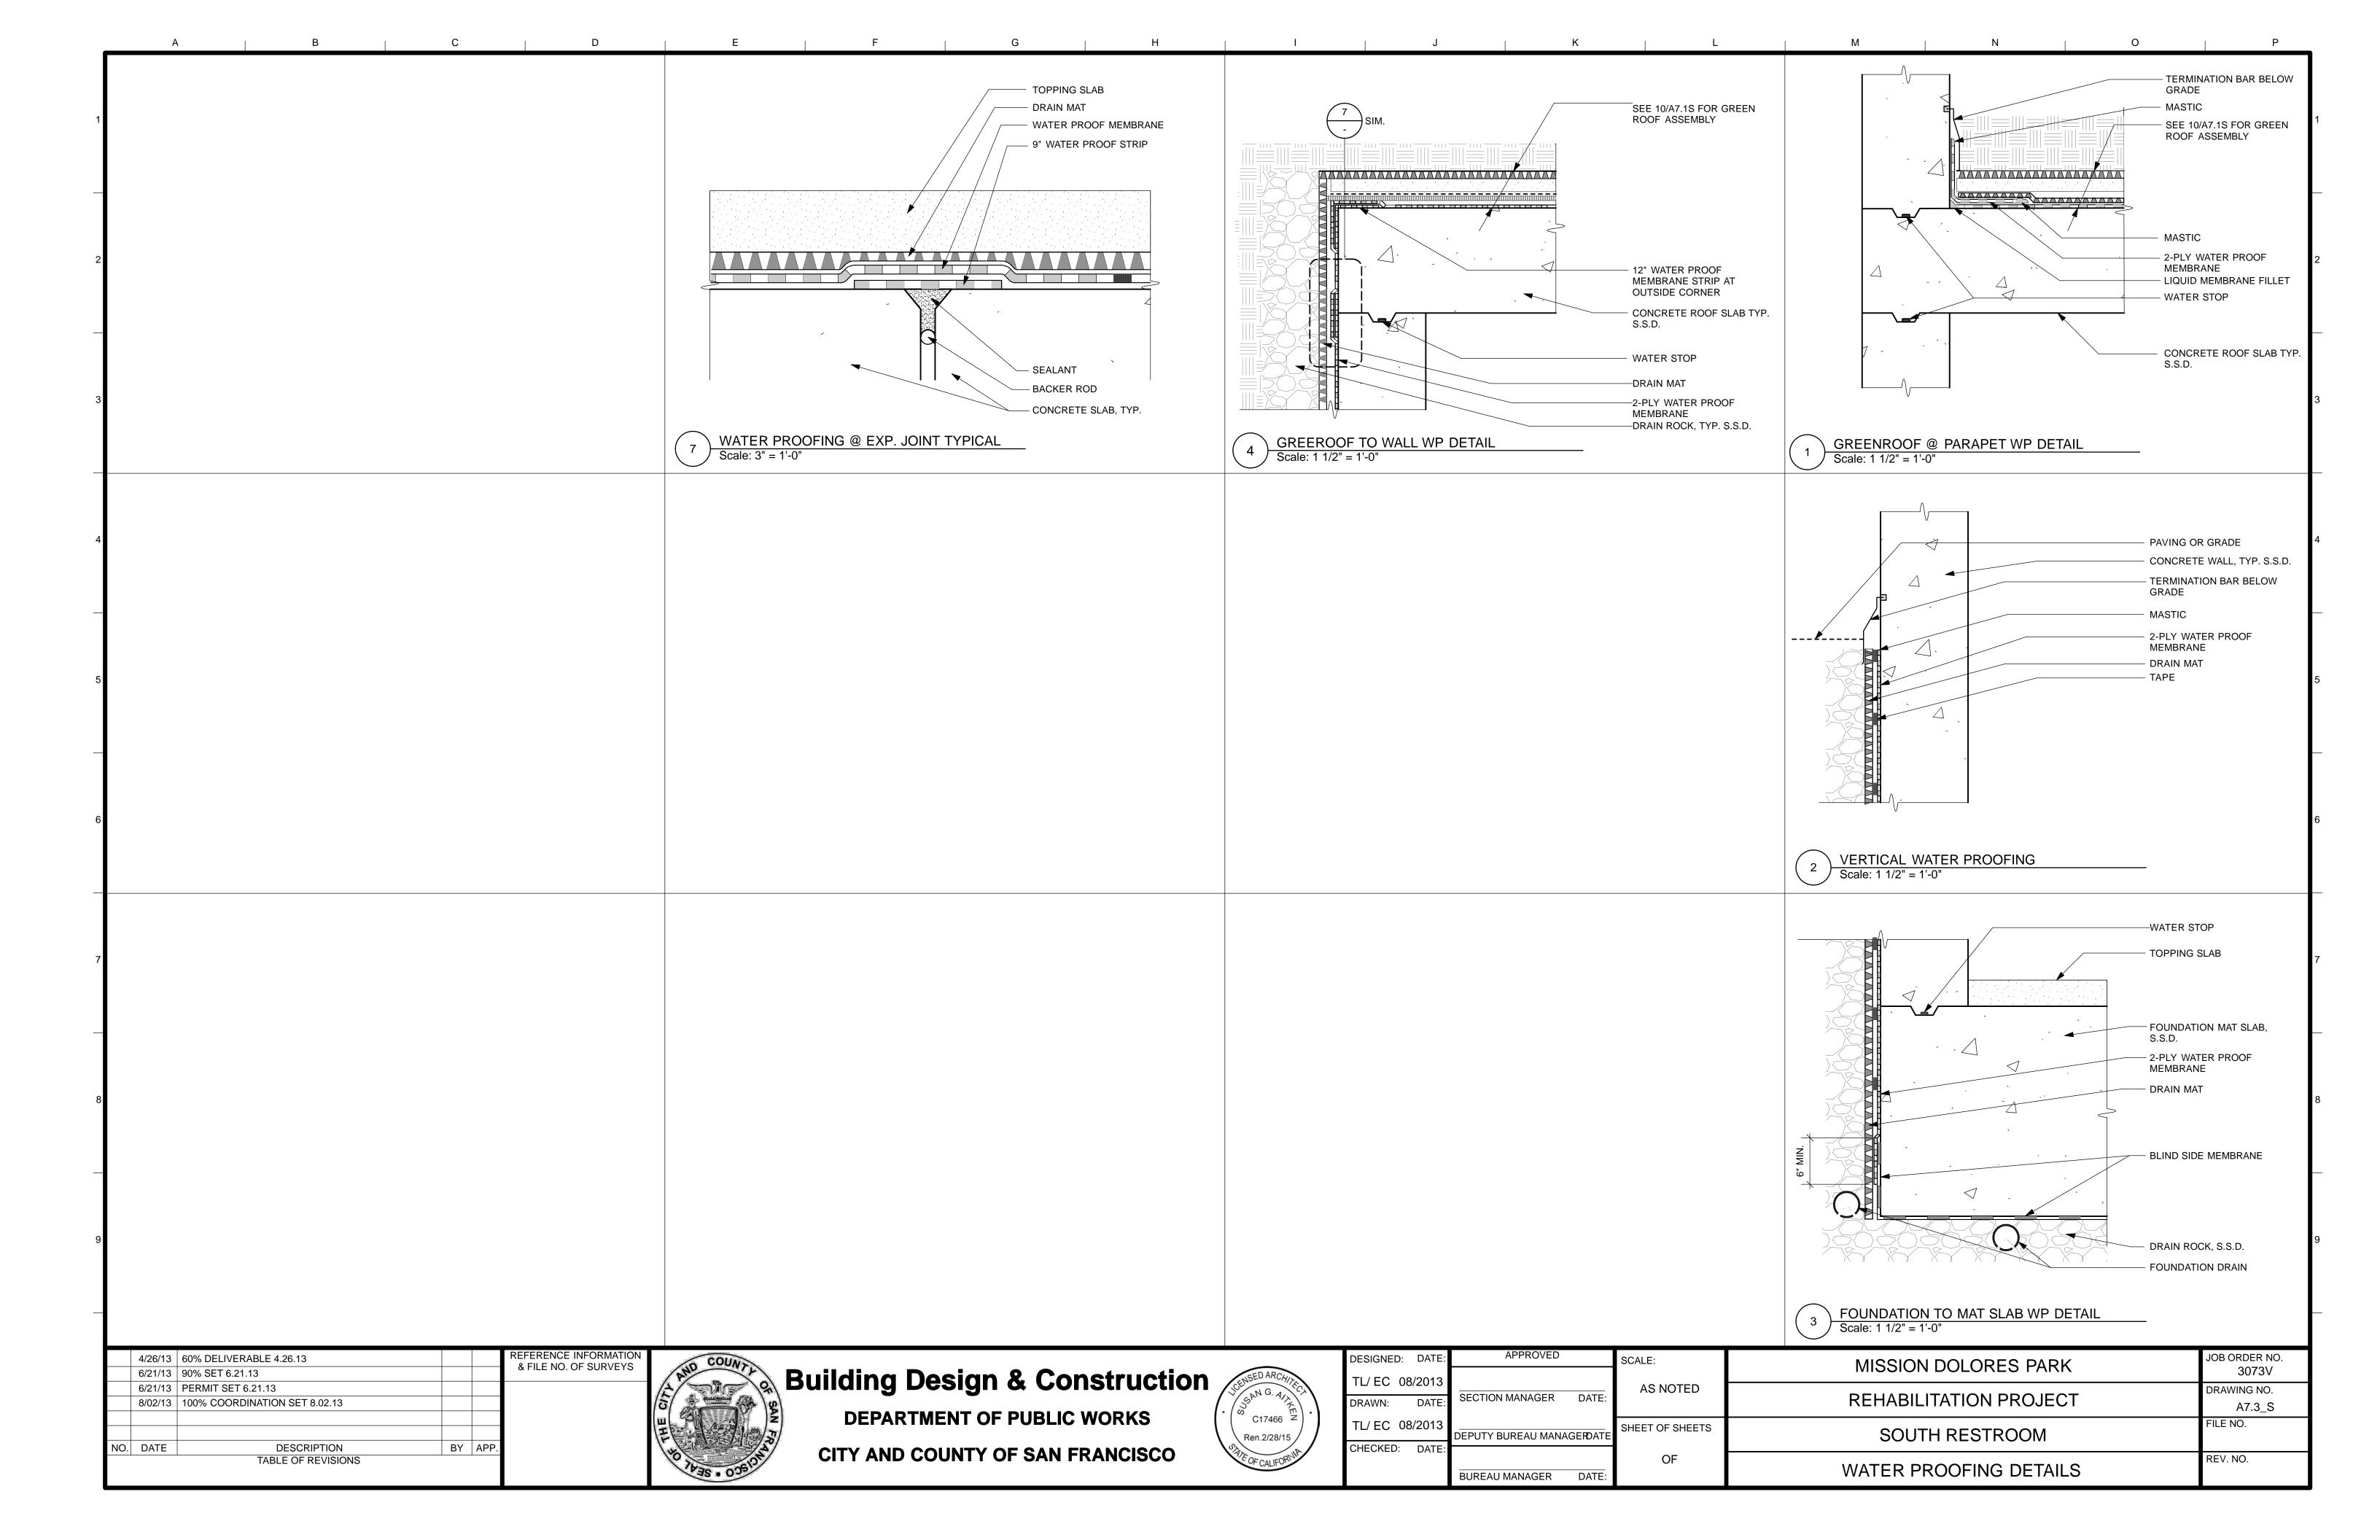

# TRANSOM SCHEDULE

Window	Tuno	W	н	Glz	Cons	Fin	De	tails		14/5/ 0	Remarks	
VVIIIGOW	Туре	VV	П	GIZ	Cons	ГШ	Head	Jamb	Sill	Wdw Cov		
01	А	13-'6"	2'-4"	2							INTERIOR TRANSOM, W/ WOVEN WIRE MESH	
02	A	14'-5"	2'-4"	2							INTERIOR TRANSOM, W/ WOVEN WIRE MESH	

# TRANSOM SCHEDULE NOTES

- DIMENSIONS OF WINDOWS ARE NOMINAL.
- ALL DOORS AND WINDOWS SHALL MEET THE MINIMUM INFILTRATION REQUIREMENTS PER SECTION 2.5311 B.E.E.S.
- ALL GLAZING SHALL COMPLY WITH CBC CHAPTER 24 AND TABLES CBC 24-1, 24-B AND 24-C. PROVIDE TEMPERED GLASS AT ALL AREAS REQUIRED BY CALIFORNIA BUILDING CODE (CBC) OR WHERE INDICATED ON ELEVATIONS - EACH PIECE MARKED BY 'T' SHALL BE TEMPERED GLAZING.

INSTALL SAFETY GLASS IN ALL WINDOWS WITHIN 18 INCHES OF A WALKING SURFACE AND WITHIN

AL ALUMINUM AWN AWNING CSMT CASEMENT CONS CONSTRUCTION DBL DOUBLE GLAZED DH DOUBLE HUNG FIN FINISH HEIGHT

WIDTH


HM HOLLOW METAL LAM LAMINATED GLASS P PAINTED SGL SINGLE GLAZED SLDR SLIDER SLGDR SLIDING GLASS DOOR SPCL SPECIAL STD STANDARD WIRE WIRE GLASS

**ABBREVIATIONS** 

# TRANSOM SCHEDULE AND NOTES

12 INCHES OF A DOOR.

# FRAME TYPES

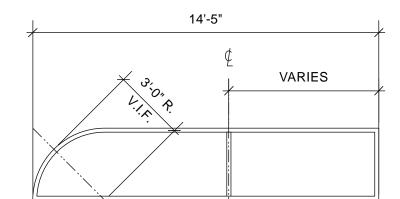


TYPE A




Scale: 1/4" = 1'-0"

# TRANSOM TYPES

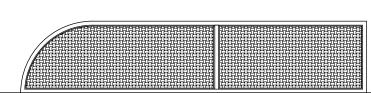

INTERIOR TRANSOM

# FRAME & TRANSOM TYPE

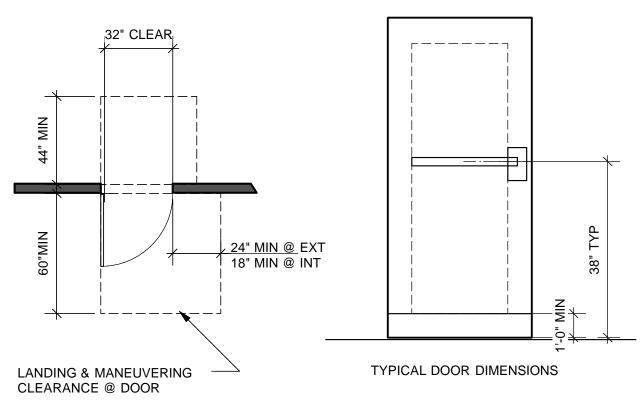

SEE DOOR SCHEDULE FOR ACTUAL DOOR SIZES AND HARDWARE GROUPS

# DOOR CLEARANCE ON PATH OF TRAVEL

	4/26/13	60% DELIVERABLE 4.26.13			REFERENCE INFORMATION	
	6/21/13	90% SET 6.21.13			& FILE NO. OF SURVEYS	
	6/21/13	PERMIT SET 6.21.13				4/
	8/02/13	100% COORDINATION SET 8.02.13				15
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						モ
NO.	DATE	DESCRIPTION	BY	APP.		I /,
		TABLE OF REVISIONS	·			\ \

# 24" MIN. @ EXT. 18" MIN. @ INT. WHERE ALCOVE IS GREATER THAN 8" DEEP, PROVIDE ASSOCIATED MINIMUM CLEARANCES

DOOR CLEARANCE AT ALCOVE CONDITION

# **Building Design & Construction DEPARTMENT OF PUBLIC WORKS CITY AND COUNTY OF SAN FRANCISCO**

# C17466 Z

TYPE A

DESIGNED: DATE:	APPROVED	SCALE:	MISSION DOLORES PARK
TL/ EC 08/2013		AGNOTED	
DRAWN: DATE:	CECTION MANAGED DATE:	AS NOTED	REHABILITATION PROJECT
TL/ EC 08/2013	DEPUTY BUREAU MANAGERDATE:	SHEET OF SHEETS	SOUTH RESTROOM
CHECKED: DATE:	BUREAU MANAGER DATE:	OF	SCHEDULES
	DUREAU WANAGER DATE:		

# DOOR SCHEDULE

Door	Туре	W	Н	Thk	Cons	Fin	Ratg	Hdwr	Frame	Frame	Frame		Details		Sign	Remarks
Door	Type	VV	11	TIIK	Cons	ГШ	Naiy	Grp	Туре	Cons		Head	Jamb	Thrshld	J	
01	А	3'0"	7'0"	1-3/4	НМ	Р	NR	1		НМ	Р	5/A8.2	4/A8.2 SIM	6/A8.2		EXTERIOR METAL DOOR WITH METAL TRANSOM
02	В	3'0"	7'0"	1-3/4	НМ	Р	NR	2		НМ	Р	2/A8.2	3/A8.2			
03	В	3'0"	7'0"	1-3/4	НМ	Р	NR	2		НМ	Р	2/A8.2	3/A8.2			1" UNDER CUT
04	А	3'0"	7'0"	1-3/4	НМ	Р	NR	1		НМ	Р	5/A8.2	4/A8.2 SIM.	6/A8.2		EXTERIOR METAL DOOR WITH METAL TRANSOM
05	А	3'0"	7'0"	1-3/4	НМ	Р	NR	1		НМ	Р	5/A8.2	4/A8.2 SIM	6/A8.2		EXTERIOR METAL DOOR WITH METAL TRANSOM
06	А	3'0"	7'0"	1-3/4	НМ	Р	NR	1		НМ	Р	5/A8.2	4/A8.2 SIM	6/A8.2		EXTERIOR METAL DOOR WITH METAL TRANSOM
07	В	3'0"	7'0"	1-3/4	НМ	Р	NR	2		НМ	Р	2/A8.2	3/A8.2			
08	В	3'0"	7'0"	1-3/4	НМ	Р	NR	2		НМ	Р	2/A8.2	3/A8.2			
09	С	3'0"	7'0"	1-3/4	НМ	Р	NR	2		НМ	Р	2/A8.2	3/A8.2			
10	С	3'0"	7'0"	1-3/4	НМ	Р	NR	2		НМ	Р	8/A8.2	8/A8.2 SIM.			
11	D	6'10"	8'8"	2"	STL	Р	NR	4				4/A8.3				SLIDING METAL GATE
12	D	6'6"	8'8"	2"	STL	Р	NR	4				4/A8.3				SLIDING METAL GATE

# DOOR SCHEDULE NOTES

- DIMENSIONS OF DOORS ARE NOMINAL ALL DOORS AND WINDOWS SHALL MEET THE MINIMUM INFILTRATION REQUIREMENTS PER SECTION 2.5311 B.E.E.S. ALL SOLID EXTERIOR DOORS SHALL BE
- WEATHER-STRIPPED COMPLETELY. ALL EXIT DOORS SHALL BE OPENABLE FROM THE INSIDE WITHOUT THE USE OF A KEY OR ANY SPECIAL KNOWLEDGE OR EFFORT. NO DEADBOLTS, NO SLIDING BOLTS, ETC. (CBC SEC. 1004 (C)). RESTROOM SECURITY GATES & DOORS W/ LOCKS SHALL BE SIGNED @ THE EGRESS SIDE "THIS DOOR TO REMAIN UNLOCKED WHEN
- BUILDING IS OCCUPIED." 4. ADJUST ALL DOOR OPENING FORCE TO THE MINIMUM REQUIRED FOR OPERATION. MAXIMUM EFFORT TO OPERATE ANY NEW DOORS SHALL NOT EXCEED 5 POUNDS FOR INTERIOR AND EXTERIOR DOORS, SUCH PULL OR PUSH EFFORT BEING APPLIED AT RIGHT ANGLES TO HINGED DOORS AND AT THE CENTER PLANE OF SLIDING OR FOLDING DOORS. COMPENSATING DEVICES OR AUTOMATIC DOOR OPERATORS MAY BE UTILIZED TO MEET THE ABOVE STANDARDS, SUBJECT TO APPROVAL BY THE ARCHITECT AND THE GOVERNING AUTHORITY, OPENING FORCE FOR FIRE RATED DOORS MAY BE ADJUSTED UP TO A MAXIMUM OF 15 POUNDS SUBJECT TO

TYPE B

DOOR AND FRAME TYPE
Scale: 1/4" = 1'-0"

APPROVAL BY THE GOVERNING AUTHORITY.

5. ALL HAND-ACTIVATED DOOR OPENING HARDWARE SHALL BE CENTERED BETWEEN 30" AND 44" ABOVE THE FLOOR. SEE DOOR TYPES FOR DIMENSION. LATCHING AND LOCKING DOORS THAT ARE HAND ACTIVATED AND WHICH ARE IN A PATH OF TRAVEL SHALL BE OPERABLE WITH A SINGLE EFFORT BY LEVER TYPE HARDWARE. LOCKED DOORS SHALL OPERATE AS ABOVE IN THE EGRESS DIRECTION.

THE BOTTOM 10 INCHES OF ALL NEW DOORS EXCEPT

AUTOMATIC AND SLIDING DOORS SHALL HAVE A SMOOTH UNINTERRUPTED SURFACE TO ALLOW THE DOOR TO BE OPENED BY A WHEELCHAIR FOOTREST WITHOUT CREATING A TRAP OR HAZARDOUS CONDITION. WHERE NARROW FRAME DOORS ARE USED, A 10" HIGH SMOOTH BOTTOM RAIL SHALL BE INSTALLED. ALL GLAZING IN DOORS SHALL BE SAFETY GLASS, OR WIRED GLASS WHERE REQUIRED.

# **ABBREVIATIONS**

CONS CONSTRUCTION (E) EXISTING FIN FINISH FL FLUSH H HEIGHT HM HOLLOW METAL LT LIGHT

NR NON-RATED P PAINTED PNL PANEL STL STEEL THK THICKNESS W WIDTH WD WOOD

JOB ORDER NO.

DRAWING NO.

FILE NO.


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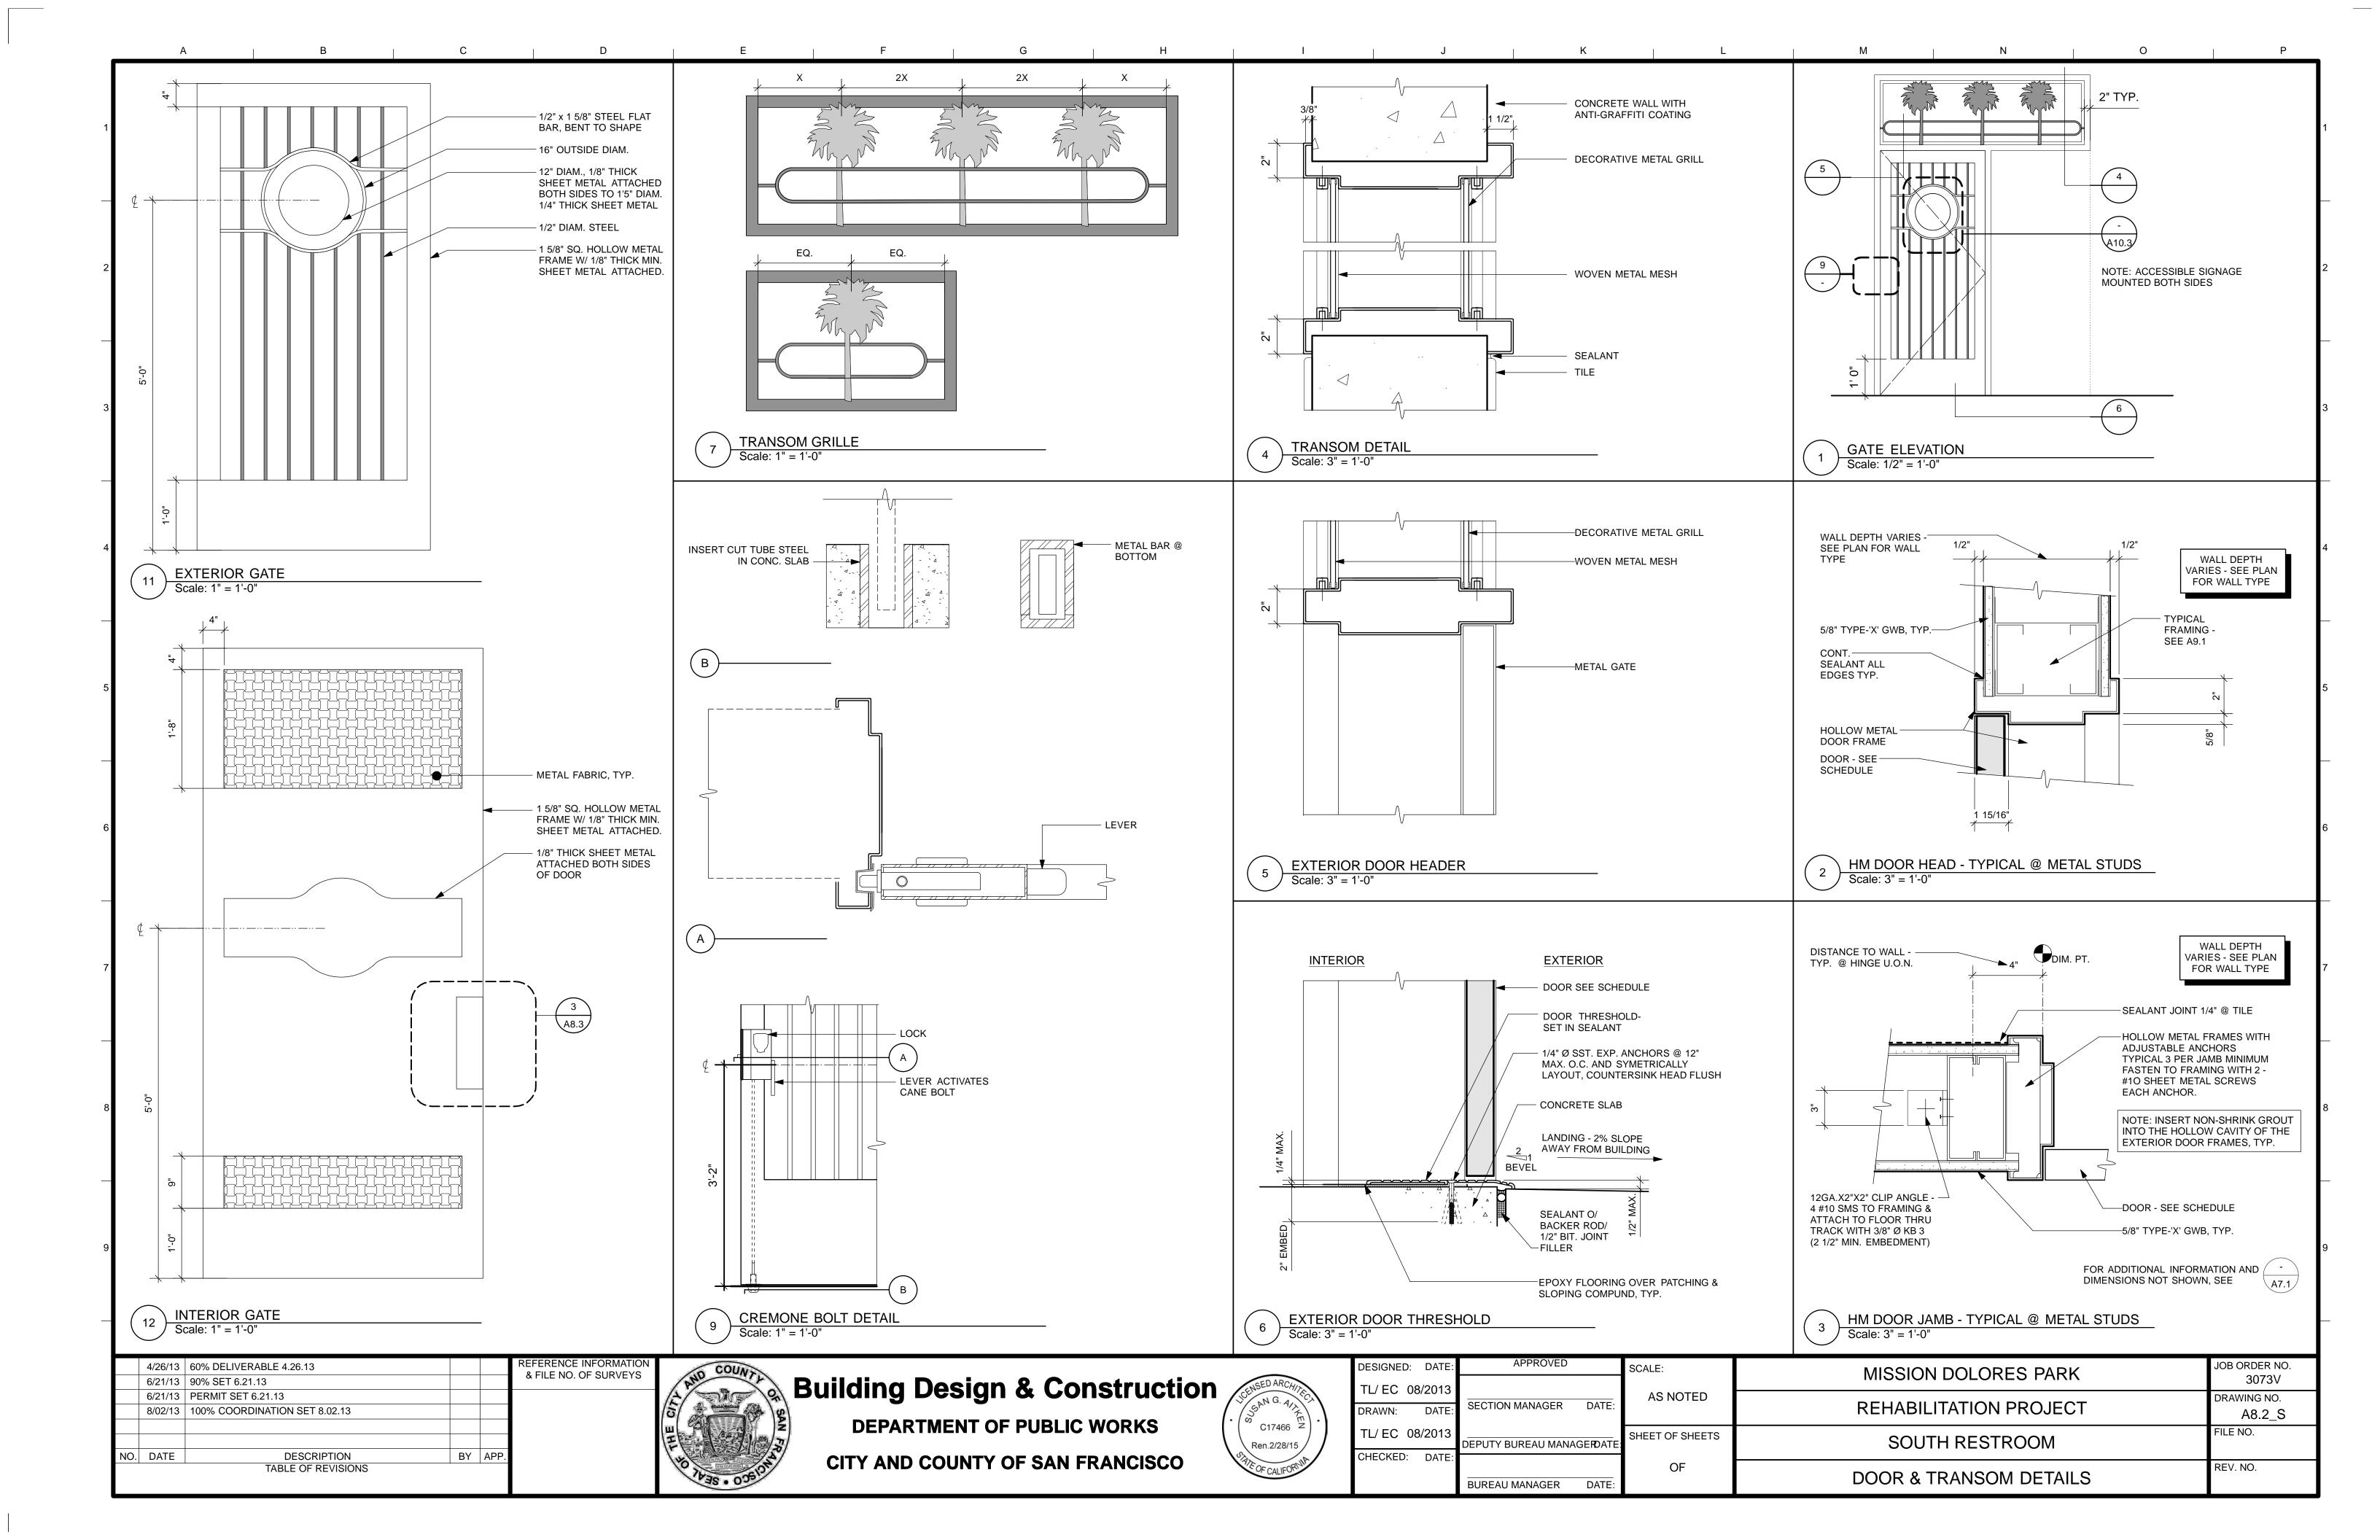
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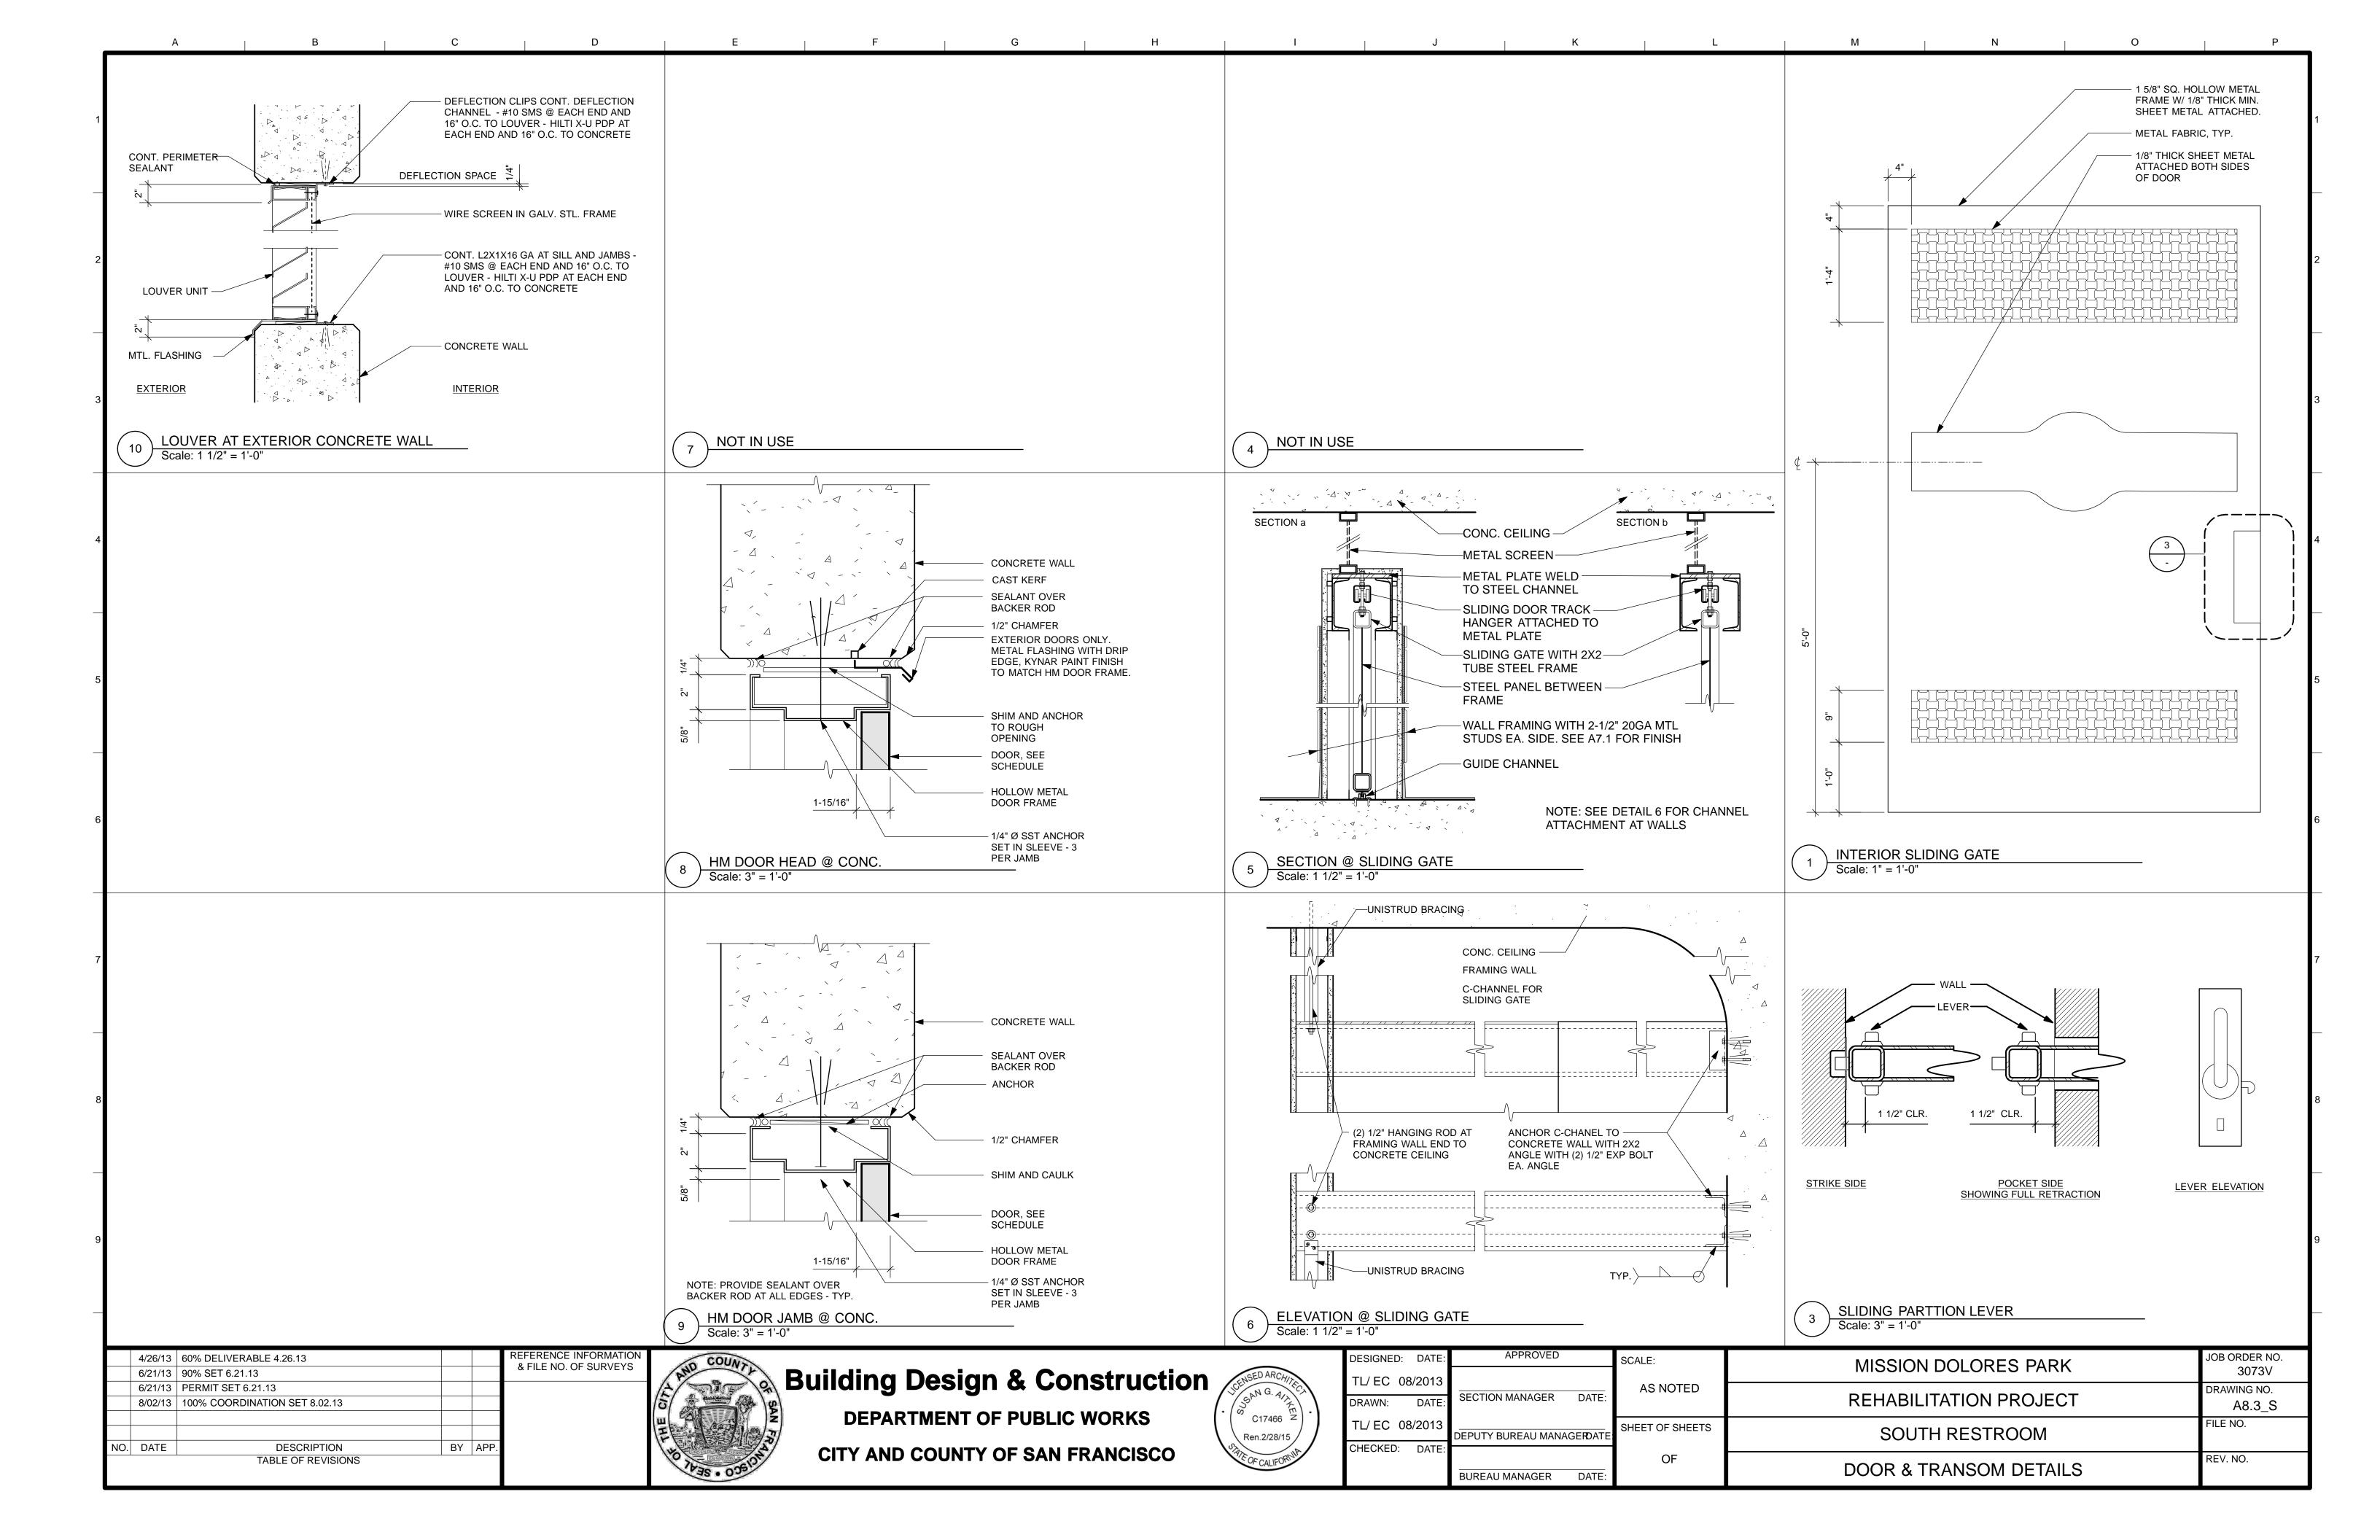
# DOOR SCHEDULE AND NOTES Scale: Actual Size


# DOOR TYPES FRAME TYPES SEE SCHEDULE





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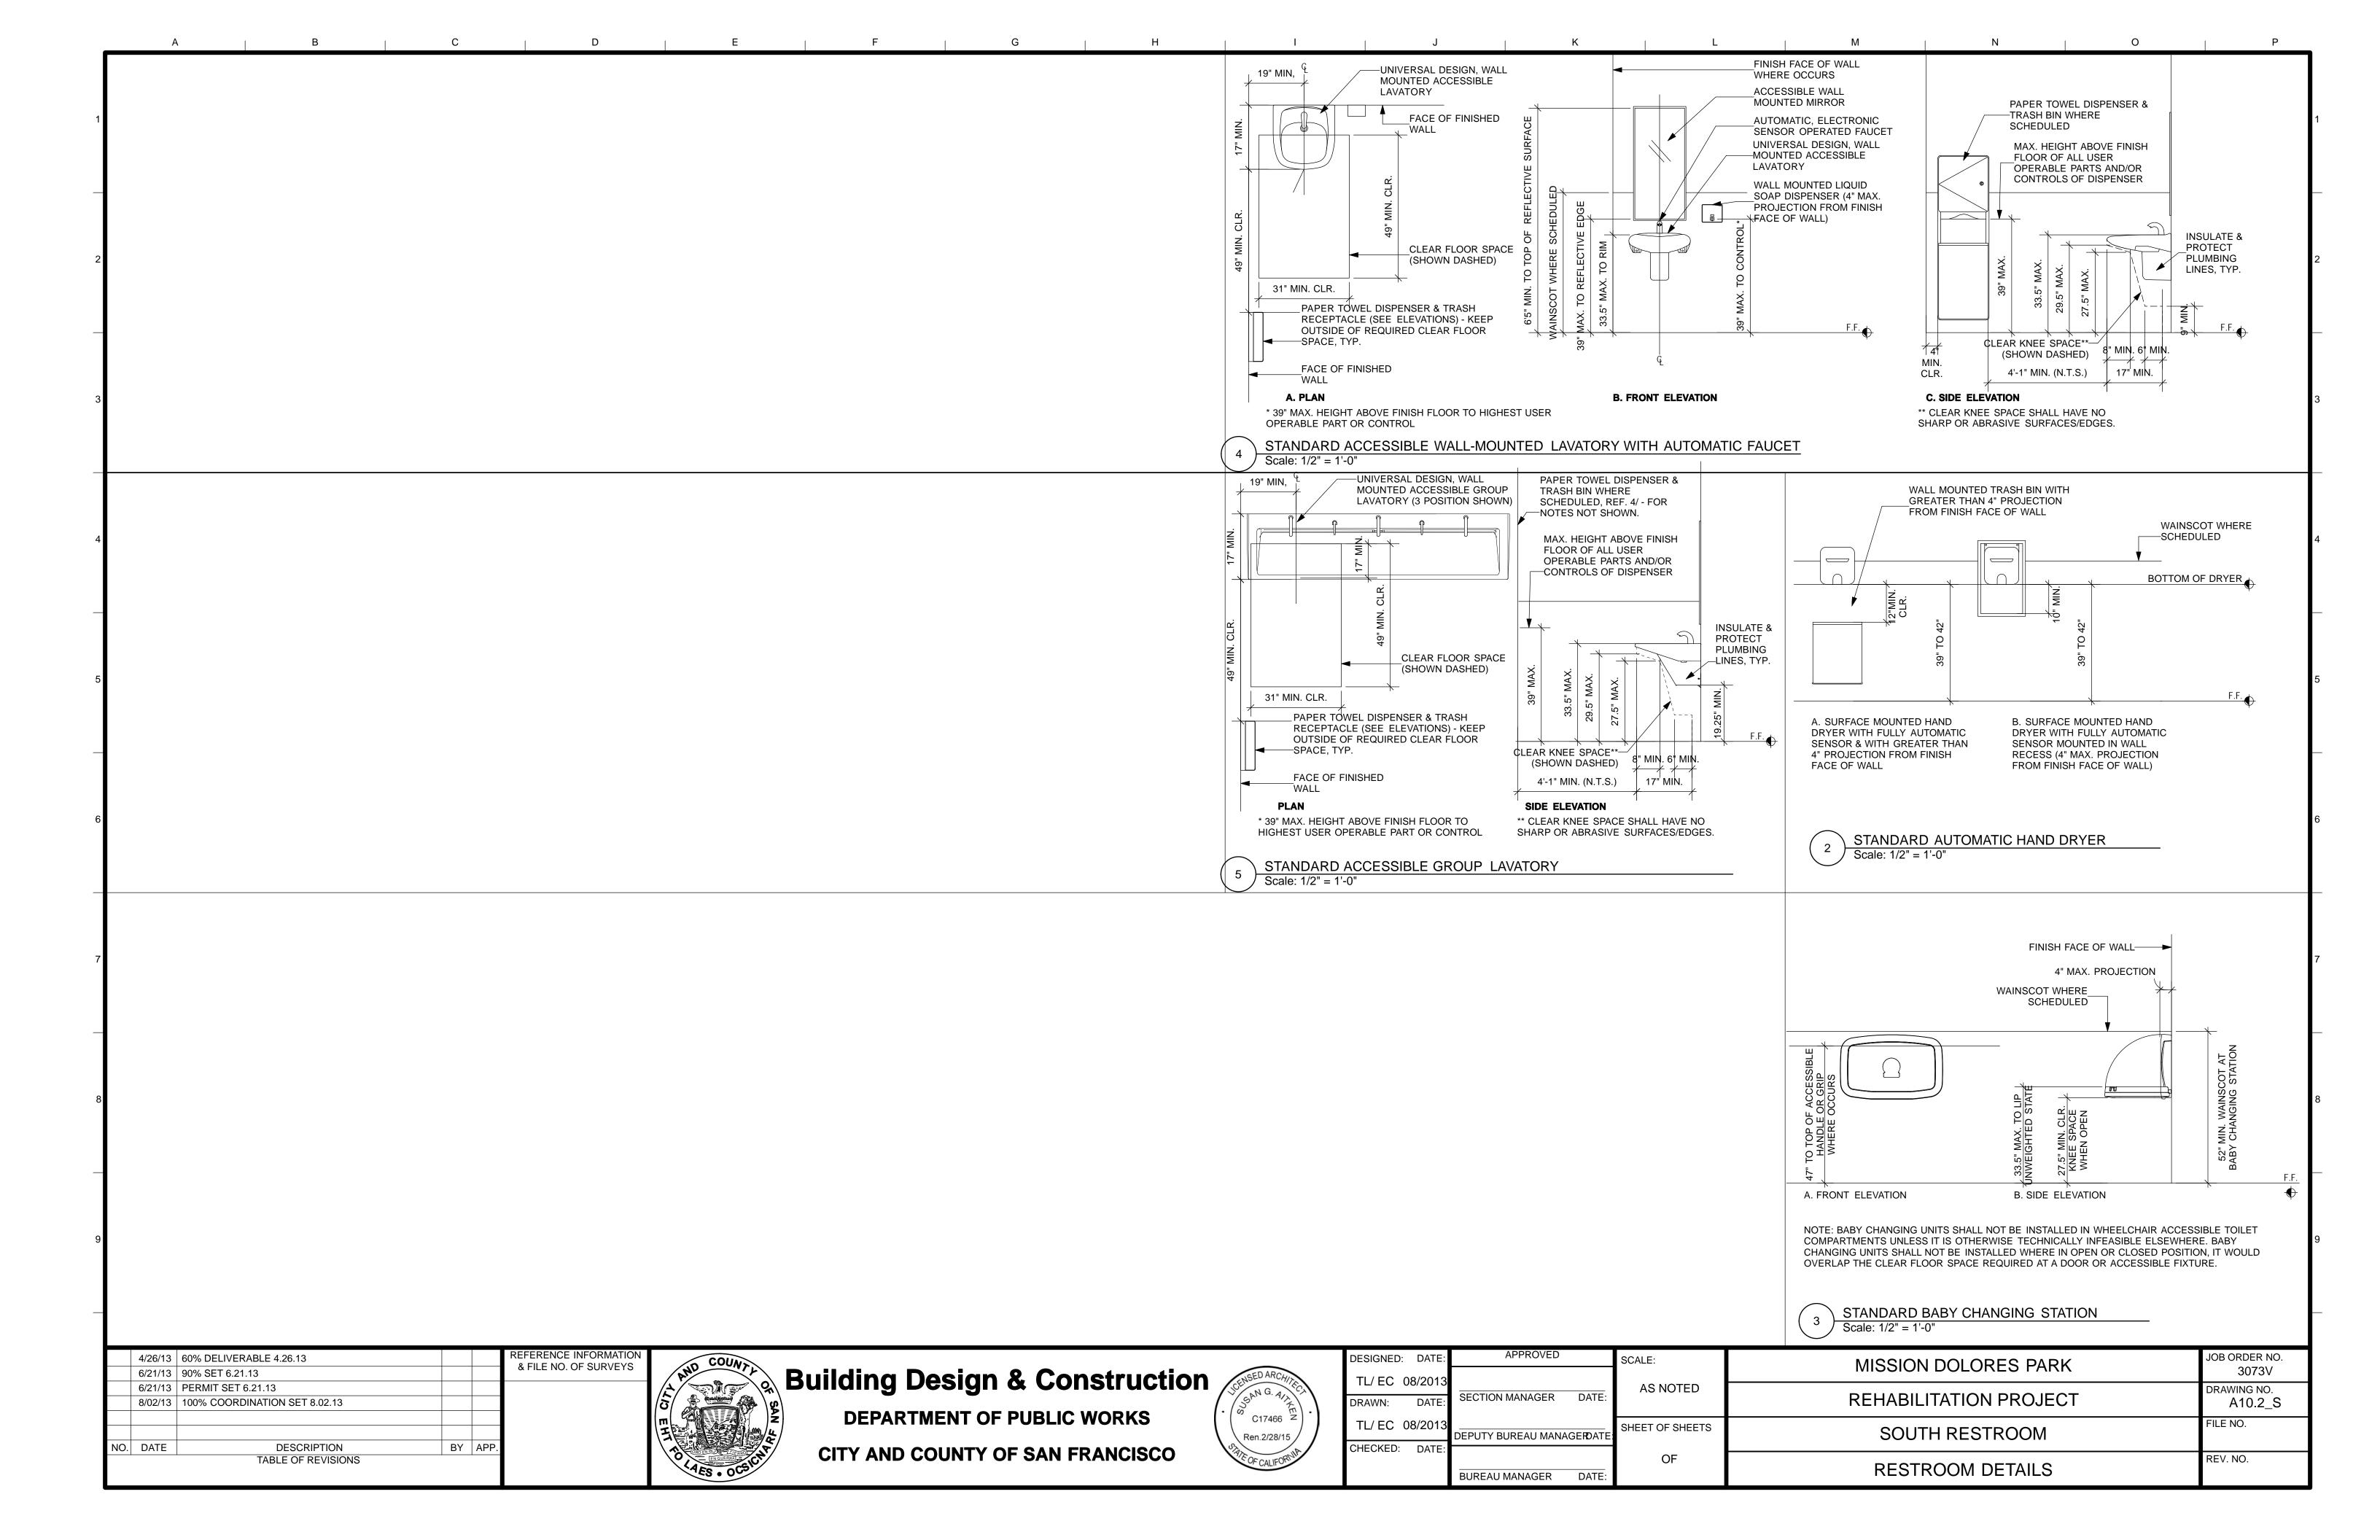





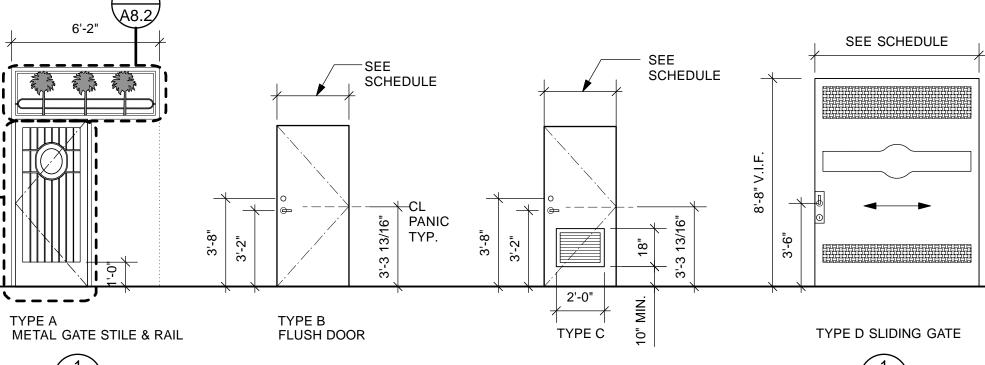

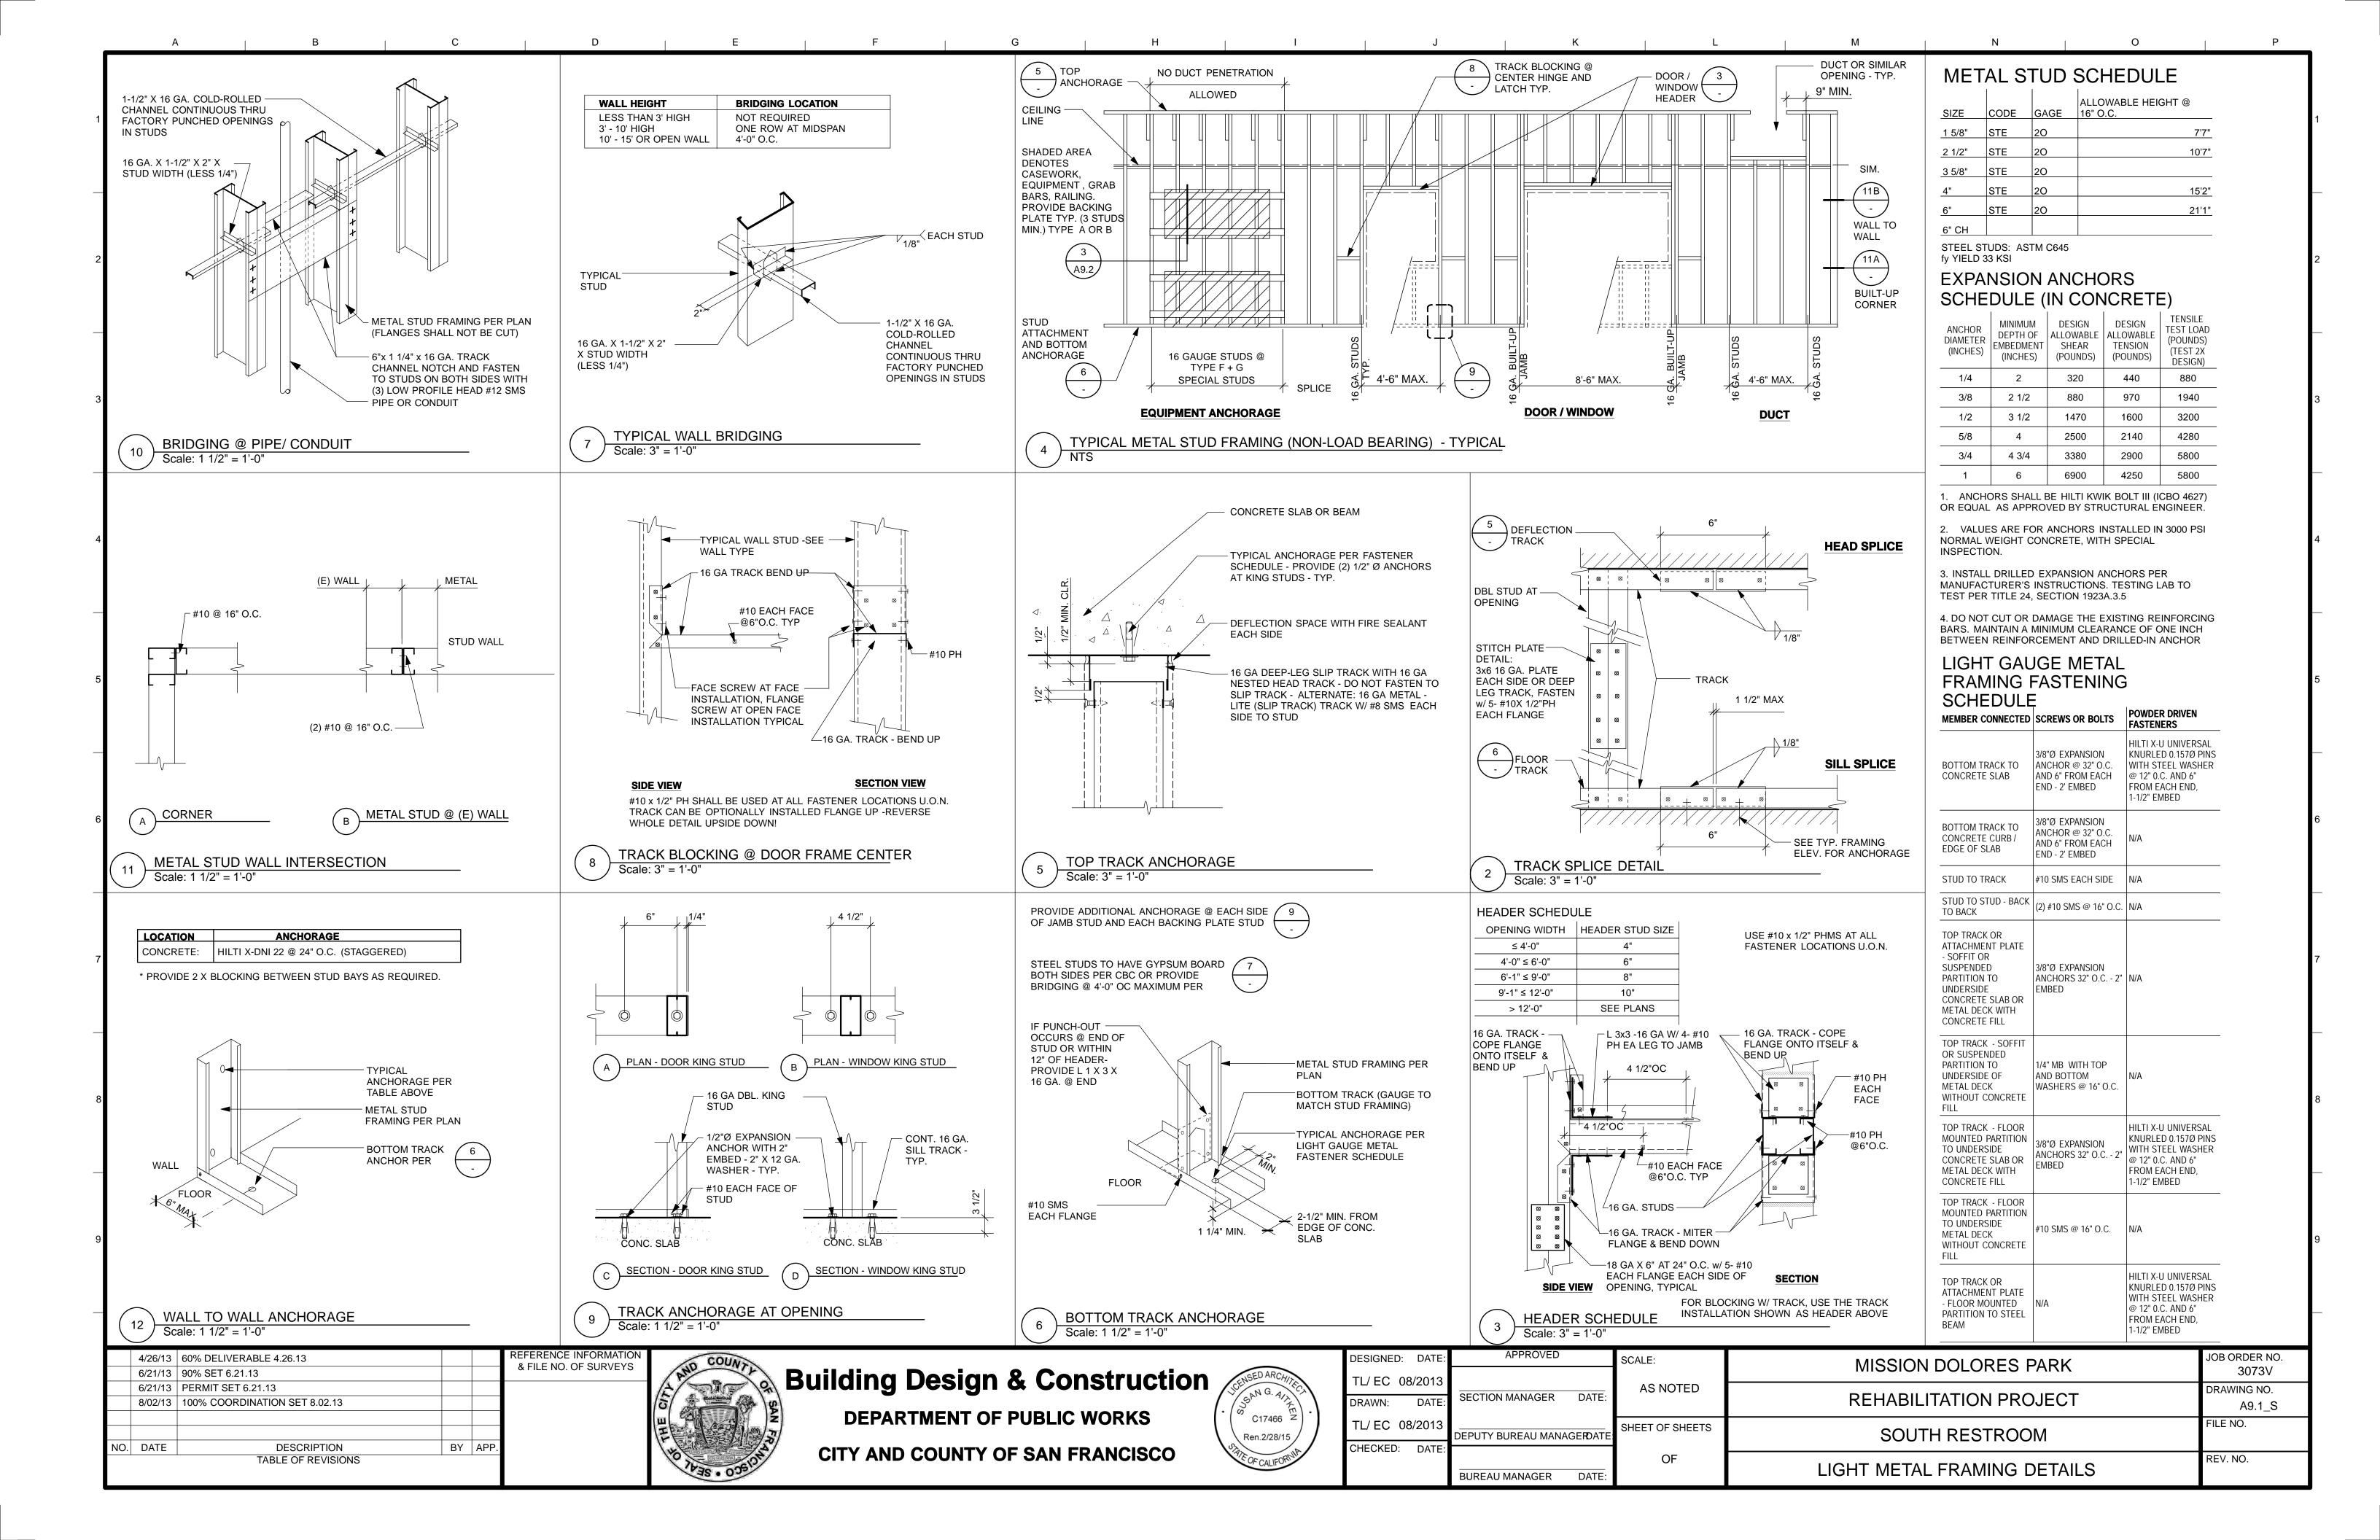

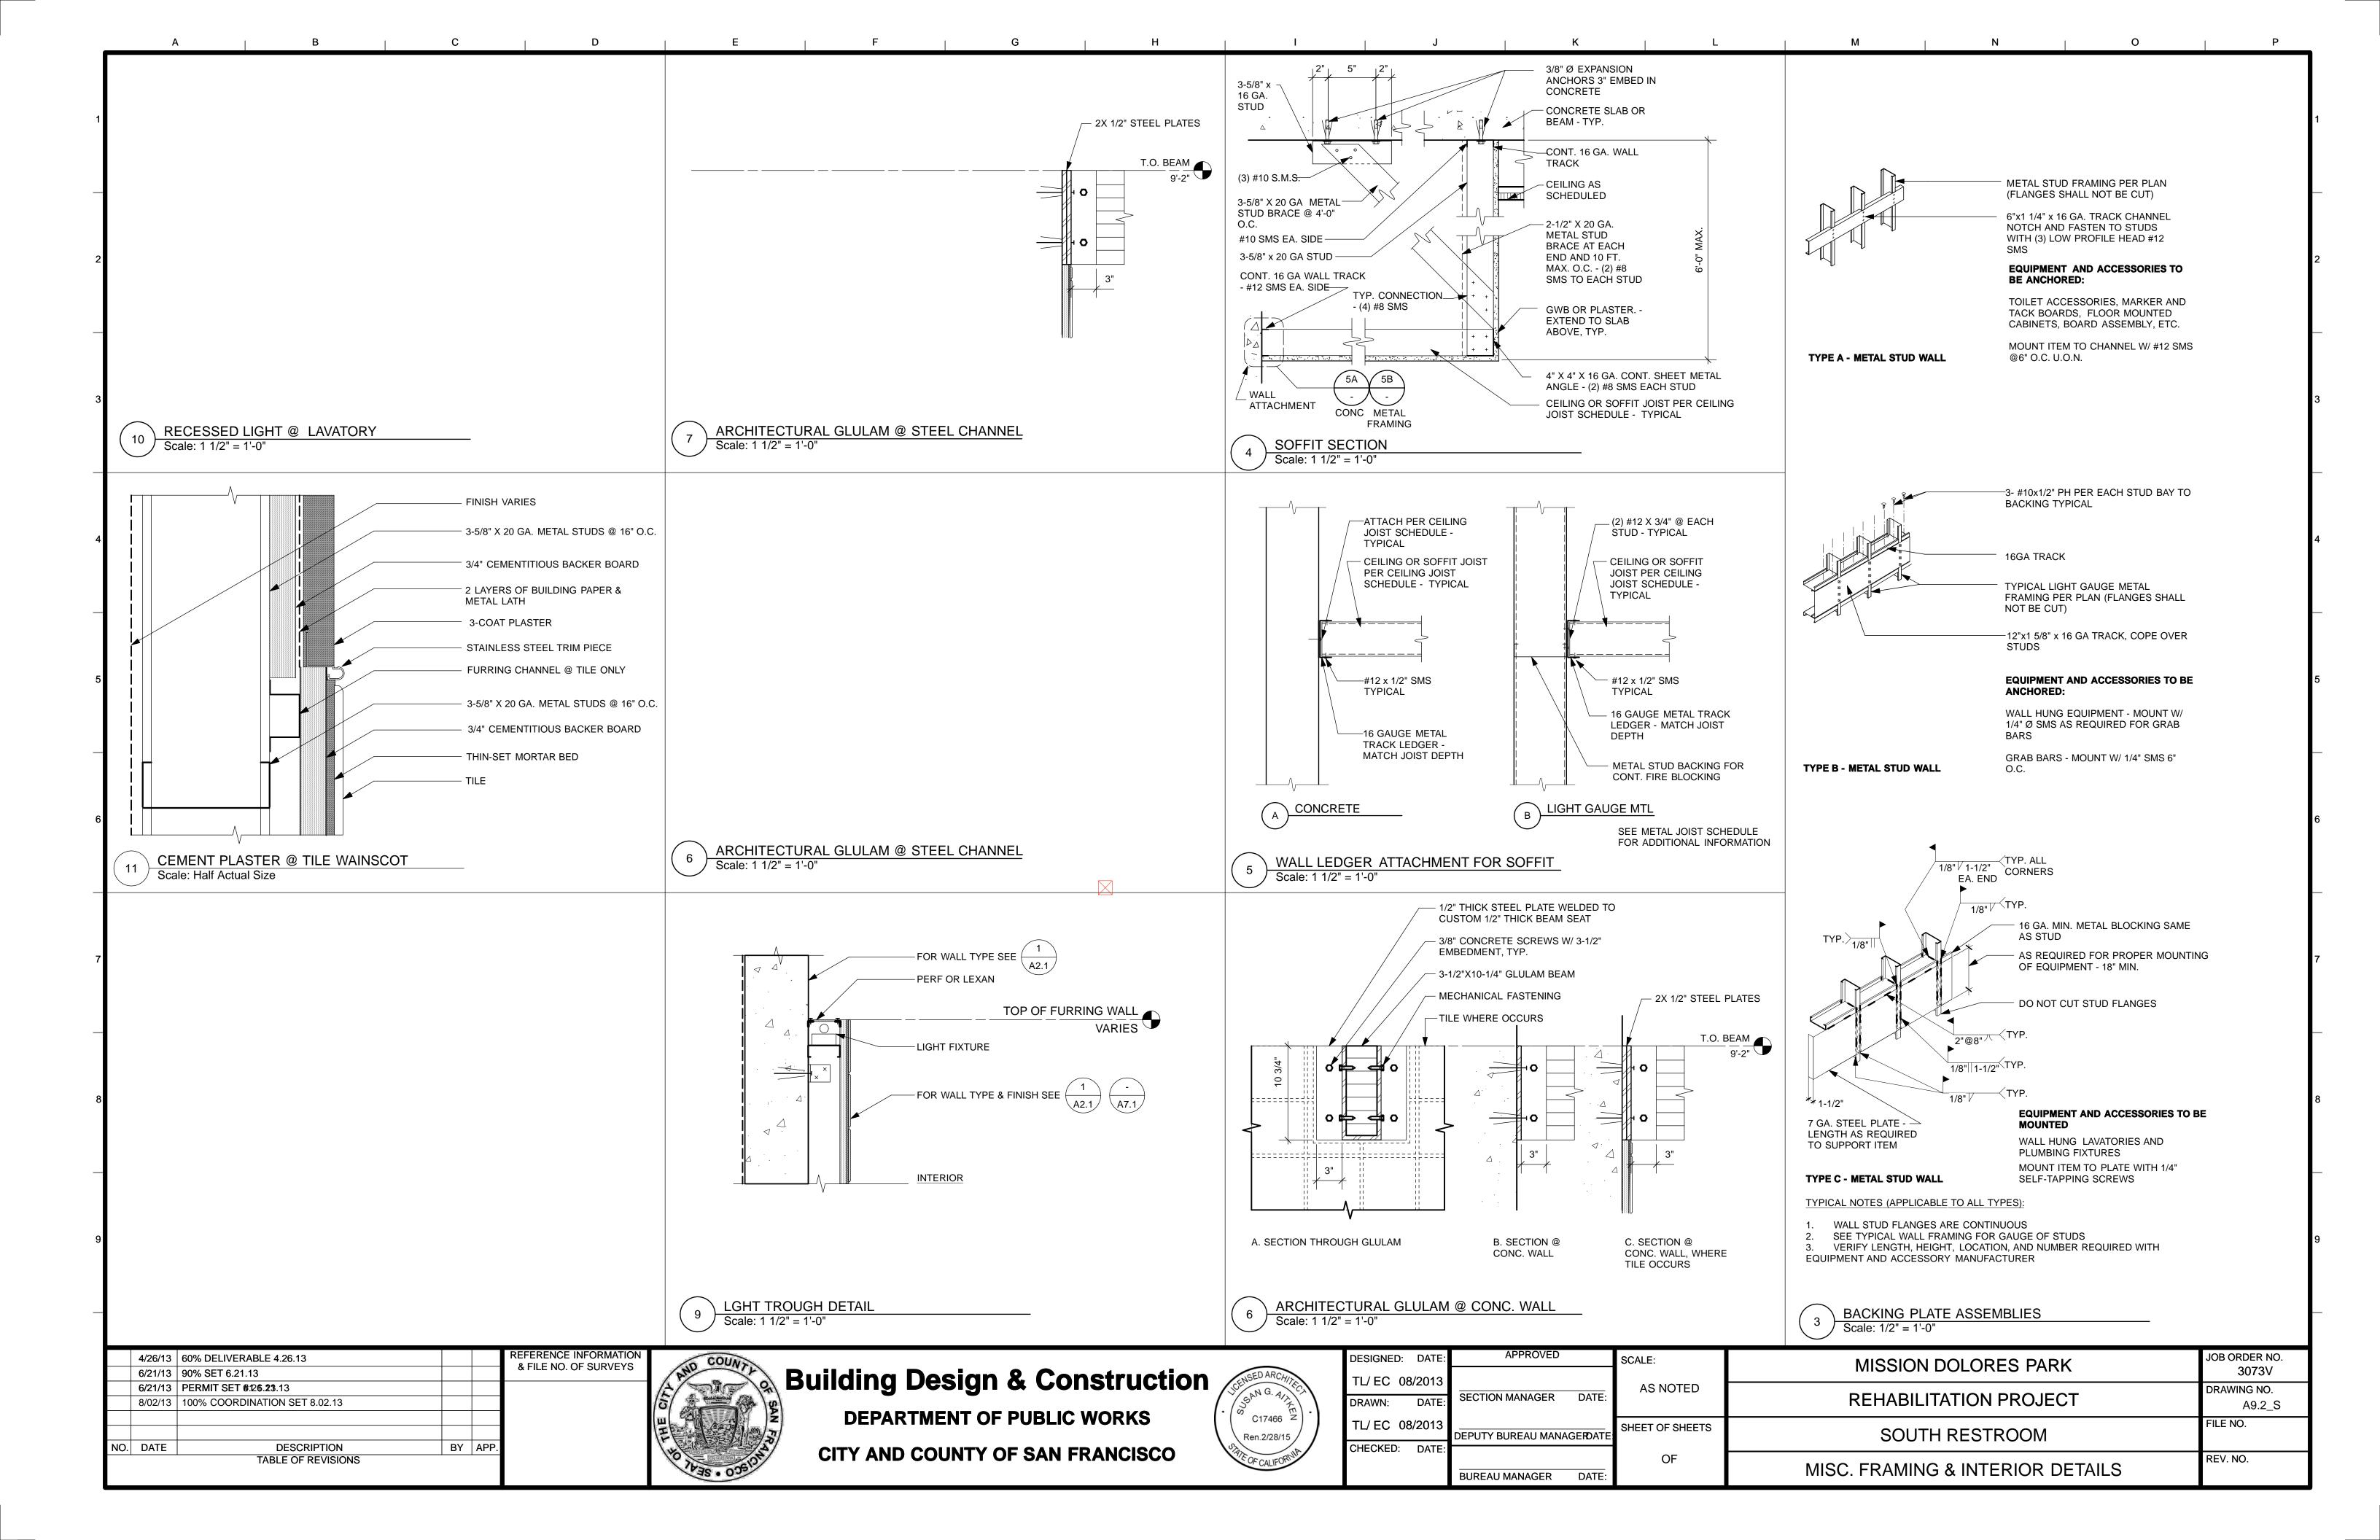

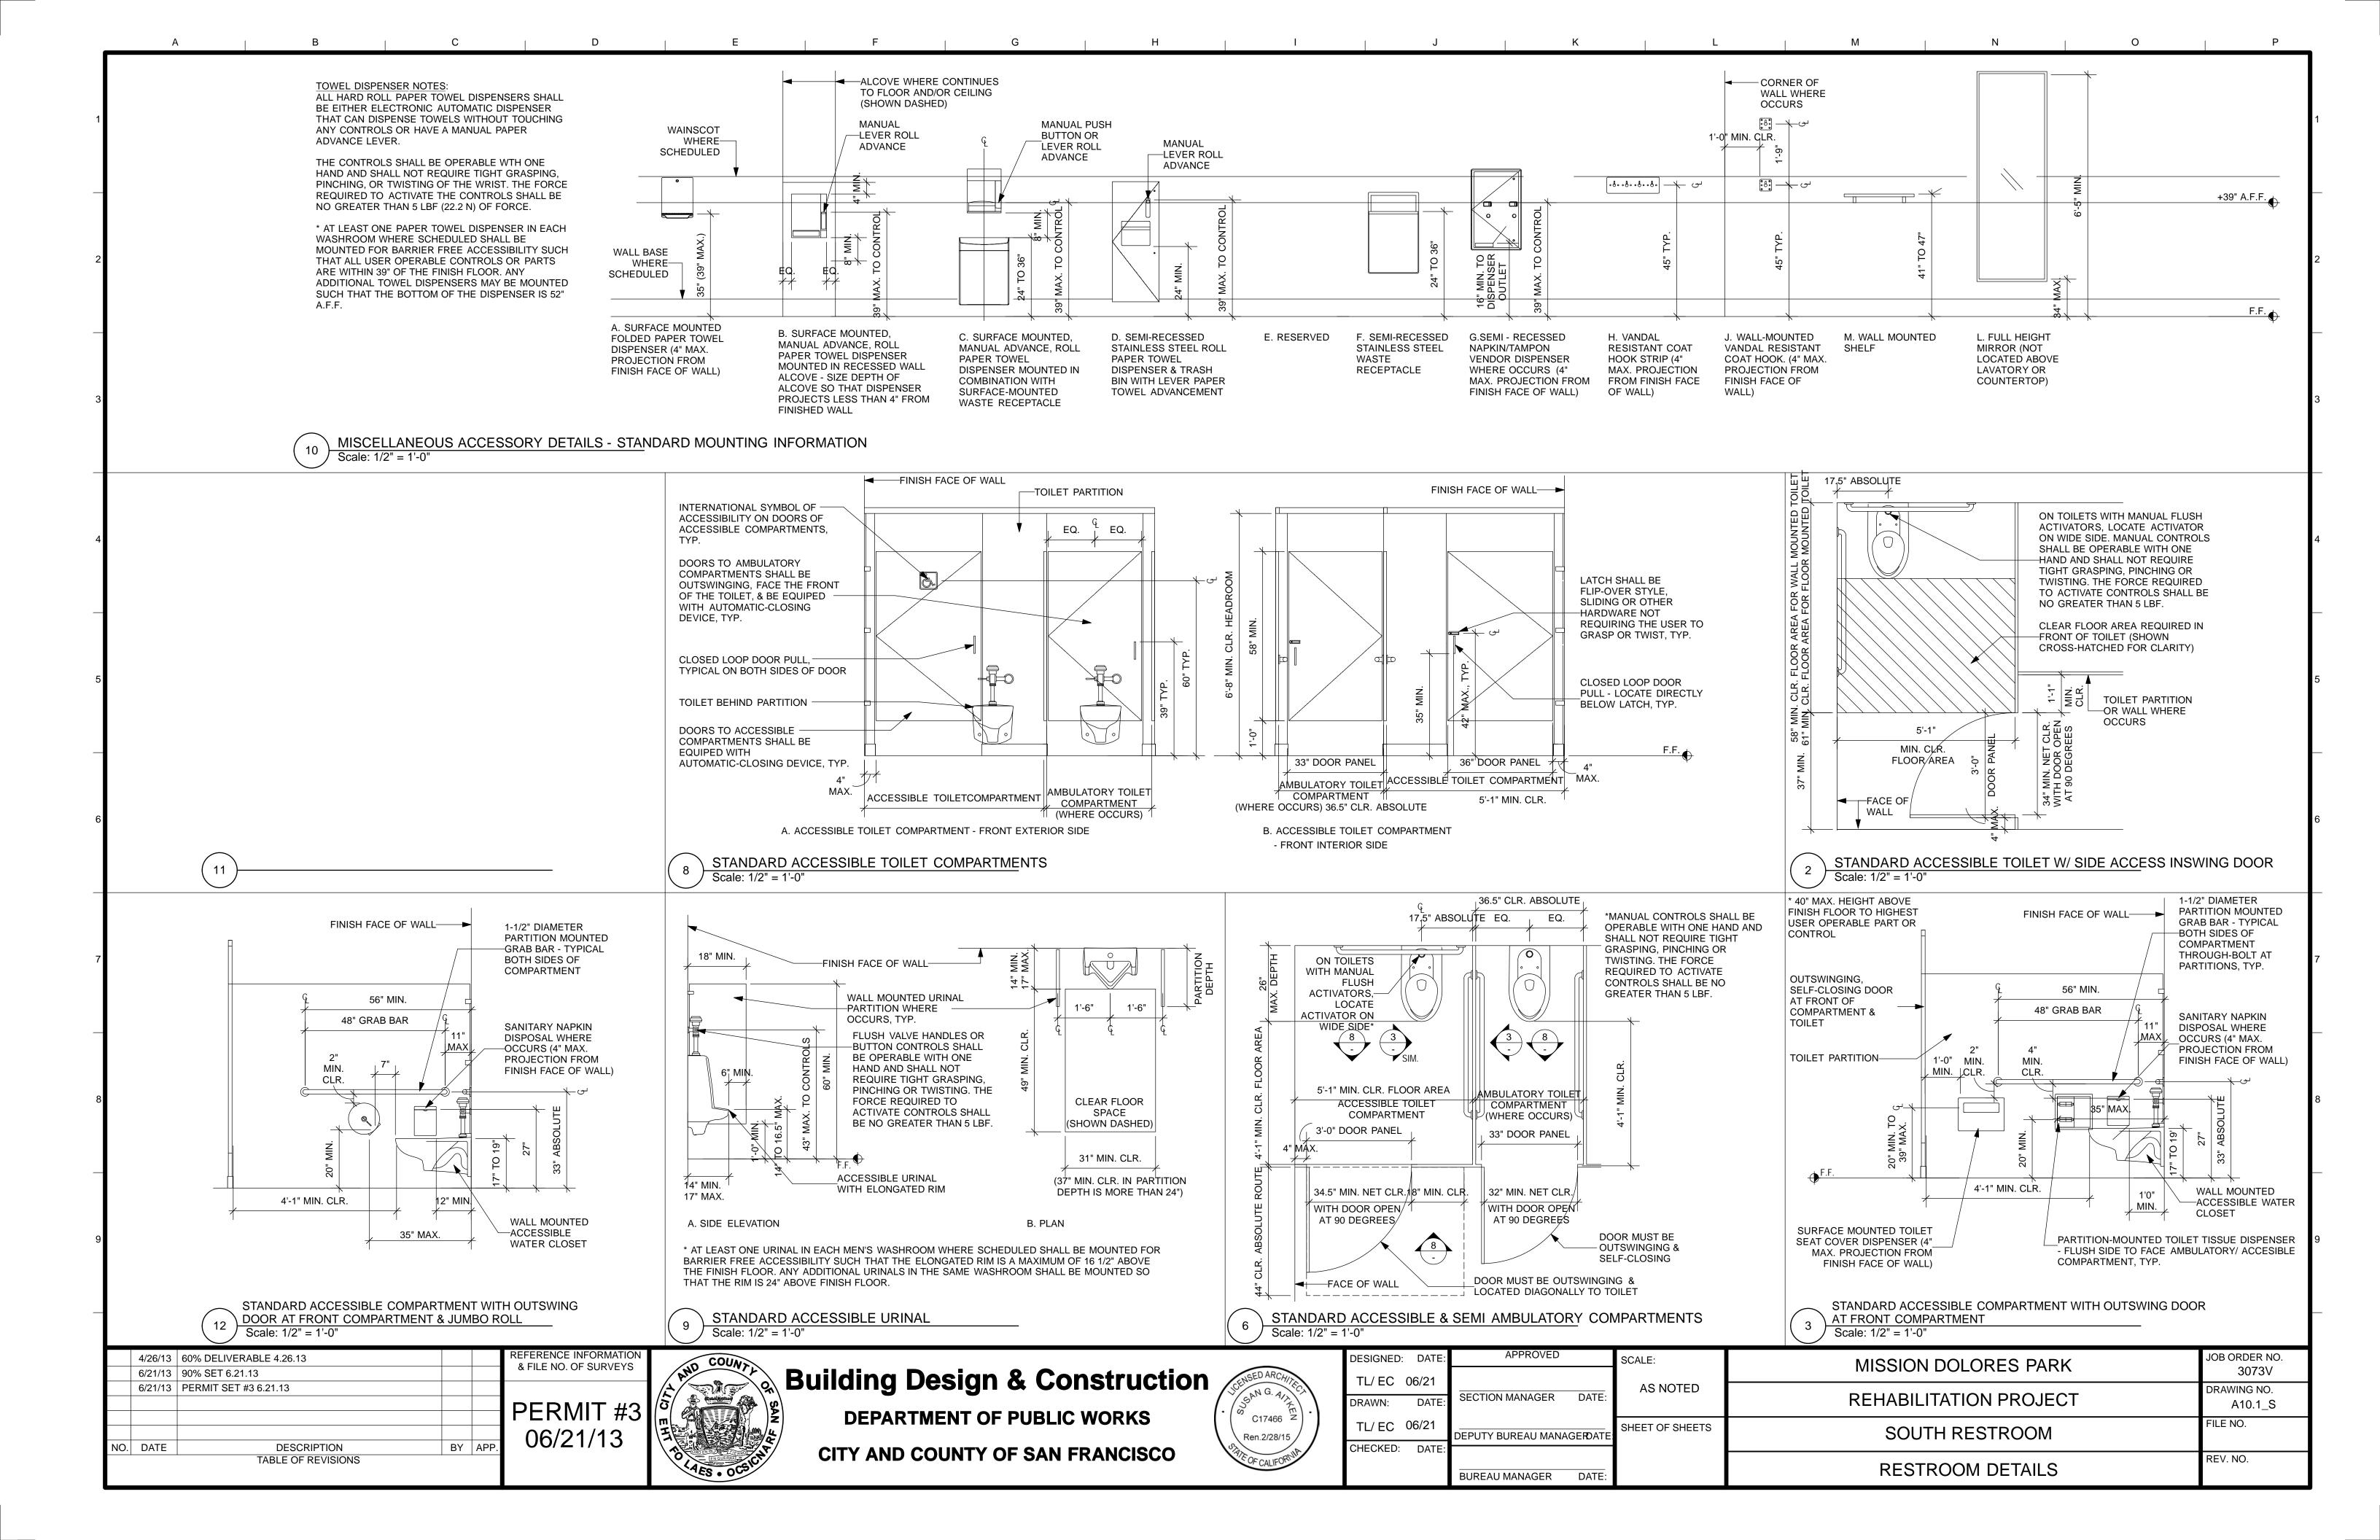

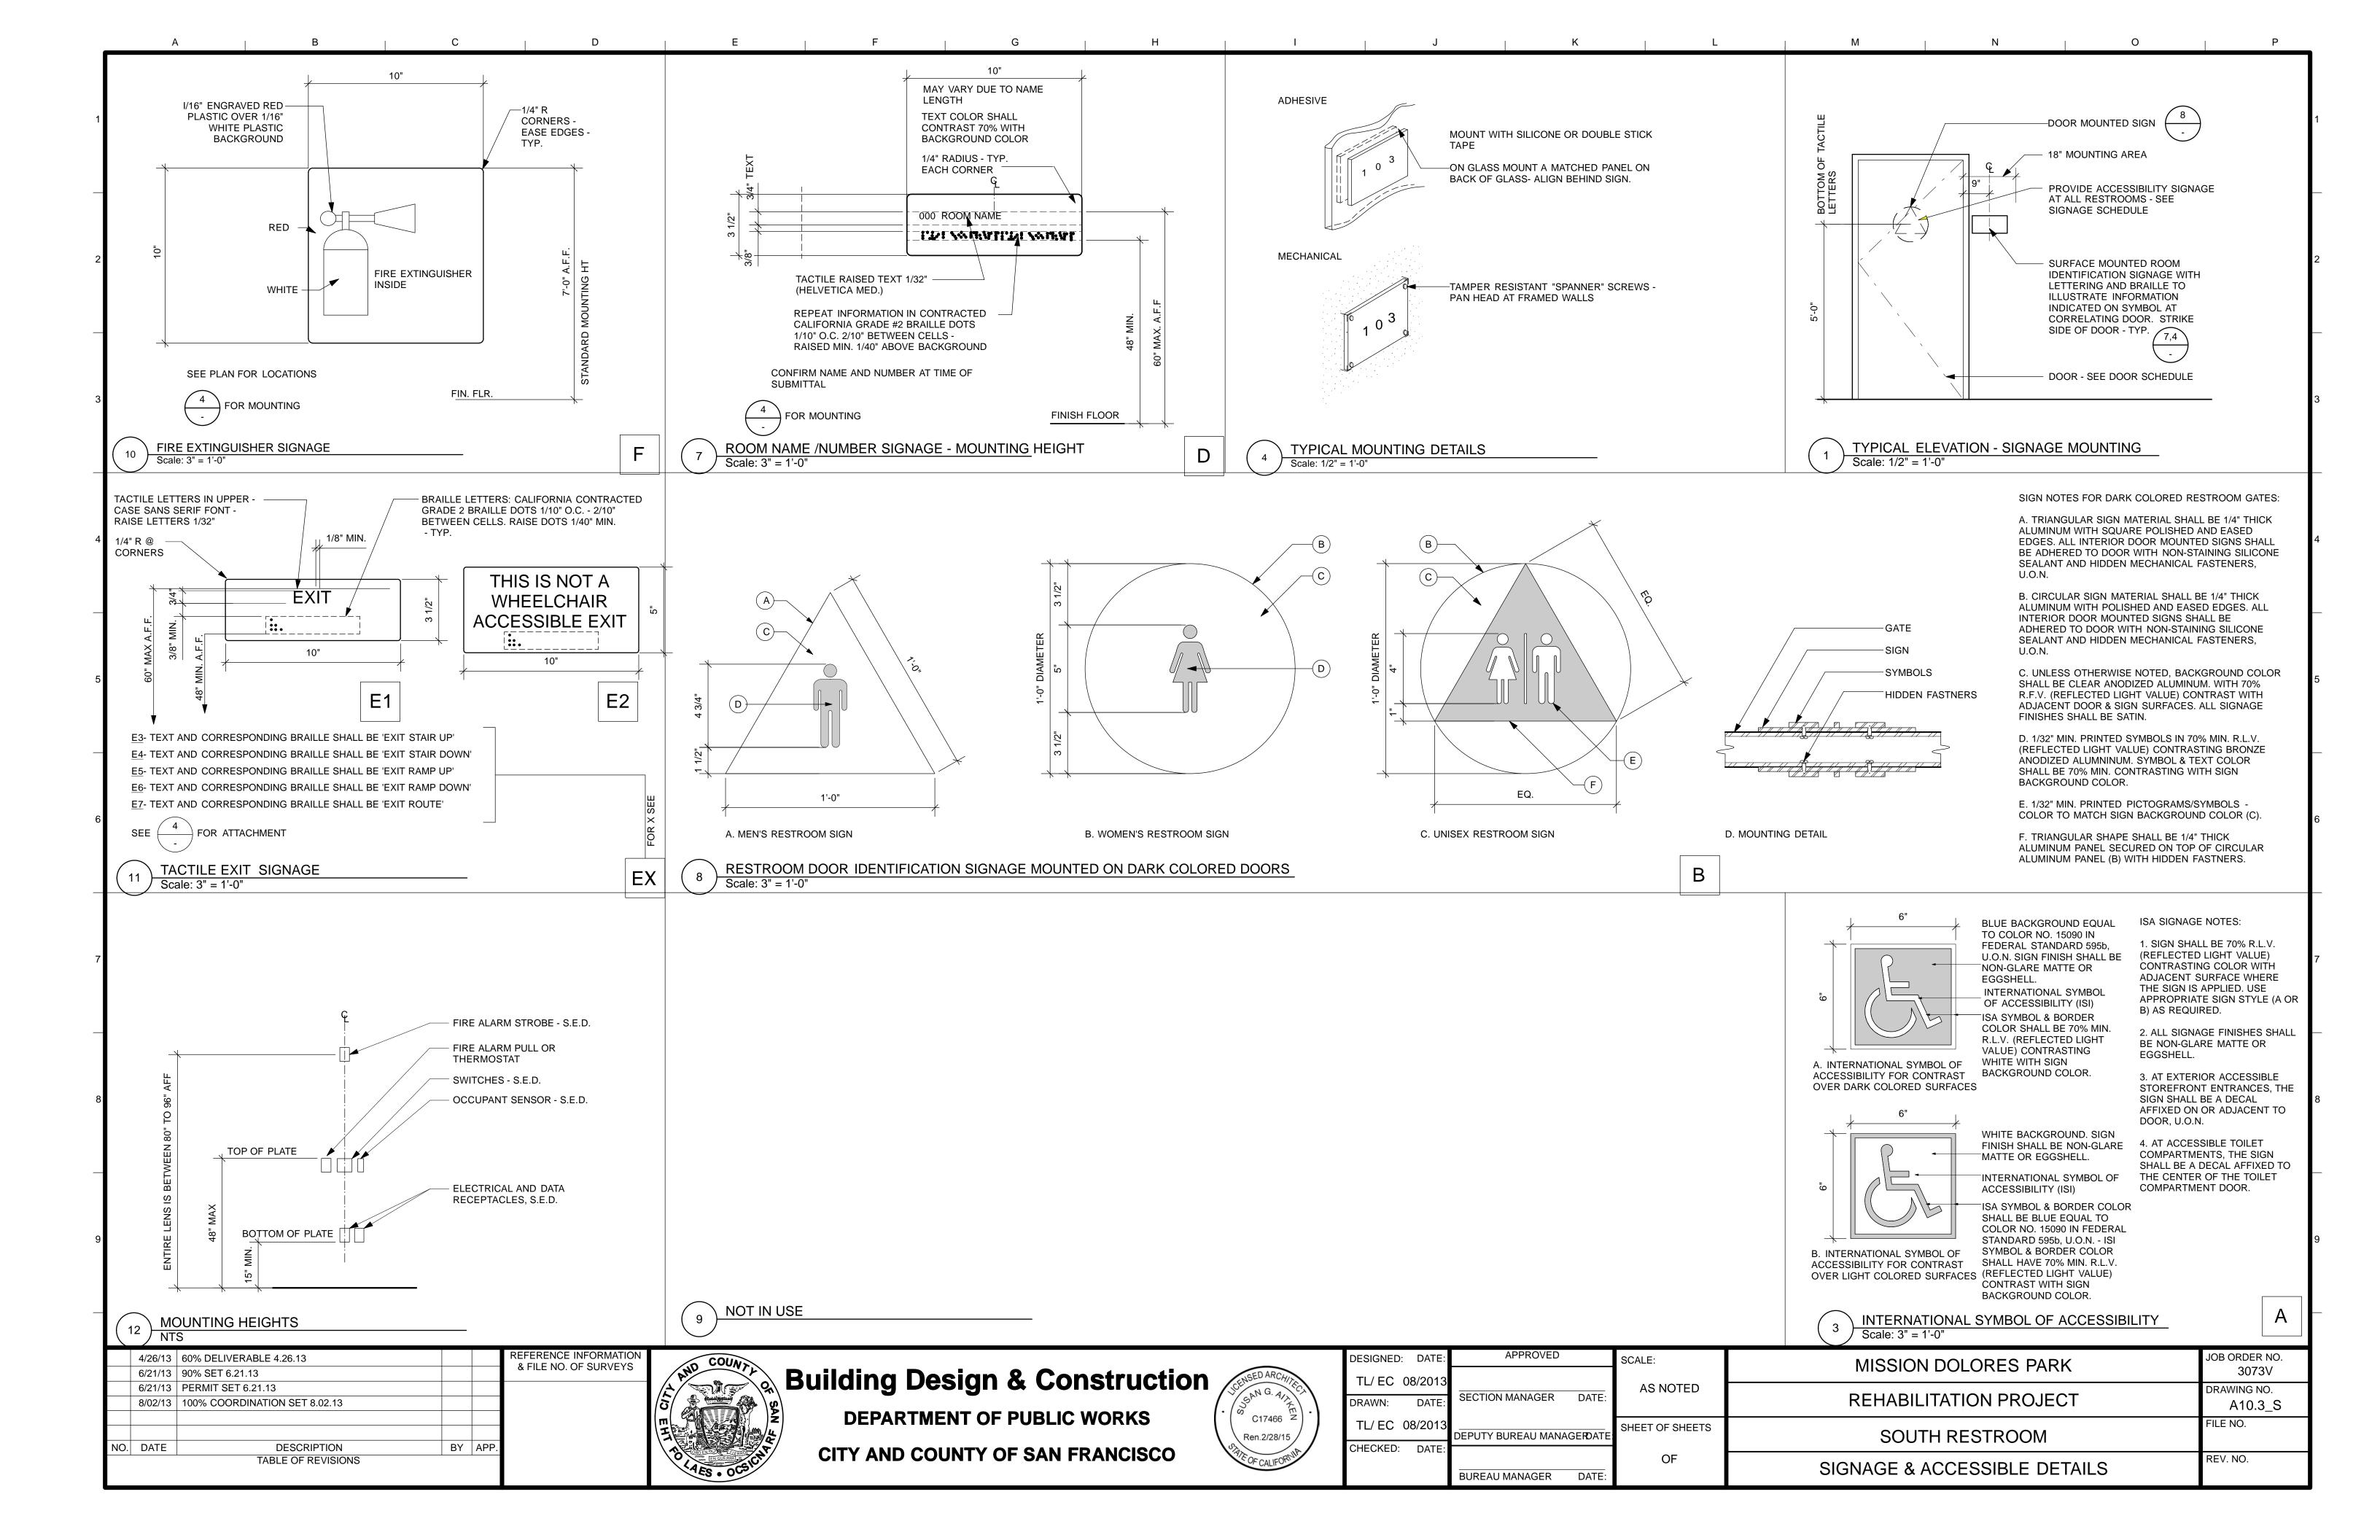

1. THE CONTRACT DOCUMENTS INCLUDE THESE DRAWINGS AND THE

SPECIFICATIONS. 2. THE INTENT OF THESE DRAWINGS AND SPECIFICATIONS IS THAT THE NEW WORK IS TO BE IN ACCORDANCE WITH TITLE 24. CALIFORNIA CODE OF REGULATIONS. NOTHING IN THE CONTRACT DOCUMENTS IS TO BE CONSTRUED TO PERMIT WORK NOT CONFORMING TO THESE CODES. WHERE CONFLICT OCCURS, THE DIRECTIVES SHALL GOVERN, EXCEPT WHERE SUPERIOR WORK IS SPECIFIED OR INDICATED. SUCH CONFLICTS SHALL BE BROUGHT TO THE CITY REPRESENTATIVE'S ATTENTION FOR CLARIFICATION, PRIOR TO PROCEEDING WITH THE WORK, SHOULD ANY EXISTING CONDITIONS SUCH AS DETERIORATION OR NON-COMPLYING CONSTRUCTION BE DISCOVERED WHICH IS NOT COVERED BY THE CONTRACT DOCUMENTS WHEREIN THE FINISHED WORK WILL NOT COMPLY WITH TITLE 24, CALIFORNIA CODE OF REGULATIONS, NOTIFY THE ARCHITECT TO RECEIVE

3. USE OF ANY MATERIAL CONTAINING ASBESTOS IS PROHIBITED. 4. EXISTING CONSTRUCTION MAY CONTAIN HAZARDOUS MATERIALS. REVIEW THE OWNER'S HAZARDOUS MATERIALS REPORT FOR INFORMATION. REMOVE ANY

HAZARDOUS MATERIALS PRIOR TO COMMENCING WORK. 5. CONTRACTOR SHALL VISIT THE SITE PRIOR TO SUBMISSION OF BIDS TO REVIEW

EXISTING CONDITIONS OF AREA OF THE WORK

AT ALL TIMES, THE CONTRACTOR SHALL BE SOLELY AND COMPLETELY RESPONSIBLE FOR THE CONDITIONS OF THE JOB SITE, INCLUDING SAFETY OF ALL PERSONS AND PROPERTY. THE ARCHITECT'S JOBSITE REVIEW IS NOT INTENDED TO INCLUDE REVIEW OF THE ADEQUACY OF THE CONTRACTOR'S SAFETY MEASURES. 7. MEANS AND METHODS: CONTRACTOR IS RESPONSIBLE FOR THE MEANS AND METHODS OF CONSTRUCTION. CONTRACTOR SHALL SELECT AND USE TOOLS, SCAFFOLDING, SHORING, EQUIPMENT AND LABOR AND METHODS THAT ARE APPROPRIATE AND ADEQUATE TO COMPLETE THE WORK. CONTRACTOR SHALL BE RESPONSIBLE FOR SEQUENCING THE WORK.

8. PERFORM ALL WORK IN AN ORDERLY MANNER WITHOUT DAMAGE TO OTHER PARTS OF THE BUILDING OR ADJACENT PROPERTIES. PROTECT ANY ADJACENT COMPLETED WORK OR PARTS OF THE BUILDING TO REMAIN WITH MEANS AVAILABLE TO CONTRACTOR INCLUDING BUT NOT LIMITED TO: BARRICADES, PROTECTION BOARDS, DROPCLOTHS, OR TEMPORARY REMOVAL FOR REINSTALLATION, IF PERMITTED BY THE CITY, ANY RESULTING DAMAGE OR LOSS SHALL BE REPAIRED OF CORRECTED BY THE CONTRACTOR AT NO EXPENSE TO THE OWNER. 9. THE CONTRACTOR SHALL BARRICADE THE WORK AREA TO PREVENT ACCESS BY UNAUTHORIZED PERSONS.

## **B. DOCUMENTS**

1. THE INTENT OF THESE DRAWINGS AND SPECIFICATIONS IS TO DESCRIBE LABOR, MATERIALS, EQUIPMENT, AND SERVICES NECESSARY FOR WORK UNDER THIS CONTRACT. INCLUDE ALL WORK SHOWN, PRESCRIBED, OR REASONABLY IMPLIED BY THE CONTRACT DOCUMENTS. WHERE WORK OR EQUIPMENT IS INDICATED "NOT IN CONTRACT", SUCH WORK AND/OR EQUIPMENT SHALL BE PROVIDED BY OTHERS. CONTRACTOR SHALL COORDINATE AND COOPERATE TO EFFECT SUCH INSTALLATION.

2. THE CONTRACT DOCUMENTS, INCLUDING THE SPECIFICATIONS AND PLANS AND DRAWINGS, ARE COMPLIMENTARY AND WHAT IS CALLED FOR BY ANY ONE SHALL BE AS BINDING AS IF CALLED FOR BY ALL. SUBSEQUENT ADDENDA, INTERPRETATIONS, OR CHANGE ORDERS SHALL GOVERN OVER THE ORIGINAL DOCUMENTS, UNLESS A DIFFERENT ORDER OF PRECEDENCE IS NOTED ELSEWHERE IN CONJUNCTION WITH A

SPECIFIC PORTION OF THE DOCUMENTS. 3. THE DRAWINGS ARE DIAGRAMMATIC IN NATURE. ELEMENTS WITHIN THE DRAWINGS ARE DESCRIBED USING ABSTRACT GRAPHIC SYMBOLS AND

CONVENTIONS, WHICH REPRESENT BUILDING ELEMENTS. 4. ALL ITEMS INDICATED ARE NEW WORK UNLESS NOTED AS EXISTING OR (E). 5. THESE GENERAL NOTES APPLY TO THE ENTIRE WORK OF THIS CONTRACT 6. WITHIN THE DRAWINGS, OTHER GENERAL NOTES OCCUR WHICH DESCRIBE SPECIFIC TYPES OF WORK OR PROCEDURES, SUCH AS "DEMOLITON GENERAL NOTES". THESE NOTES APPLY TO ALL SIMILAR TYPES OF WORK OR PROCEDURES

WITHIN THE ENTIRE CONTRACT. 7. SHEET NOTES APPLY TO THE DRAWING SHEET ON WHICH THEY OCCUR. KEYNOTES REFER TO SPECIFIC ITEMS ON THE DRAWINGS. AND A KEYNOTE NUMBER ON ONE SHEET SHALL HAVE THE SAME MEANING ON EVERY SHEET. 8. ALL REQUESTS FOR CLARIFICATIONS OF THESE DRAWINGS SHALL BE DIRECTED TO THE CITY REPRESENTATIVE. REVIEW THE DOCUMENTS IN ADVANCE OF SCHEDULING THE WORK, AND MAKE REQUESTS FOR CLARIFICATION SUFFICIENTLY

IN ADVANCE TO AVOID DELAY

9. DO NOT SCALE DRAWINGS 10. CONTRACTOR SHALL FIELD VERIFY ALL DIMENSIONS PRIOR TO DEMOLITION, FABRICATION, ASSEMBLY, OR INSTALLATION OF ANY WORK.

11. ITEMS INDICATED TO BE VERIFIED OR FIELD VERIFIED ARE REQUIRED TO BE VERIFIED PRIOR TO ORDERING MATERIALS OR PROCEEDING WITH THE WORK. ITEMS SHALL BE VERIFIED FOR DESIGN INTENT AND COMPATIBILITY WITH APPROPRIATE BUILDING CODES.

12. NOT IN USE. 13. VERIFY ALL EXISTING CONDITIONS AND PROPOSED DIMENSIONS AT JOB SITE. EXISTING DIMENSIONS GIVEN ARE TAKEN FROM INFORMATION PROVIDED BY THE OWNER'S SURVEY. REVIEW ALL DRAWINGS AND DIMENSIONS BEFORE COMMENCING CONSTRUCTION MATERIAL AND AFFECTED CONSTRUCTION IN EXISTING OCCUPIED WORK AND NOTIFY CITY REPRESENTATIVE OF ANY DISCREPANCIES. DO NOT

PROCEED WITH WORK UNTIL DISCREPANCIES ARE RESOLVED. 14. WHERE ON ANY DRAWING A PORTION OF THE WORK IS DRAWN OUT AND THE REMAINDER IS INDICATED IN OUTLINE, THE DRAWN-OUT PARTS SHALL APPLY TO ALL 11. ALL FIRE ALARM INITIATING DEVICES (ALARM BOXES) TO BE MOUNTED PER T-24 OTHER LIKE PORTIONS OF THE WORK. WHERE ORNAMENT OR OTHER DETAIL IS INDICATED AS STARTING, SUCH DETAIL SHALL BE CONTINUED THROUGHOUT THE COURSES OR PARTS IN WHICH IT OCCURS AND SHALL ALSO APPLY TO OTHER

SIMILAR PARTS IN THE WORK, UNLESS OTHERWISE INDICATED. 15. IN CASE OF CONFLICT BETWEEN THE DOCUMENTS, THE DOCUMENT CONTAINING ADDITIONAL QUANTITIES SHALL GOVERN IN MATTERS OF QUANTITY, AND THE DOCUMENT REQUIRING A HIGHER DEGREE OF QUALITY SHALL GOVERN IN MATTERS OF QUALITY. IN CASE OF CONFLICT WITHIN THE DRAWINGS INVOLVING QUANTITIES OR WITHIN THE SPECIFICATIONS INVOLVING QUALITY, THE GREATER QUANTITY AND THE HIGHER QUALITY SHALL BE FURNISHED. THE CONTRACTOR SHALL NOTIFY THE ARCHITECT OF ALL SUCH QUANTITY AND QUALITY CONFLICTS AND SHALL AGREE

UPON RESOLUTION, IN WRITING, PRIOR TO PROCEEDING. 16. STRUCTURAL DRAWINGS GOVERN FOR SPACING AND SIZING FOR ALL STRUCTURAL MEMBERS, REINFORCING AND INSTALLATION DETAILS. VERIFY ANY CONFLICT BETWEEN STRUCTURAL AND OTHER DOCUMENTS WITH THE ARCHITECT PRIOR TO PROCEEDING.

17. WORK NOT DETAILED, MARKED OR SPECIFIED IN PARTICLUAR, WILL BE AS SIMILAR WORK THAT IS DETAILED, MARKED, OR SPECIFIED, ALL TYPICAL DETAILS SHALL BE USED WHERE APPLICABLE UNLESS NOTED OTHERWISE. ALL DETAILS SHALL BE CONSIDERED TYPICAL AT SIMILAR CONDITIONS. 18. THE TERM "TYPICAL" (TYP) SHALL MEAN APPLYING TO ALL LIKE OR SIMILAR

CONDITIONS IN THE AREAS DESIGNATED FOR WORK. 19. DIMENSIONS GIVEN AS NOMINAL ARE FOR REFERENCE ONLY. ACTUAL

DIMENSIONS MUST BE VERIFIED THROUGH FIELD LAYOUT 20. ALL PLAN DIMENSIONS ARE GIVEN TO FACE OF FINISH AND CENTERLINE OF WINDOWS UNLESS OTHERWISE NOTED. VERTICAL DIMENSIONS GIVEN TO TOP OF SLAB AND TOP OF PLYWOOD FLOOR OR ROOF SHEATHING UNLESS OTHERWISE

21. ALL DOORS ARE DIMENSIONED FROM ADJACENT WALL TO HINGE SIDE OF FRAME ACCORDING TO TYPICAL DOOR FRAME DETAIL, UNLESS OTHERWISE NOTED. 2. ALL FAUCET CONTROLS AND OPERATING MECHANISMS SHALL BE OPERABLE 22. SEE DOOR AND WINDOW SCHEDULES FOR UNIT DIMENSIONS. SEE THE SCHEDULE OF KEYNOTES FOR A LIST OF KEYNOTES FOR THIS PROJECT. IF ANY KEYNOTE ON ANY ARCHITECTURAL SHEET IS ILLEGIBLE OR MISING REFER TO THE SCHEDULE OF KEYNOTES.

23. MATCH LINES ARE INDICATORS OF WHERE ADJOINING FLOOR PLANS MEET. SEE CCR TITLE 24 AT ACCESSIBLE TOILET FACILITIES. PLANS ON BOTH SIDES OF MATCH LINES FOR WORK OVERLAPPING MATCH LINE.

## C. FIELD CONDITIONS

1. THE CONTRACTOR SHALL MAINTAIN THE PUBLIC RIGHTS OF WAY AFFECTED BY CONSTRUCTION CLEAN AND FREE OF ALL SOIL, DEBRIS, TRASH, ETC., ON A DAILY BASIS. MAINTAIN SIDEWALKS, MEANS OF EGRESS, CORRIDORS, STAIRS, ETC. CLEAR, UNOBSTRUCTED AND FREE OF ALL SOIL, DEBRIS, TRASH, ETC., ON A DAILY BASIS. CLEAN EGRESS SHALL BE MAINTAINED AT ALL TIMES FOR ALL BUILDING OCCUPANTS.

2. THE CONTRACTOR SHALL SECURE PERMIT FROM GOVERNING AGENCIES FOR WORK IN RIGHTS OF WAY AND/OR SCAFFOLDING.

3. LOCATIONS OF ALL UTILITIES SHOWN ARE APPROXIMATE AND CONTRACTOR SHALL EXERCISE EXTREME CAUTION IN EXCAVATING AND TRENCHING ON THIS SITE TO AVOID INTERCEPTING EXISTING PIPING OR CONDUITS. IT SHALL BE THE RESPONSIBILITY OF THE CONTRACTOR TO LOCATE EXISTING UTILITIES WHETHER OR NOT SHOWN ON THESE DRAWINGS AND TO PROTECT THEM FROM DAMAGE. THE CITY IS NOT RESPONSIBLE FOR THE LOCATION OF UNDERGROUND UTILITIES OR STRUCTURES WHETHER OR NOT SHOWN OR DETAILED AND INSTALLED BY H. ROOFING AND INSULATION ANY OTHER CONTRACT. THE CONTRACTOR SHALL IMMEDIATELY NOTIFY THE CITY REPRESENTATIVE SHOULD ANY UNIDENTIFIED CONDITIONS BE DISCOVERED. THE CONTRACTOR SHALL BEAR ALL EXPENSE OF REPLACEMENT OF UTILITIES OR OTHER PROPERTY DAMAGED BY OPERATIONS IN CONJUNCTION WITH PROSECUTION OF THIS WORK 4. EXISTING UTILITIES AND IMPROVEMENTS DAMAGED DURING THE COURSE OF THE WORK SHALL BE PROMPTLY REPAIRED. EXISTING UTILITIES AND IMPROVEMENTS DAMAGED, FOR WHICH LOCATIONS WERE UNKNOWN, SHALL BE IMMEDIATELY BROUGHT TO THE OWNER'S AND ARCHITECT'S ATTENTION AND PROMPTLY REPAIRED AT HIS/HER DIRECTION. THE WORK REQUIRED TO REPAIR DAMAGED EXISTING UTILITIES AND IMPROVEMENTS FOR WHICH LOCATIONS WERE UNKNOWN WILL BE REVIEWED AND TAKEN UNDER CONSIDERATION AS EXTRA WORK.

# D. FIRE SAFETY

1. GENERAL: FIRE SAFETY DURING CONSTRUCTION SHALL COMPLY WITH CALIFORNIA FIRE CODE (CFC) CALIFORNIA CODE OF REGULATIONS (CCR)

TITLE 24. PART 9 ARTICLE 87. 2. ACCESS ROADS: FIRE DEPARTMENT ACCESS ROADS SHALL BE ESTABLISHED AND MAINTAINED IN ACCORDANCE SECTION 902. 3. WATER SUPPLY: WATER MAINS AND HYDRANTS SHALL BE OPERATIONAL IN ACCORDANCE WITH SECTION 903.

4. BUILDING ACCESS: ACCESS TO BUILDINGS FOR THE PURPOSE OF FIREFIGHTING SHALL BE PROVIDED. CONSTRUCTION MATERIAL SHALL NOT BLOCK ACCESS BUILDINGS, HYDRANTS OR FIRE APPLIANCES. 6. DEMOLITION OF BUILDINGS: SHALL COMPLY WITH SECTION 8706 AND APPLICABLE PROVISIONS OF SECTIONS 8704 AND 8705.

7. FIRE WATCH: MAINTAIN FIRE WATCH WHEN REQUIRED BY THE BUILDING ARCHITECT OR PROFESSIONAL ENGINEER WHO HAS BEEN DELEGATED OFFICIAL AND WHEN EXISTING FIRE PROTECTION SYSTEMS ARE SHUT DOWN FOR ALTERATIONS. FIRE WATCH SHALL REMAIN IN EFFECT UNTIL EXISTING PROTECTION SYSTEMS ARE RETURNED TO SERVICE OR AS ALLOWED BY THE BUILDING OFFICIAL

8. PENETRATIONS OF FIRE RATED MATERIALS OR ASSEMBLIES SHALL BE RESTORED TO EQUAL RATING. FIRE STOP SYSTEMS AS LISTED BY UNDERWRITERS LABORATORIES SHALL BE INSTALLED PER FIRE RESISTANCE DIRECTORY. FIRE STOP SYSTEMS SHALL BE AS SPECIFIED. 9. OBTAIN APPROVAL FROM LOCAL FIRE AUTHORITY PRIOR TO STORAGE OF BUILDING.

10. PROTECT SMOKE DETECTORS NEAR CONSTRUCTION AREAS WITH A VISQUEEN OR SIMILAR WRAP. REMOVE PROTECTION AT END OF EACH WORKING DAY. CCR PART 3 ARTICLE 760-9.

PROCEDURES SHALL BE APPROVED BY THE BUILDING INSPECTOR PRIOR TO THE INSTALLATION. 13. ANY NEW EXIT SIGN SHALL BE INTERNALLY ILLUMINATED AND THE WORD 'EXIT' SHALL BE GREEN ON OPAQUE BACKGROUND PER CBC SECTION 1002.8.3.

12. ALL FIRE DAMPER ASSEMBLIES, INCLUDING SLEEVES AND INSTALLATION

14. PROVIDE ONE CIRCUIT FOR ANY NEW EXIT SIGNS TO CONFORM TO CBC SECTION 1003.2.8.4. AND 1003.2.8.5. 15. ALL CEILING AND MECHANICAL EQUIPMENT PLENUMS THAT ARE NEW OR TO ALL BE CLEAN AND FREE OF DEBRIS PRIOR TO CLOSING IN

# E. EXTERIOR ACCESSIBILITY

AND PRIOR TO RETURN AIR FAN START-UP.

1. ALL NEW WALKS AND SIDEWALKS SHALL HAVE A CONTINUOUS COMMON SURFACE, NOT INTERRUPTED BY STEPS OR BY ABRUPT CHANGES IN LEVEL, AND SHALL BE A MINIMUM OF 48" WIDE.

3. ALL NEW SURFACES WITH A SLOPE GREATER THAN 6 PERCENT GRADIENT SHALL BE AT LEAST AS SLIP RESISTANT AS THAT DESCRIBED AS A HEAVY BROOM FINISH. 4. ALL NEW SURFACE CROSS SLOPES SHALL NOT EXCEED 1/4 INCH PER FOOT. 5. ALL WALKS WITH CONTINUOUS GRADIENTS SHALL HAVE AT LEAST 5 FEET IN LANDING LENGTH AT INTERVALS OF EVERY 30 INCHES IN VERTICAL RISE. 6. SURFACE SLOPE FOR ACCESSIBLE PARKING SPACES FOR THE PHYSICALLY DISABLED SHALL NOT EXCEED 1/4 INCH PER FOOT IN ANY DIRECTION.

### F. INTERIOR ACCESSIBILITY

1. ALL HOT WATER AND DRAINPIPES UNDER LAVATORIES SHALL BE INSULATED OR OTHERWISE COVERED. THERE SHALL BE NO SHARP OR ABRASIVE SURFACES UNDER LAVATORIES.

WITH ONE HAND AND SHALL NOT REQUIRE TIGHT GRASPING, PINCHING OR TWISTING OF THE WRIST. THE FORCE REQUIRED TO ACTIVATE CONTROLS SHALL BE NO MORE THAN FIVE POUNDS. 3. ACCESSIBLE TOILET ROOM IDENTIFICATION SYMBOLS ARE TO BE PROVIDED PER

4. ANY NEW DRINKING FOUNTAIN SHALL BE ACTIVATED BY A CONTROL WHICH IS EASILY OPERATED BY A PHYSICALLY CHALLENGED PERSON SUCH AS A HAND-OPERATED LEVER TYPE CONTROL LOCATED WITHIN 6 INCHES OF THE FRONT OF THE DRINKING FOUNTAIN, ETC. THE BUBBLER SHALL BE SUBSTANTIALLY PARALLEL TO THE FRONT EDGE OF THE DRINKING FOUNTAIN.

# G. CONSTRUCTION

1. PENETRATIONS IN FIRE RATED ASSEMBLIES AND BEARING WALLS SHALL BE PROTECTED AS REQUIRED BY CBC CHAPTER 7.

2. ALL NEW FINISH MATERIALS SHALL BE MAINTAINED IN A FLAME RETARDANT CONDITION. (CCR T-19, SEC. 1.14, 3.08, 3.21). 3. ANY NEW FURRED CEILINGS SHALL BE CONSTRUCTED AS REQUIRED IN CBC SEC

2504 AND TABLE 25A. 4. ANY NEW SUSPENDED ACOUSTICAL CEILING BOARD SHALL BE NON-COMBUSTIBLE.

5. ALL NEW WALL AND CEILING MATERIALS IN EXIT CORRIDORS SHALL COMPLY WITH CBC SEC. 1005.

1. WHERE CEILING OR ROOF MOUNTED EQUIPMENT/ PENETRATIONS ARE REQUIRED TO BE REMOVED OR INSTALLED/ RE-INSTALLED, PROVIDE ROOFING AND FLASHING TO ACCOMMODATE THE CONDITION.

2. ALL INSULATION MATERIAL SHALL MEET THE CALIFORNIA QUALITY STANDARD PER SECTION 2.5311 B.E.E.S.-1986. ROOF INSULATION SHALL MEET CBC SECTION 1510 AND WALL INSULATION SHALL MEET CBC SECTION 1807.2. 3. ALL ROOFING SHALL BE CLASS A FIRE RETARDANT.

## 1. DEMOLITION

 DEMOLISH AND REMOVE FROM THE PREMISES ALL PARTS OF THE EXISTING BUILDING INDICATED FOR DEMOLITION OR REQUIRED TO BE DEMOLISHED FOR THE INSTALLATION OF NEW WORK.

2. ALL ITEMS NOTED TO BE SALVAGED SHALL BE RETURNED TO THE OWNER. THE OWNER RETAINS THE RIGHT TO SALVAGE ANY EXISTING MATERIAL INDICATED OR REQUIRED TO BE REMOVED OR DEMOLISHED.

3. THE CONTRACTOR IS RESPONSIBLE FOR REVIEWING AND FIELD VERIFYING DEMOLITION REQUIREMENTS IN RELATION TO CONSTRUCTION DRAWINGS. THE ARCHITECT IS TO BE NOTIFIED OF ANY CONFLICTS. DISCREPANCIES OR PROBLEMS. 4. CONSTRUCTION DEBRIS AND WASTES SHALL BE DEPOSITED AT AN APPROPRIATE SITE. THE CONTRACTOR SHALL AT ALL TIMES KEEP PREMISES FREE FROM ACCUMULATION OF DEBRIS CAUSED BY ITS OPERATIONS. AT THE COMPLETION OF THE WORK, CONTRACTOR SHALL CLEAN ALL GLASS SURFACES AND LEAVE THE WORK IN A CLEAN CONDITION READY FOR OCCUPANCY.

# J. **DEFERRED APPROVAL ITEMS:**

INSTALLATION OF DEFERRED APPROVAL ITEMS SHALL NOT BE STARTED UNTIL DETAILED PLANS, SPECIFICATIONS, AND ENGINEERING CALCULATIONS HAVE BEEN ACCEPTED AND SIGNED BY THE ARCHITECT OR ENGINEER IN GENERAL RESPONSIBLE CHARGE OF DESIGN AND SIGNED BY A CALIFORNIA REGISTERED RESPONSIBILITY COVERING THE WORK SHOWN ON A PARTICULAR PLAN OR SPECIFICATION AND APPROVED BY THE SAN FRANCISCO DEPARTMENT OF BUILDING INSPECTION.

		E.	EAST	JAN.	JANITOR	S	SOUTH
	ANGLE	(E)	EXISTING	JST.	JOIST	S.A.D.	SEE ARCHITECTURAL
L	CENTERLINE	ÈÁ.	EACH	JT.	JOINT	0.7	DRAWINGS
	DIAMETER OR ROUND	E.B.	EXPANSION BOLT			SB	SPLASH BLOCK
		E.J.	EXPANSION JOINT	K.O.	KNOCKOUT	S.C.D.	SEE CIVIL DRAWINGS
	ANCHOR BOLT	ELEC.	ELECTRIC			SCD	SEAT COVER DISPENSER
	ABOVE	ELEV.	ELEVATION	LAM.	LAMINATE	SCHED.	SCHEDULE
	ACCESSIBLE		EMERGENCY	LAV.	LAVATORY	S.E.D.	SEE ELECTRICAL
	ACOUSTICAL ACOUSTICAL CEILING TILE	E.Q.	EQUAL	LBL.	LABEL		DRAWINGS
	AIR CONDITIONED	_ ~ ~	EQUIPMENT	LBS.	POUNDS	SHT.	SHEET
	AREA DRAIN	E.W.	EACH WAY	L.P.	LOW POINT	SHTG.	SHEATHING
	ADJUSTABLE	EXH. EXP.	EXHAUST	LT.	LIGHT	SIM.	SIMILAR
	ABOVE FINISHED FLOOR	EXP. EXT.	EXPANSION EXTERIOR	N 4 A 3/	NA A MINALINA	S.L.D.	SEE LANDSCAPE
	AGGREGATE	EXI.	EXTERIOR	MAX.	MAXIMUM MACHINE BOLT	CMD	DRAWINGS
	ALUMINUM	F.A.	FIRE ALARM	M.B. MECH.	MACHINE BOLT	S.M.D.	SEE MECHANICAL DRAWINGS
	ALUMINUM	F.D.	FLOOR DRAIN	MECH. MET.	MECHANICAL METAL	S.M.S.	SHEET METAL SCREW
	ALTERNATIVE	FDN.	FOUNDATION	MFR.	MANUFACTURER	SND	SANITARY NAPKIN
	ANCHOR	FEC	FIRE EXTINGUISHER	MICRO.	MICROWAVE	SND	DISPOSAL
Р	ACCESS PANEL	•	CABINET	MIN.	MINIMUM	S.P.D.	SEE PLUMBING
PPROX.	APPROXIMATE	F.H.C.	FIRE HOSE CABINET	MIR	MIRROR	O.I .D.	DRAWINGS
	ARCHITECTURAL	F.H.M.S.	FLAT HEAD METAL	MISC.	MISCELLANEOUS	SPEC.	SPECIFICATION
	ASPHALT		SCREW	MTD.	MOUNTED	SQ.	SQUARE
T.R.D.	ABOVE TOP OF ROOF DECK	F.H.W.S.	FLAT HEAD WOOD	MTL.	METAL	S.S.D.	SEE STRUCTURAL
	ATTACHMENT		SCREW	MUL.	MULLION		DRAWINGS
UTO.	AUTOMATIC	FIN.	FINISH			SST.	STAINLESS STEEL
_	50455	F.G.	FINISH GRADE	N.	NORTH	ST.	STREET
	BOARD	FIXT.	FIXTURE	(N)	NEW	STD.	STANDARD
	BITUMINOUS	FL.	FLUSH	N.I.C.	NOT IN CONTRACT	STL.	STEEL
LDG.	BUILDING BLOCK	FLR.	FLOOR (ING)		NUMBER		STRUCTURAL
	BLOCKING		FLASHING	NOM.	NOMINAL	SYM.	SYMMETRICAL
	BEAM	FLOOR. F.O.	FLUORESCENT FACE OF	NR.	NON-RATED	_	TDE 4.5
	ВОТТОМ	F.O.C.	FACE OF CONCRETE	N.T.S.	NOT TO SCALE	T.	TREAD
	BRACKET	F.O.F.	FACE OF FINISH	0/	OVER	TEMP	TEMPERED
.U.	BUILT-UP	FPRF.	FIREPROOF		OVER OVERALL	T&G THK.	TONGUE AND GROOVE THICKNESS
	20.2. 0.	F.R.	FIRE RESISTIVE	O.A. O.C.	ON CENTER	THRES.	THRESHOLD
AB.	CABINET	F.S.	FULL SIZE	O.C. O.D.	OUTSIDE DIMENSION		TOP OF CURB
.B.	CATCH BASIN	F.T.	FIRE TREATED	O.H.	OVAL HEAD	T.O.P.	TOP OF PAVEMENT
.C.	CENTER TO CENTER	FT.	FOOT OR FEET	OPER.	OPERABLE	T.O.S.	TOP OF SLAB
	CEMENT	FTG.	FOOTING	OPNG.	OPENING	T.O.ST.	TOP OF STEEL
	CERAMIC TILE	FURR.	FURRING	OPP.	OPPOSITE	T.O.W.	TOP OF WALL
	CONTROL JOINT	FUT.	FUTURE	OZ.	OUNCE	TPD	TOILET PAPER
	CEILING	FXD.	FIXED				DISPENSER
	CLEAR			PL.	PLATE	TS	TUBULAR STEEL
	COLUMN	G	GAS	P/L	PROPERTY LINE	TYP.	TYPICAL
	CARPET COLD WATER	GA.	GAUGE	PLAS.	PLASTER		
	COMBINATION	GALV.	GALVANIZED		PLUMBING	U.B.C.	UNIFORM BUILDING
ONC.	CONCRETE	G.B. GL.	GRAB BAR GLASS	PLY.	PLYWOOD		CODE
	CONNECTION	GL. GSM.	GALVANIZED SHEET		PLYWOOD	UL	UNDERWRITERS
	CONSTRUCTION	OOW.	METAL	PR. PT.	PAIR POINT	U.O.N.	LABORATORY UNLESS OTHERWISE
	CONTINUOUS	GYP.	GYPSUM	P.T.	PRESSURE TREATED	U.U.IN.	NOTED
	COUNTER	GWB.	GYPSUM WALLBOARD	PTD	PAPER TOWEL		NOTED
TR.	CENTER	_		1 10	DISPENSER	VERT.	VERTICAL
TSK.	COUNTERSUNK	H.B.	HOSE BIB		2.6. 2.162.1	V.I.F.	VERIFY IN FIELD
		HDR.	HEADER	QTY.	QUANTITY		
	DOUBLE	HDWD.	HARDWOOD			W.	WEST
	DIAPER CHANGE STATION		HARDWARE	R.	RISE	W/	WITH
EPT.	DEPARTMENT	H.M.	HOLLOW METAL	RAD.	RADIUS	WC	WATER CLOSET
ET.	DETAIL	HORIZ.	HORIZONTAL	R.D.	ROOF DRAIN	WD	WOOD
.F.	DRINKING FOUNTAIN	H.P.	HIGH POINT	REC	RECESSED	WF	WIDE FLANGE
IA.	DIAGONAL	HR.	HOUR	REF.	REFERENCE	WH	WATER HEATER
IAG.	DIAGONAL	HT.	HEIGHT		REFRIGERATOR	W.O.	WHERE OCCURS
IM. ISP	DIMENSION DISPOSAL	H.W.	HOT WATER	REQ.	REQUIRED	W/O	WITHOUT
N	DOWN	I.D. IN	SIDE DIAMETER	RES.	RESILIENT	WSCT	WAINSCOT
.S.P.	DRY STANDPIPE	I.D. IN INFO.	INFORMATION	RET.	RETAINING	WR w.t	WASTE RECEPTACLE
TL.	DETAIL	INFO. INSUL.		R.H. RM.	ROUND HEAD ROOM	WT	WEIGHT
W	DISHWASHER		TERIOR	RIVI. RND.	ROUND		
WG.	DRAWING			RWL	RAINWATER LEADER		

**LEGEND** 

/ A.1 <sup>\</sup>

**ROOM NAME** 

201

X/A4.X

**CASEWORK** 

**DESIGNATION** 

COLUMN LINES

**ELEVATION** 

-drawing number on sheet

INTERIOR ELEVATION

-drawing number on sheet

drawing number on sheet

DETAIL REFERENCE

MATCH LINE

DIMENSION OR

ROOM NUMBER

DOOR NUMBER

PARTITION TYPE

—partition number

REFERENCE

\_interior elevation reference

-multiple door designation

-special treatment indication

**REVISION DESIGNATION** 

SPOT ELEVATION IN FEET

G = GRADE, I = INVERT

KEYNOTE REFERENCE

**CEILING HEIGHT** 

Above Finish Floor

-Keynote Number.

—corresponds to room #

WINDOW SCHEDULE

WORK POINT

—drawing number on sheet

-sheet on which section occurs

-sheet on which elevation occ

-sheet on which section occurs

-sheet on which elevation occur

# REGULATORY CODES

LIST OF APPLICABLE CODES - CALIFORNIA CODE OF REGULATIONS

1.1 2010 CALIFORNIA BUILDING STANDARDS ADMINISTRATIVE CODE, PART 1 TITLE 24 C.C.R.

CALIFORNIA AMENDMENTS)

1.3 2010 CALIFORNIA ELECTRICAL CODE (CEC), PART 3 TITLE 24 C.C.R.

1.4 2010 CALIFORNIA MECHANICAL CODE (CMC), PART 4, TITLE 24 C.C.R

1.7 2010 CALIFORNIA ELEVATOR SAFETY CONSTRUCTION CODE PART 7, TITLE 24 C.C.R

1.9 2010 CALIFORNIA EXISTING BUILDING CODE, PART 10, TITLE 24 C.C.R.

1.10 2010 CALIFORNIA REFERENCED STANDARDS, PART 12, TITLE 24 C.C.R

1.11 TITLE 19 C.C.R. PUBLIC SAFETY, STATE FIRE MARSHAL REGULATIONS

**ABBREVIATIONS** 

1.2 2010 CALIFORNIA BUILDING CODE (IBC), PART 2, TITLE 24 C.C.R. 2006 INTERNATIONAL BUILDING CODE VOLUMES 1-3 W/ 2007

1.5 2010 CALIFORNIA PLUMBING CODE (CPC), PART 5, TITLE 24 C.C.R 1.6 2010 CALIFORNIA ENERGY CODE (CEC) PART 6,TITLE 24 C.C.R.


1.8 2010 CALIFORNIA FIRE CODE, PART 9, TITLE 24 C.C.R.

15. ALL CEILING AN	ND	MEC
RECEIVE NEW WO	RK	SHA

2. ALL NEW SURFACES WITH A SLOPE LESS THAN 6 PERCENT GRADIENT SHALL BE AT LEAST AS SLIP RESISTANT AS THAT DESCRIBED AS A MEDIUM BROOM FINISH.


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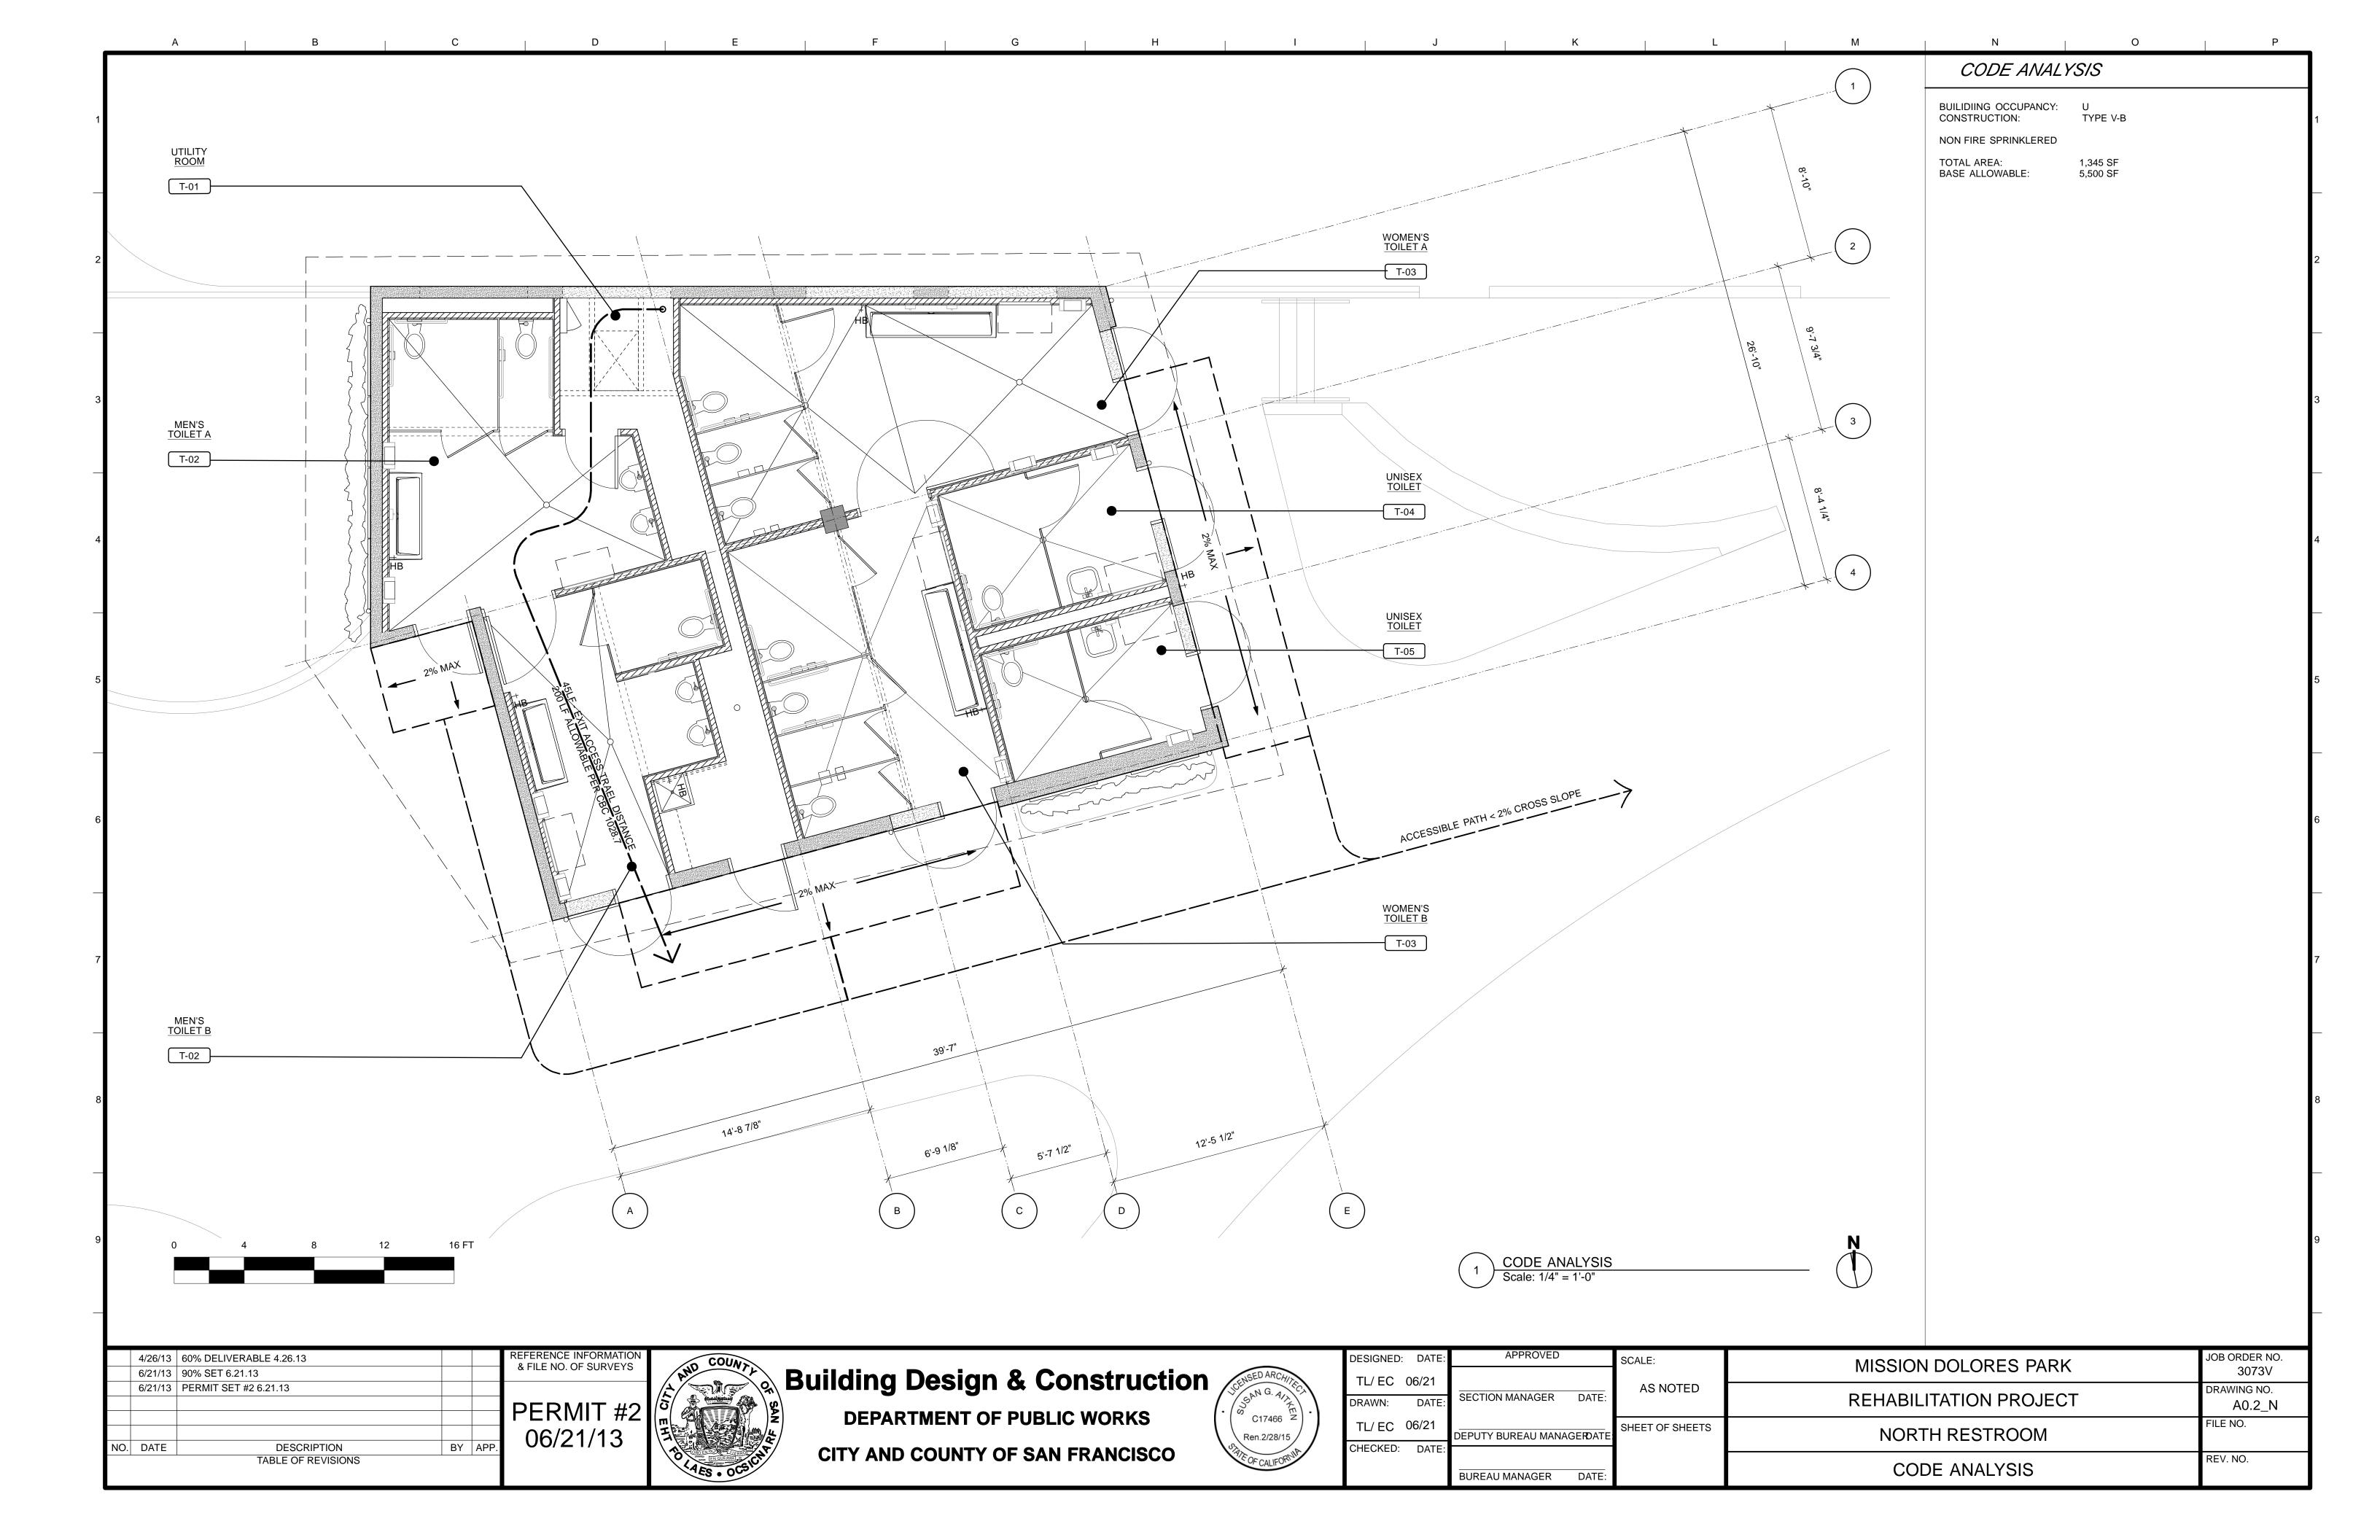
4/26/13 | 60% DELIVERABLE 4.26.13 REFERENCE INFORMATION & FILE NO. OF SURVEYS 6/21/13 | 90% SET 6.21.13 6/21/13 | PERMIT SET 6.21.13 8/02/13 | 100% COORDINATION SET 8.02.13 NO. DATE **DESCRIPTION** BY AP TABLE OF REVISIONS

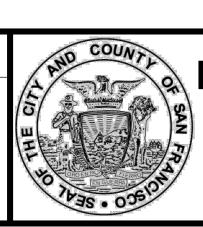



**Building Design & Construction DEPARTMENT OF PUBLIC WORKS** CITY AND COUNTY OF SAN FRANCISCO







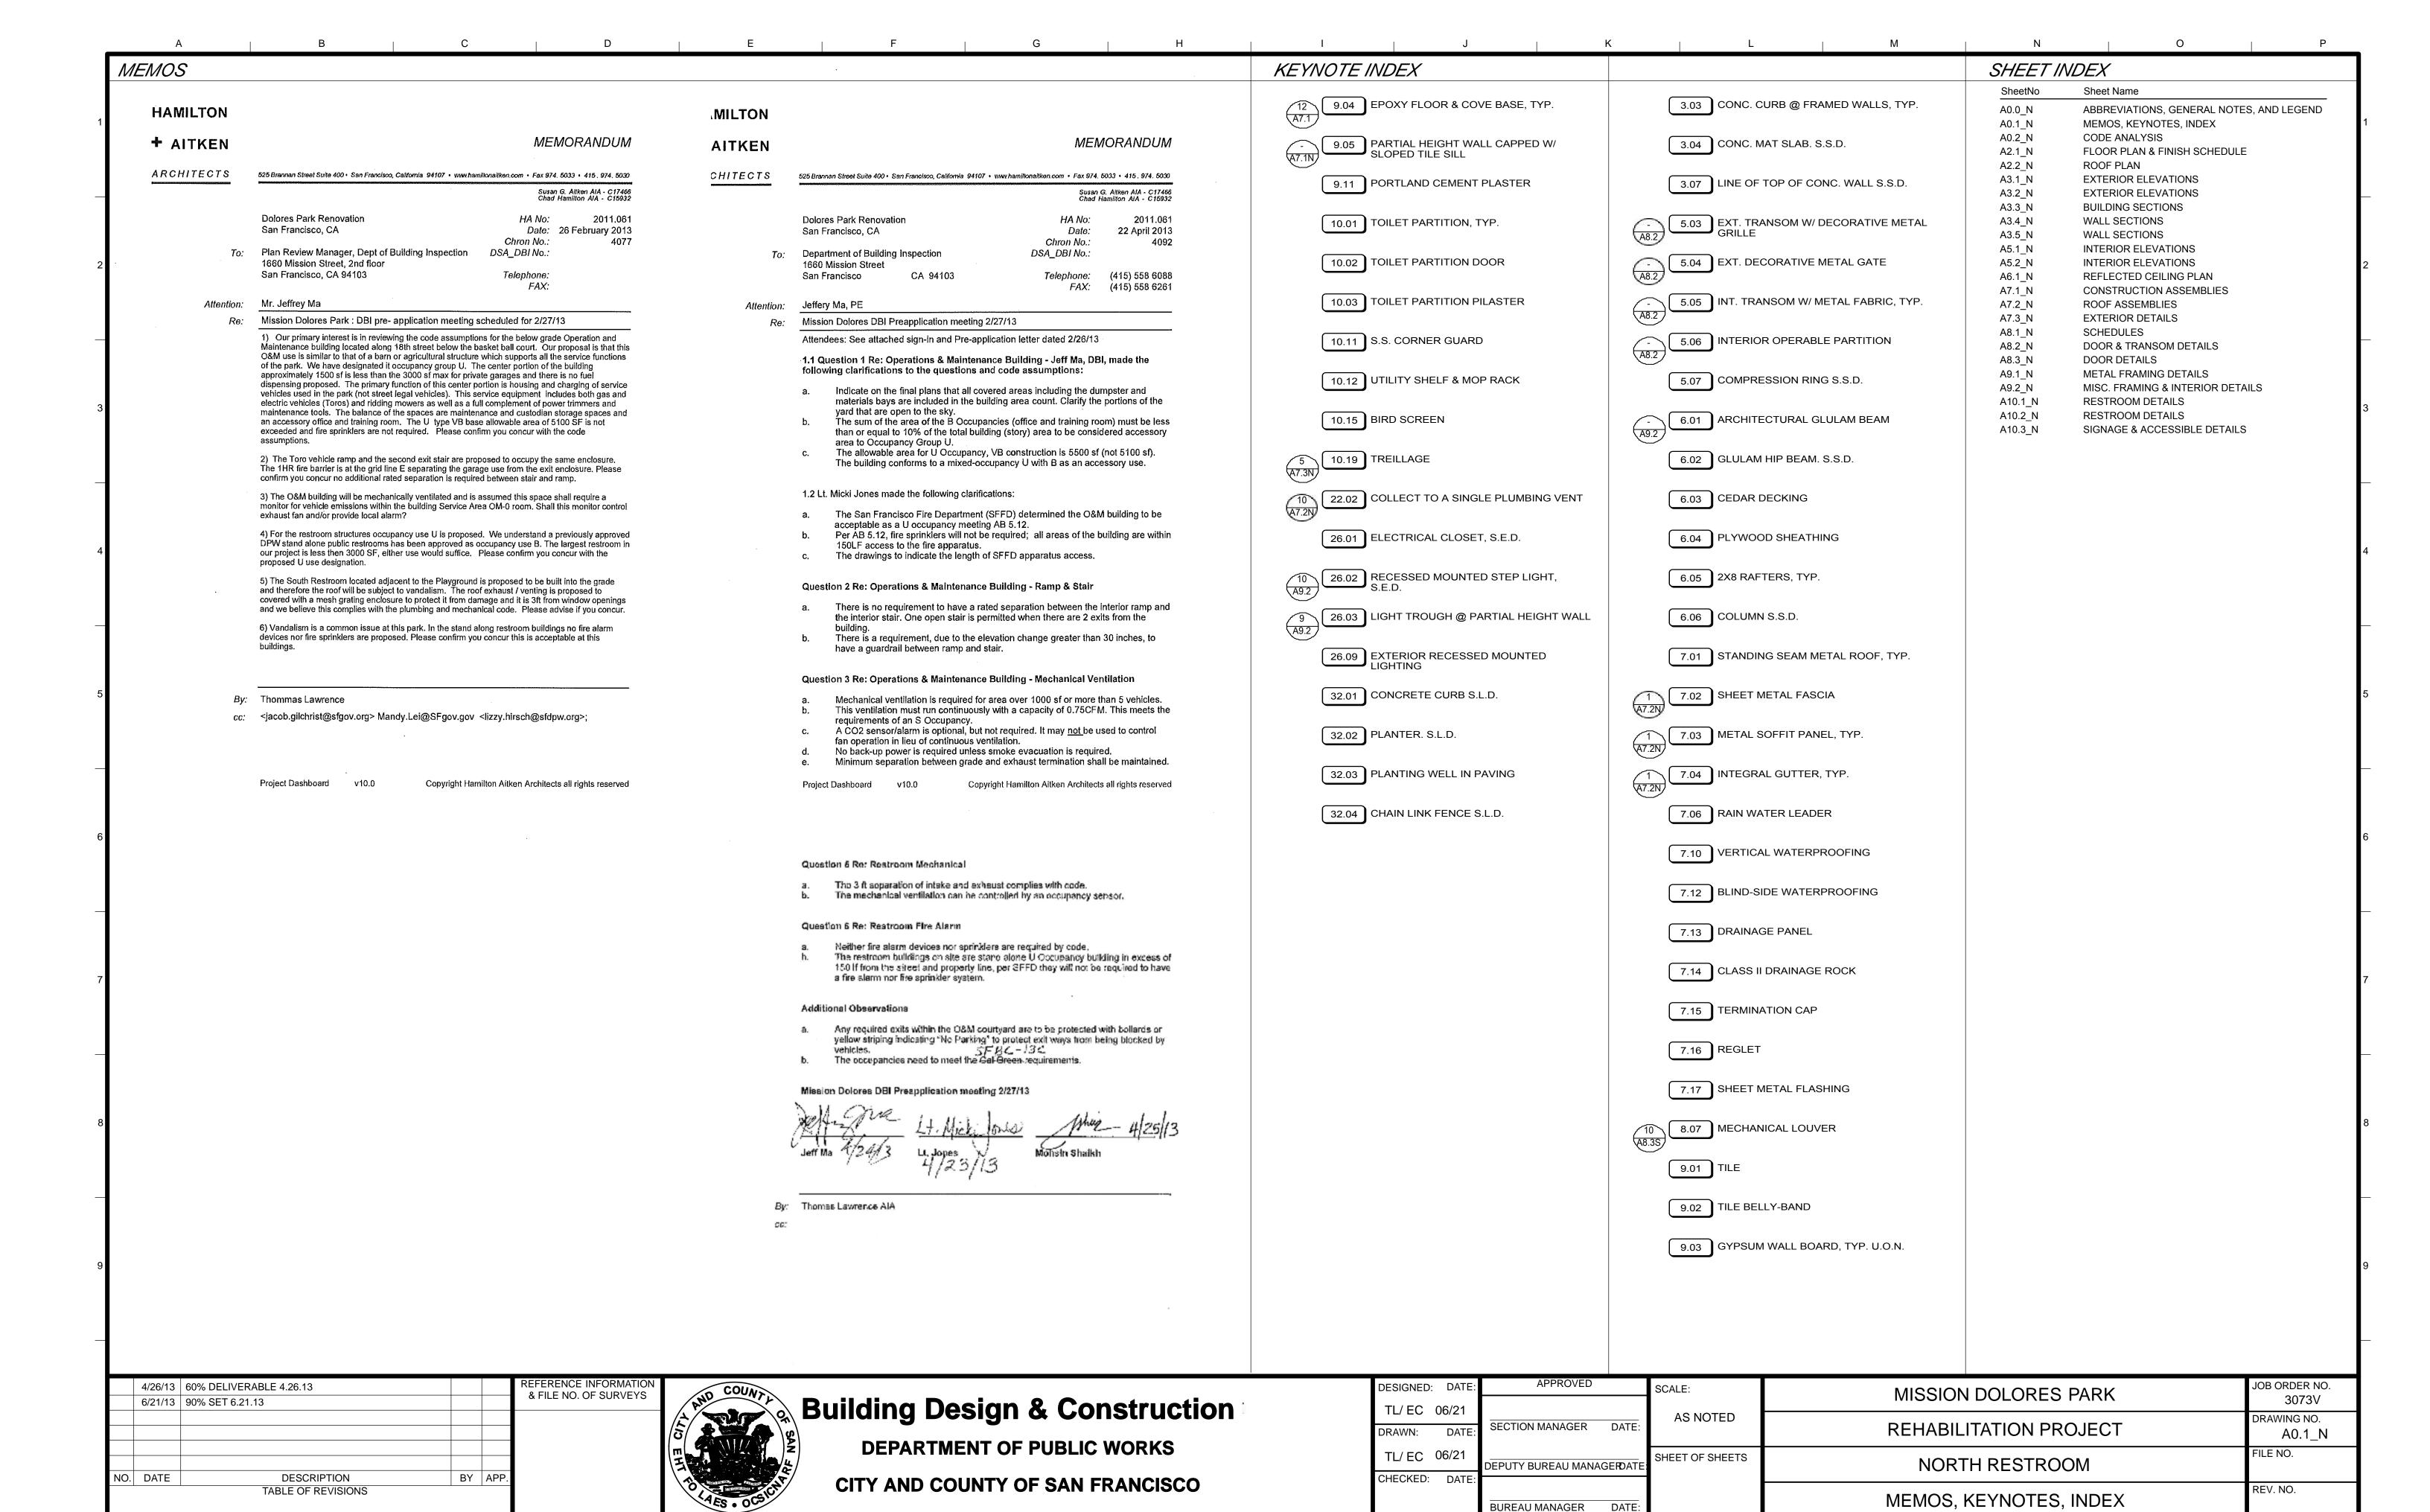


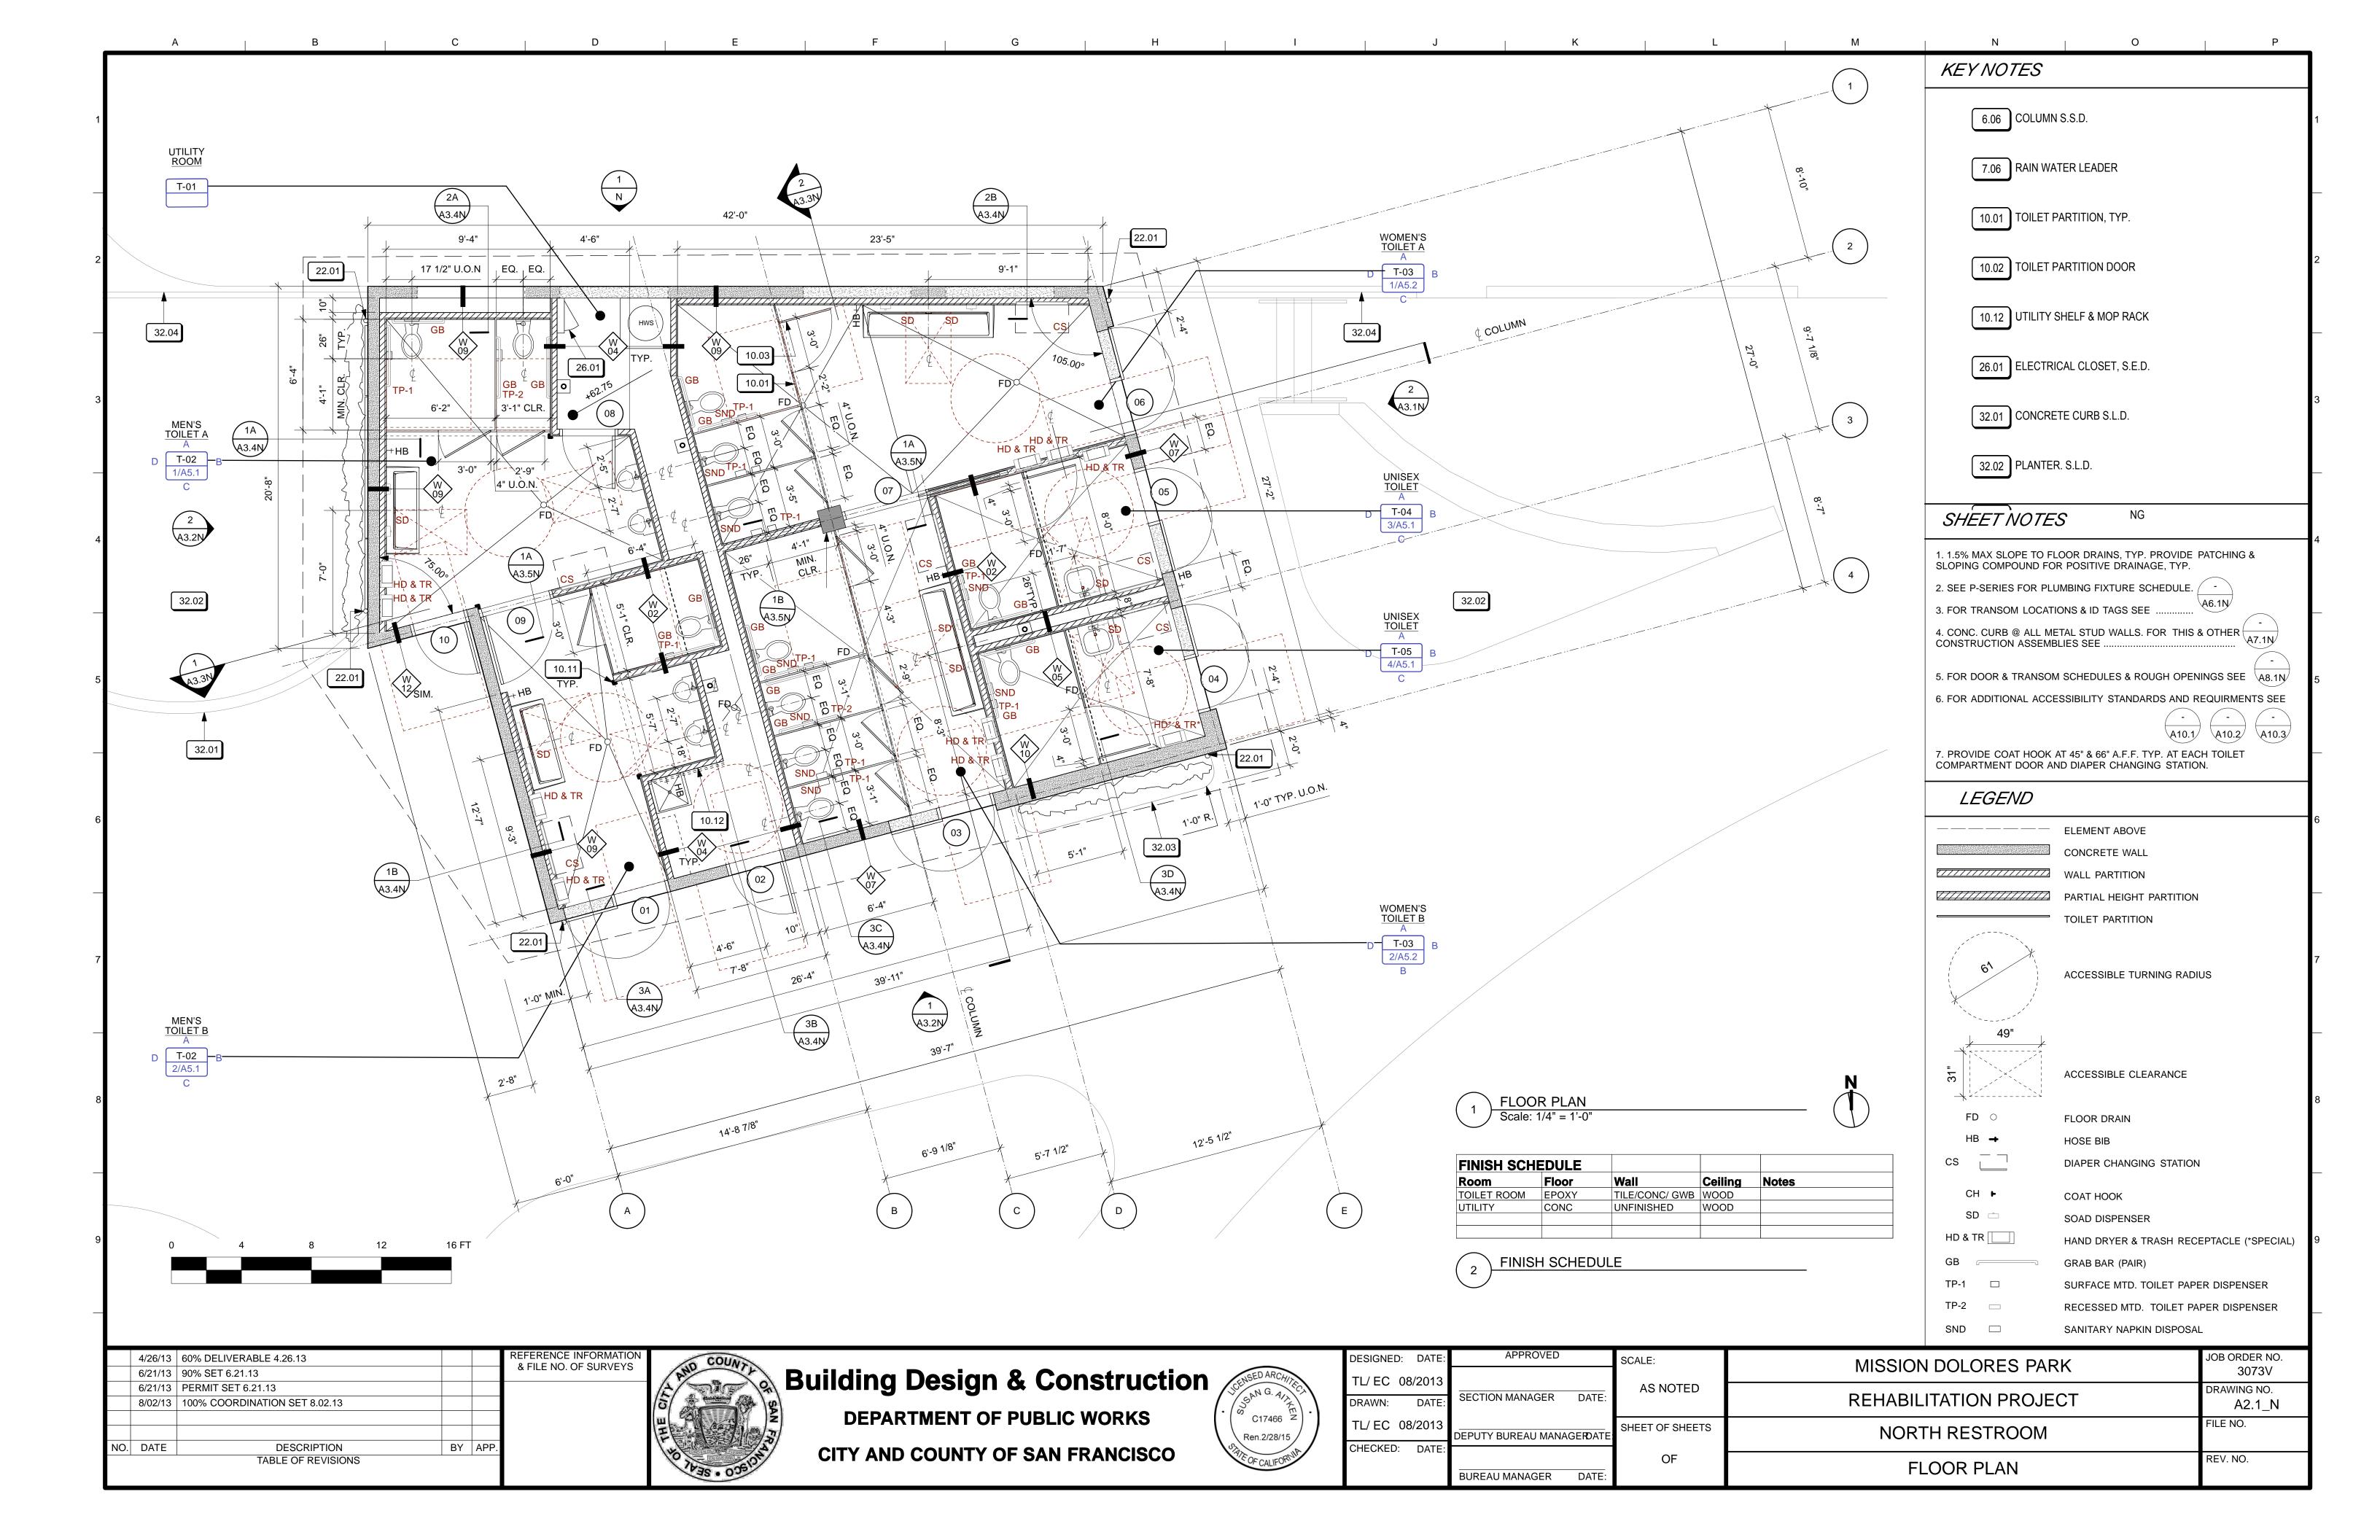


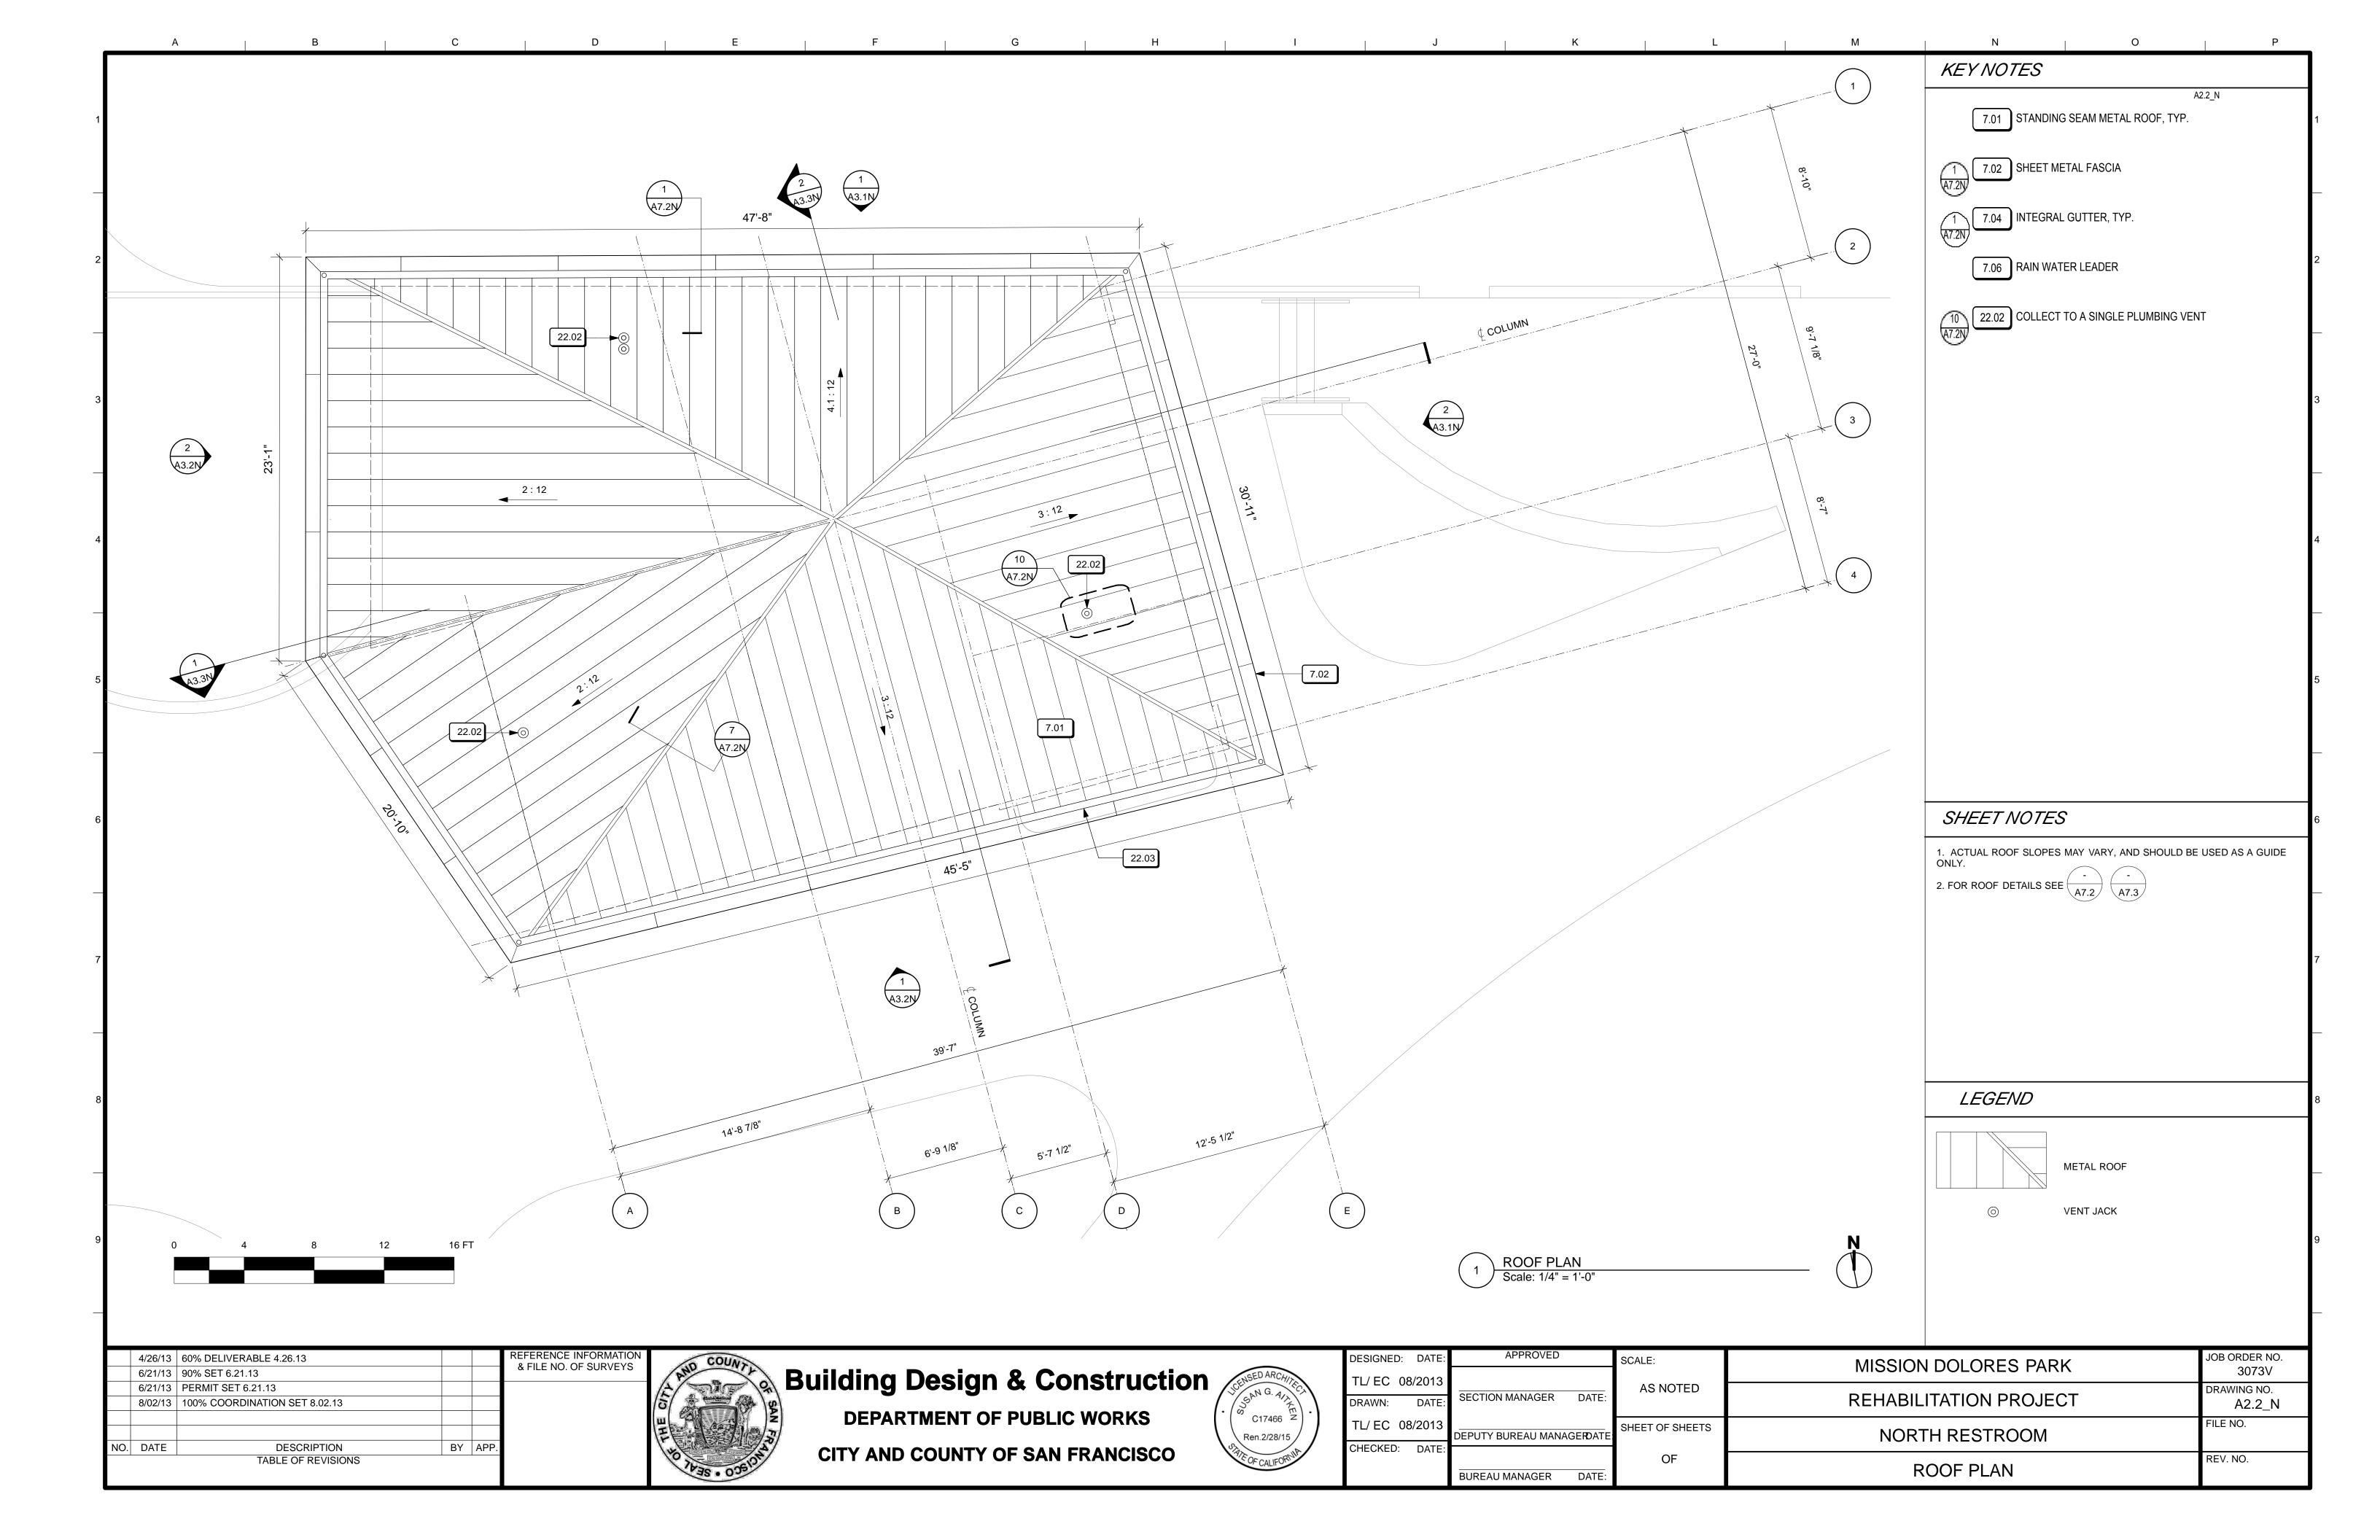


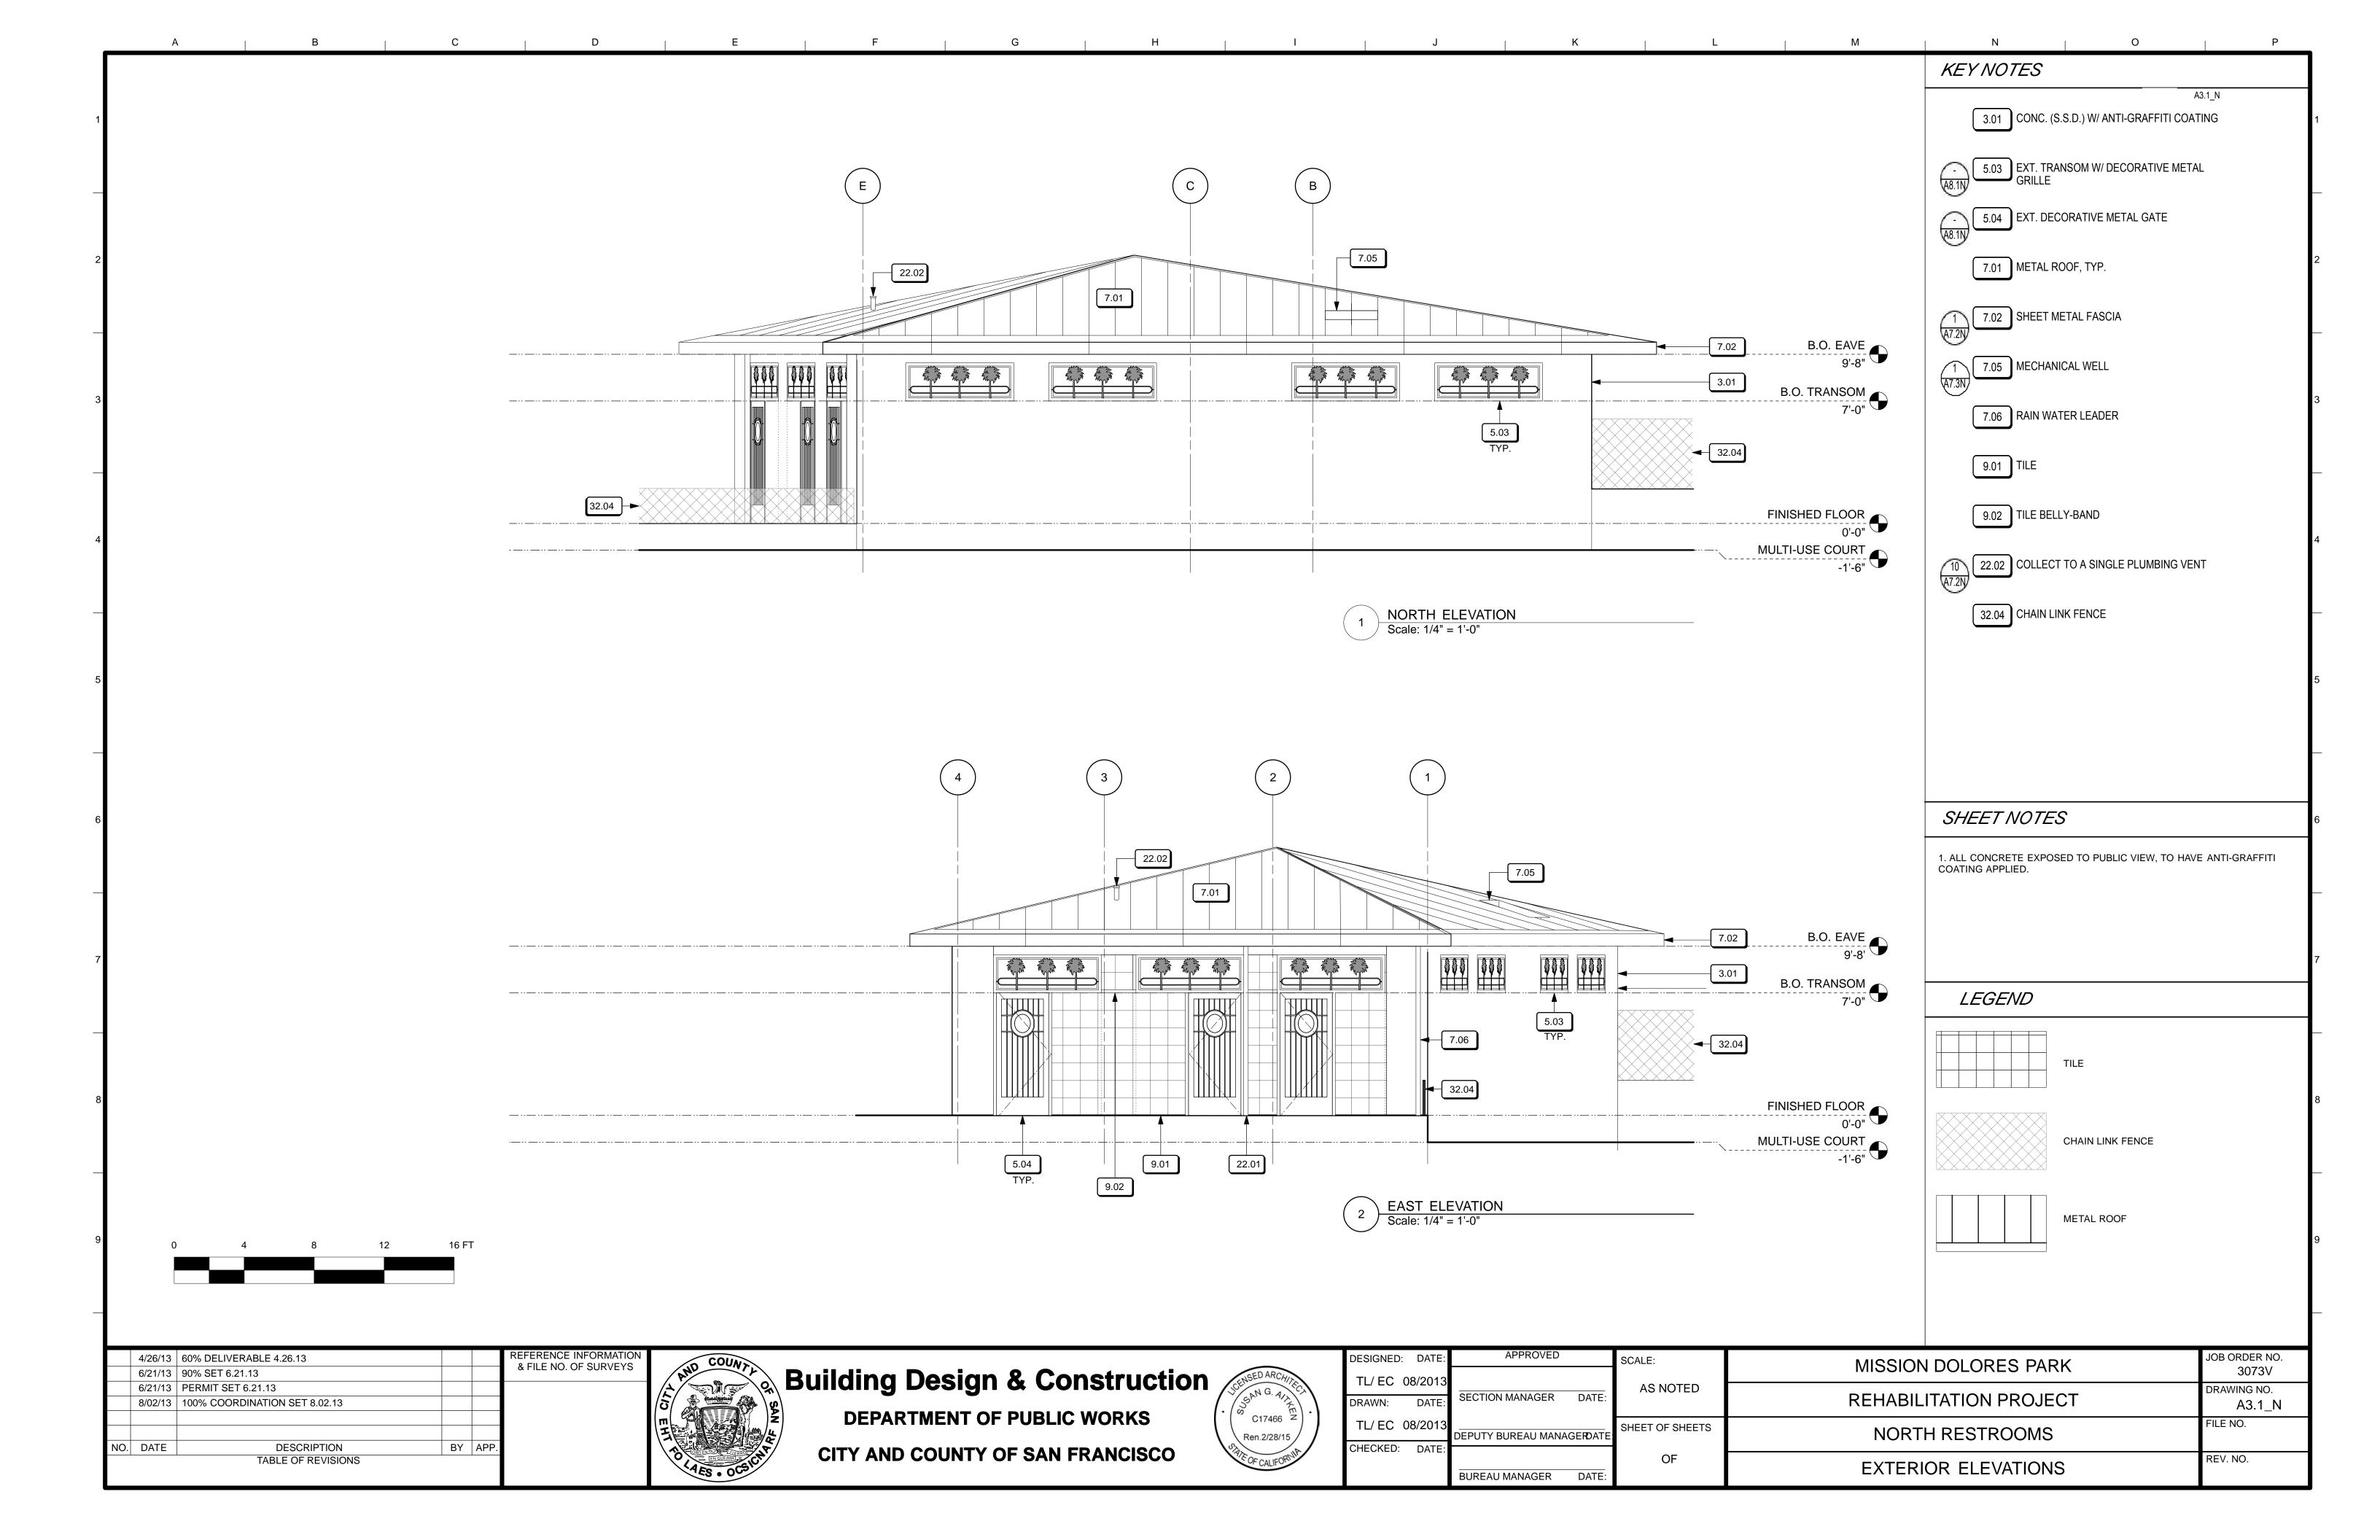


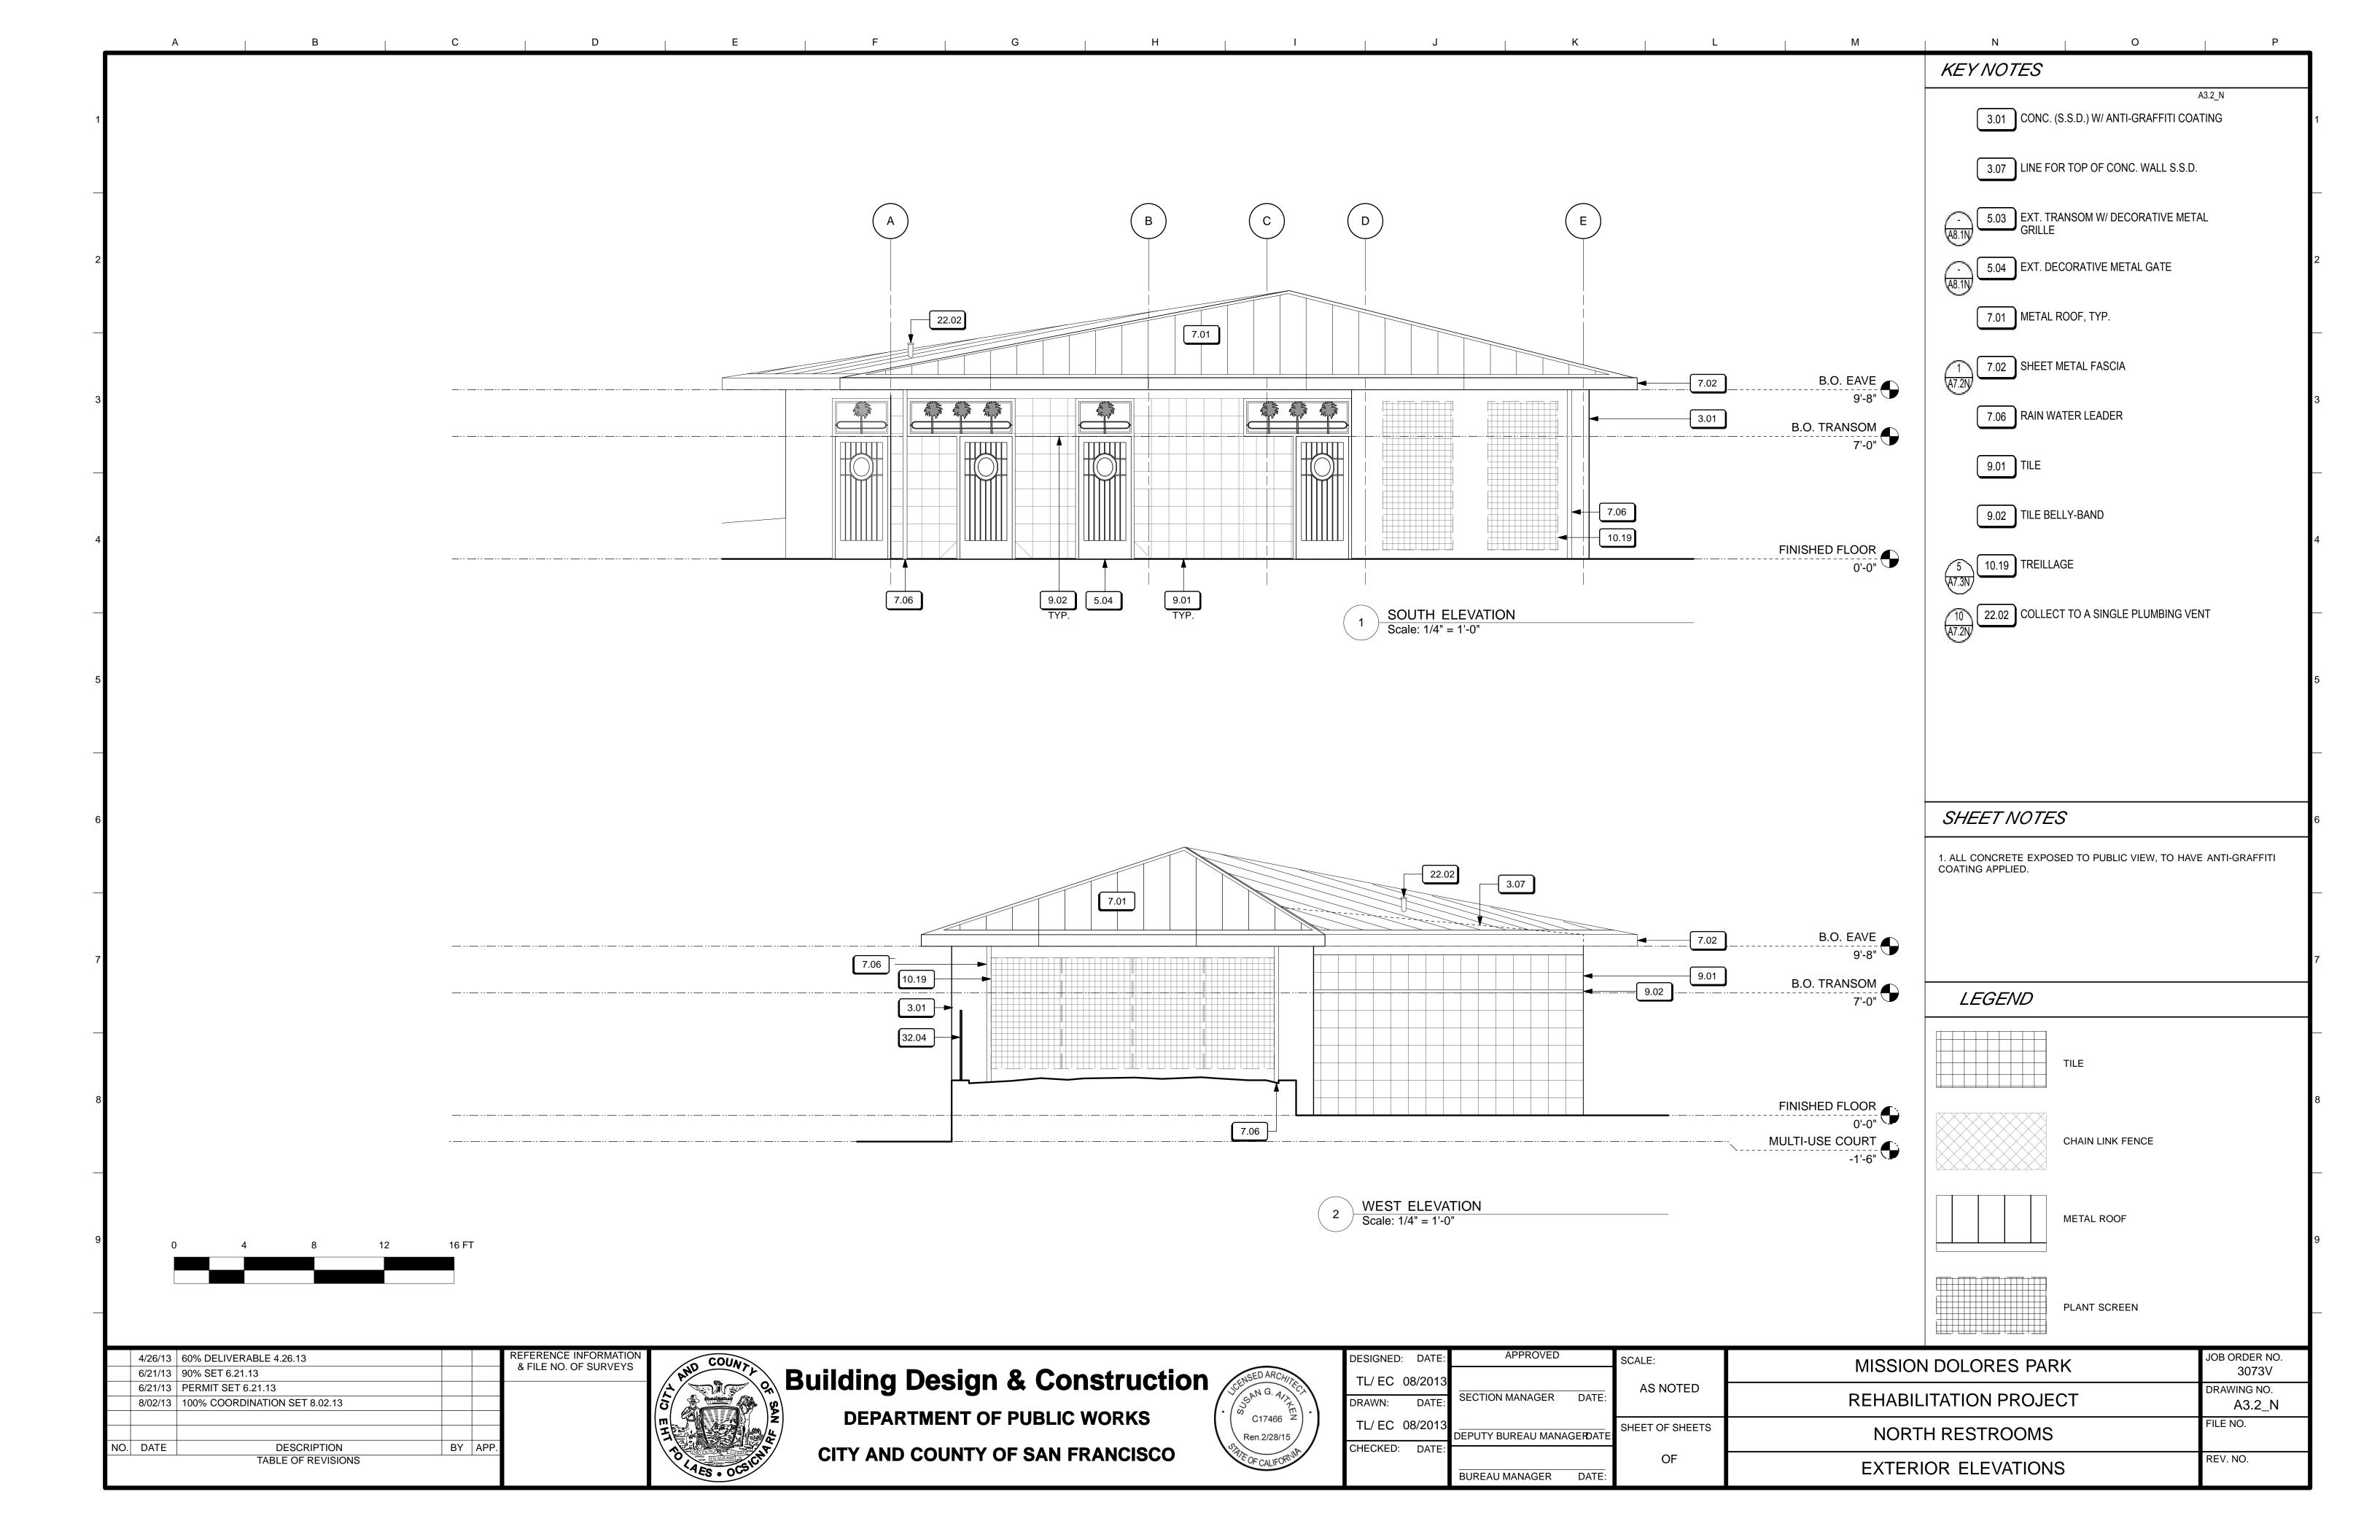


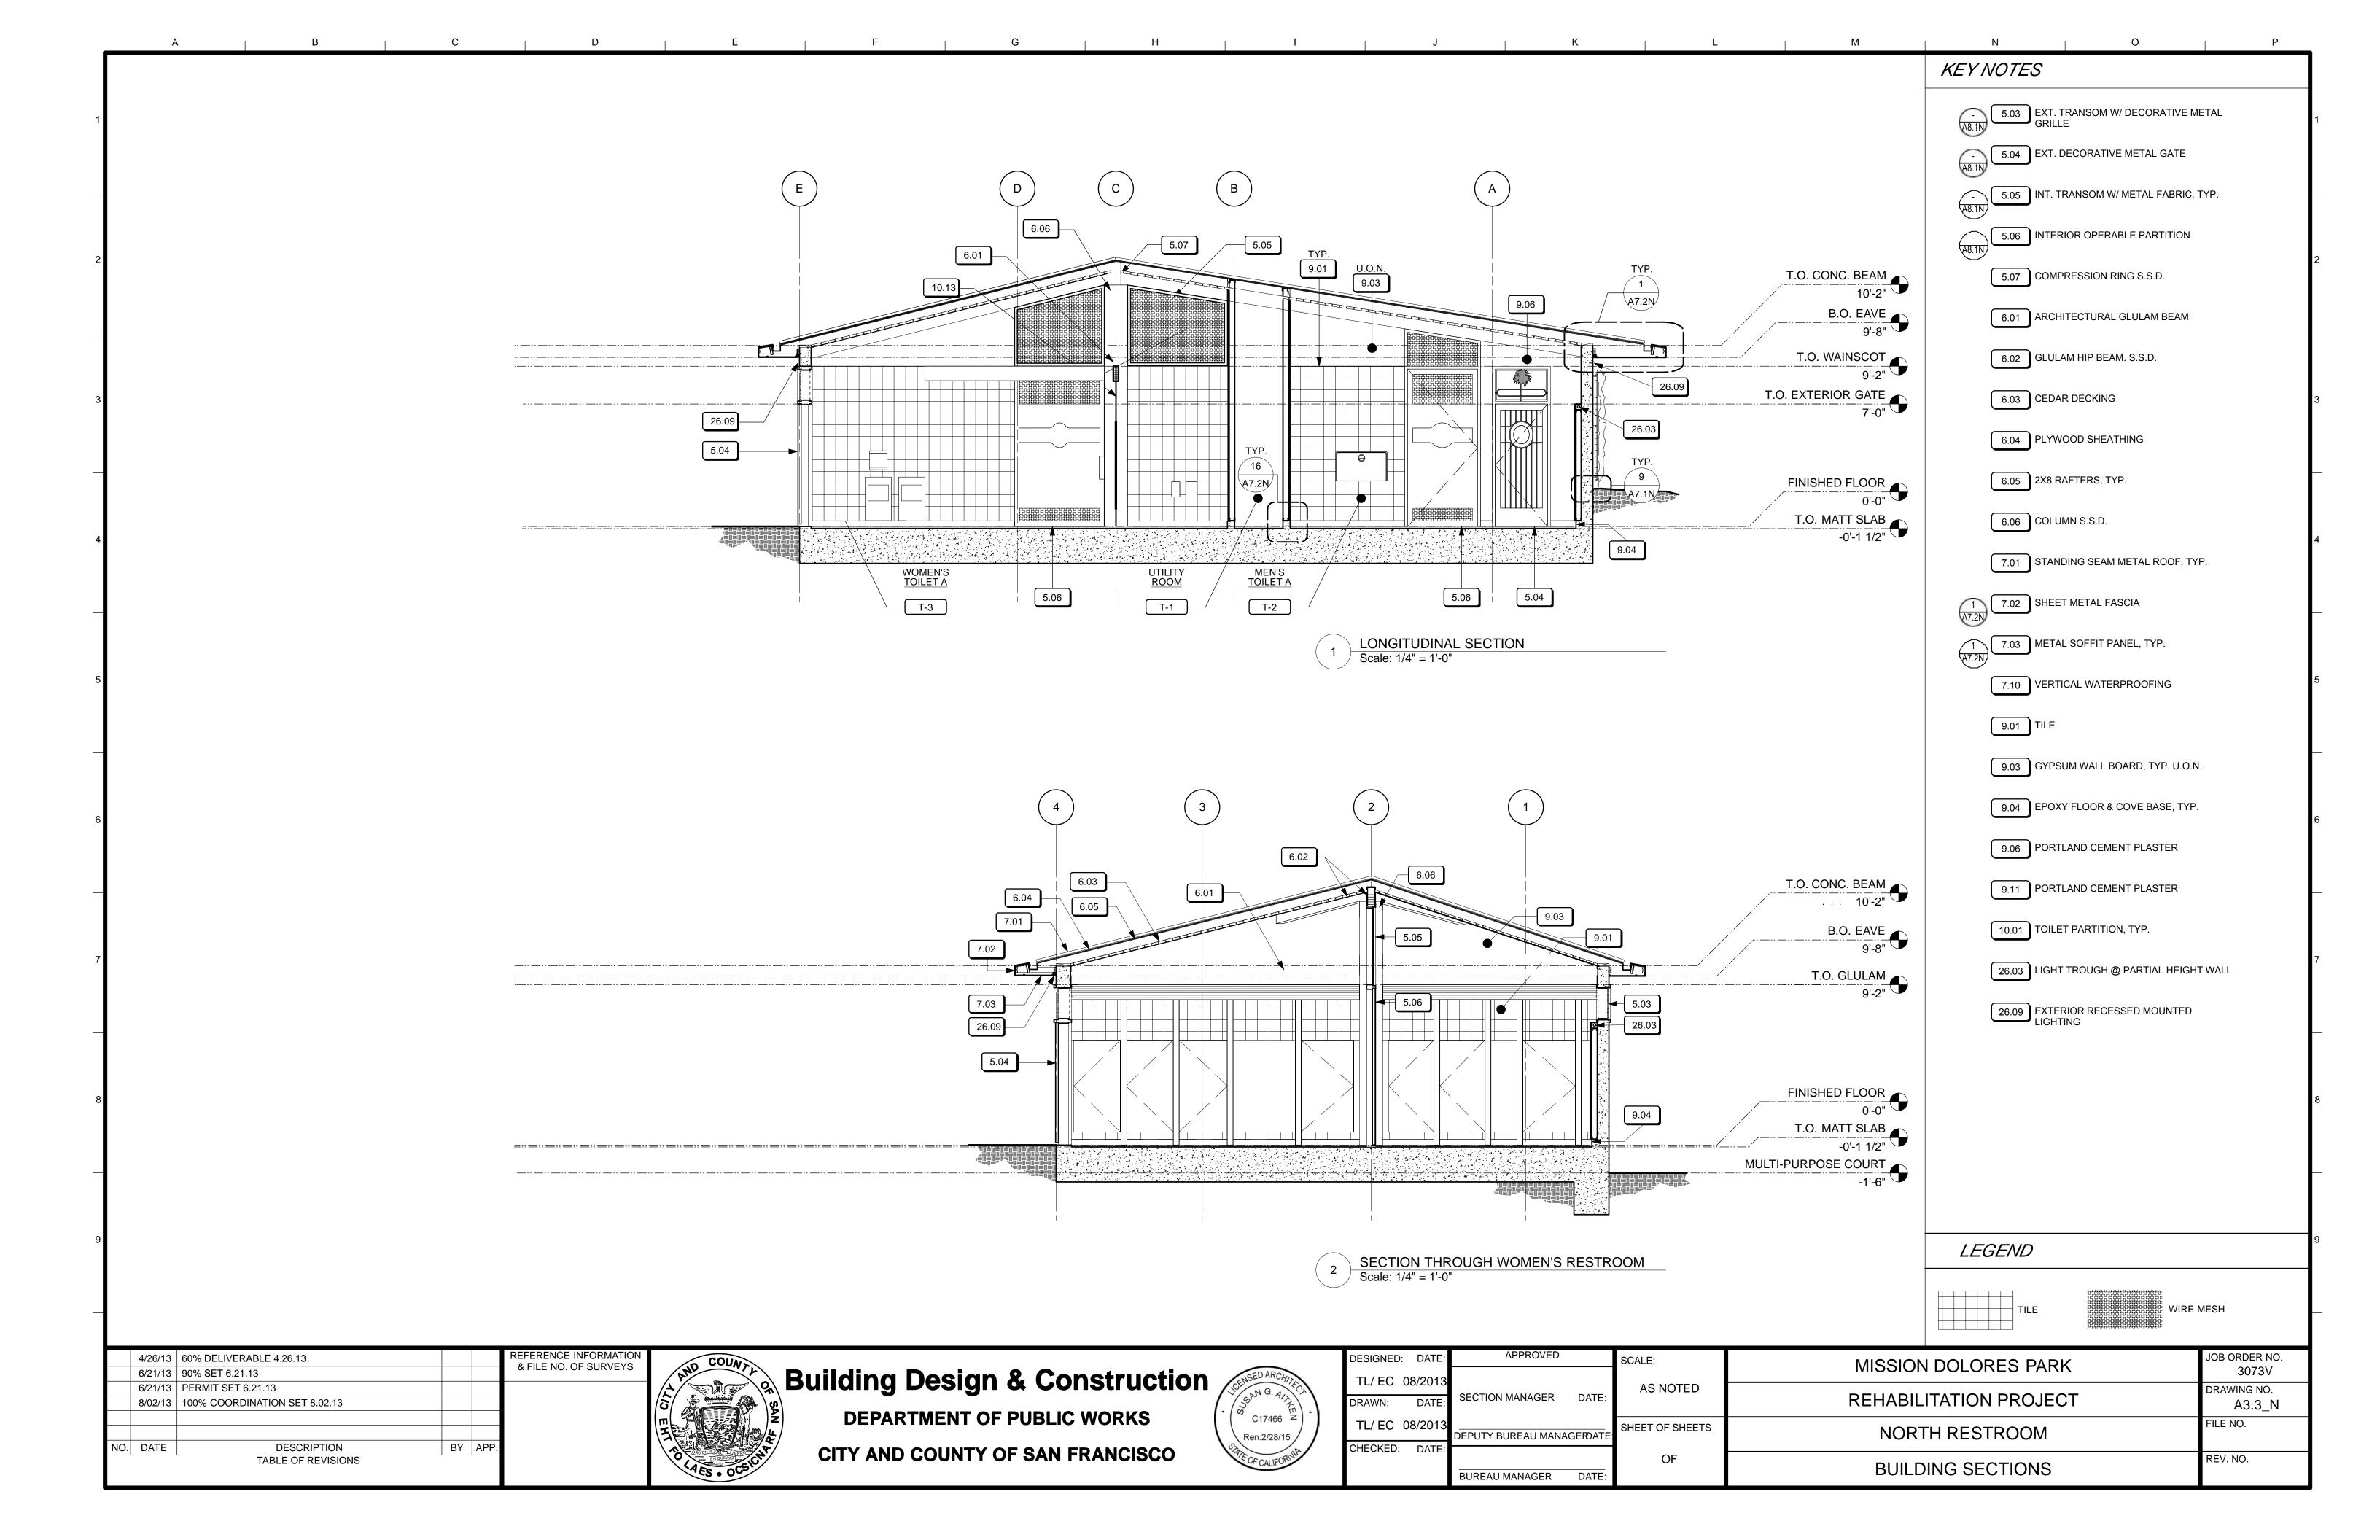


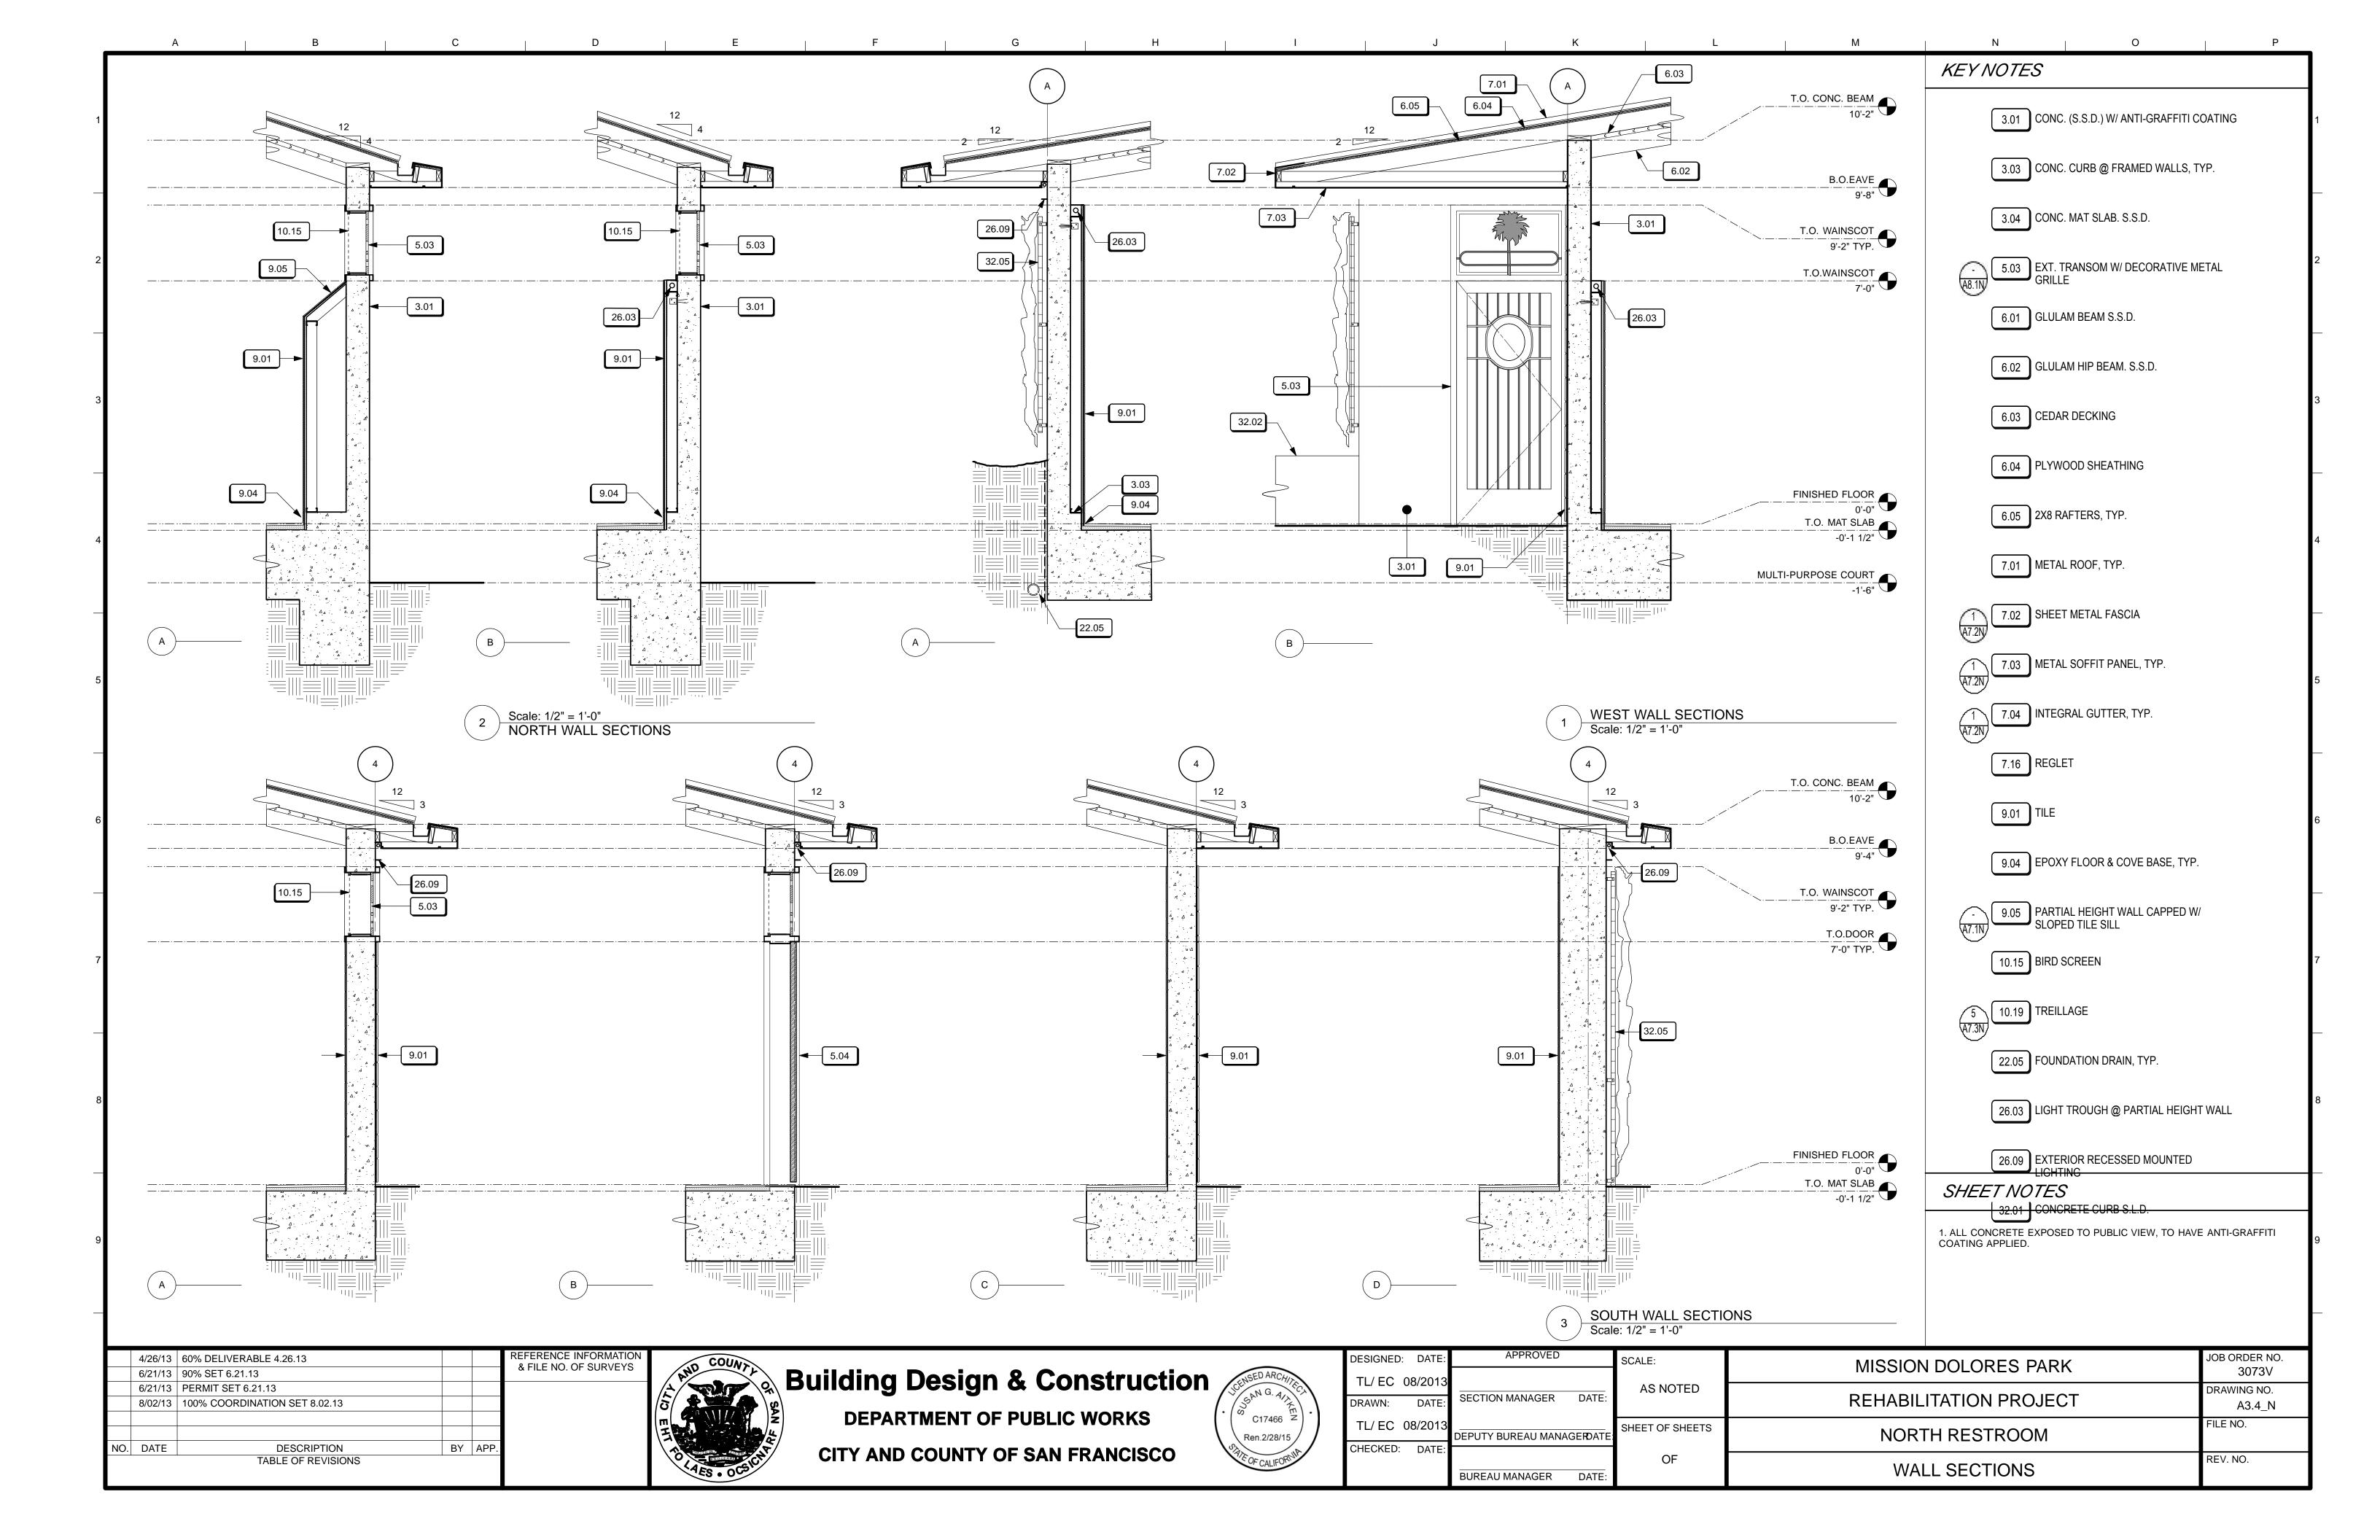


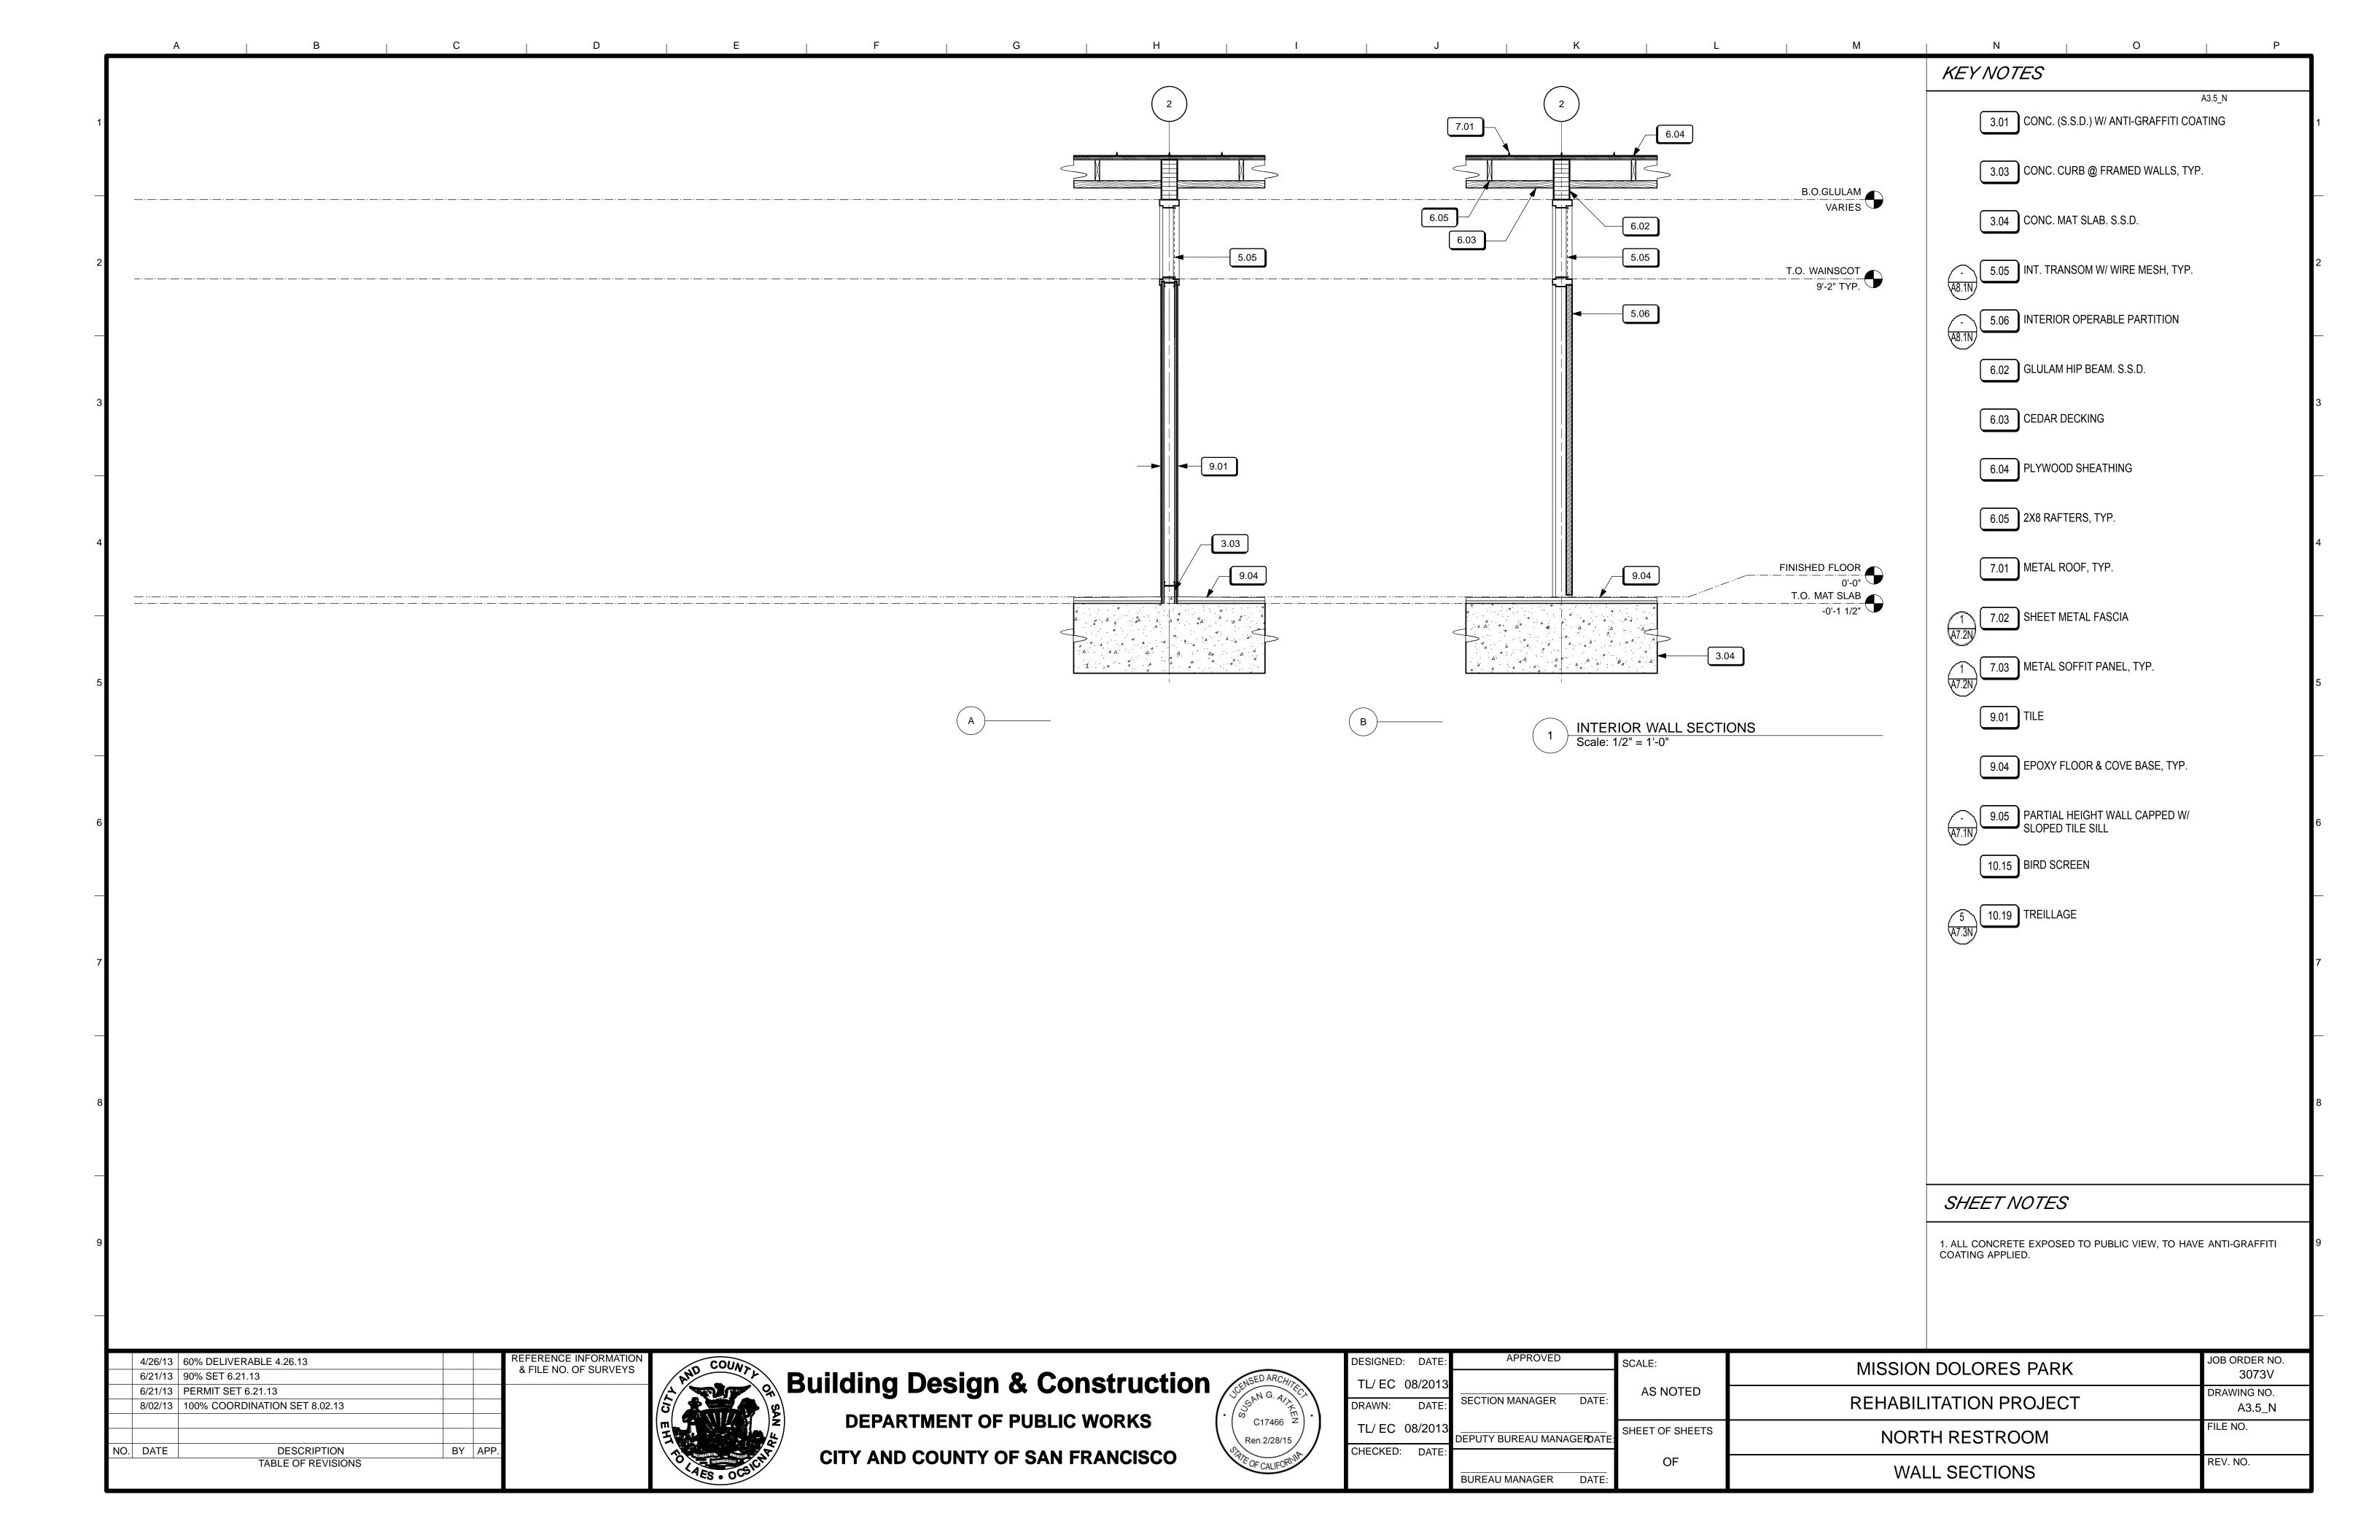


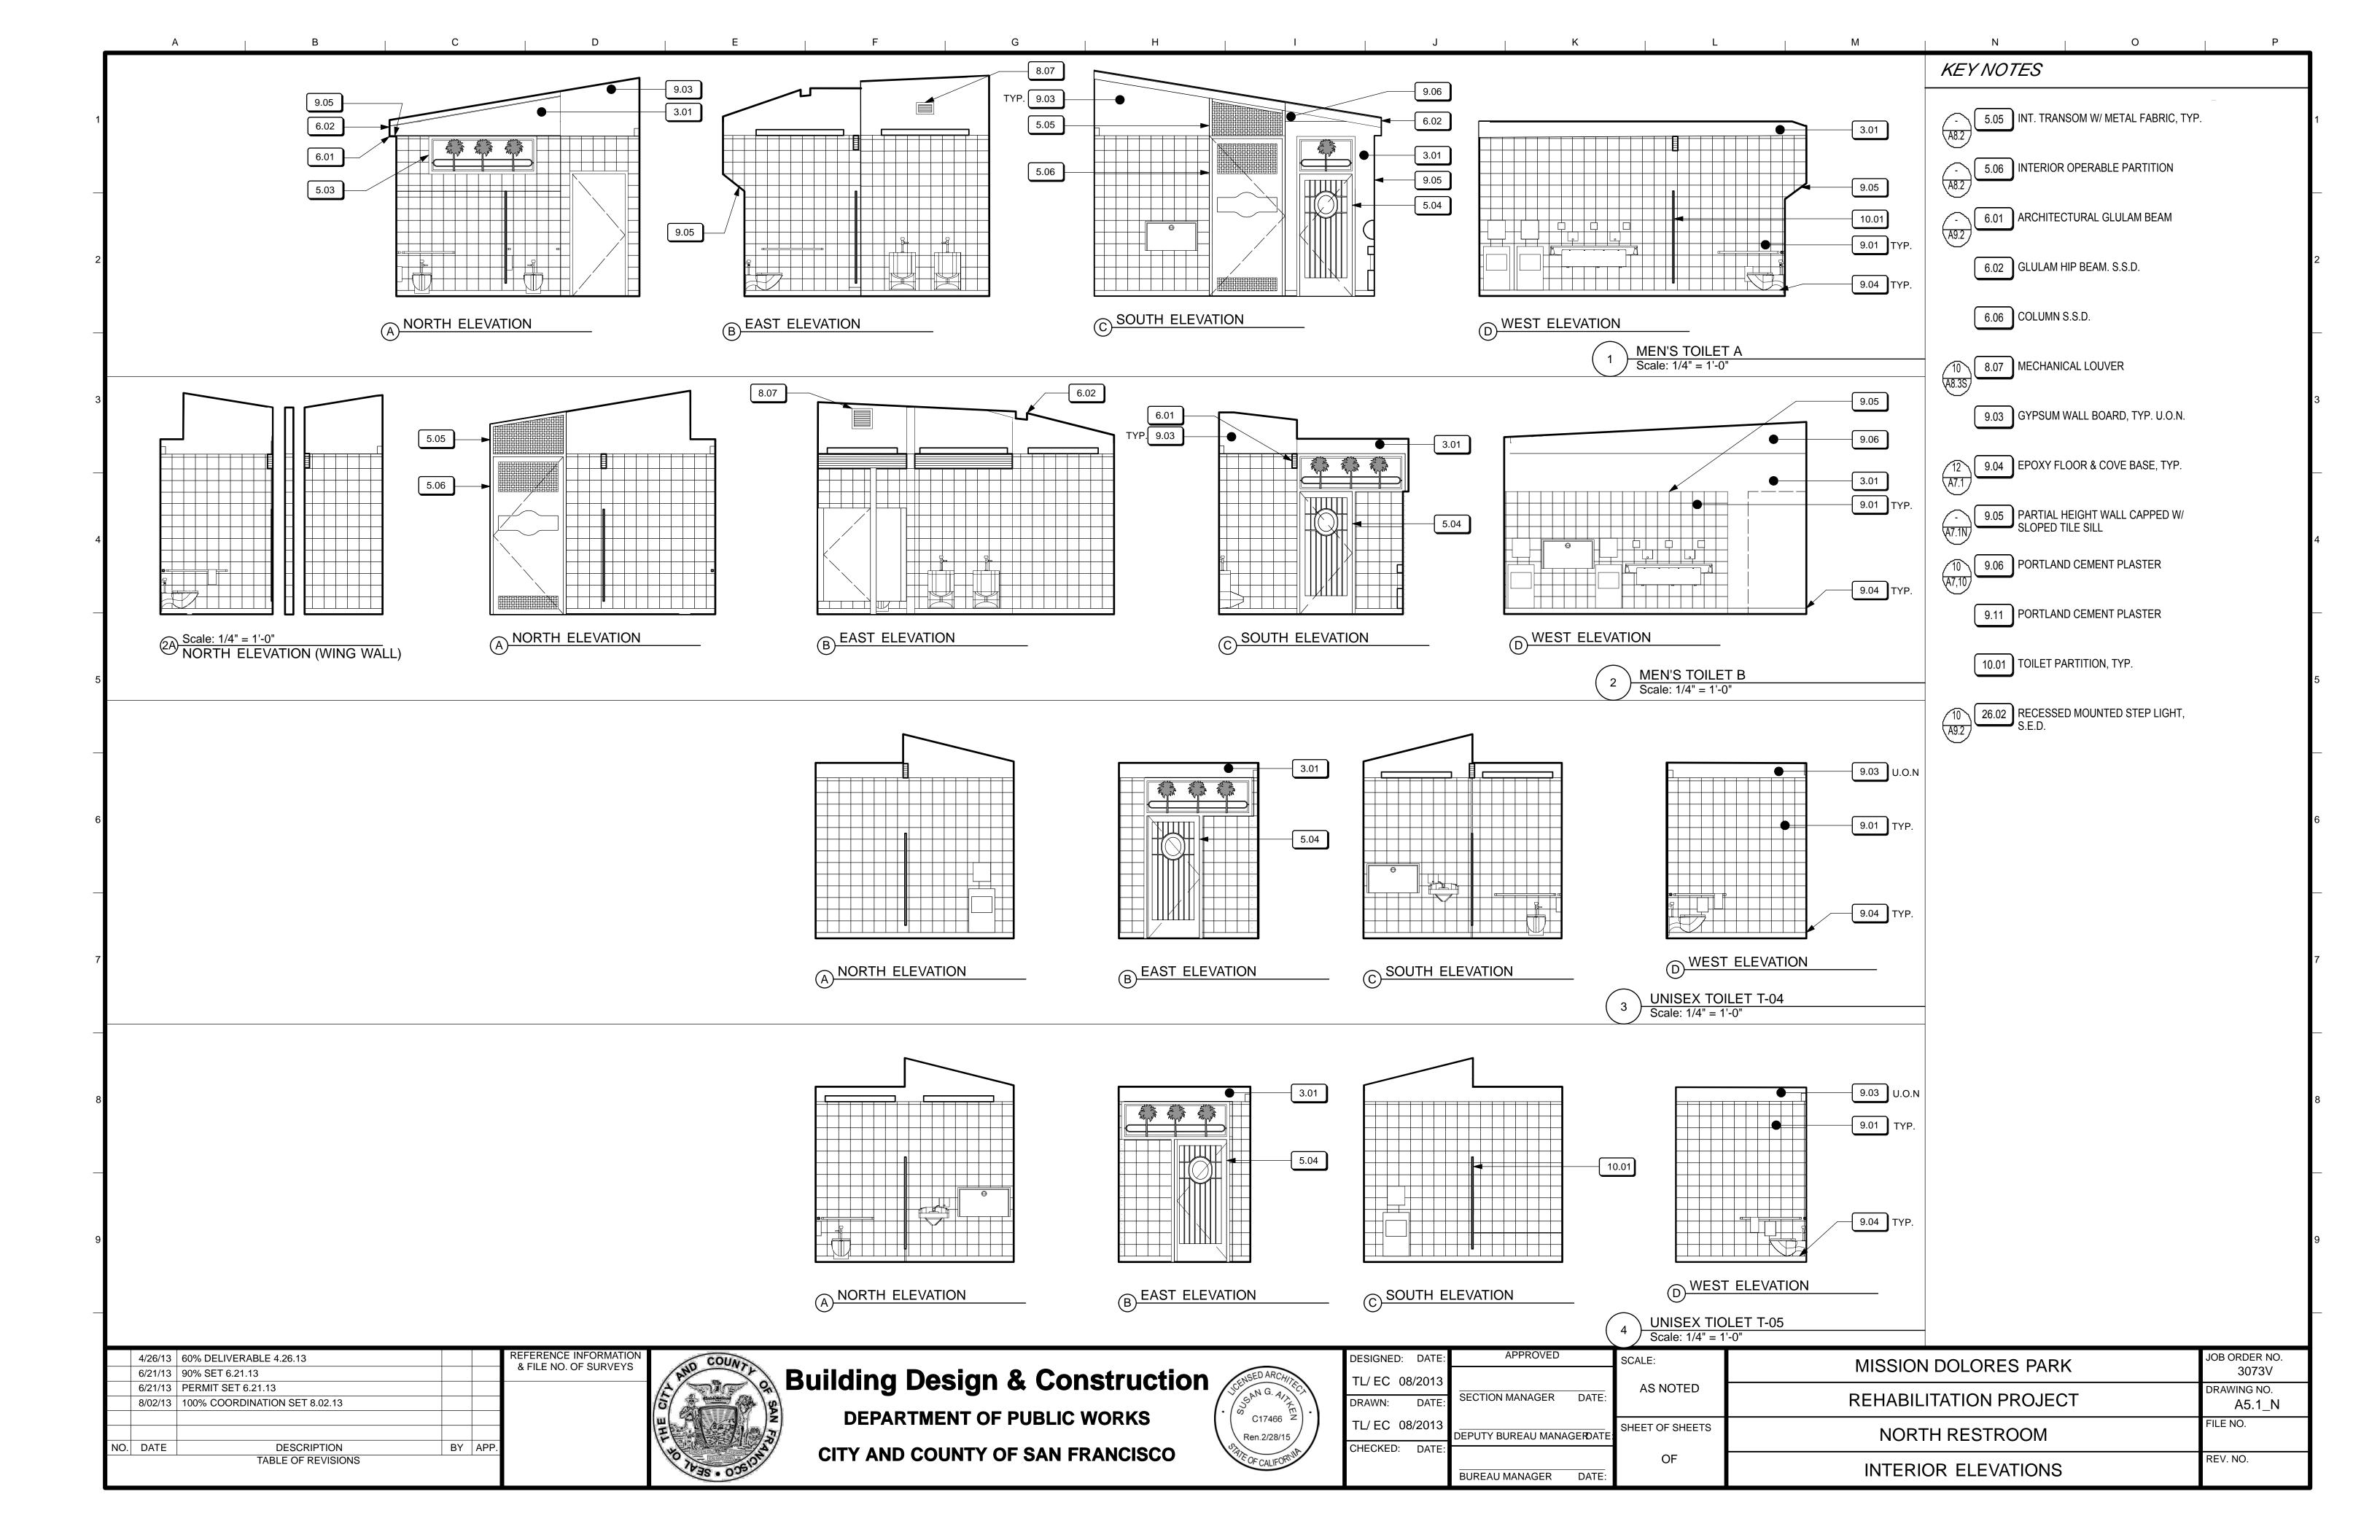


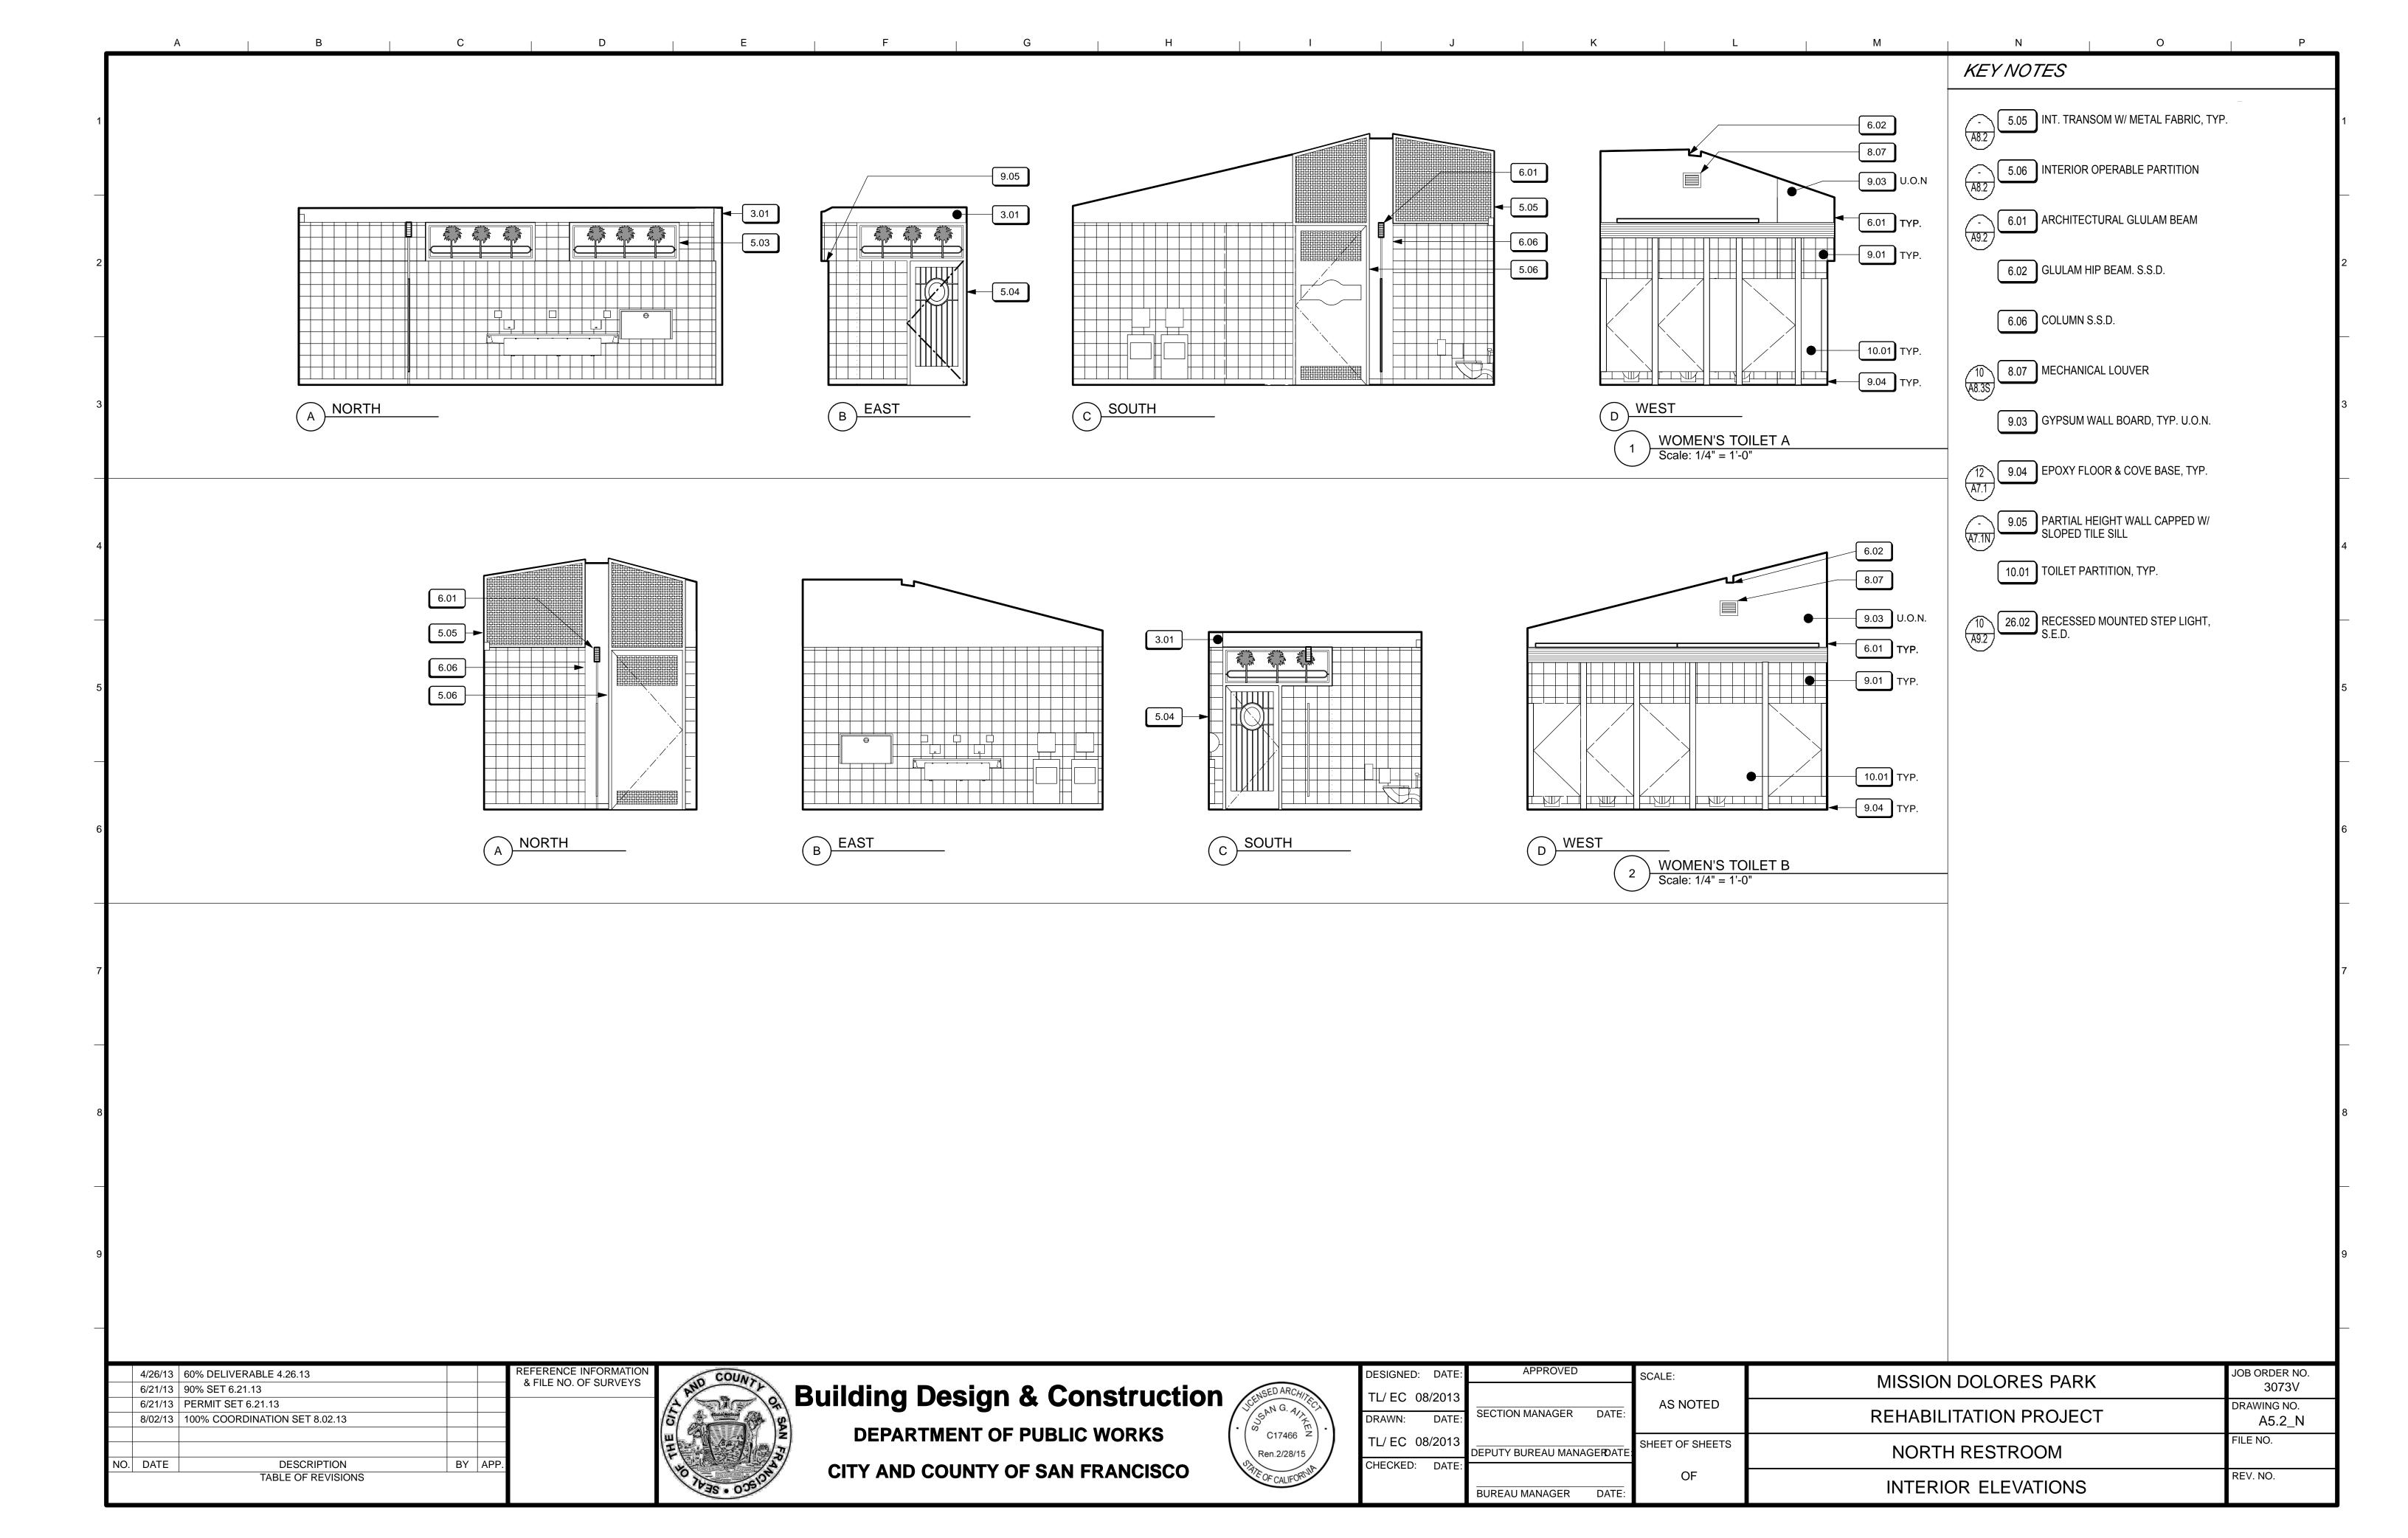

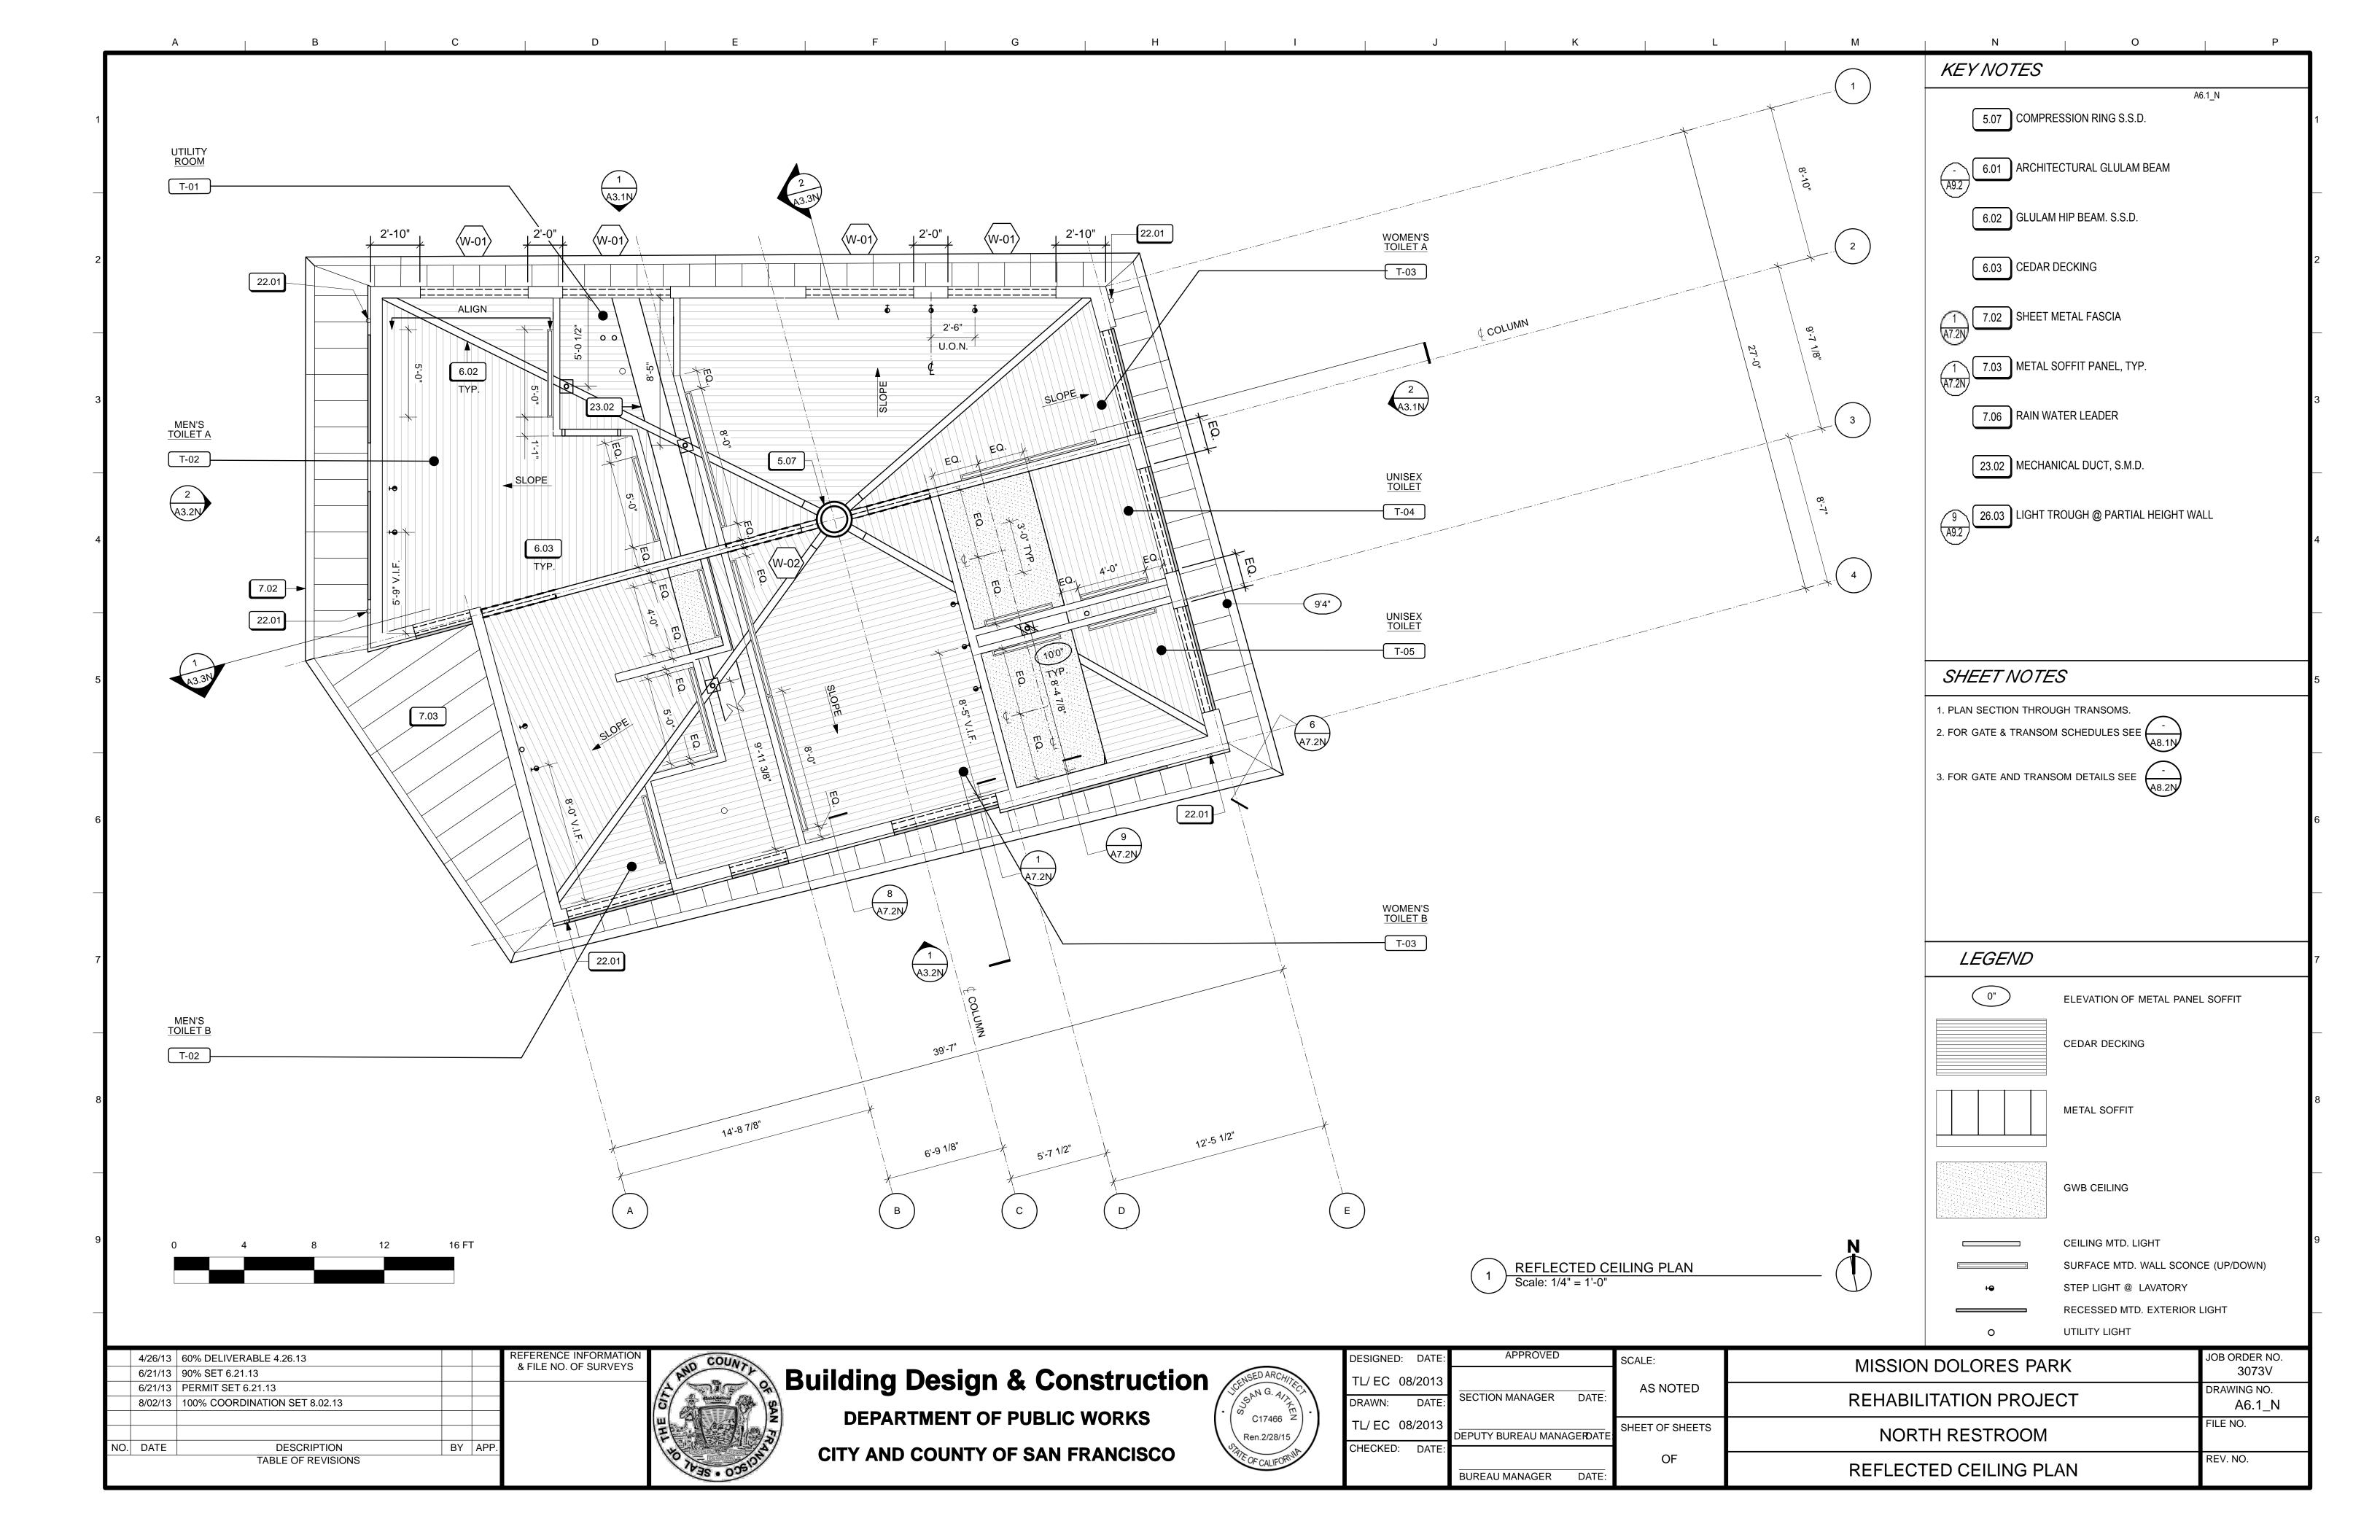

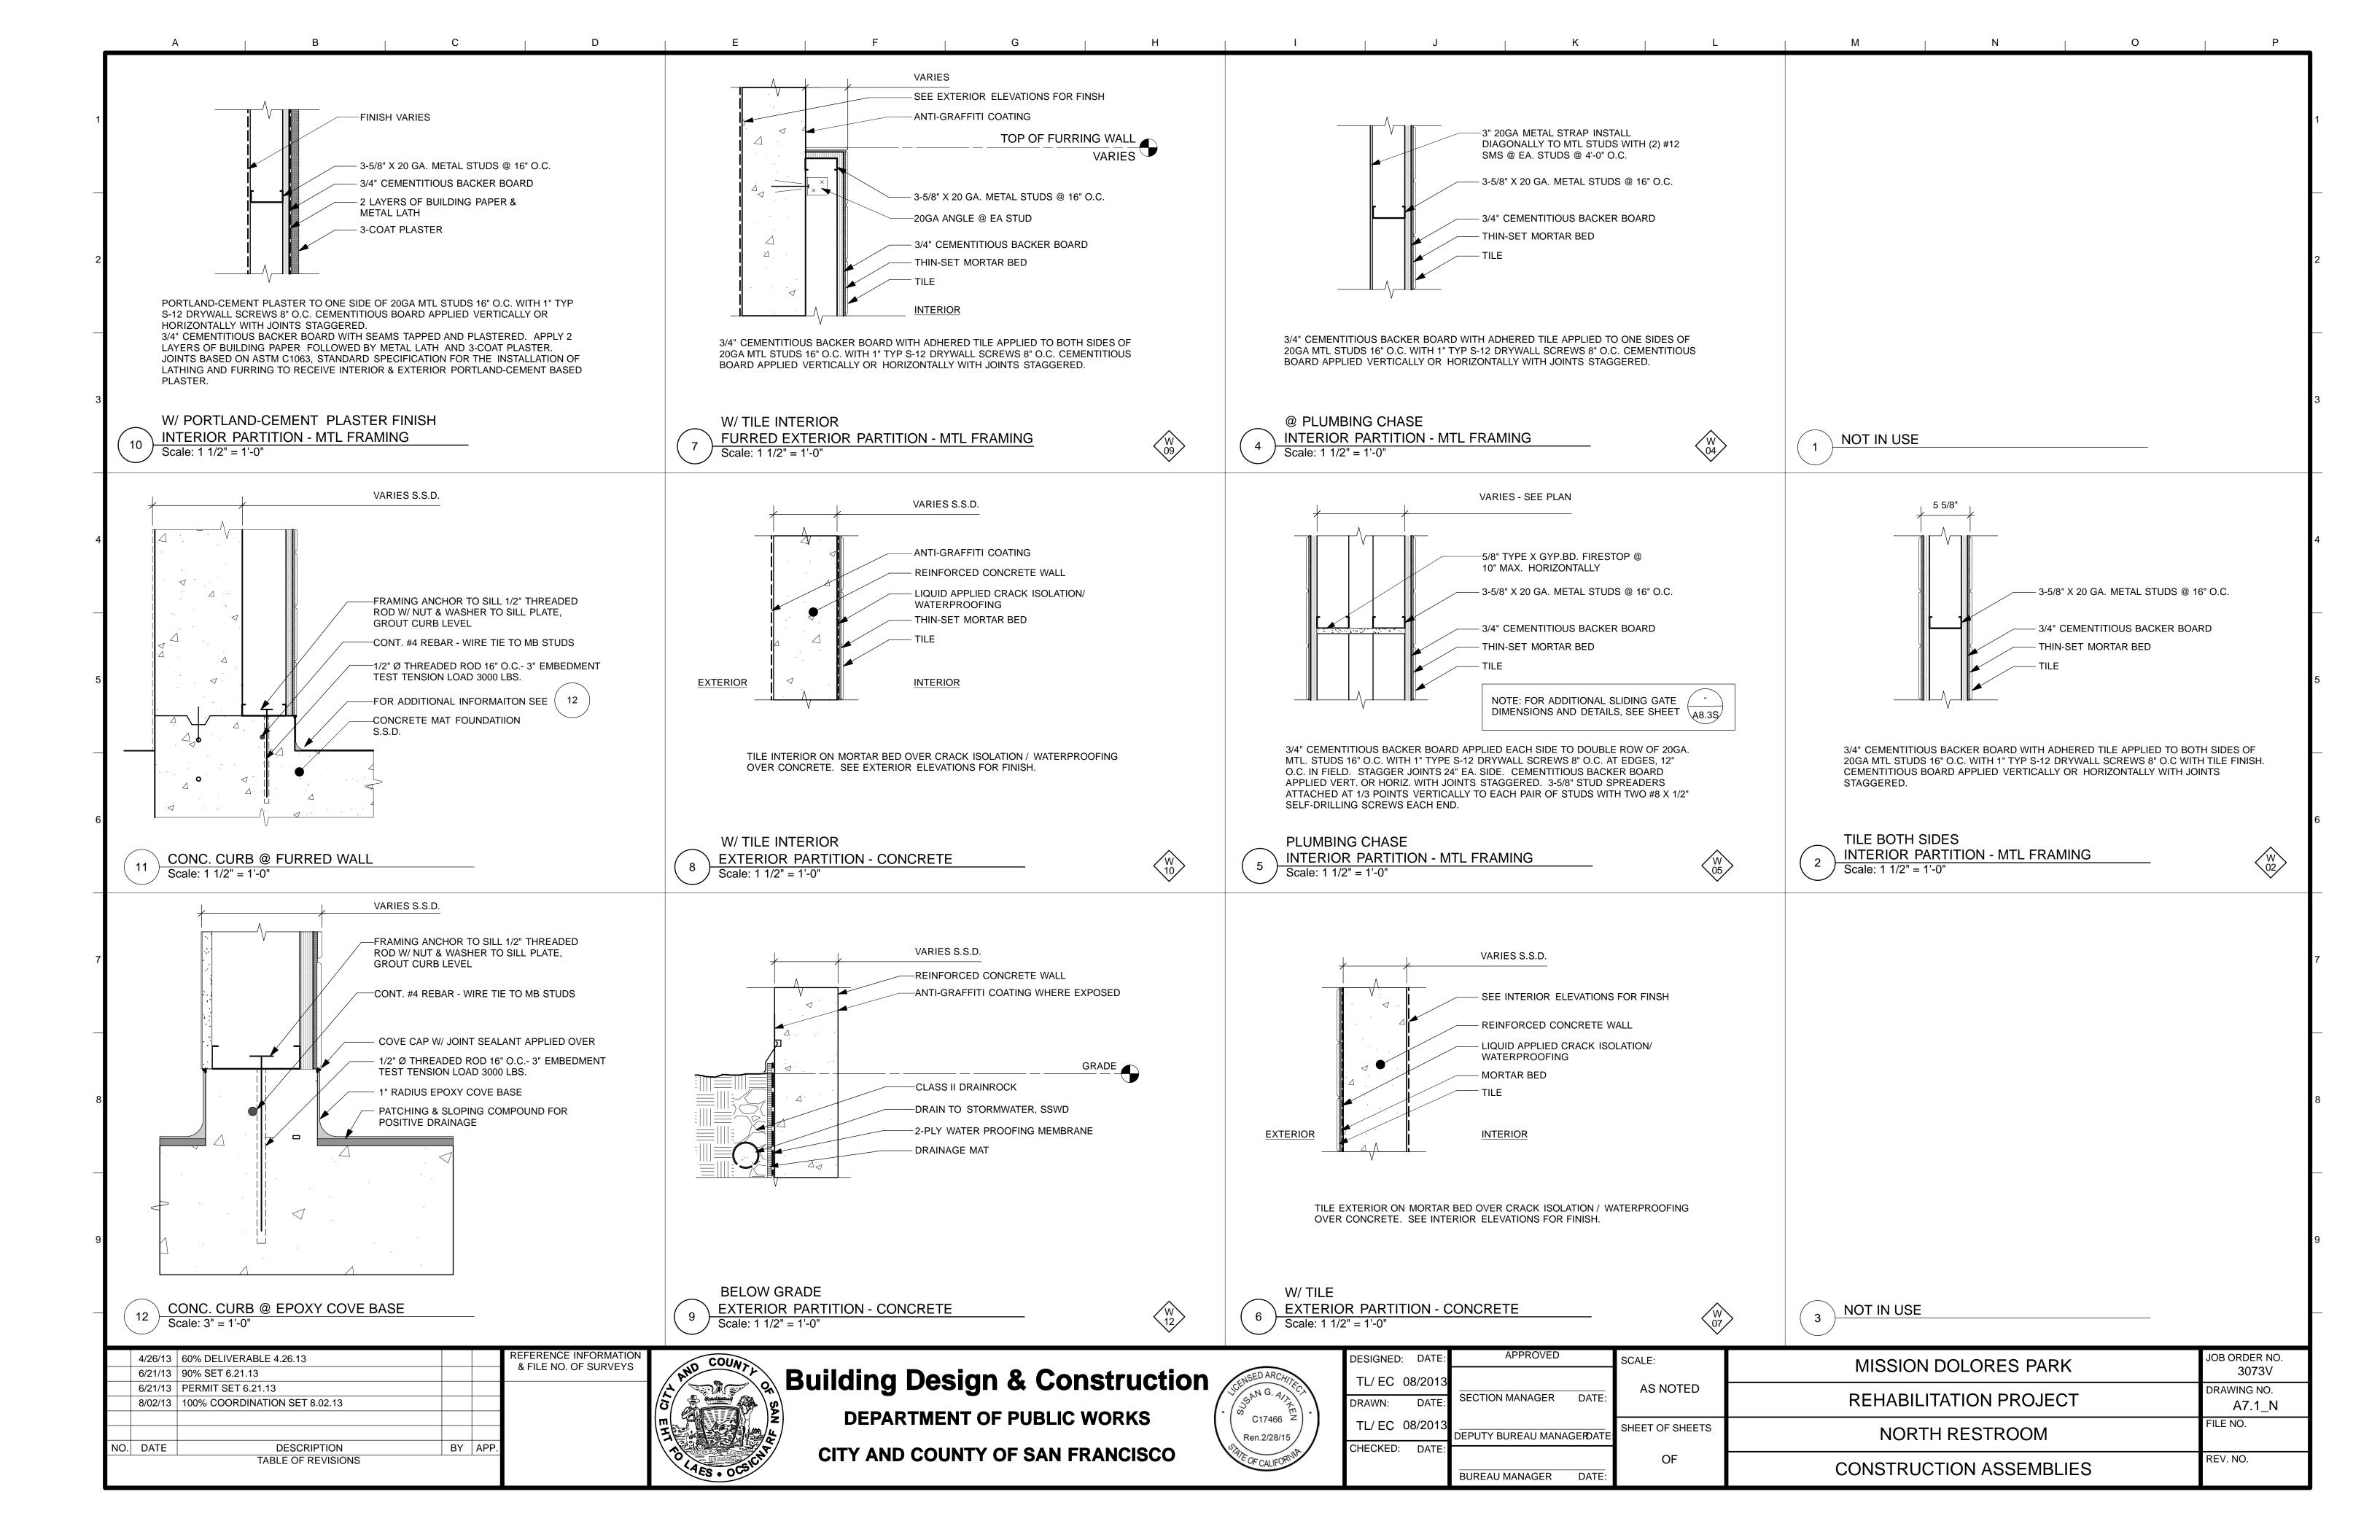

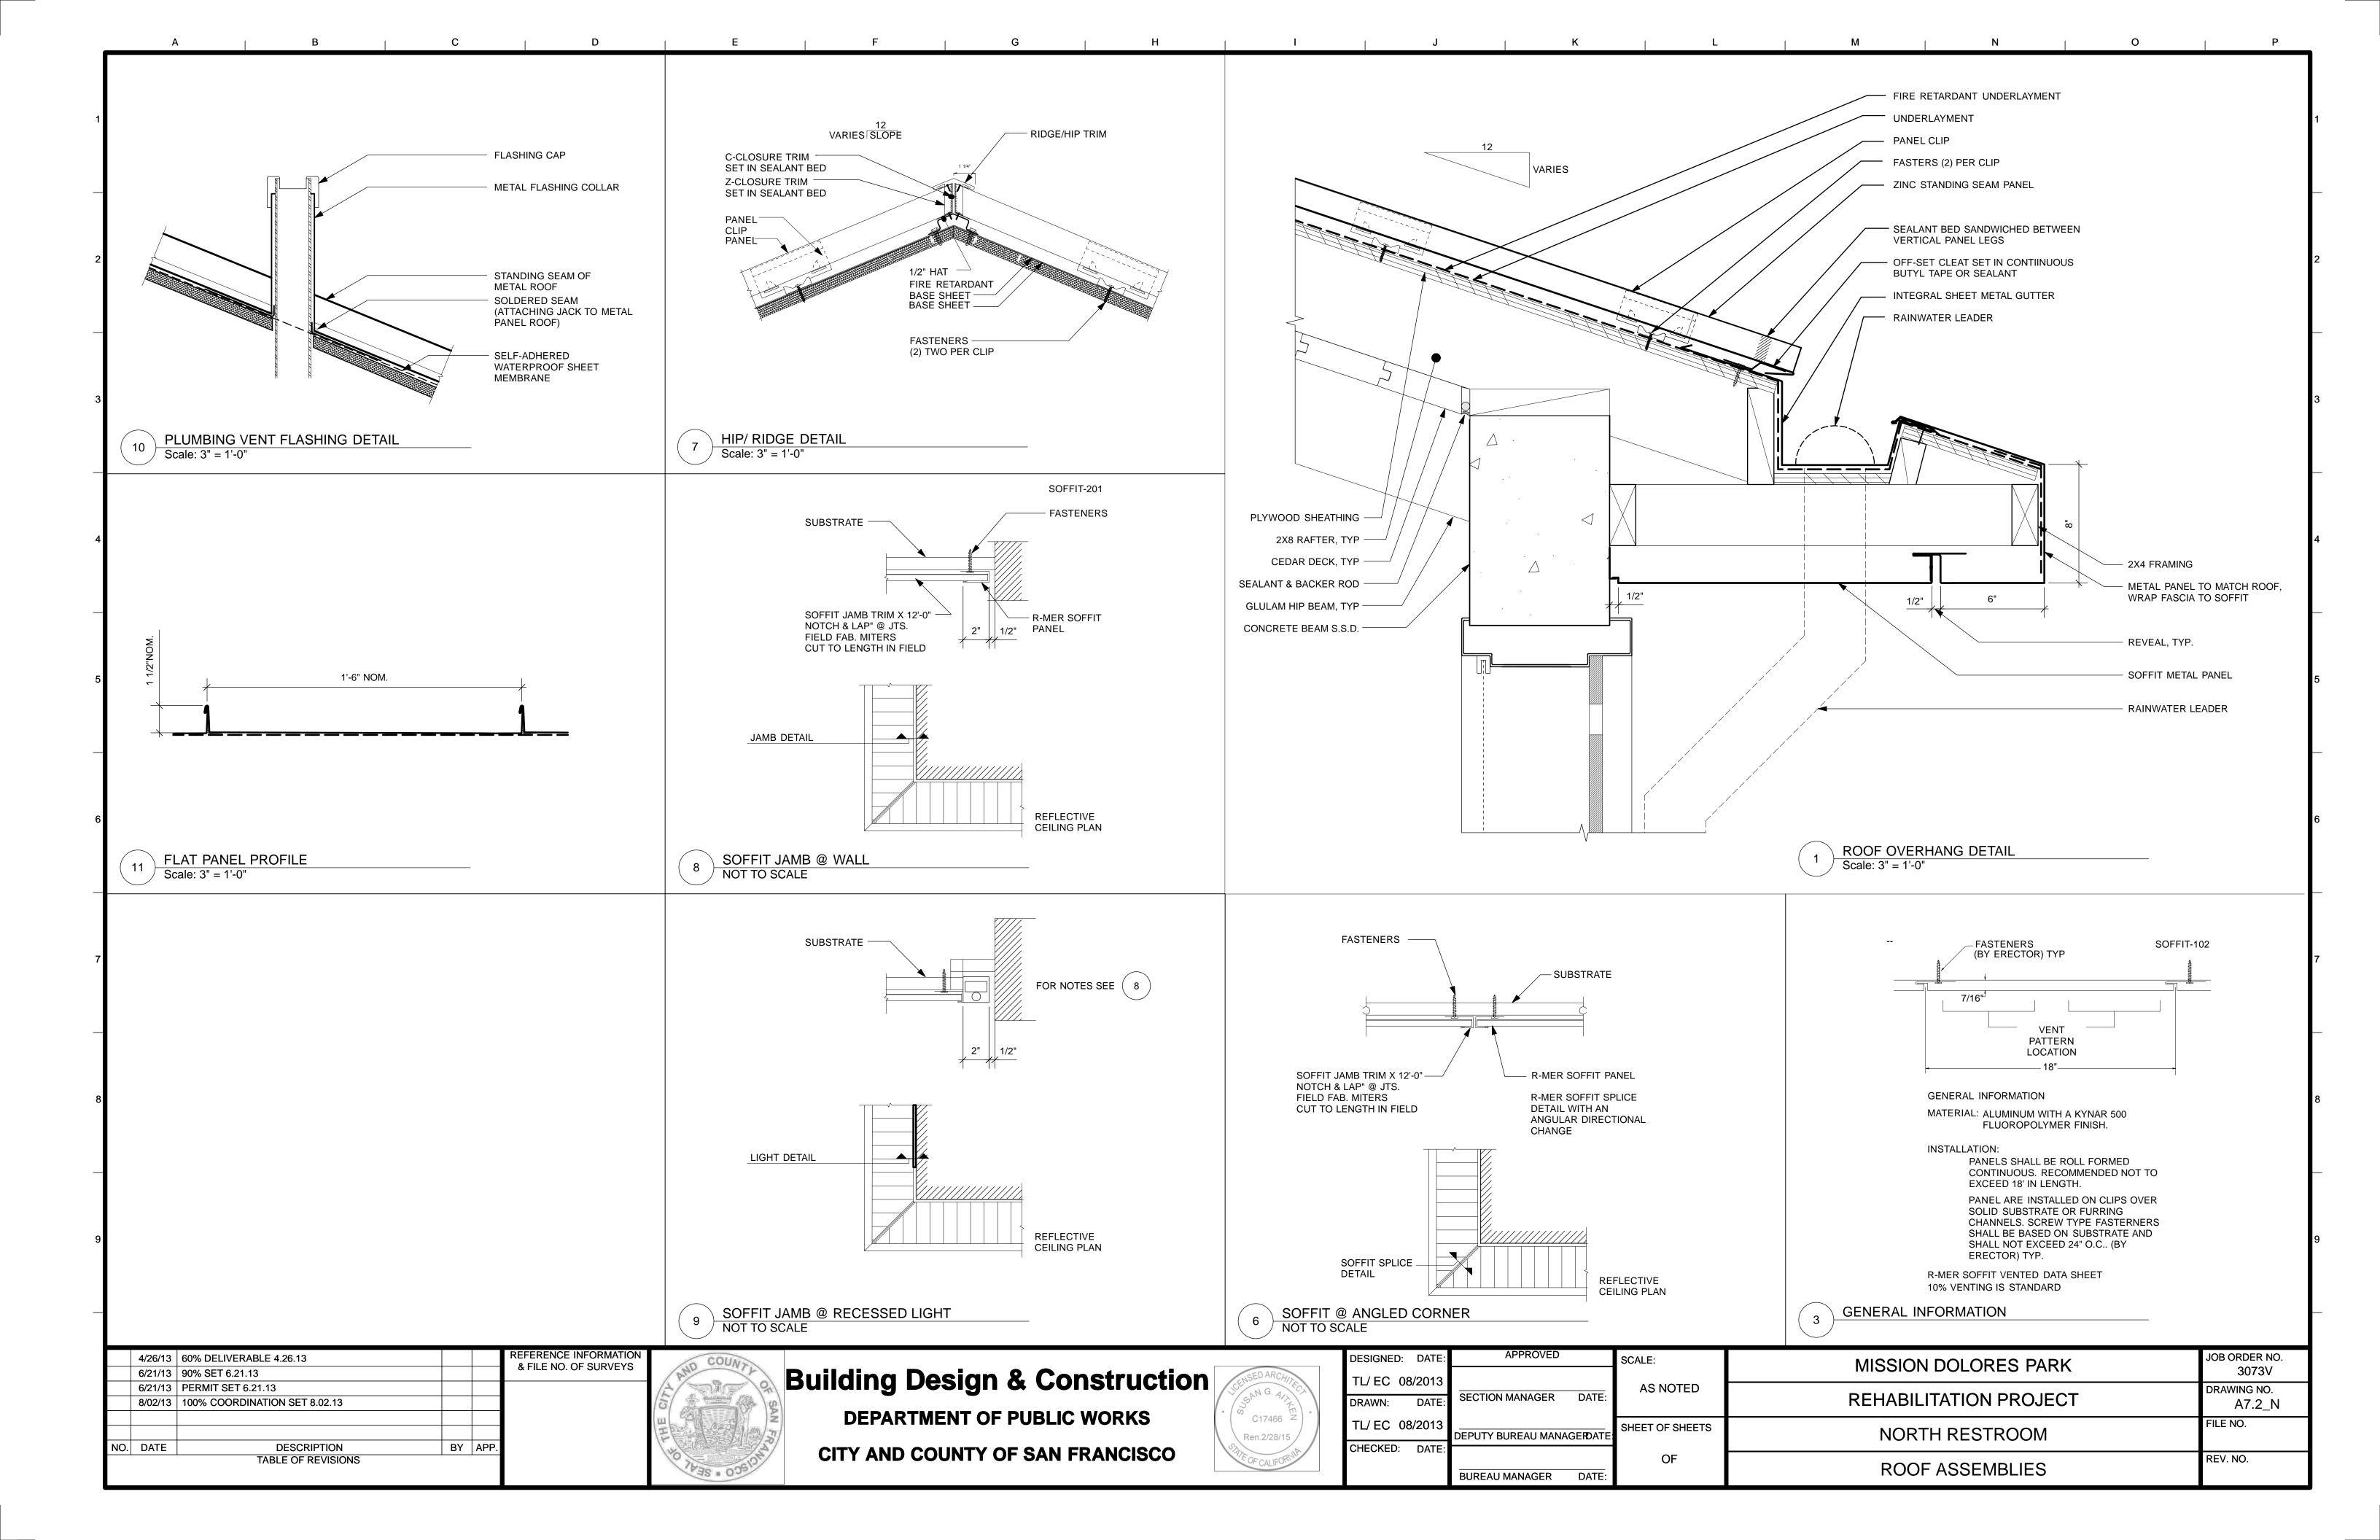

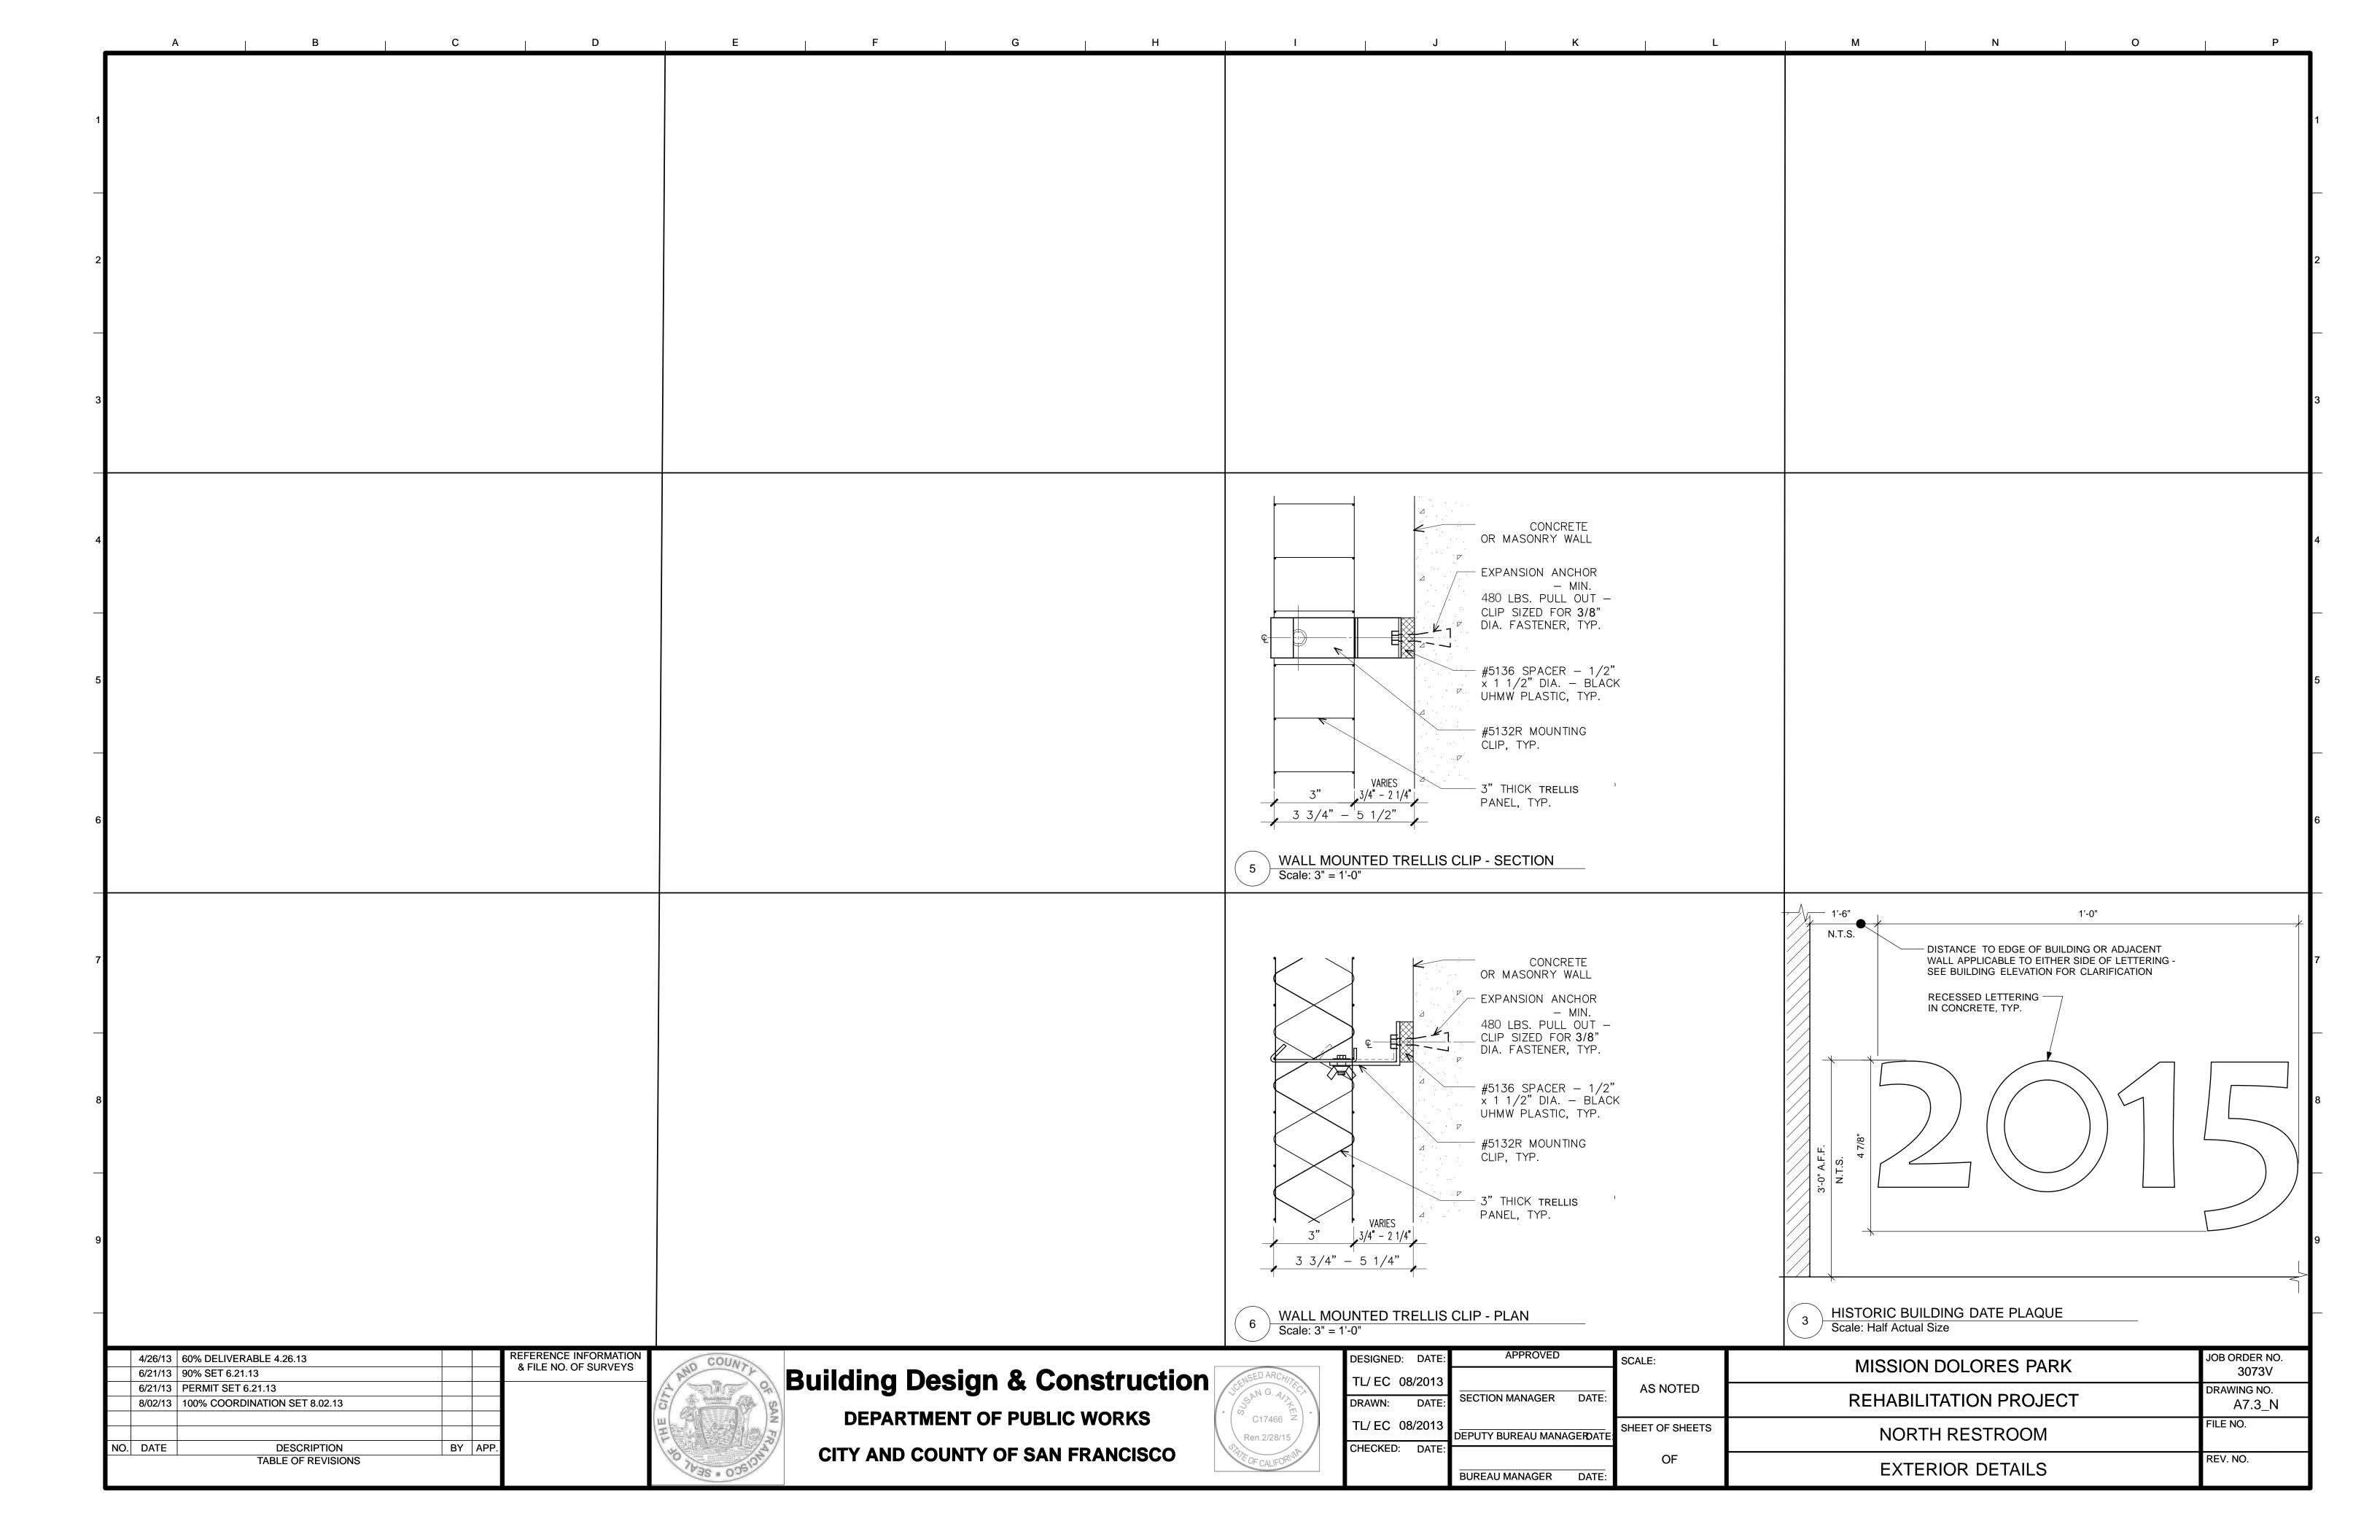

#### WINDOW SCHEDULE

ſ		Window	Туре	W	Н	Glz	Cons	Fin	Details			14/2/11/ 0211	Demonto
L				VV					Head	Jamb	Sill	Wdw Cov	Remarks
		01	GRILL	6'2"	2'2"	1,2							EXTERIOR TRANSOM, METAL GRILLE BACKED W/ WOVEN WIRE MESH
		02	MESH	5'9"	V.I.F.	2							INTERIOR TRANSOM, W/ WOVEN WIRE MESH

#### TRANSOM SCHEDULE NOTES

- 1. DIMENSIONS OF WINDOWS ARE NOMINAL.
- 2. ALL DOORS AND WINDOWS SHALL MEET THE MINIMUM INFILTRATION REQUIREMENTS PER SECTION 2.5311 B.E.E.S.
- SECTION 2.5311 B.E.E.S.
- ALL GLAZING SHALL COMPLY WITH CBC CHAPTER 24 AND TABLES CBC 24-1, 24-B AND 24-C.
  PROVIDE TEMPERED GLASS AT ALL AREAS REQUIRED BY CALIFORNIA BUILDING CODE (CBC) OR WHERE INDICATED ON ELEVATIONS EACH PIECE MARKED BY 'T' SHALL BE TEMPERED GLAZING. INSTALL SAFETY GLASS IN ALL WINDOWS WITHIN 18 INCHES OF A WALKING SURFACE AND WITHIN 12 INCHES OF A DOOR.

## AL ALUMINUM AWN AWNING CSMT CASEMENT CONS CONSTRUCTION

FINISH

HEIGHT

WIDTH

FIN


DOUBLE GLAZED


DOUBLE HUNG


HM HOLLOW METAL
LAM LAMINATED GLASS
P PAINTED
SGL SINGLE GLAZED
SLDR SLIDER
SLGDR SLIDING GLASS DOOR
SPCL SPECIAL
STD STANDARD
WIRE WIRE GLASS

**ABBREVIATIONS** 

#### TRANSOM SCHEDULE AND NOTES

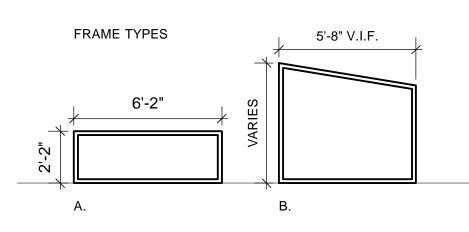


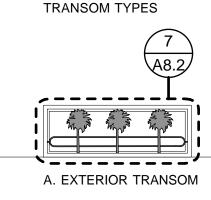


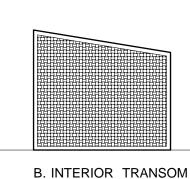

SEE  $\frac{4}{A8.2}$  SEE  $\frac{4}{A8.2}$ 

FRAME & TRANSOM TYPES

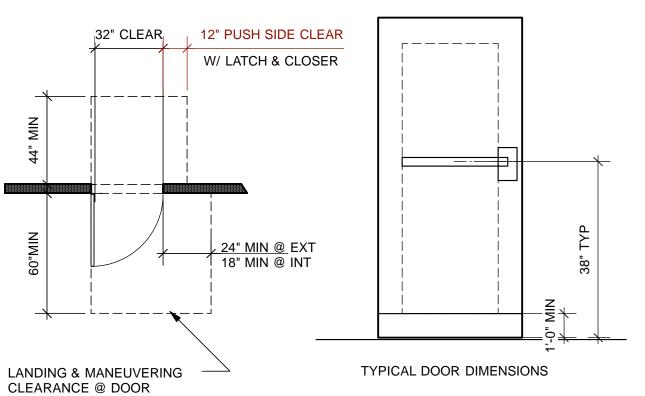

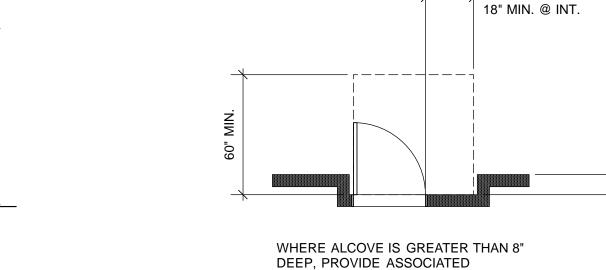

SEE DOOR SCHEDULE FOR ACTUAL DOOR SIZES AND HARDWARE GROUPS

### DOOR CLEARANCE ON PATH OF TRAVEL NTS

### 9 DOOR CLEARANCE AT ALCOVE CONDITION NTS

MINIMUM CLEARANCES

	4/26/13	60% DELIVERABLE 4.26.13			REFERENCE INFORMATION	
	6/21/13	90% SET 6.21.13			& FILE NO. OF SURVEYS	
	6/21/13	PERMIT SET 6.21.13				l i
	8/02/13	100% COORDINATION SET 8.02.13				1
						Į,
						ľ
NO.	DATE	DESCRIPTION	BY	APP.		1
		TABLE OF REVISIONS				

# Building Design & Construction DEPARTMENT OF PUBLIC WORKS CITY AND COUNTY OF SAN FRANCISCO

24" MIN. @ EXT.

# C17466 Z Ren.2/28/15

ESIGNED: DATE:	APPROVED	SCALE:	MISSION DOLORES PARK	JOB ORDER NO. 3073V
L/ EC 08/2013		AS NOTED		
RAWN: DATE:	SECTION MANAGER DATE:	AS NOTED	REHABILITATION PROJECT	DRAWING NO. A8.1_N
L/ EC 08/2013	DEPUTY BUREAU MANAGERDATE:	SHEET OF SHEETS	NORTH RESTROOM	FILE NO.
HECKED: DATE:				
	BUREAU MANAGER DATE:	OF	DOOR & TRANSOM SCHEDULES	REV. NO.

#### DOOR SCHEDULE

Door	Туре	W	Н	Thk	Cons	Fin	Ratg	Hdwr	Frame	Frame	Frame		Details		Sign	Remarks
Door	Туре	VV	П	TTIK	Cons	TIII	Raig	Grp	Туре	Cons	Fin	Head	Jamb	Thrshld	_	
01	А	3'0"	7'0"	1-3/4	НМ	Р	NR	1	Α	НМ	Р				В	GATE W/ TRANSOM (RIGHT)
02	В	3'0"	7'0"	1-3/4	НМ	Р	NR	15	В	НМ	Р					METAL GATE W/ SOLID 14 GA. SHEET METAL BACKING & TRANSOM
03	А	3'0"	7'0"	1-3/4	НМ	Р	NR	1	Α	НМ	Р				В	GATE W/ TRANSOM (RIGHT)
04	А	3'0"	7'0"	1-3/4	НМ	Р	NR	1	А	НМ	Р				В	GATE W/ TRANSOM (LEFT)
05	А	3'0"	7'0"	1-3/4	НМ	Р	NR	1	А	НМ	Р				В	GATE W/ TRANSOM (RIGHT)
06	А	3'0"	7'0"	1-3/4	НМ	Р	NR	1	А	НМ	Р				В	GATE W/ TRANSOM (LEFT)
07	D	4'0"	9'-0"	1-3/4	НМ	Р	NR	4	D	НМ	Р					
08	С	3'0"	7'0"	1-3/4	НМ	Р	NR	2	С	НМ	Р					
09	D	4'0"	9'0"	1-3/4	НМ	Р	NR	14	D	НМ	Р					
10	В	3'0"	7'0"	1-3/4	НМ	Р	NR	1	В	НМ	Р				В	GATE W/ TRANSOM

#### DOOR SCHEDULE NOTES

- DIMENSIONS OF DOORS ARE NOMINAL.
   VERIFY DIMENSIONS OF ALL EXISTING DOOR FRAMES TO BE RE-USED - FIT NEW DOORS TO EXISTING FRAMES AS REQUIRED.
- 3. ALIGN NEW DOOR HEADS TO EXISTING ADJACENT
- DOOR HEADS WHERE OCCURS.

  4. ALL DOORS SHALL BE POSITIVE LATCHING W/
  LEVER ACTING DOOR HARDWARE. ALL FIRE
  RATED DOORS SHALL HAVE PERIMETER SMOKE
  GASKETS AS REQUIRED, AND SELF-CLOSERS OR
- AUTOMATIC CLOSERS WITH SMOKE DETECTORS.

  5. ALL DOORS AND WINDOWS SHALL MEET THE MINIMUM INFILTRATION REQUIREMENTS PER SECTION 2.5311 B.E.E.S. ALL NEW EXTERIOR DOORS SHALL BE WEATHER-STRIPPED
- COMPLETELY.

  ALL EXIT DOORS SHALL BE OPENABLE FROM THE INSIDE WITHOUT THE USE OF A KEY OR ANY SPECIAL KNOWLEDGE OR EFFORT. NO DEADBOLTS, NO SLIDING BOLTS, ETC. (CBC SEC.
- 7. ADJUST ALL DOOR OPENING FORCE TO THE MINIMUM REQUIRED FOR OPERATION. MAXIMUM EFFORT TO OPERATE ANY NEW DOORS SHALL NOT EXCEED 5 POUNDS FOR INTERIOR AND EXTERIOR DOORS, SUCH PULL OR PUSH EFFORT BEING APPLIED AT RIGHT ANGLES TO HINGED DOORS AND AT THE CENTER PLANE OF SLIDING OR FOLDING DOORS.
- COMPENSATING DEVICES OR AUTOMATIC DOOR OPERATORS MAY BE UTILIZED TO MEET THE ABOVE STANDARDS, SUBJECT TO APPROVAL BY THE ARCHITECT AND THE GOVERNING AUTHORITY, OPENING FORCE FOR FIRE RATED DOORS MAY BE ADJUSTED UP TO A MAXIMUM OF 15 POUNDS SUBJECT TO APPROVAL BY THE
- GOVERNING AUTHORITY.

  8. ALL HAND-ACTIVATED DOOR OPENING
  HARDWARE SHALL BE CENTERED BETWEEN 30"
  AND 44" ABOVE THE FLOOR. SEE DOOR TYPES
  FOR DIMENSION. LATCHING AND LOCKING
  DOORS THAT ARE HAND ACTIVATED AND
  WHICH ARE IN A PATH OF TRAVEL SHALL BE
  OPERABLE WITH A SINGLE EFFORT BY LEVER
  TYPE HARDWARE. LOCKED DOORS SHALL
  OPERATE AS ABOVE IN THE EGRESS

DIRECTION.

- 9. THE BOTTOM 10 INCHES OF ALL NEW DOORS
  EXCEPT AUTOMATIC AND SLIDING DOORS
  SHALL HAVE A SMOOTH UNINTERRUPTED
  SURFACE TO ALLOW THE DOOR TO BE OPENED
  BY A WHEELCHAIR FOOTREST WITHOUT
  CREATING A TRAP OR HAZARDOUS CONDITION.
  WHERE NARROW FRAME DOORS ARE USED, A
  10" HIGH SMOOTH BOTTOM RAIL SHALL BE
  - INSTALLED.
    ALL GLAZING IN DOORS SHALL BE SAFETY
    GLASS, OR WIRED GLASS WHERE REQUIRED.

#### **ABBREVIATIONS**


LT LIGHT

P PAINTED

NR NON-RATED

CONS CONSTRUCTION
(E) EXISTING
FIN FINISH
FL FLUSH
FR FRENCH
H HEIGHT


FL FLUSH PNL PANEL
FR FRENCH THK THICKNESS
H HEIGHT W WIDTH
HM HOLLOW METAL WD WOOD

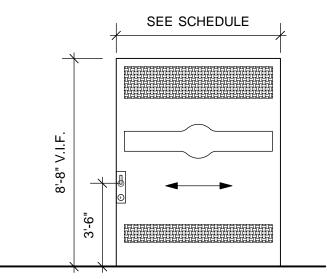



D. SLIDING GATE


#### 5 DOOR SCHEDULE AND NOTES


FRAME & DOOR TYPES

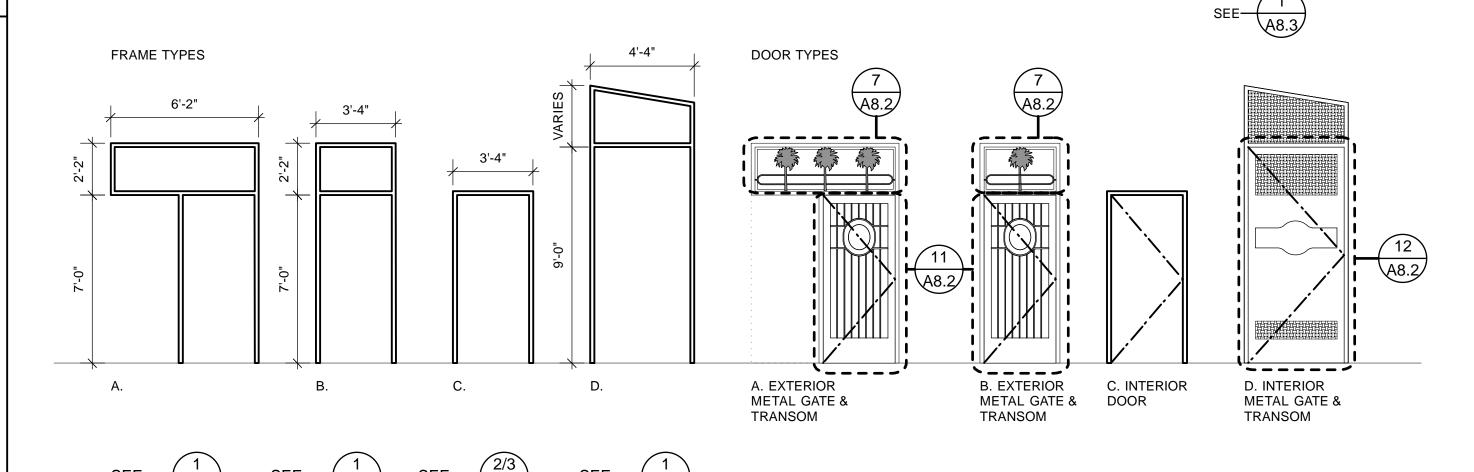


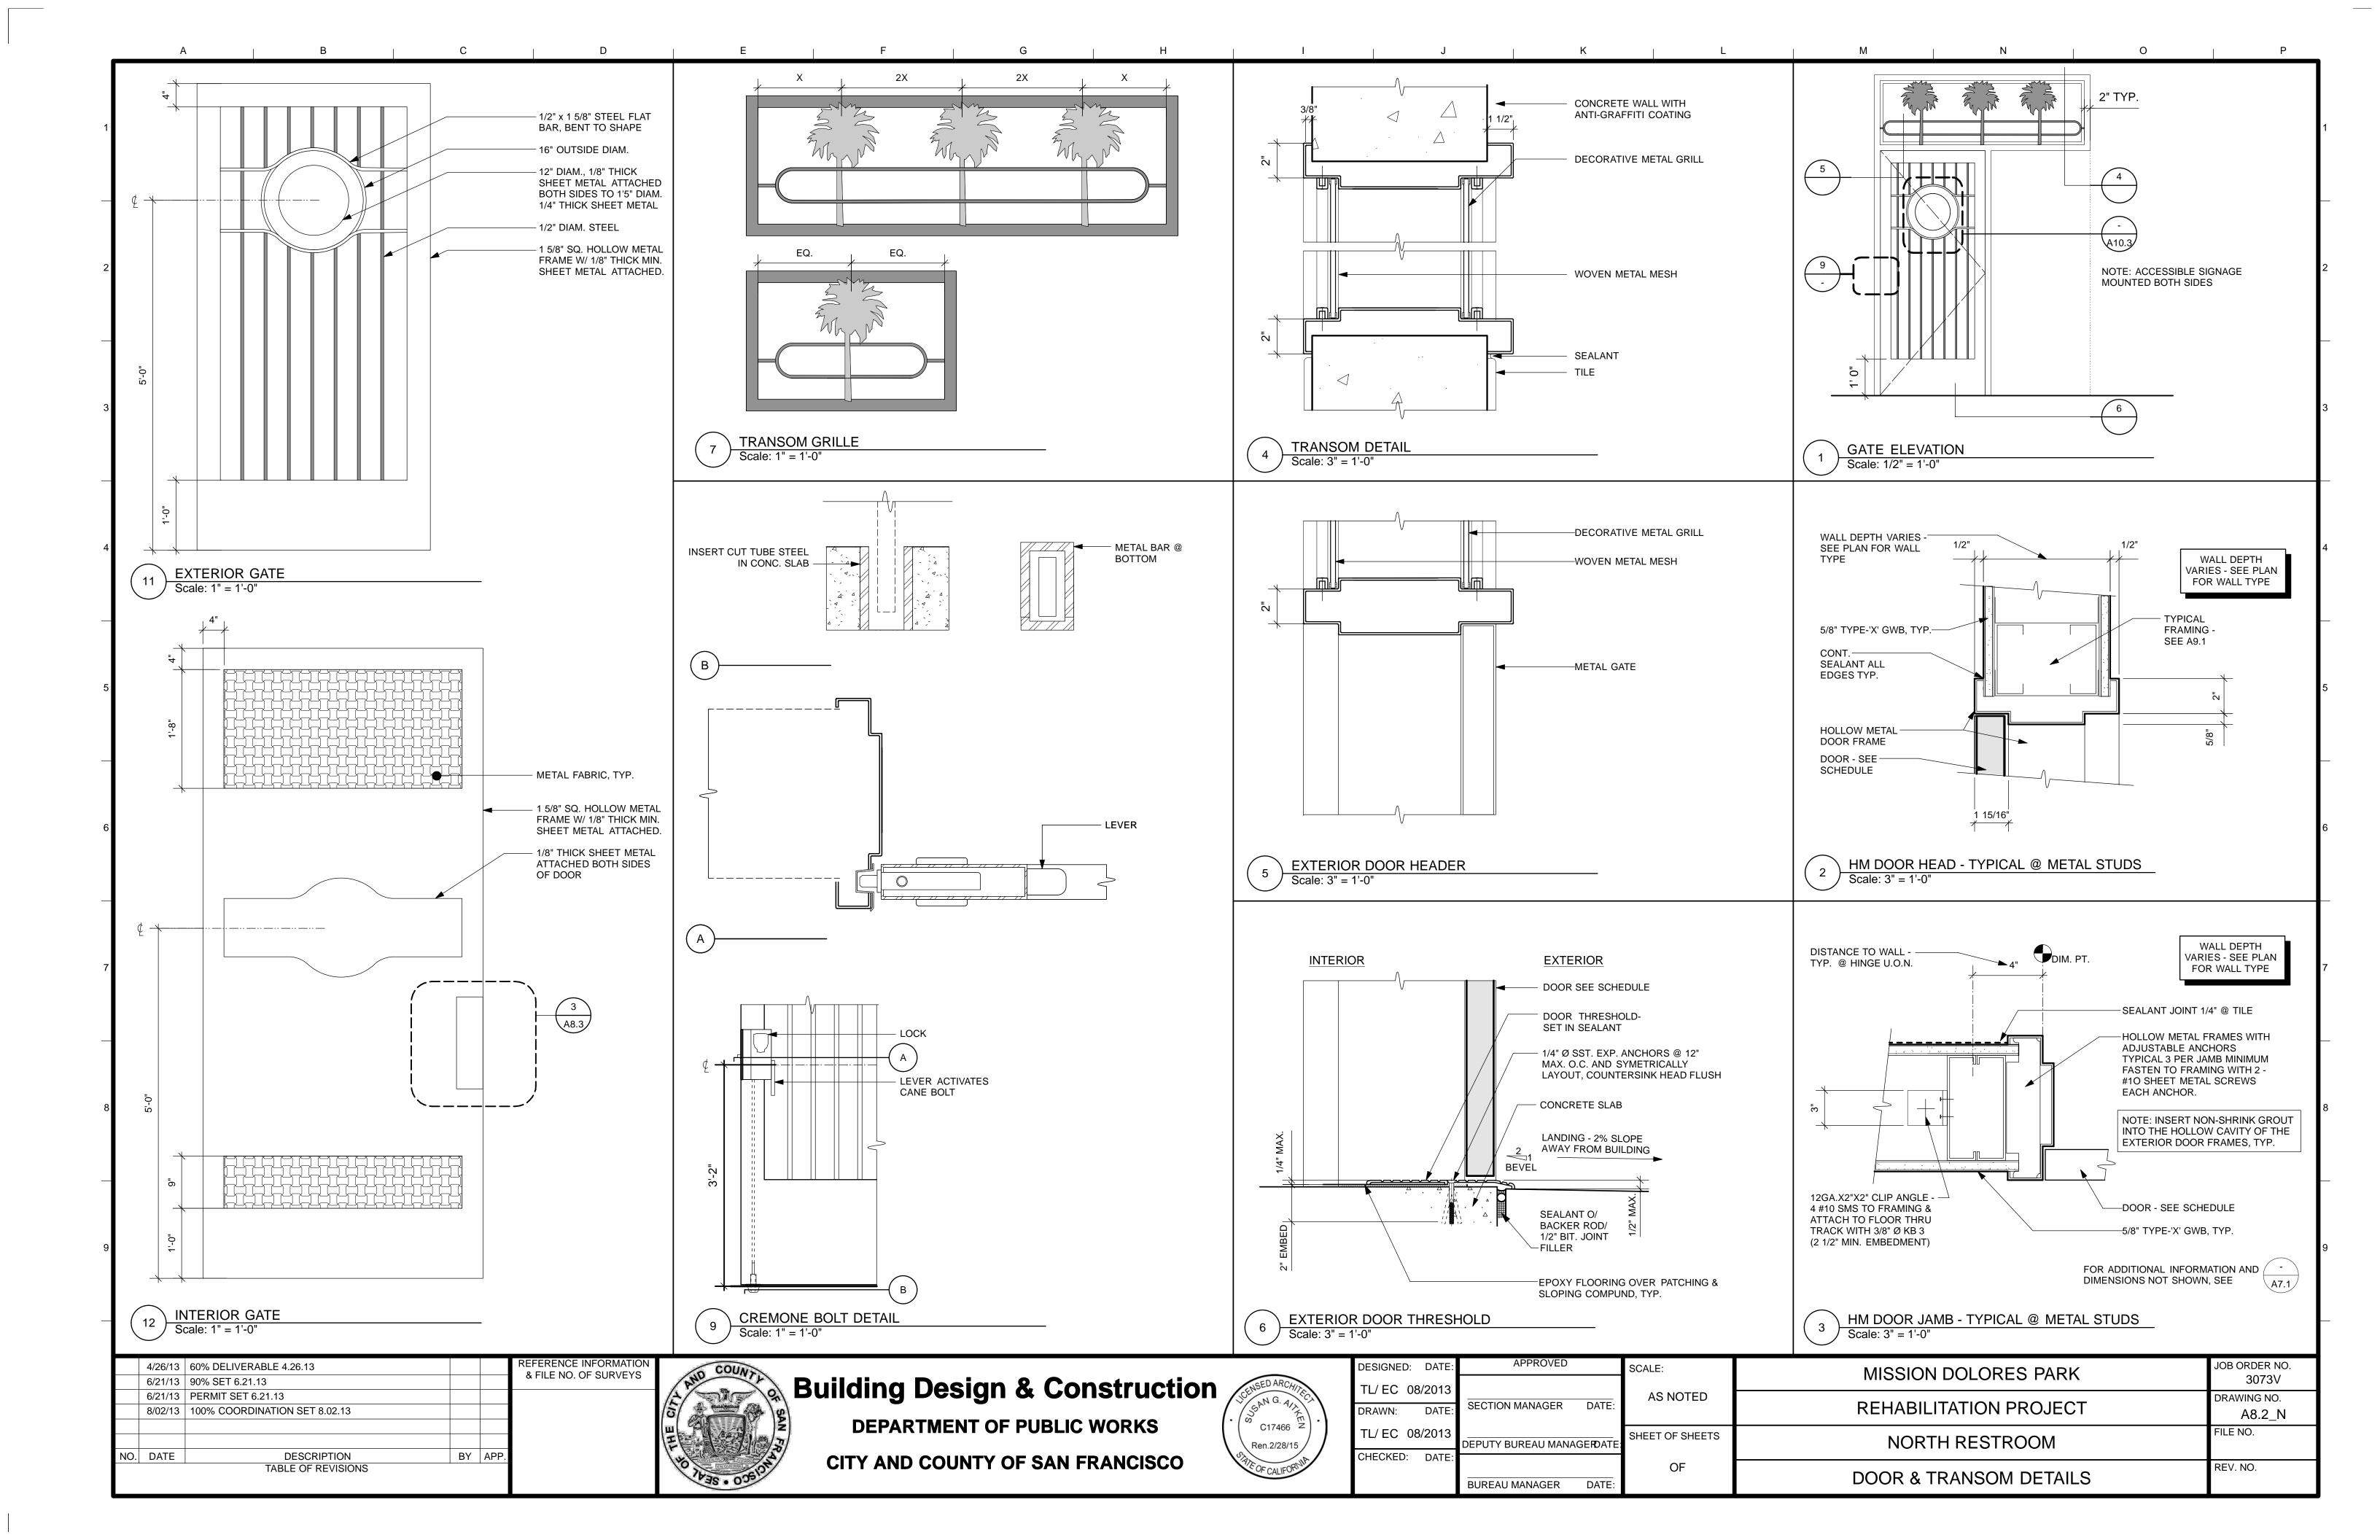


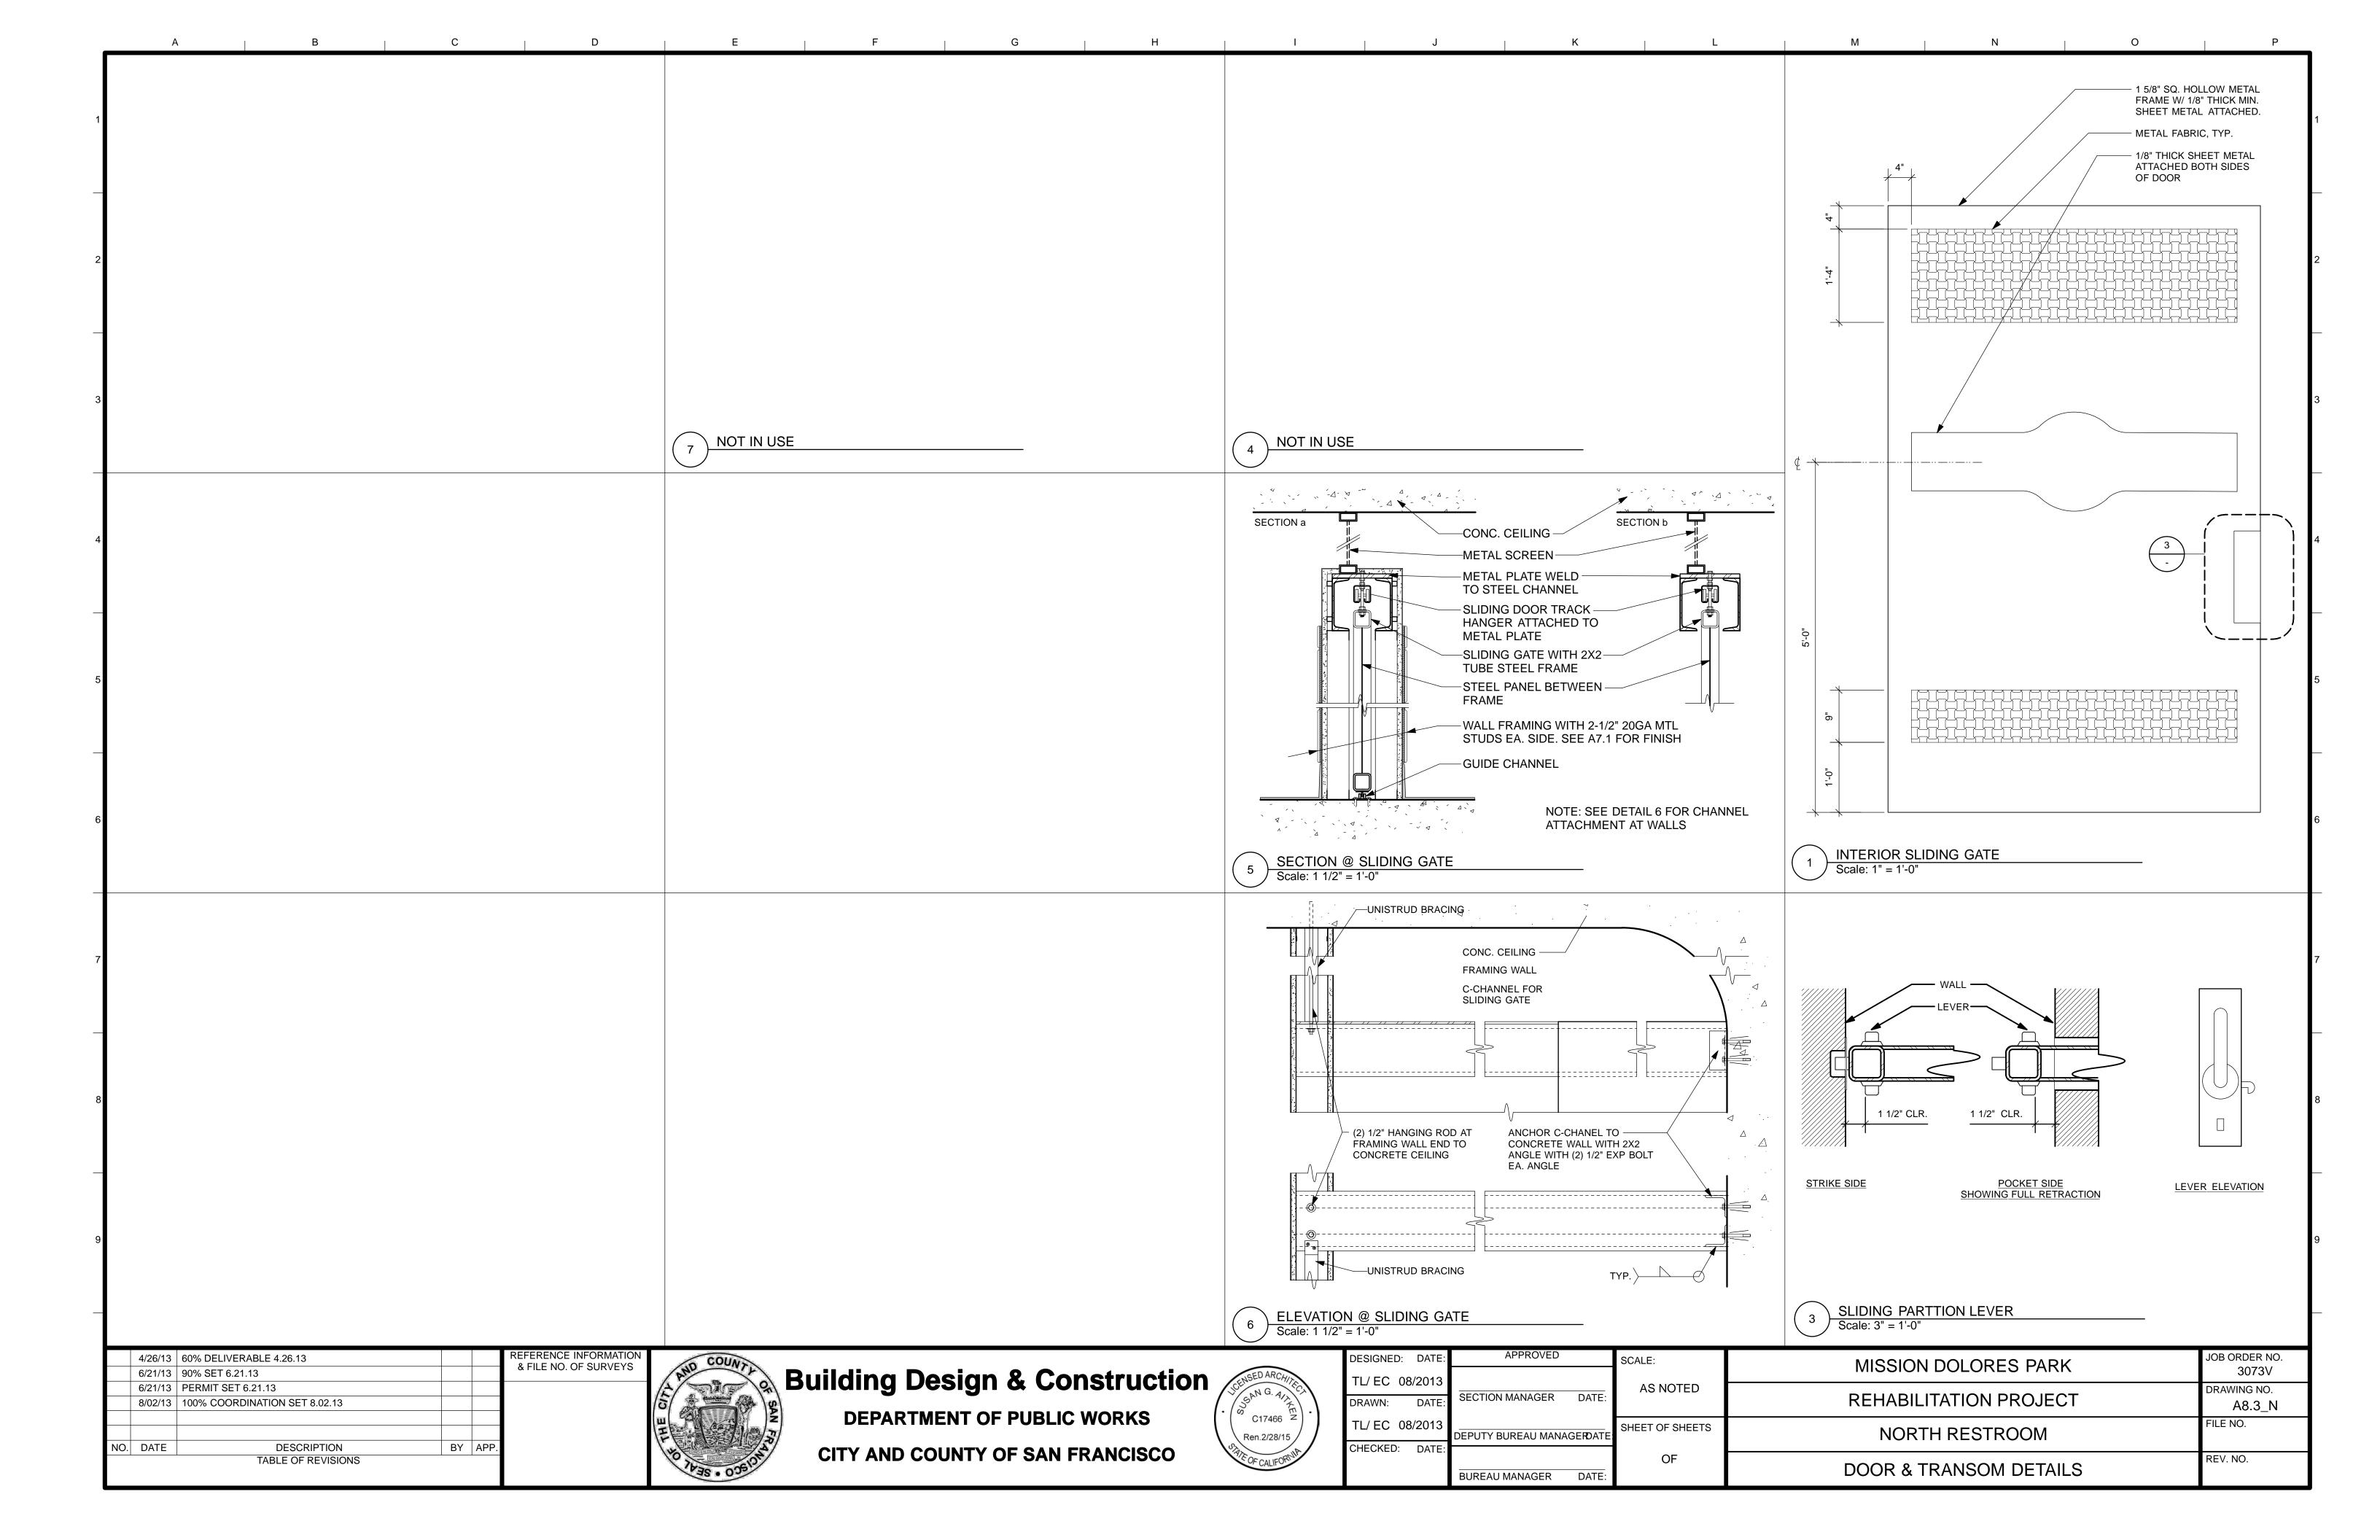


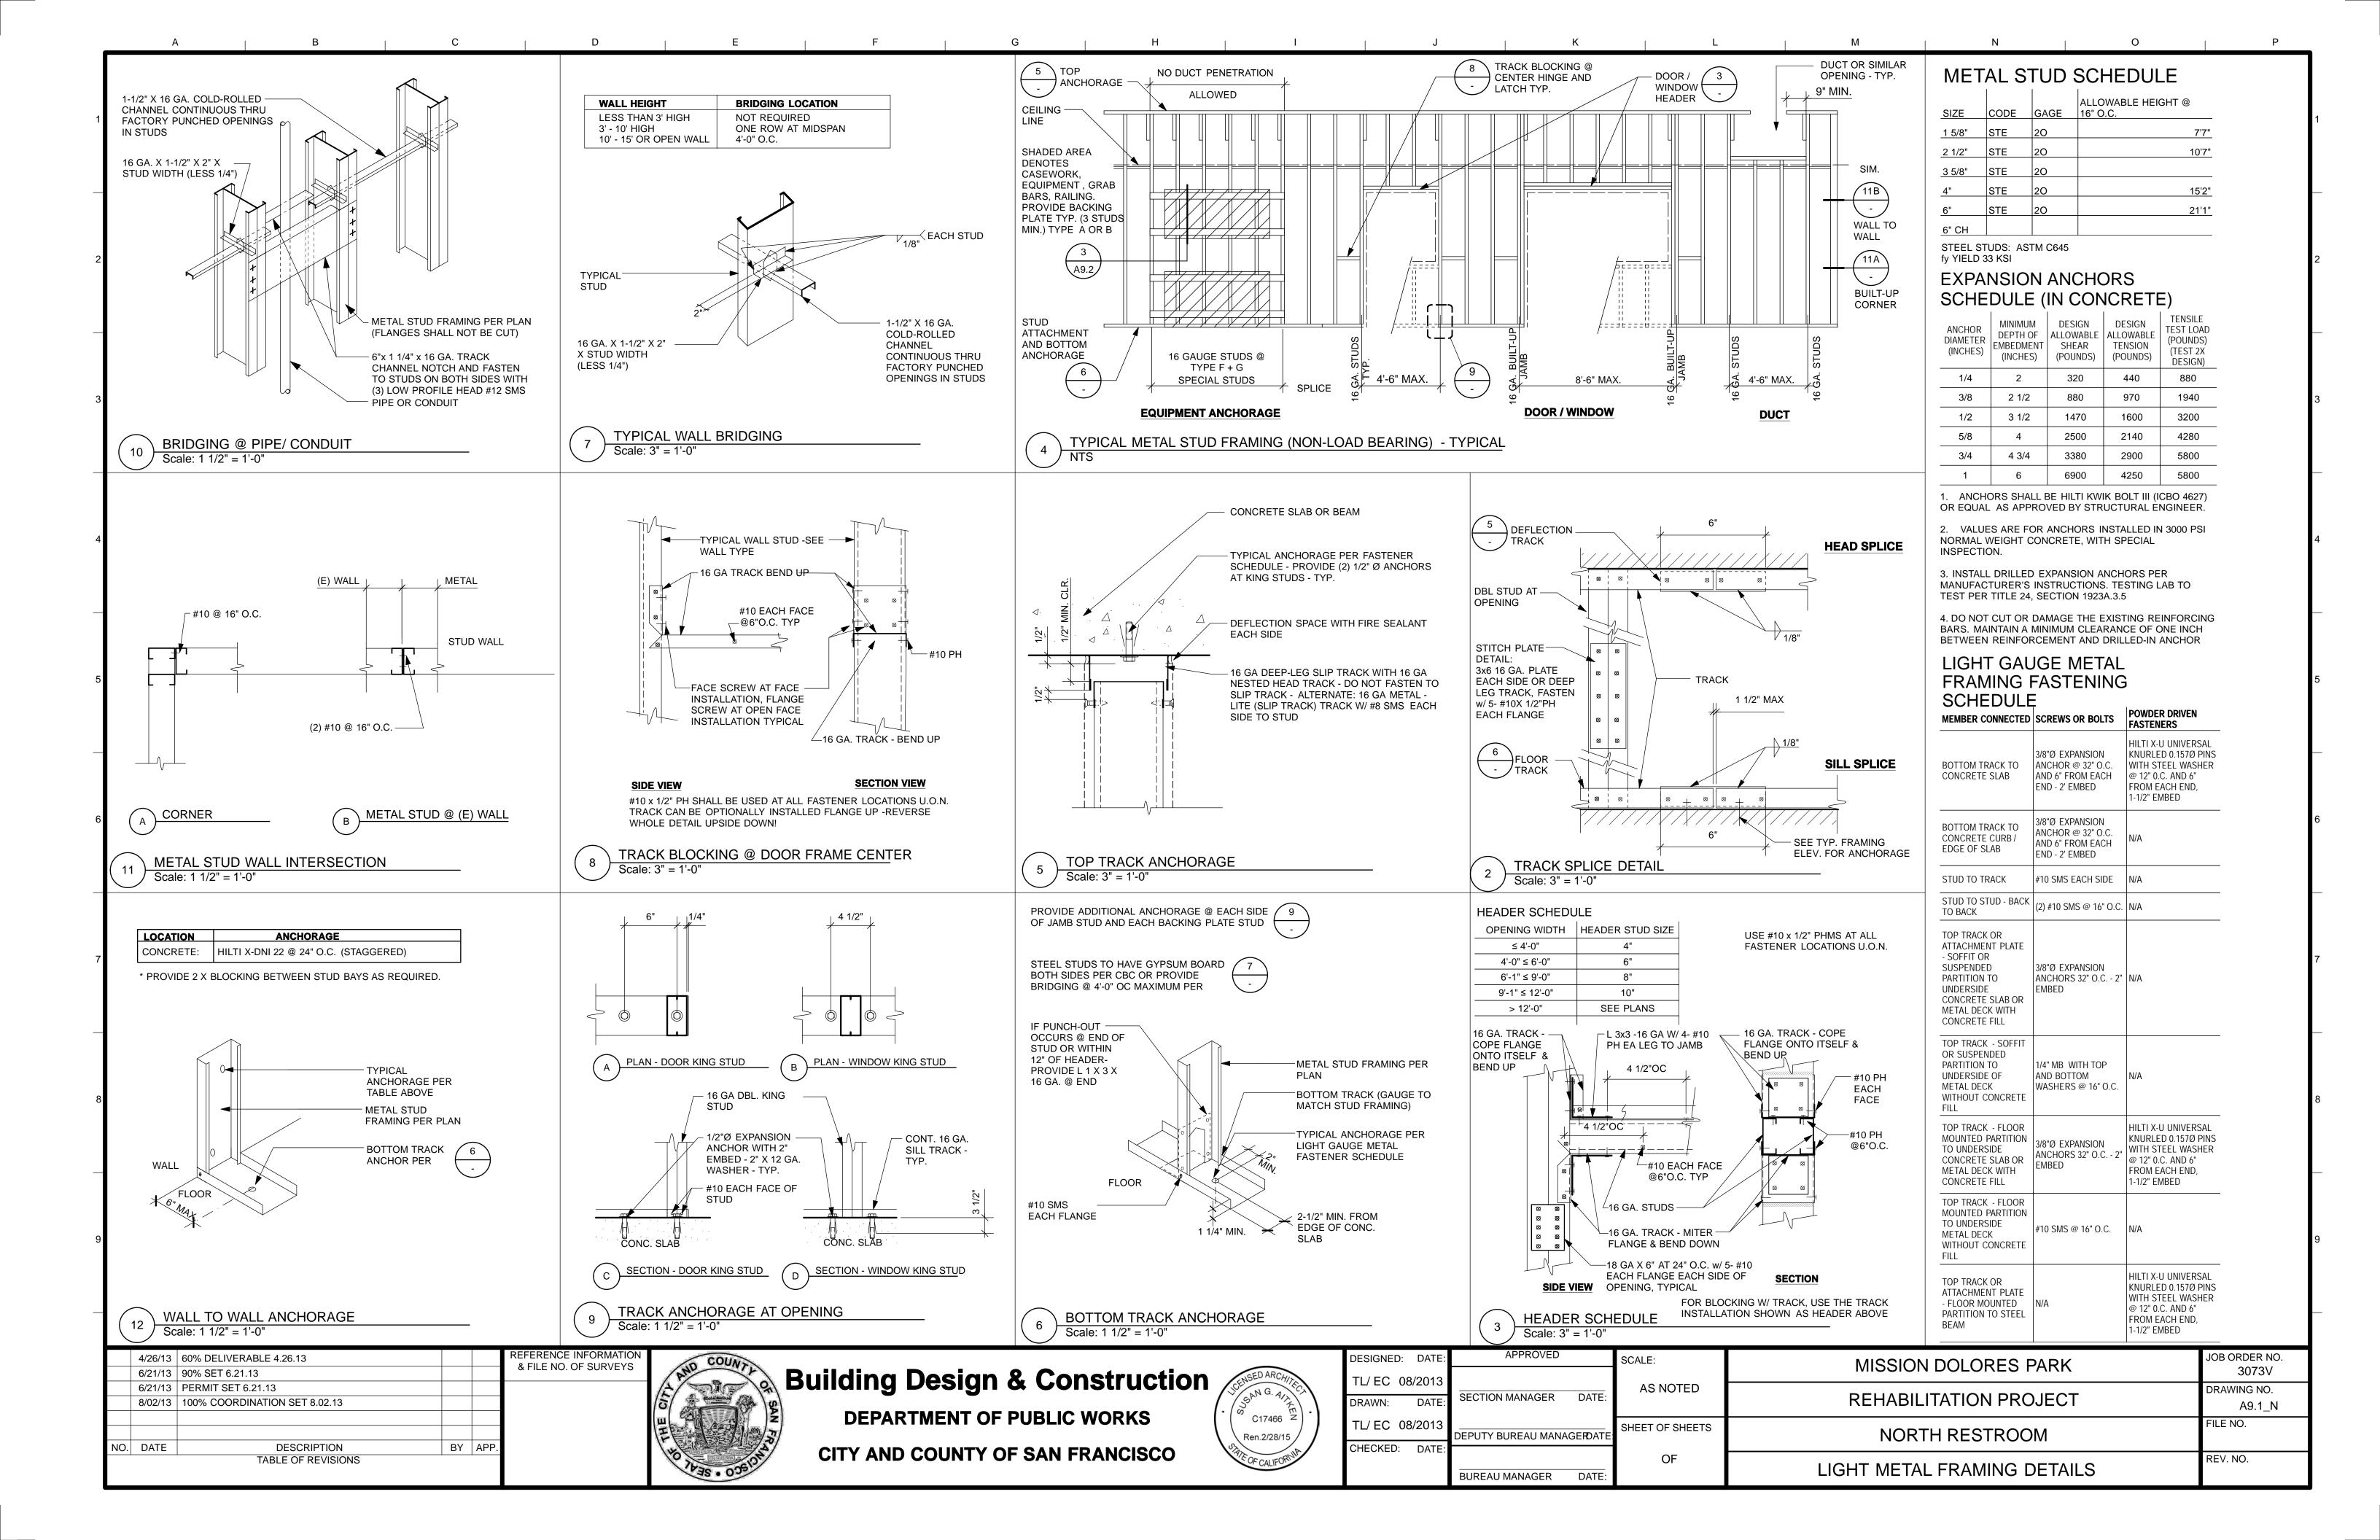

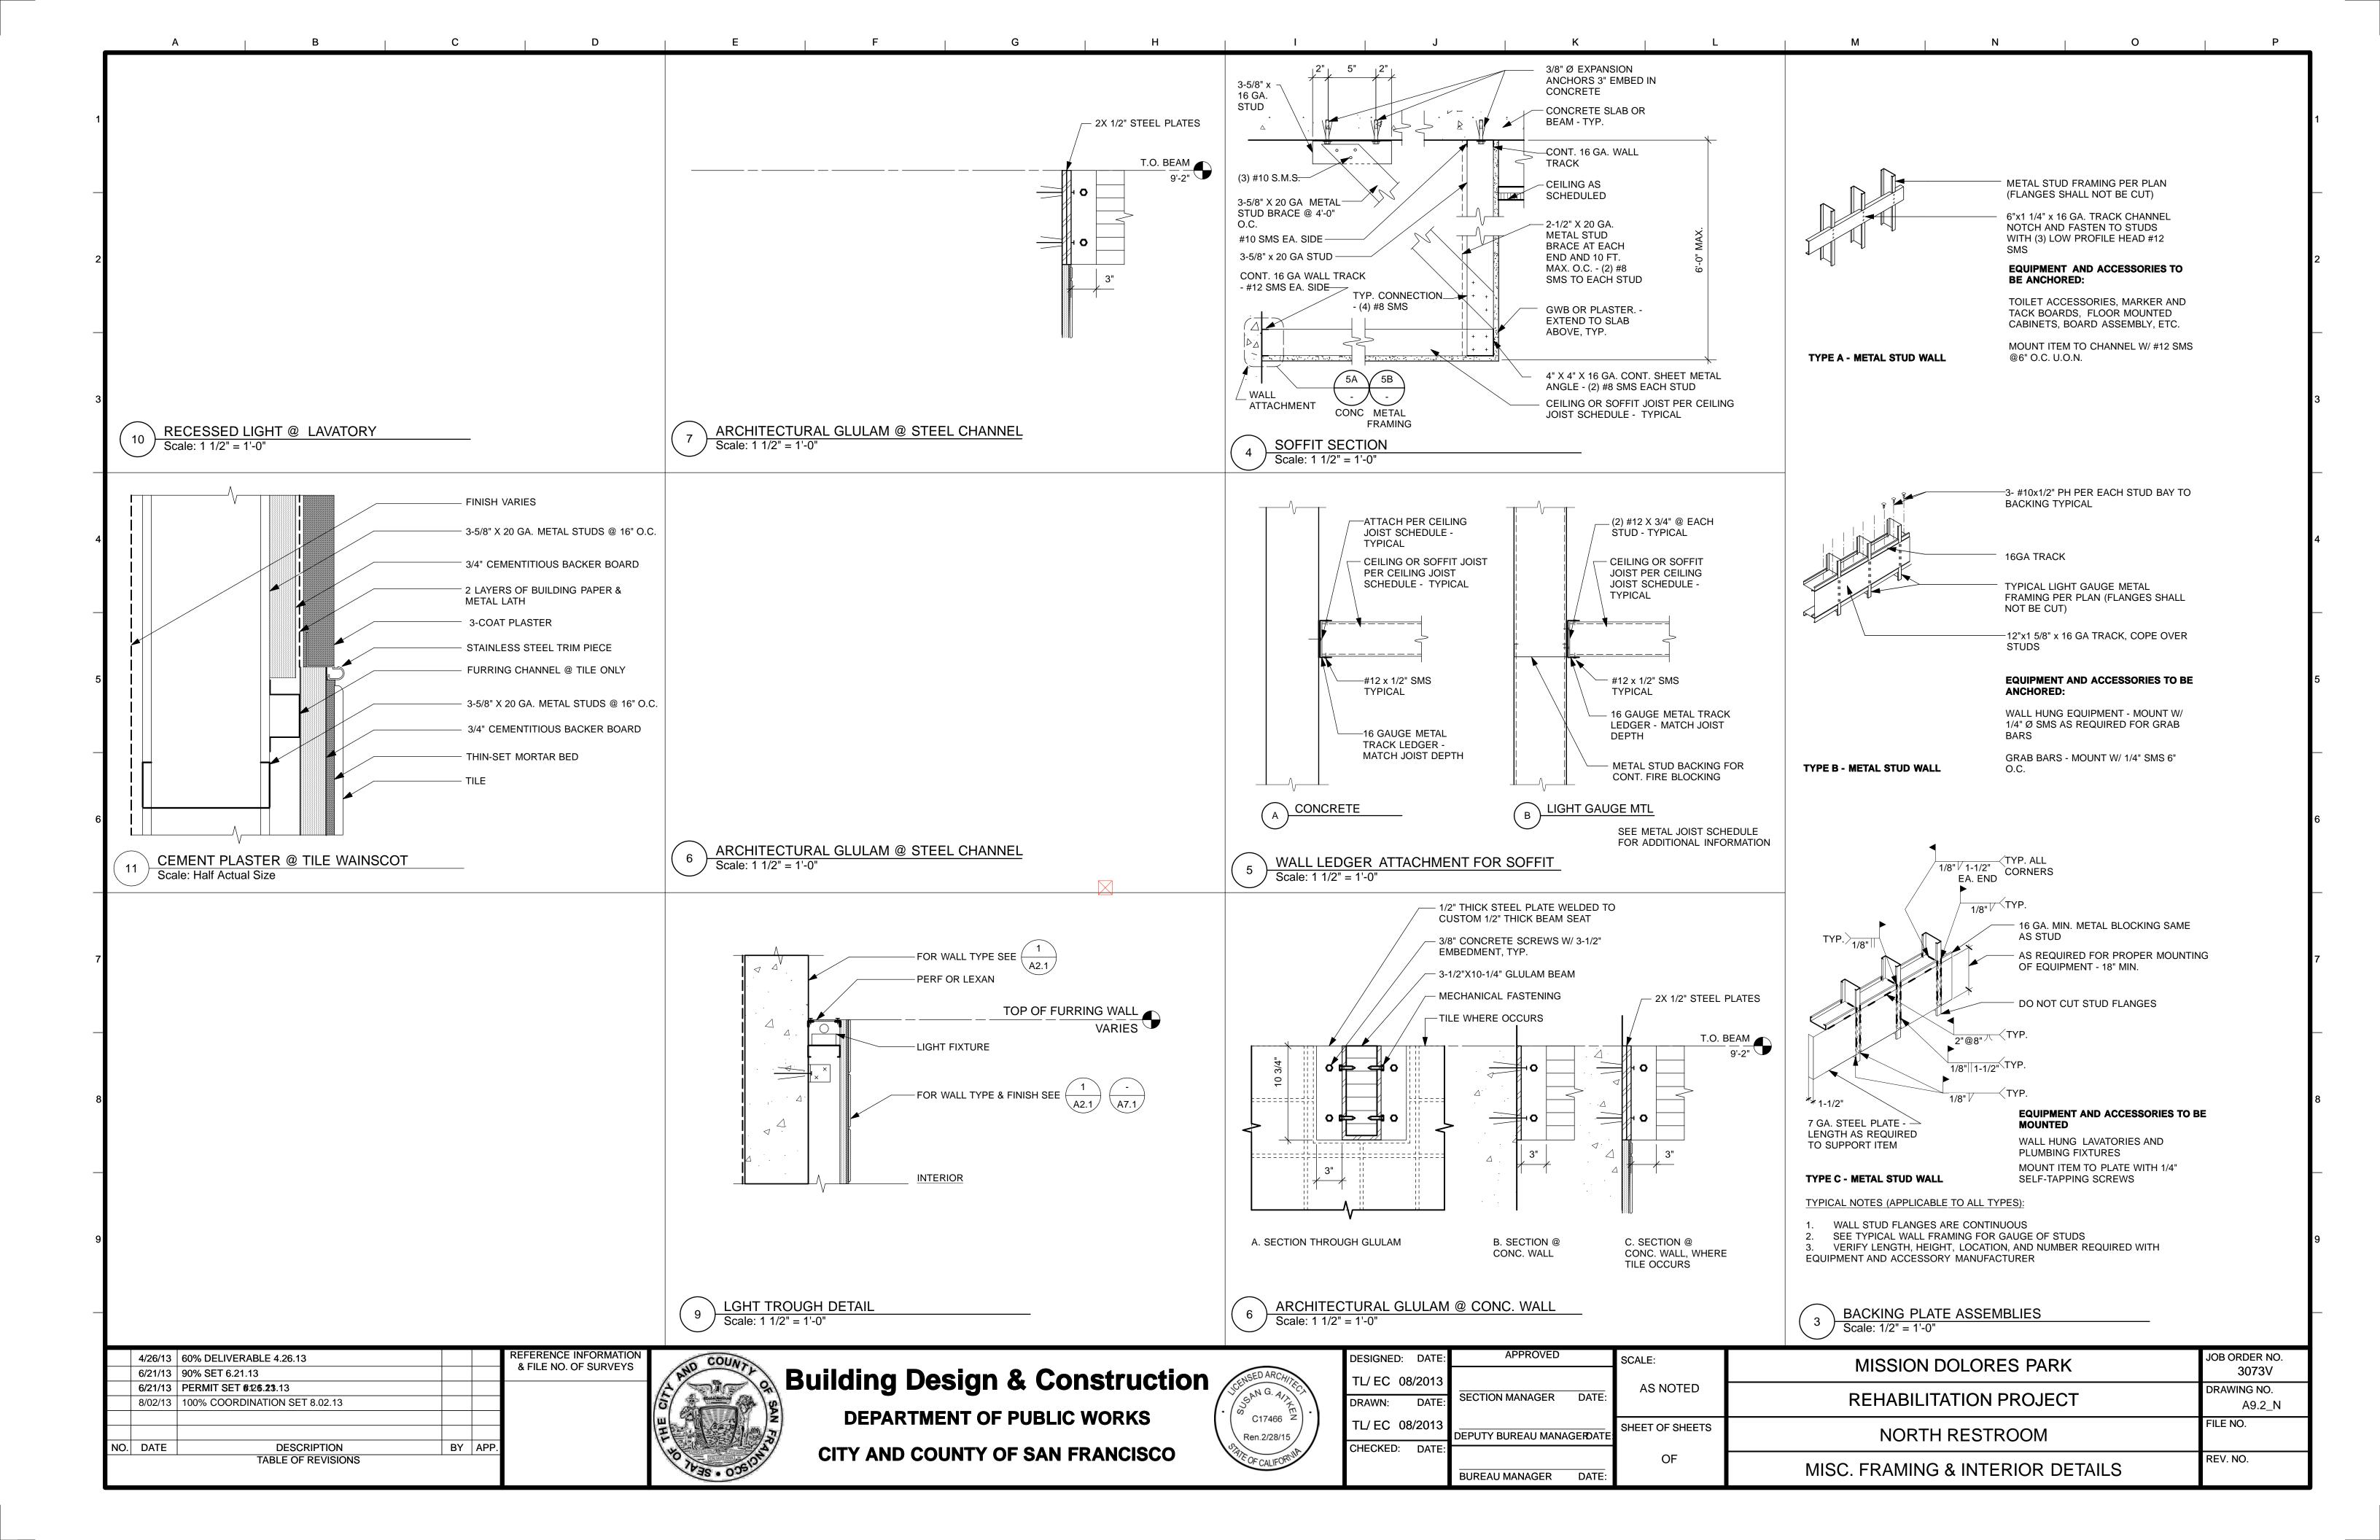

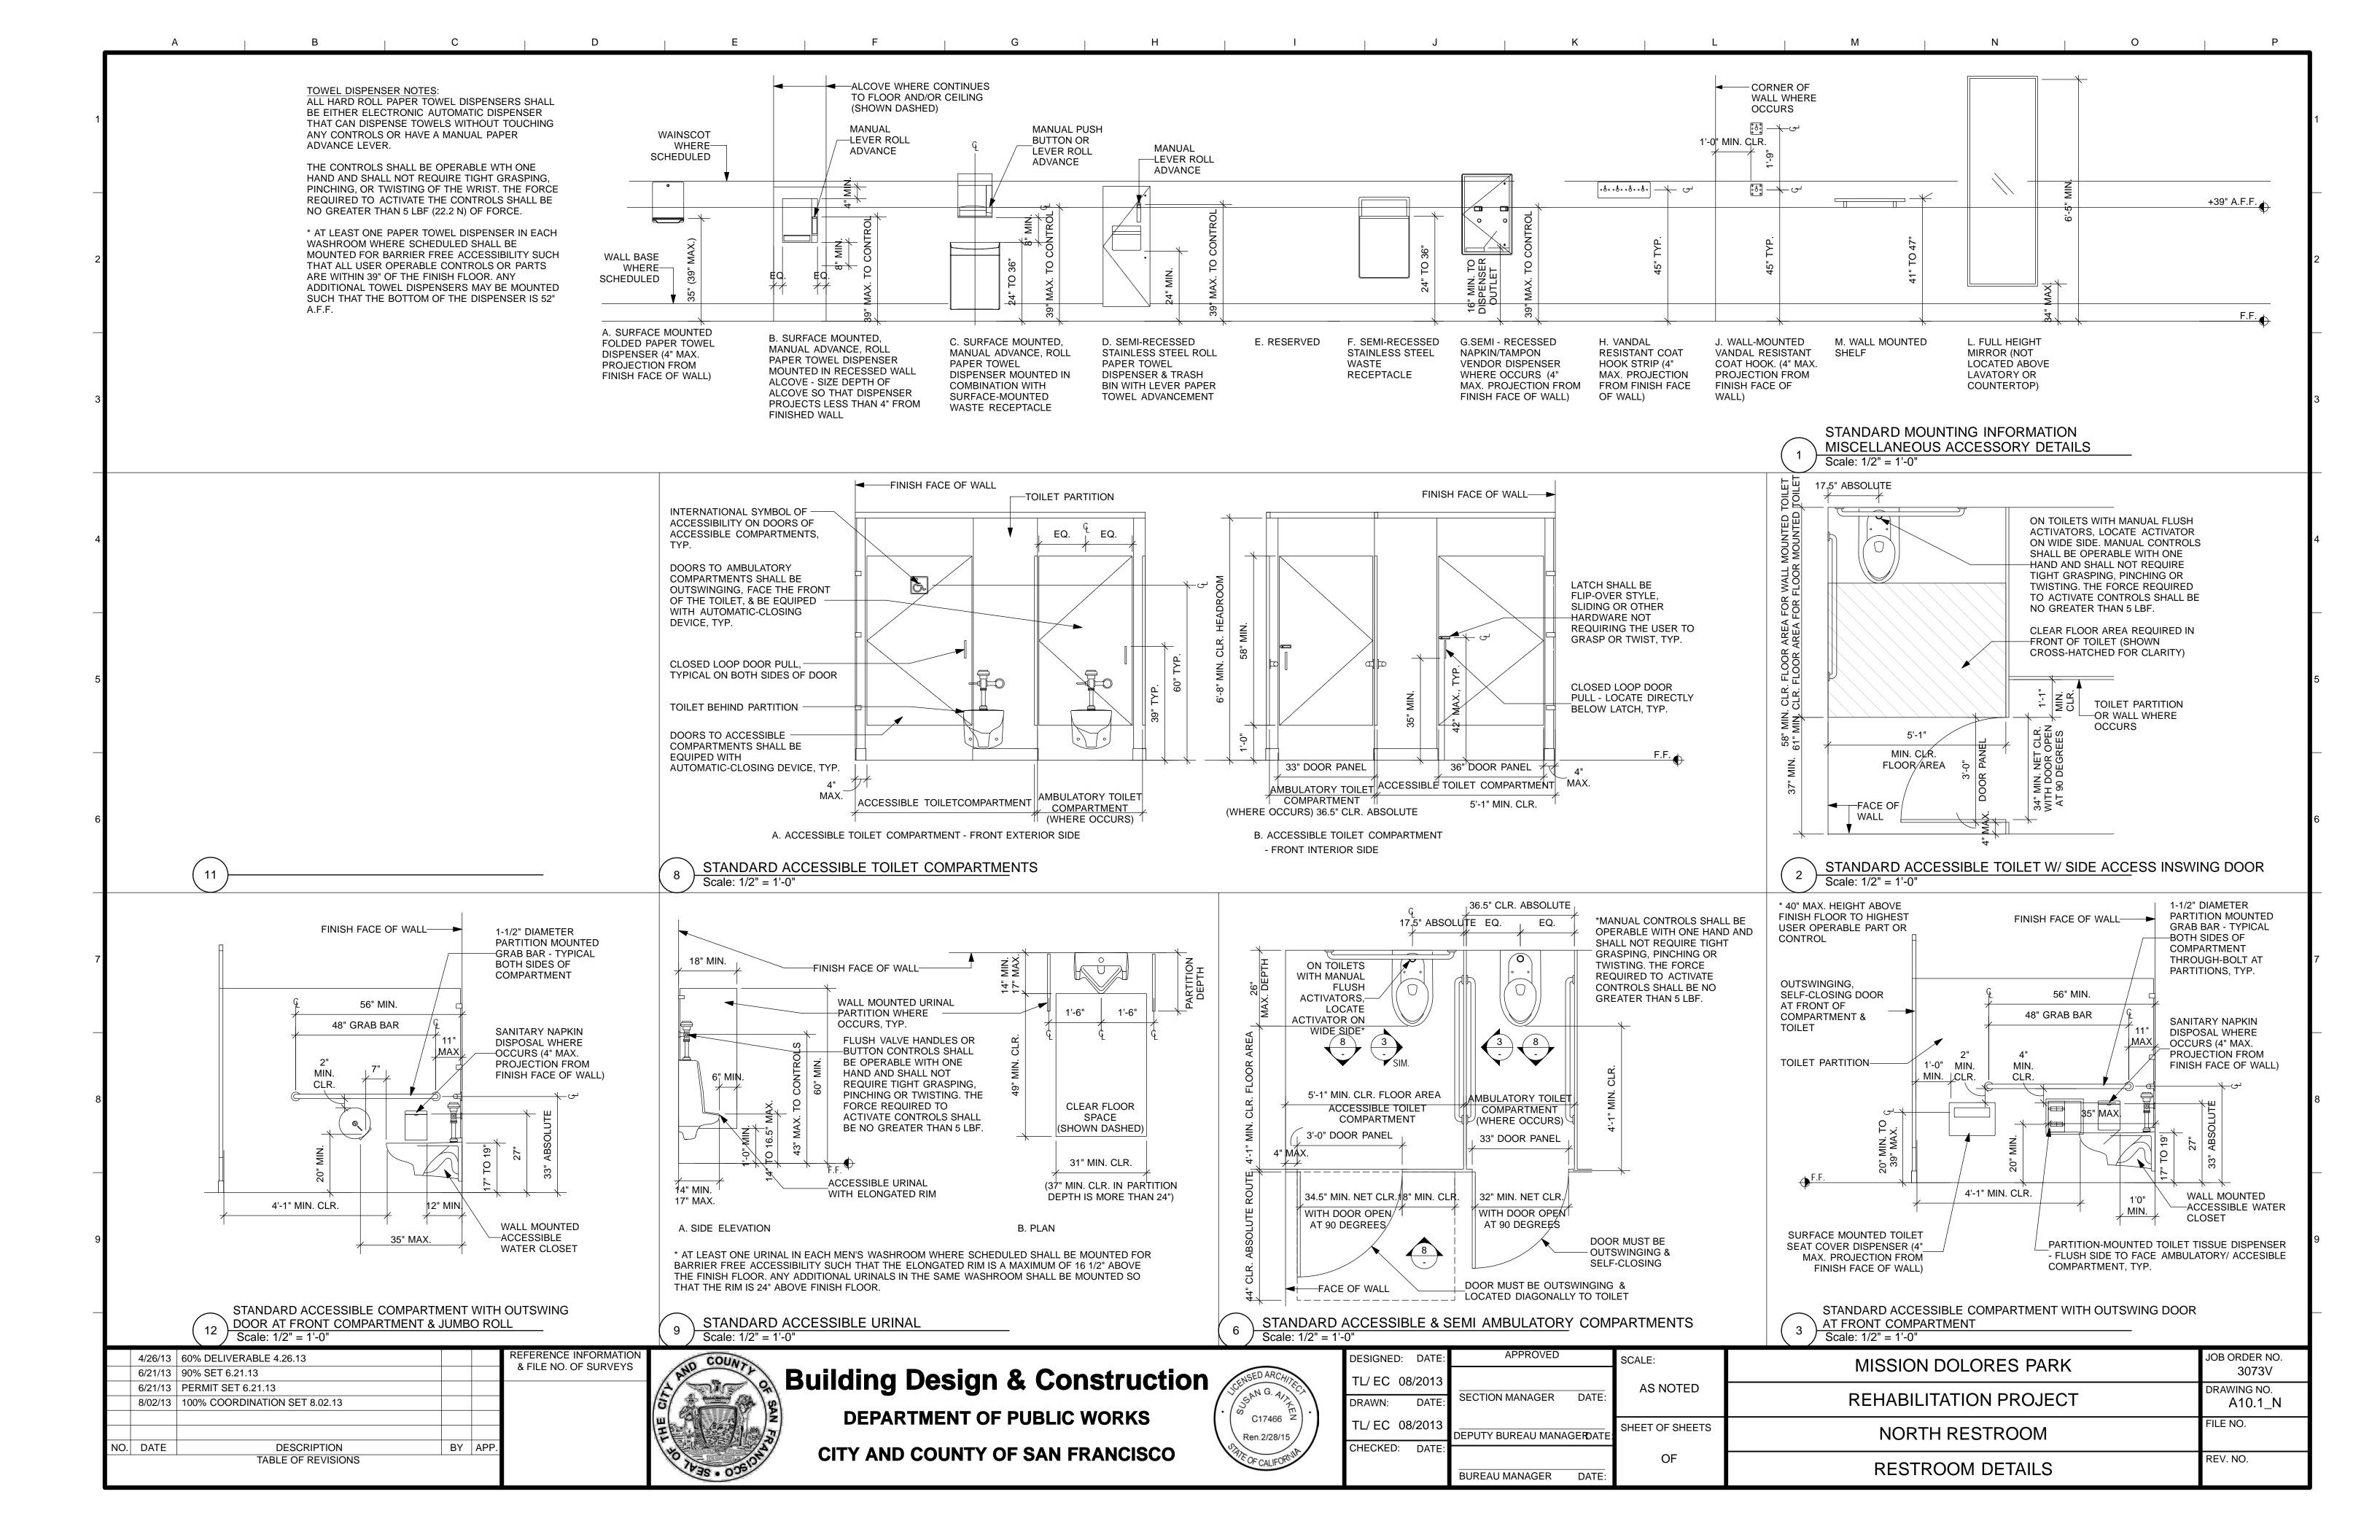

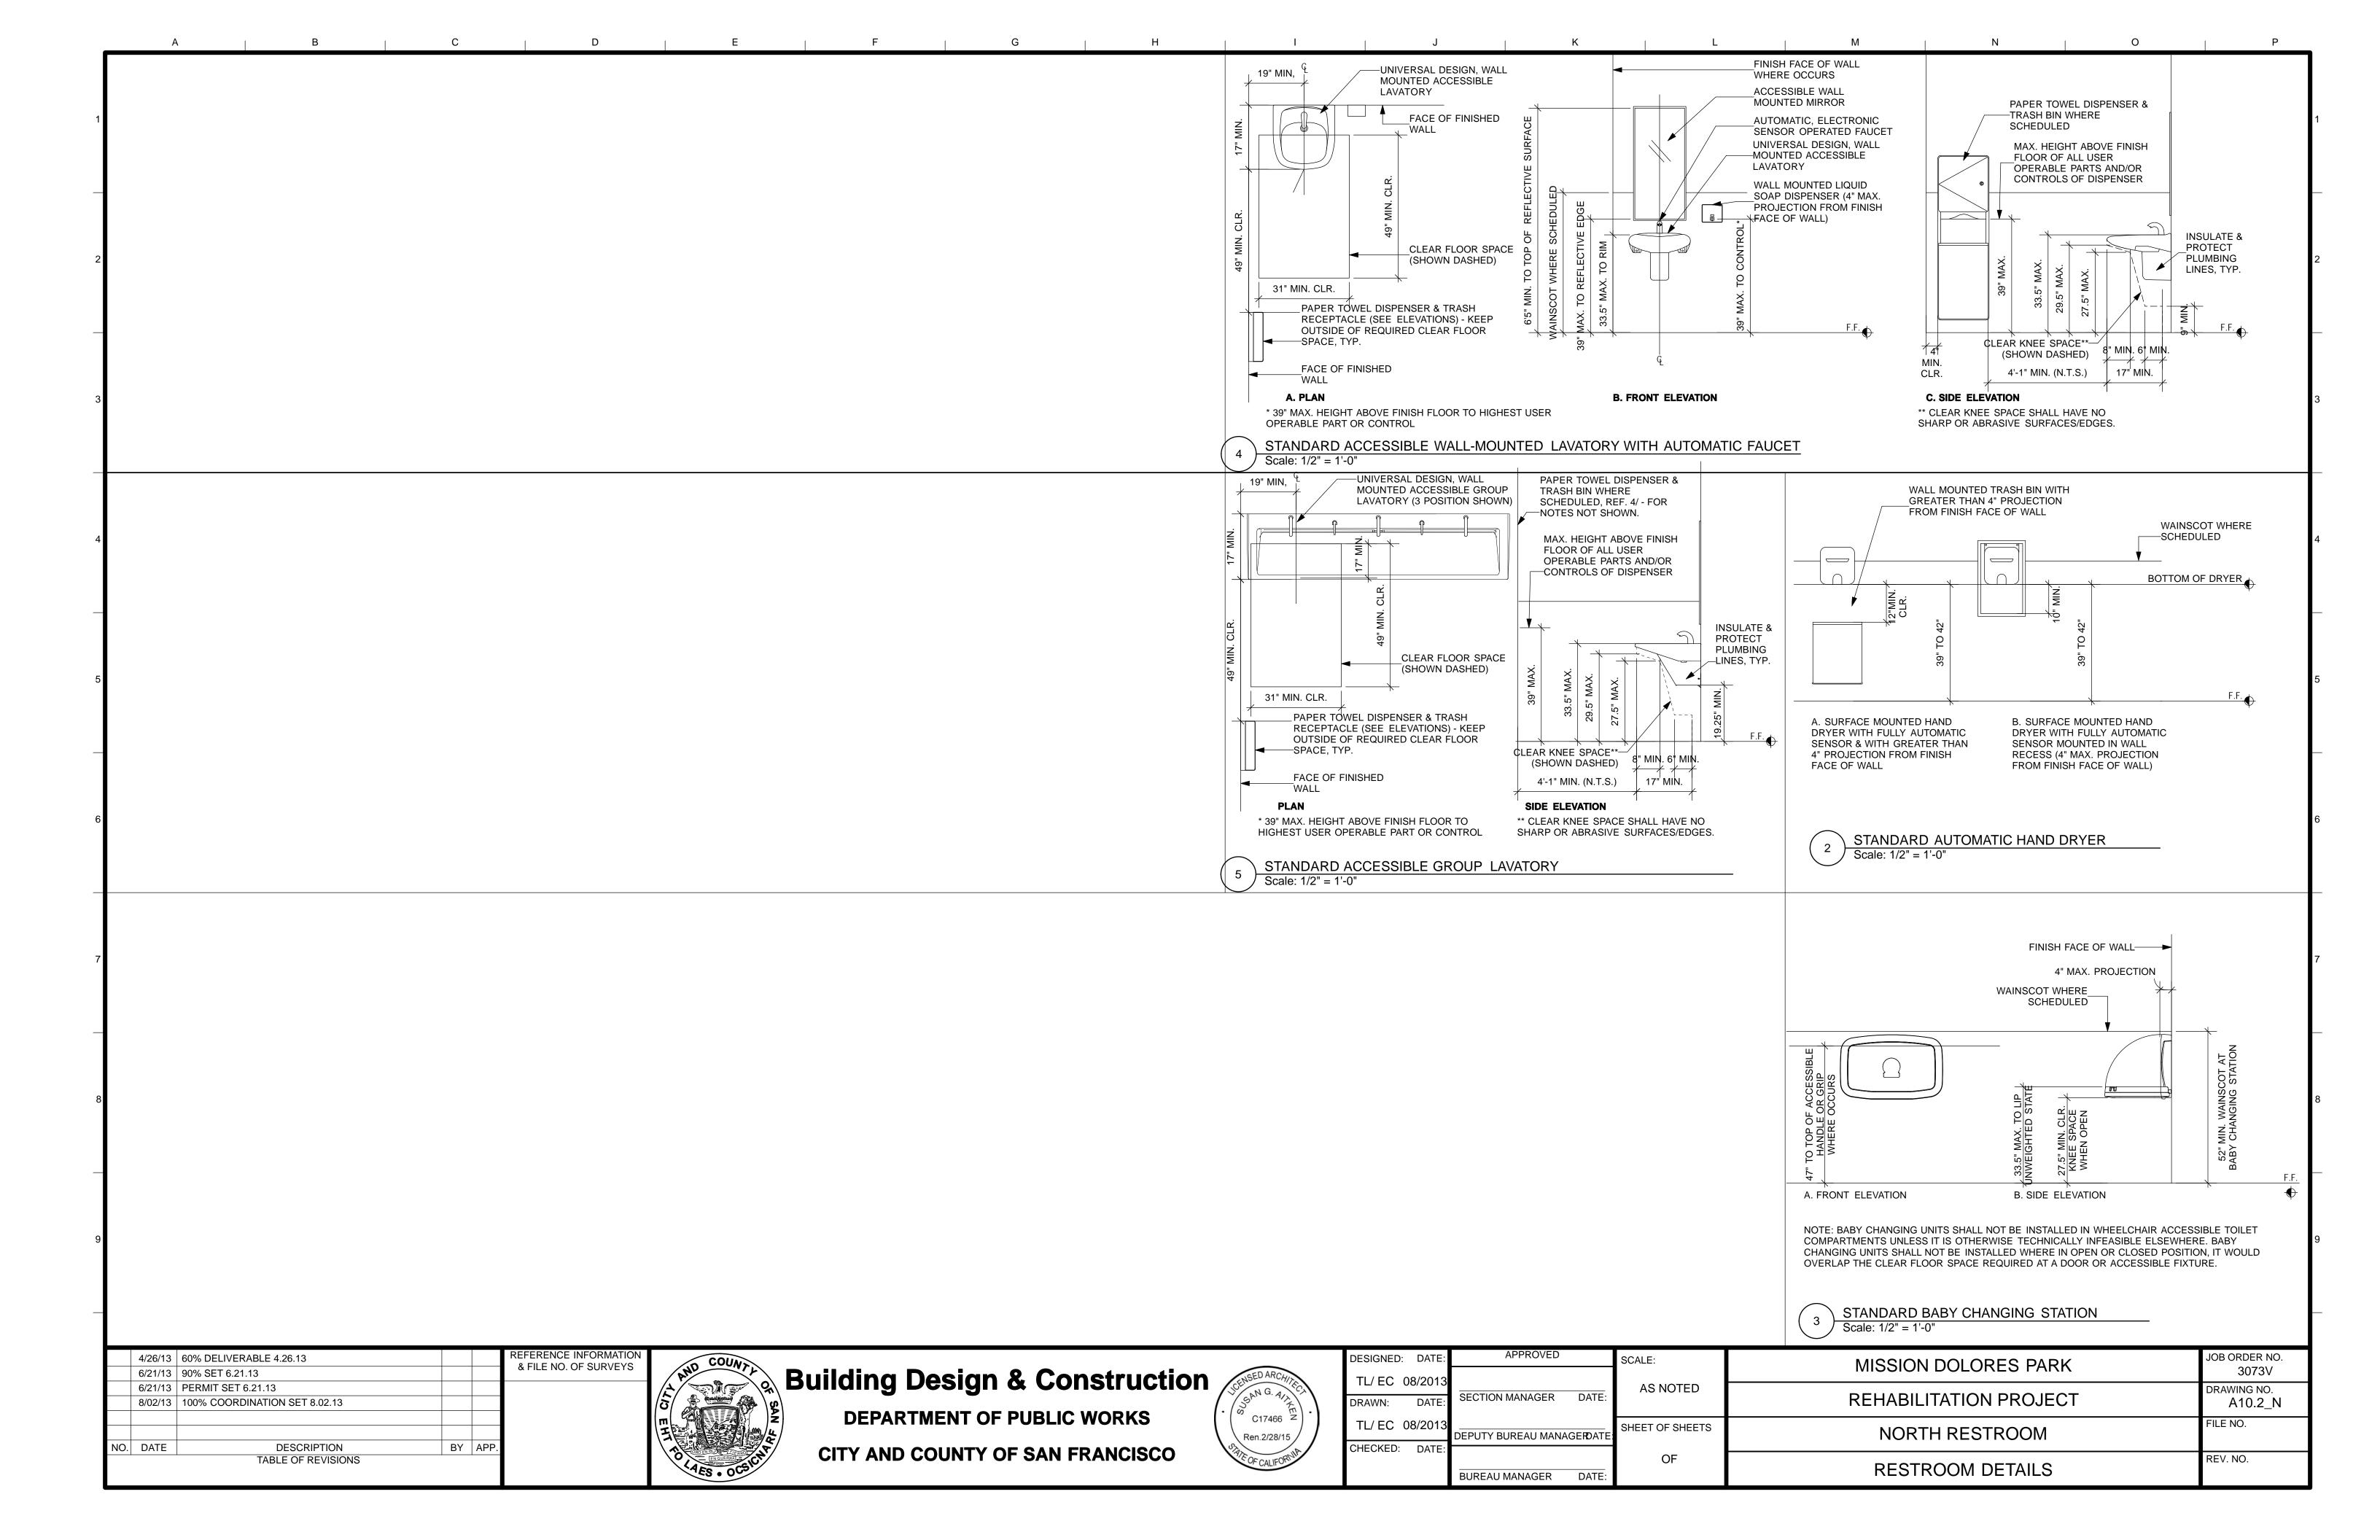

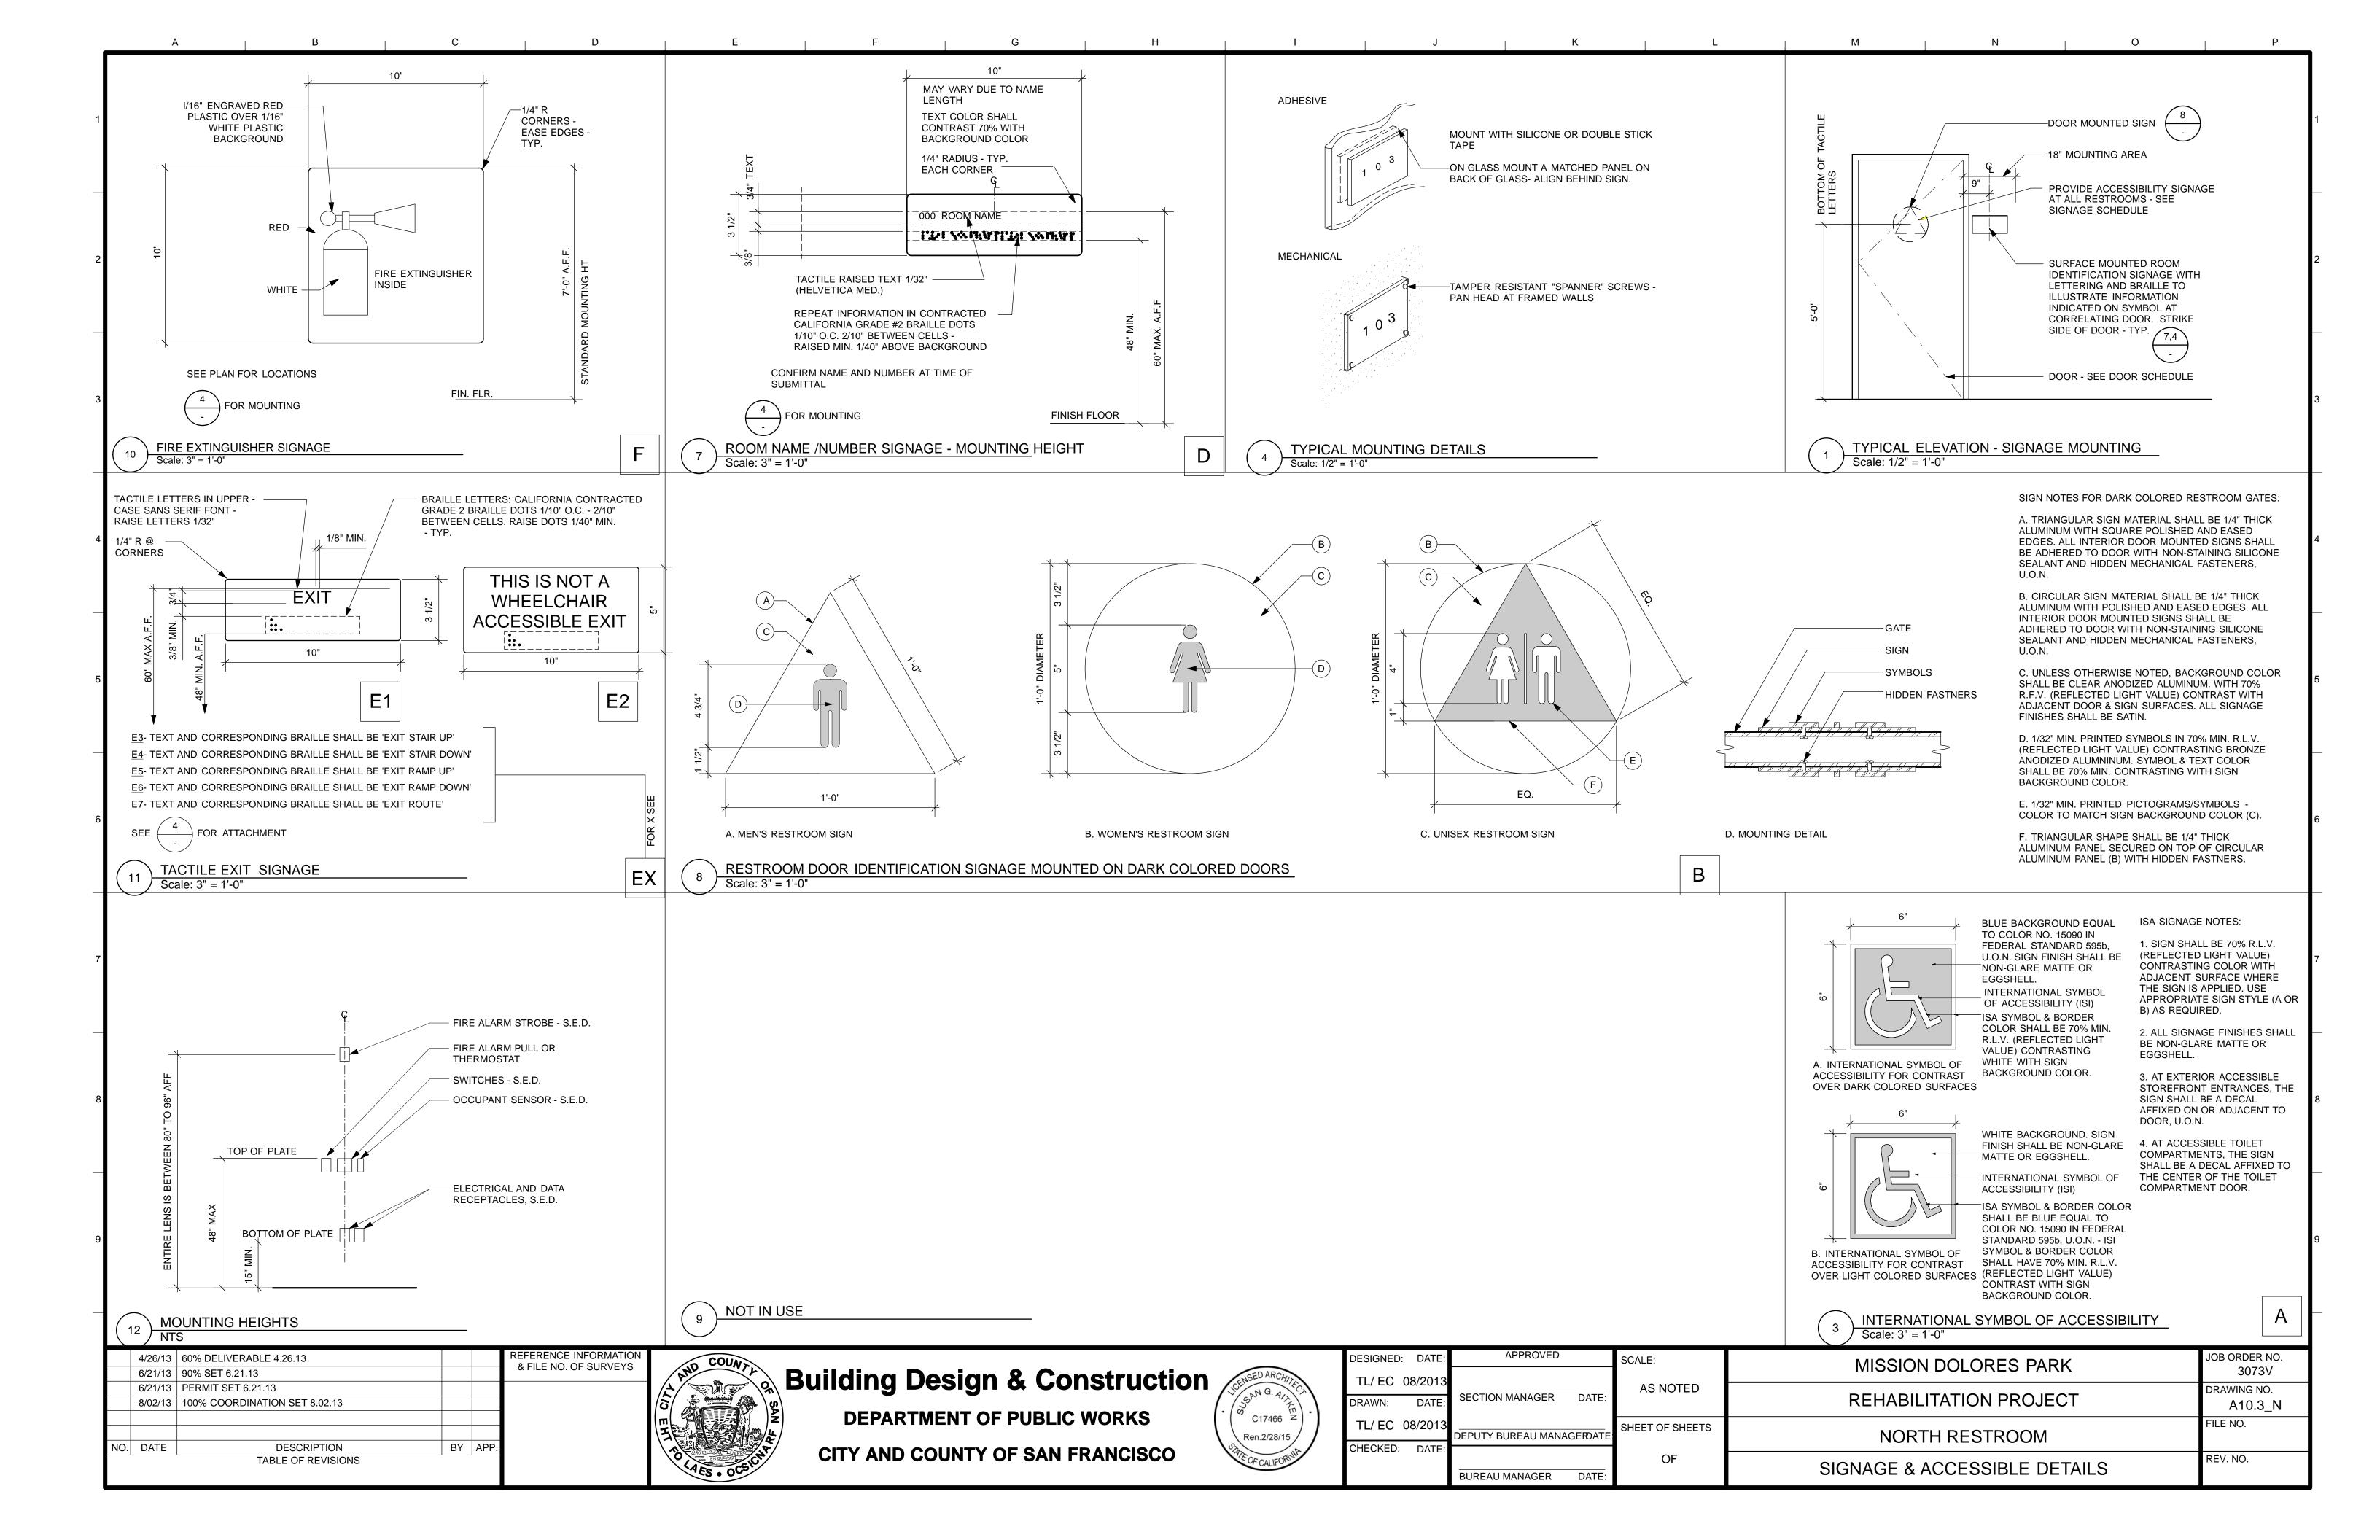

RESPONSIBLE FOR SEQUENCING THE WORK.

8. PERFORM ALL WORK IN AN ORDERLY MANNER WITHOUT DAMAGE TO OTHER PARTS OF THE BUILDING OR ADJACENT PROPERTIES. PROTECT ANY ADJACENT COMPLETED WORK OR PARTS OF THE BUILDING TO REMAIN WITH MEANS AVAILABLE TO CONTRACTOR INCLUDING BUT NOT LIMITED TO: BARRICADES, PROTECTION BOARDS, DROPCLOTHS, OR TEMPORARY REMOVAL FOR REINSTALLATION, IF PERMITTED BY THE CITY. ANY RESULTING DAMAGE OR LOSS SHALL BE REPAIRED OF CORRECTED BY THE CONTRACTOR AT NO EXPENSE TO THE OWNER. 9. THE CONTRACTOR SHALL BARRICADE THE WORK AREA TO PREVENT ACCESS BY UNAUTHORIZED PERSONS.

#### **B. DOCUMENTS**

1. THE INTENT OF THESE DRAWINGS AND SPECIFICATIONS IS TO DESCRIBE LABOR, MATERIALS, EQUIPMENT, AND SERVICES NECESSARY FOR WORK UNDER THIS CONTRACT. INCLUDE ALL WORK SHOWN, PRESCRIBED, OR REASONABLY IMPLIED BY THE CONTRACT DOCUMENTS. WHERE WORK OR EQUIPMENT IS INDICATED "NOT IN CONTRACT", SUCH WORK AND/OR EQUIPMENT SHALL BE PROVIDED BY OTHERS. CONTRACTOR SHALL COORDINATE AND COOPERATE TO EFFECT SUCH INSTALLATION.

2. THE CONTRACT DOCUMENTS, INCLUDING THE SPECIFICATIONS AND PLANS AND DRAWINGS, ARE COMPLIMENTARY AND WHAT IS CALLED FOR BY ANY ONE SHALL BE AS BINDING AS IF CALLED FOR BY ALL. SUBSEQUENT ADDENDA, INTERPRETATIONS, OR CHANGE ORDERS SHALL GOVERN OVER THE ORIGINAL DOCUMENTS, UNLESS A DIFFERENT ORDER OF PRECEDENCE IS NOTED ELSEWHERE IN CONJUNCTION WITH A

SPECIFIC PORTION OF THE DOCUMENTS. 3. THE DRAWINGS ARE DIAGRAMMATIC IN NATURE. ELEMENTS WITHIN THE DRAWINGS ARE DESCRIBED USING ABSTRACT GRAPHIC SYMBOLS AND CONVENTIONS, WHICH REPRESENT BUILDING ELEMENTS.

4. ALL ITEMS INDICATED ARE NEW WORK UNLESS NOTED AS EXISTING OR (E). 5. THESE GENERAL NOTES APPLY TO THE ENTIRE WORK OF THIS CONTRACT 6. WITHIN THE DRAWINGS, OTHER GENERAL NOTES OCCUR WHICH DESCRIBE SPECIFIC TYPES OF WORK OR PROCEDURES, SUCH AS "DEMOLITON GENERAL NOTES". THESE NOTES APPLY TO ALL SIMILAR TYPES OF WORK OR PROCEDURES

WITHIN THE ENTIRE CONTRACT. 7. SHEET NOTES APPLY TO THE DRAWING SHEET ON WHICH THEY OCCUR KEYNOTES REFER TO SPECIFIC ITEMS ON THE DRAWINGS, AND A KEYNOTE NUMBER ON ONE SHEET SHALL HAVE THE SAME MEANING ON EVERY SHEET. 8. ALL REQUESTS FOR CLARIFICATIONS OF THESE DRAWINGS SHALL BE DIRECTED TO THE CITY REPRESENTATIVE, REVIEW THE DOCUMENTS IN ADVANCE OF SCHEDULING THE WORK, AND MAKE REQUESTS FOR CLARIFICATION SUFFICIENTLY

IN ADVANCE TO AVOID DELAY.

9. DO NOT SCALE DRAWINGS 10. CONTRACTOR SHALL FIELD VERIFY ALL DIMENSIONS PRIOR TO DEMOLITION, FABRICATION, ASSEMBLY, OR INSTALLATION OF ANY WORK.

11. ITEMS INDICATED TO BE VERIFIED OR FIELD VERIFIED ARE REQUIRED TO BE VERIFIED PRIOR TO ORDERING MATERIALS OR PROCEEDING WITH THE WORK. ITEMS SHALL BE VERIFIED FOR DESIGN INTENT AND COMPATIBILITY WITH APPROPRIATE BUILDING CODES.

12. NOT IN USE. 13. VERIFY ALL EXISTING CONDITIONS AND PROPOSED DIMENSIONS AT JOB SITE. EXISTING DIMENSIONS GIVEN ARE TAKEN FROM INFORMATION PROVIDED BY THE OWNER'S SURVEY. REVIEW ALL DRAWINGS AND DIMENSIONS BEFORE COMMENCING CONSTRUCTION MATERIAL AND AFFECTED CONSTRUCTION IN EXISTING OCCUPIED WORK AND NOTIFY CITY REPRESENTATIVE OF ANY DISCREPANCIES. DO NOT

PROCEED WITH WORK UNTIL DISCREPANCIES ARE RESOLVED. 14. WHERE ON ANY DRAWING A PORTION OF THE WORK IS DRAWN OUT AND THE REMAINDER IS INDICATED IN OUTLINE, THE DRAWN-OUT PARTS SHALL APPLY TO ALL 11. ALL FIRE ALARM INITIATING DEVICES (ALARM BOXES) TO BE MOUNTED PER T-24 OTHER LIKE PORTIONS OF THE WORK. WHERE ORNAMENT OR OTHER DETAIL IS INDICATED AS STARTING, SUCH DETAIL SHALL BE CONTINUED THROUGHOUT THE COURSES OR PARTS IN WHICH IT OCCURS AND SHALL ALSO APPLY TO OTHER

SIMILAR PARTS IN THE WORK, UNLESS OTHERWISE INDICATED. 15. IN CASE OF CONFLICT BETWEEN THE DOCUMENTS, THE DOCUMENT CONTAINING ADDITIONAL QUANTITIES SHALL GOVERN IN MATTERS OF QUANTITY, AND THE DOCUMENT REQUIRING A HIGHER DEGREE OF QUALITY SHALL GOVERN IN MATTERS 14. PROVIDE ONE CIRCUIT FOR ANY NEW EXIT SIGNS TO CONFORM TO CBC OF QUALITY. IN CASE OF CONFLICT WITHIN THE DRAWINGS INVOLVING QUANTITIES SECTION 1003.2.8.4. AND 1003.2.8.5. OR WITHIN THE SPECIFICATIONS INVOLVING QUALITY, THE GREATER QUANTITY AND 15. ALL CEILING AND MECHANICAL EQUIPMENT PLENUMS THAT ARE NEW OR TO THE HIGHER QUALITY SHALL BE FURNISHED. THE CONTRACTOR SHALL NOTIFY THE RECEIVE NEW WORK SHALL BE CLEAN AND FREE OF DEBRIS PRIOR TO CLOSING IN ARCHITECT OF ALL SUCH QUANTITY AND QUALITY CONFLICTS AND SHALL AGREE

UPON RESOLUTION, IN WRITING, PRIOR TO PROCEEDING. 16. STRUCTURAL DRAWINGS GOVERN FOR SPACING AND SIZING FOR ALL STRUCTURAL MEMBERS, REINFORCING AND INSTALLATION DETAILS. VERIFY ANY CONFLICT BETWEEN STRUCTURAL AND OTHER DOCUMENTS WITH THE ARCHITECT PRIOR TO PROCEEDING.

WORK IN RIGHTS OF WAY AND/OR SCAFFOLDING. 3. LOCATIONS OF ALL UTILITIES SHOWN ARE APPROXIMATE AND CONTRACTOR SHALL EXERCISE EXTREME CAUTION IN EXCAVATING AND TRENCHING ON THIS SITE TO AVOID INTERCEPTING EXISTING PIPING OR CONDUITS. IT SHALL BE THE RESPONSIBILITY OF THE CONTRACTOR TO LOCATE EXISTING UTILITIES WHETHER OR NOT SHOWN ON THESE DRAWINGS AND TO PROTECT THEM FROM DAMAGE. THE CITY IS NOT RESPONSIBLE FOR THE LOCATION OF UNDERGROUND UTILITIES OR STRUCTURES WHETHER OR NOT SHOWN OR DETAILED AND INSTALLED BY H. ROOFING AND INSULATION ANY OTHER CONTRACT. THE CONTRACTOR SHALL IMMEDIATELY NOTIFY THE CITY REPRESENTATIVE SHOULD ANY UNIDENTIFIED CONDITIONS BE DISCOVERED. THE CONTRACTOR SHALL BEAR ALL EXPENSE OF REPLACEMENT OF UTILITIES OR OTHER PROPERTY DAMAGED BY OPERATIONS IN CONJUNCTION WITH PROSECUTION OF THIS WORK 4. EXISTING UTILITIES AND IMPROVEMENTS DAMAGED DURING THE COURSE OF THE WORK SHALL BE PROMPTLY REPAIRED. EXISTING UTILITIES AND IMPROVEMENTS DAMAGED, FOR WHICH LOCATIONS WERE

UNKNOWN, SHALL BE IMMEDIATELY BROUGHT TO THE OWNER'S AND ARCHITECT'S ATTENTION AND PROMPTLY REPAIRED AT HIS/HER DIRECTION. THE WORK REQUIRED TO REPAIR DAMAGED EXISTING UTILITIES AND IMPROVEMENTS FOR WHICH LOCATIONS WERE UNKNOWN WILL BE REVIEWED AND TAKEN UNDER CONSIDERATION AS EXTRA WORK.

#### D. FIRE SAFETY

1. GENERAL: FIRE SAFETY DURING CONSTRUCTION SHALL COMPLY WITH CALIFORNIA FIRE CODE (CFC) CALIFORNIA CODE OF REGULATIONS (CCR) TITLE 24. PART 9 ARTICLE 87.

2. ACCESS ROADS: FIRE DEPARTMENT ACCESS ROADS SHALL BE ESTABLISHED AND MAINTAINED IN ACCORDANCE SECTION 902. 3. WATER SUPPLY: WATER MAINS AND HYDRANTS SHALL BE OPERATIONAL IN ACCORDANCE WITH SECTION 903.

4. BUILDING ACCESS: ACCESS TO BUILDINGS FOR THE PURPOSE OF FIREFIGHTING SHALL BE PROVIDED. CONSTRUCTION MATERIAL SHALL NOT BLOCK ACCESS BUILDINGS, HYDRANTS OR FIRE APPLIANCES. 6. DEMOLITION OF BUILDINGS: SHALL COMPLY WITH SECTION 8706 AND APPLICABLE PROVISIONS OF SECTIONS 8704 AND 8705.

7. FIRE WATCH: MAINTAIN FIRE WATCH WHEN REQUIRED BY THE BUILDING ARCHITECT OR PROFESSIONAL ENGINEER WHO HAS BEEN DELEGATED OFFICIAL AND WHEN EXISTING FIRE PROTECTION SYSTEMS ARE SHUT DOWN FOR ALTERATIONS. FIRE WATCH SHALL REMAIN IN EFFECT UNTIL EXISTING PROTECTION SYSTEMS ARE RETURNED TO SERVICE OR AS ALLOWED BY THE BUILDING OFFICIAL

8. PENETRATIONS OF FIRE RATED MATERIALS OR ASSEMBLIES SHALL BE RESTORED TO EQUAL RATING. FIRE STOP SYSTEMS AS LISTED BY UNDERWRITERS LABORATORIES SHALL BE INSTALLED PER FIRE RESISTANCE DIRECTORY. FIRE STOP SYSTEMS SHALL BE AS SPECIFIED. 9. OBTAIN APPROVAL FROM LOCAL FIRE AUTHORITY PRIOR TO STORAGE OF BUILDING.

10. PROTECT SMOKE DETECTORS NEAR CONSTRUCTION AREAS WITH A VISQUEEN OR SIMILAR WRAP. REMOVE PROTECTION AT END OF EACH WORKING DAY. CCR PART 3 ARTICLE 760-9.

PROCEDURES SHALL BE APPROVED BY THE BUILDING INSPECTOR PRIOR TO THE INSTALLATION. 13. ANY NEW EXIT SIGN SHALL BE INTERNALLY ILLUMINATED AND THE WORD 'EXIT' SHALL BE GREEN ON OPAQUE BACKGROUND PER CBC SECTION 1002.8.3.

12. ALL FIRE DAMPER ASSEMBLIES, INCLUDING SLEEVES AND INSTALLATION

AND PRIOR TO RETURN AIR FAN START-UP.

#### E. EXTERIOR ACCESSIBILITY

1. ALL NEW WALKS AND SIDEWALKS SHALL HAVE A CONTINUOUS COMMON SURFACE, NOT INTERRUPTED BY STEPS OR BY ABRUPT CHANGES IN LEVEL, AND SHALL BE A MINIMUM OF 48" WIDE.

2. ALL NEW SURFACES WITH A SLOPE LESS THAN 6 PERCENT GRADIENT SHALL BE AT LEAST AS SLIP RESISTANT AS THAT DESCRIBED AS A MEDIUM BROOM FINISH.

2. ALL NEW FINISH MATERIALS SHALL BE MAINTAINED IN A FLAME RETARDANT CONDITION. (CCR T-19, SEC, 1.14, 3.08, 3.21) 3. ANY NEW FURRED CEILINGS SHALL BE CONSTRUCTED AS REQUIRED IN CBC SEC

2504 AND TABLE 25A. 4. ANY NEW SUSPENDED ACOUSTICAL CEILING BOARD SHALL BE NON-COMBUSTIBLE.

5. ALL NEW WALL AND CEILING MATERIALS IN EXIT CORRIDORS SHALL COMPLY WITH CBC SEC. 1005.

1. WHERE CEILING OR ROOF MOUNTED EQUIPMENT/ PENETRATIONS ARE REQUIRED TO BE REMOVED OR INSTALLED/ RE-INSTALLED, PROVIDE ROOFING AND FLASHING TO ACCOMMODATE THE CONDITION.

2. ALL INSULATION MATERIAL SHALL MEET THE CALIFORNIA QUALITY STANDARD PER SECTION 2.5311 B.E.E.S.-1986. ROOF INSULATION SHALL MEET CBC SECTION 1510 AND WALL INSULATION SHALL MEET CBC SECTION 1807.2. 3. ALL ROOFING SHALL BE CLASS A FIRE RETARDANT.

#### 1. DEMOLITION

1. DEMOLISH AND REMOVE FROM THE PREMISES ALL PARTS OF THE EXISTING BUILDING INDICATED FOR DEMOLITION OR REQUIRED TO BE DEMOLISHED FOR THE INSTALLATION OF NEW WORK. 2. ALL ITEMS NOTED TO BE SALVAGED SHALL BE RETURNED TO THE OWNER. THE

OWNER RETAINS THE RIGHT TO SALVAGE ANY EXISTING MATERIAL INDICATED OR REQUIRED TO BE REMOVED OR DEMOLISHED. 3. THE CONTRACTOR IS RESPONSIBLE FOR REVIEWING AND FIELD VERIFYING

DEMOLITION REQUIREMENTS IN RELATION TO CONSTRUCTION DRAWINGS. THE ARCHITECT IS TO BE NOTIFIED OF ANY CONFLICTS, DISCREPANCIES OR PROBLEMS 4. CONSTRUCTION DEBRIS AND WASTES SHALL BE DEPOSITED AT AN APPROPRIATE SITE. THE CONTRACTOR SHALL AT ALL TIMES KEEP PREMISES FREE FROM ACCUMULATION OF DEBRIS CAUSED BY ITS OPERATIONS. AT THE COMPLETION OF THE WORK, CONTRACTOR SHALL CLEAN ALL GLASS SURFACES AND LEAVE THE WORK IN A CLEAN CONDITION READY FOR OCCUPANCY.

#### J. DEFERRED APPROVAL ITEMS:

INSTALLATION OF DEFERRED APPROVAL ITEMS SHALL NOT BE STARTED UNTIL DETAILED PLANS, SPECIFICATIONS, AND ENGINEERING CALCULATIONS HAVE BEEN ACCEPTED AND SIGNED BY THE ARCHITECT OR ENGINEER IN GENERAL RESPONSIBLE CHARGE OF DESIGN AND SIGNED BY A CALIFORNIA REGISTERED. RESPONSIBILITY COVERING THE WORK SHOWN ON A PARTICULAR PLAN OR SPECIFICATION AND APPROVED BY THE SAN FRANCISCO DEPARTMENT OF BUILDING INSPECTION.

DEFERRED APPROVAL ITEMS FOR THIS PROJECT ARE THE FOLLOWING ITEMS:

1. SPRINKLER SYSTEM SHALL BE PROVIDED ON A DESIGN-BUILD BASIS AND SPRINKLER DRAWINGS PROVIDED ARE DIAGRAMMATIC. SPRINKLER SYSTEMS SHALL BE APPLIED FOR UNDER SEPARATE PERMIT BY THE CONTRACTOR UNLESS OTHERWISE NOTED. CONTRACTOR SHALL BE RESPONSIBLE FOR PROVIDING ALL FEES, ENGINEERED DRAWINGS, CALCULATIONS AND OTHER DOCUMENTATION REQUIRED BY FIRE MARSHALL AND ANY OTHER GOVERNING AGENCIES FOR PLAN CHECK AND PERMIT ISSUANCE.

C17466

Ren.2/28/15

## DRAWING

**BLOCKING** 

BEAM

**BOTTOM** 

**BRACKET** 

**BUILT-UP** 

**CABINET** 

CEMENT

CEILING

COLUMN

CARPET

CONSTR. CONSTRUCTION

COUNTER

CENTER

DOUBLE

DETAIL

DIAMETER

DIAGONAL

DISPOSAL

DOWN

DETAIL

**DIMENSION** 

DRY STANDPIPE

DISHWASHER

COLD WATER

CONCRETE

CONNECTION

CONTINUOUS

COUNTERSUNK

DEPARTMENT

DIAPER CHANGE STATION

DRINKING FOUNTAIN

**COMBINATION** 

**CLEAR** 

**CATCH BASIN** 

CERAMIC TILE

**CONTROL JOINT** 

CENTER TO CENTER

BLKG.

BOT.

B.U.

CAB.

CEM.

C.JT.

CLG

COL.

CRPT.

C.W.

COMB.

CONC.

CONN.

CONT.

CNTR

CTSK.

DCS.

DET.

DIAG.

DIM.

DISP

D.S.P.

DTL.

DW

DEPT.

BRKT.

LIST OF APPLICABLE CODES - CALIFORNIA CODE OF REGULATIONS

1.2 2010 CALIFORNIA BUILDING CODE (IBC), PART 2, TITLE 24 C.C.R. 2006 INTERNATIONAL BUILDING CODE VOLUMES 1-3 W/ 2007

1.3 2010 CALIFORNIA ELECTRICAL CODE (CEC), PART 3 TITLE 24 C.C.R.

1.5 2010 CALIFORNIA PLUMBING CODE (CPC), PART 5, TITLE 24 C.C.R

1.6 2010 CALIFORNIA ENERGY CODE (CEC) PART 6.TITLE 24 C.C.R.

1.8 2010 CALIFORNIA FIRE CODE, PART 9, TITLE 24 C.C.R.

1.9 2010 CALIFORNIA EXISTING BUILDING CODE, PART 10, TITLE 24 C.C.R. 1.10 2010 CALIFORNIA REFERENCED STANDARDS, PART 12, TITLE 24 C.C.R

#### REGULATORY CODES

1.1 2010 CALIFORNIA BUILDING STANDARDS ADMINISTRATIVE CODE, PART 1 TITLE 24 C.C.R.

FLUOR.

F.O.

F.O.C.

FOF

FPRF.

F.S.

F.T.

FT.

FTG.

FUT.

FXD.

GALV.

G.B.

GSM.

GWB.

H.B.

HDR.

HDWD.

HDWR.

HORIZ

н м

H.P.

HR.

HT.

H.W.

INSUL.

FURR.

**FLUORESCENT** 

FACE OF CONCRET

FACE OF FINISH

FIRE RESISTIVE

FIRE TREATED

FOOT OR FEET

**FIREPROOF** 

**FULL SIZE** 

FOOTING

**FURRING** 

**FUTURE** 

FIXED

GAUGE

GLASS

GYPSUM

HOSE BIB

HARDWOOD

HARDWARE

**HORIZONTAL** 

HIGH POINT

HOT WATER

INFORMATION

INSULATION

HOUR

HEIGHT

I.D. INSIDE DIAMETER

INT. INTERIOR

**HOLLOW METAL** 

HEADER

GALVANIZED

**GALVANIZED SHEET** 

GYPSUM WALLBOARD

GRAB BAR

FACE OF

NON-RATED

OVER

OVERALL

ON CENTER

OVAL HEAD

OPERABLE

OPENING

OPPOSITE

PROPERTY LINE

PRESSURE TREATED

PAPER TOWEL

DISPENSER

QUANTITY

RISE

RADIUS

REFRIG. REFRIGERATOR

ROOM

ROUND

ROOF DRAIN

REFERENCE

RECESSED

REQUIRED

RETAINING

ROUND HEAD

RESILIENT

OUNCE

PLATE

PLASTER

PLYWOOD

PLUMB. PLUMBING

PLYWD. PLYWOOD

PAIR

POINT

OUTSIDE DIMENSION T.O.C.

NOT TO SCALE

TREAD

T&G

THK.

T.O.P.

T.O.S.

T.O.ST.

T.O.W.

TPD

TS

TYP.

U.B.C.

U.O.N.

V.I.F.

W/

WC

WD

WF

WH

W.O.

W/O

WSCT

WR

WT

THRES.

TEMPERED

THICKNESS

THRESHOLD

TOP OF CURB

TOP OF SLAB

TOP OF STEEL

TOP OF WALL

DISPENSER

TYPICAL

CODE

**TOILET PAPER** 

TUBULAR STEEL

UNIFORM BUILDING

UNLESS OTHERWISE

**UNDERWRITERS** 

VERIFY IN FIELD

WATER CLOSET

WIDE FLANGE

WATER HEATER

WHERE OCCURS

WASTE RECEPTACLE

LABORATORY

**VERTICAL** 

WEST

WITH

WOOD

WITHOUT

WAINSCOT

WEIGHT

TOP OF PAVEMENT

**TONGUE AND GROOVE** 

N.T.S.

O.C.

O.D.

O.H.

OPP

OZ.

OPER.

OPNG.

PLAS.

PLY.

РΤ

PTD

QTY.

RAD.

R.D.

REC

REF.

REQ.

RES.

RET.

R.H.

RND.

CALIFORNIA AMENDMENTS) 1.4 2010 CALIFORNIA MECHANICAL CODE (CMC), PART 4, TITLE 24 C.C.R

1.7 2010 CALIFORNIA ELEVATOR SAFETY CONSTRUCTION CODE PART 7, TITLE 24 C.C.R

1.11 TITLE 19 C.C.R. PUBLIC SAFETY, STATE FIRE MARSHAL REGULATIONS

SIGNED: DATE:	APPROVED	SCALE:	MISSION DOLORES PARK	JOB ORDER NO. 3073V
/ EC 08/2013 AWN: DATE:	SECTION MANAGER DATE:	AS NOTED	REHABILITATION PROJECT	DRAWING NO. A0.0_M
/ EC 08/2013 ECKED: DATE:	DEPUTY BUREAU MANAGERDATE:	SHEET OF SHEETS	OPERATIONS & MAINTENANCE BUILDING	FILE NO.
 TORED. DATE.	BUREAU MANAGER DATE:	OF	ABBREVIATIONS, GENERAL NOTES, AND LEGEND	REV. NO.

**CASEWORK** 

**DESIGNATION** 

COLUMN LINES

**ELEVATION** 

SECTION

-drawing number on sheet

INTERIOR ELEVATION

—drawing number on sheet

drawing number on sheet

DETAIL REFERENCE

drawing number on sheet

MATCH LINE

DIMENSION OR

-ROOM NUMBER

DOOR NUMBER

PARTITION TYPE

—partition number

REFERENCE

—interior elevation reference

—multiple door designation

–special treatment indication

REVISION DESIGNATION

SPOT ELEVATION IN FEET

G = GRADE, I = INVERT

KEYNOTE REFERENCE

**CEILING HEIGHT** 

Above Finish Floor

-Keynote Number.

–corresponds to room #

WINDOW SCHEDULE

WORK POINT

–sheet on which elevation occ

—sheet on which section occurs

—sheet on which section occurs

–sheet on which elevation occur

/ A.1 <sup>'</sup>


**ROOM NAME** 

201

X/A4.X

**(7'-6")** 

4/26/13	60% DELIVERABLE 4.26.13			REFERENCE INFORMATION
6/21/13	90% SET 6.21.13			& FILE NO. OF SURVEYS
6/21/13	PERMIT SET 6.21.13			
8/02/13	100% COORDINATION SET 8.02.13			
DATE	DESCRIPTION	BY	APP.	
	TABLE OF REVISIONS			
	6/21/13 6/21/13 8/02/13	6/21/13 90% SET 6.21.13 6/21/13 PERMIT SET 6.21.13 8/02/13 100% COORDINATION SET 8.02.13 DATE DESCRIPTION	6/21/13 90% SET 6.21.13 6/21/13 PERMIT SET 6.21.13 8/02/13 100% COORDINATION SET 8.02.13  DATE DESCRIPTION BY	6/21/13 90% SET 6.21.13 6/21/13 PERMIT SET 6.21.13 8/02/13 100% COORDINATION SET 8.02.13  DATE DESCRIPTION BY APP.

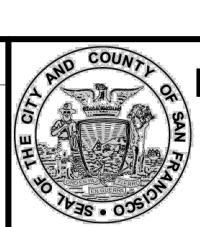

**Building Design & Construction DEPARTMENT OF PUBLIC WORKS** CITY AND COUNTY OF SAN FRANCISCO

**MEMOS** KEYNOTE INDEX SHEET INDEX 3.04 CONC. MAT SLAB. S.S.D. SheetNo Sheet Name BLACK ACOUSTIC BATT ABBREVIATIONS, GENERAL NOTES, LEGEND A0.0 M A0.1\_M MEMOS, KEYNOTES, SHEET INDEX HAMILTON **HAMILTON** FIBER-REINFORCED PANEL 3.11 CONC. SLAB S.S.D. A0.2\_M CODE ANALYSIS A2.1 M FLOOR PLAN & FINISH SCHEDULE *MEMORANDUM* MEMORANDUM ♣ AITKEN + AITKEN A2.2\_M **ROOF PLAN** 3.12 CONC. TOPPING SLAB 9.12 RESILIENT BASE A3.1 M **BUILDING ELEVATIONS & SECTIONS** ARCHITECTS 525 Brannan Street Suite 400 • San Francisco, California 94107 • www.hamiltonaitken.com • Fax 974, 5033 • 415, 974, 5030 525 Brannan Street Suite 400 • San Francisco, California 94107 • www.hamiltonaitken.com • Fax 974, 5033 • 415, 974, 5030 ARCHITECTS A3.2 M BUILDING SECTIONS A3.3\_M BUILDING SECTIONS Susan G. Aitken AIA - C17466 Chad Hamilton AIA - C15932 3.14 CONC. BRIDGE TO BASKETBALL COURT. S. SOUND ABSORBING UNITS A3.4 M WALL SECTIONS S.D & S.L.D. **Dolores Park Renovation** 2011,061 HA No: 2011.061 A3.5 M WALL SECTIONS HA No: **Dolores Park Renovation** San Francisco, CA Date: 26 February 2013 San Francisco, CA Date: 22 April 2013 A4.1\_M STAIR DETAILS Chron No.: Chron No.: 4092 3.15 COVERED STORAGE S.S.D. WORKBENCH SHELVING A4.2\_M ENLARGED PLAN AND DETAILS To: Plan Review Manager, Dept of Building Inspection DSA\_DBI No.: Department of Building Inspection DSA\_DBI No.: A5.1 M INTERIOR ELEVATIONS 1660 Mission Street, 2nd floor 1660 Mission Street A5.2\_M INTERIOR ELEVATIONS Telephone: (415) 558 6088 San Francisco, CA 94103 CA 94103 Telephone: San Francisco 3.16 CONSTRUCTION JOINT FIRE EXTINGUISHER FAX: FAX: (415) 558 6261 A5.3\_M INTERIOR ELEVATIONS A6.1 M REFLECTED CEILING PLAN Mr. Jeffrey Ma Attention: Jeffery Ma, PE Attention: A7.1\_M CONSTRUCTION ASSEMBLIES Mission Dolores Park: DBI pre- application meeting scheduled for 2/27/13 Mission Dolores DBI Preapplication meeting 2/27/13 3.17 CONTRACTION JOINT S.S.D. WHITE BOARD 10.08 A7.2\_M CONCRETE DETAILS 1) Our primary interest is in reviewing the code assumptions for the below grade Operation and Attendees: See attached sign-in and Pre-application letter dated 2/26/13 A7.3 M WATER PROOFING DETAILS Maintenance building located along 18th street below the basket ball court. Our proposal is that this O&M use is similar to that of a barn or agricultural structure which supports all the service functions A8.1\_M SCHEDULES -1.1 Question 1 Re: Operations & Maintenance Building - Jeff Ma, DBI, made the of the park. We have designated it occupancy group U. The center portion of the building WORK BENCH W/ UPPERS 3.18 RETAINING WALL S.S.D. following clarifications to the questions and code assumptions: A8.2\_M INTERIOR DOOR DETAILS approximately 1500 sf is less than the 3000 sf max for private garages and there is no fue EXTERIOR DOOR/ WINDOW DETAILS dispensing proposed. The primary function of this center portion is housing and charging of service A8.3 M Indicate on the final plans that all covered areas including the dumpster and vehicles used in the park (not street legal vehicles). This service equipment includes both gas and A8.4\_M GATE DETAILS materials bays are included in the building area count. Clarify the portions of the electric vehicles (Toros) and ridding mowers as well as a full complement of power trimmers and 3.19 36" CONC. WALL WAINSCOT 10.16 LOCKERS maintenance tools. The balance of the spaces are maintenance and custodian storage spaces and yard that are open to the sky. A9.1 M LIGHT METAL FRAMING DETAILS The sum of the area of the B Occupancies (office and training room) must be less an accessory office and training room. The U type VB base allowable area of 5100 ŠF is not A9.2 M LIGHT MATEL FRAMING DETAILS exceeded and fire sprinklers are not required. Please confirm you concur with the code than or equal to 10% of the total building (story) area to be considered accessory A9.3\_M CEILING DETAILS area to Occupancy Group U. The allowable area for U Occupancy, VB construction is 5500 sf (not 5100 sf). **BENCH** 3.20 CONC. CURB A9.4 M FIRESTOP PENETRATION DETAILS 2) The Toro vehicle ramp and the second exit stair are proposed to occupy the same enclosure. The building conforms to a mixed-occupancy U with B as an accessory use. The 1HR fire barrier is at the grid line E separating the garage use from the exit enclosure. Please A10.1 M RESTROOM DETAILS confirm you concur no additional rated separation is required between stair and ramp. A10.2\_M RESTROOM ACCESSORIES DETAILS 1.2 Lt. Micki Jones made the following clarifications: 5.10 GUARDRAIL S.L.D. **HEAVY DUTY SHELVING** 3) The O&M building will be mechanically ventilated and is assumed this space shall require a A10.3\_M SIGNAGE & ACCESSIBLE DETAILS monitor for vehicle emissions within the building Service Area OM-0 room. Shall this monitor control CASEWORK DETAILS A10.4 M The San Francisco Fire Department (SFFD) determined the O&M building to be exhaust fan and/or provide local alarm? acceptable as a U occupancy meeting AB 5.12. 4) For the restroom structures occupancy use U is proposed. We understand a previously approved Per AB 5.12, fire sprinklers will not be required; all areas of the building are within DUMPSTER (N.I.C.) 5.11 PIPE HANDRAIL DPW stand alone public restrooms has been approved as occupancy use B. The largest restroom in 150LF access to the fire apparatus. our project is less then 3000 SF, either use would suffice. Please confirm you concur with the The drawings to indicate the length of SFFD apparatus access. proposed U use designation. 7.12 BLIND-SIDE WATERPROOFING TORO PATH & EGRESS STAIR TUNNEL 5) The South Restroom located adjacent to the Playground is proposed to be built into the grade and therefore the roof will be subject to vandalism. The roof exhaust / venting is proposed to Question 2 Re: Operations & Maintenance Building - Ramp & Stair covered with a mesh grating enclosure to protect it from damage and it is 3ft from window openings There is no requirement to have a rated separation between the interior ramp and and we believe this complies with the plumbing and mechanical code. Please advise if you concur. the interior stair. One open stair is permitted when there are 2 exits from the WATER HEATER 7.13 DRAINAGE PANEL 22.04 6) Vandalism is a common issue at this park. In the stand along restroom buildings no fire alarm There is a requirement, due to the elevation change greater than 30 inches, to devices nor fire sprinklers are proposed. Please confirm you concur this is acceptable at this have a guardrail between ramp and stair. FOUNDATION DRAIN, TYP. 7.14 CLASS II DRAINAGE ROCK 22.05 Question 3 Re: Operations & Maintenance Building - Mechanical Ventilation By: Thommas Lawrence Mechanical ventilation is required for area over 1000 sf or more than 5 vehicles. 7.15 TERMINATION CAP TRENCH DRAIN W/ COVER This ventilation must run continuously with a capacity of 0.75CFM. This meets the cc: <jacob.gilchrist@sfgov.org> Mandy.Lei@SFgov.gov <lizzy.hirsch@sfdpw.org>; requirements of an S Occupancy. A CO2 sensor/alarm is optional, but not required. It may <u>not</u> be used to control fan operation in lieu of continuous ventilation. 22.08 AREA DRAIN 7.16 REGLET No back-up power is required unless smoke evacuation is required. Minimum separation between grade and exhaust termination shall be maintained. Indicate the source and capacity of make-up air on the final plans. v10.0 Copyright Hamilton Aitken Architects all rights reserved Project Dashboard 22.09 EYE WASH 7.17 SHEET METAL FLASHING Question 4 Re: Restroom Occupancy Classification 22.10 MOP SINK 8.02 DOUBLE DOORS Stand alone restrooms conform to the Cocupancy U. Question 6 Re: Restroom Mechanical 8.03 ALUMINUM ENTRANCE DOOR & SIDELIGHT 23.02 MECHANICAL DUCT, S.M.D. The 3 ft separation of intake and exhaust complies with code. The mechanical ventilation can be controlled by an occupancy sensor. 23.03 AIR SUPPLY UNIT, S.M.D. 8.04 SECTIONAL, OVERHEAD DOOR Question 6 Re: Restroom Fire Alarm Neither fire alarm devices nor sprinklers are regulter by code. 26.00 ELECTRICAL SWITCHBOARD ON 6" CONC. PAD. S.E.D. 8.06 FIXED WINDOW The restroom buildings on site are stand alone U Occupancy building in excess of 150 If from the street and property line, per SFFD they will not be required to have 8.07 MECHANICAL LOUVER a fire alarm nor fire sprinkler system. [ 26.04 ] CHARGING STATION Additional Observations Any required exita within the O&M courtyard are to be protected with bollards or [ 26.05 ] COURT LIGHT, TYP. S.E.D. 8.08 VEHICLE GATE W/ PERSONNEL LEAF yellow striping bidinating "No Parking" to protect exit ways from being blocked by vehicles. SFBC -13C b. The occupancies need to meet the Gel-Green requirements. 26.06 ELECTRICAL BACKBOARD 8.09 OPERABLE WINDOW Mission Dolores DBI Preapplication meeting 2/27/13 8.12 HOLLOW METAL DOOR FRAME, TYP. 26.07 SURFACE MTD. LIGHT FIXTURE S.E.D. 9.01 TILE 32.02 PLANTER. S.L.D. [ 32.03 ] PLANTING WELL IN PAVING 9.03 GYPSUM WALL BOARD, TYP. U.O.N. By: Thomas Lawrence AIA ( 32.04 CHAIN LINK FENCE S.L.D. 9.07 METAL STUD SUPPORT 9.08 ACOUSTIC CEILING EDGE 32.07 GRADE VARIES S.L.D. FILE NO. OF SURVEYS **Building Design & Construction** 

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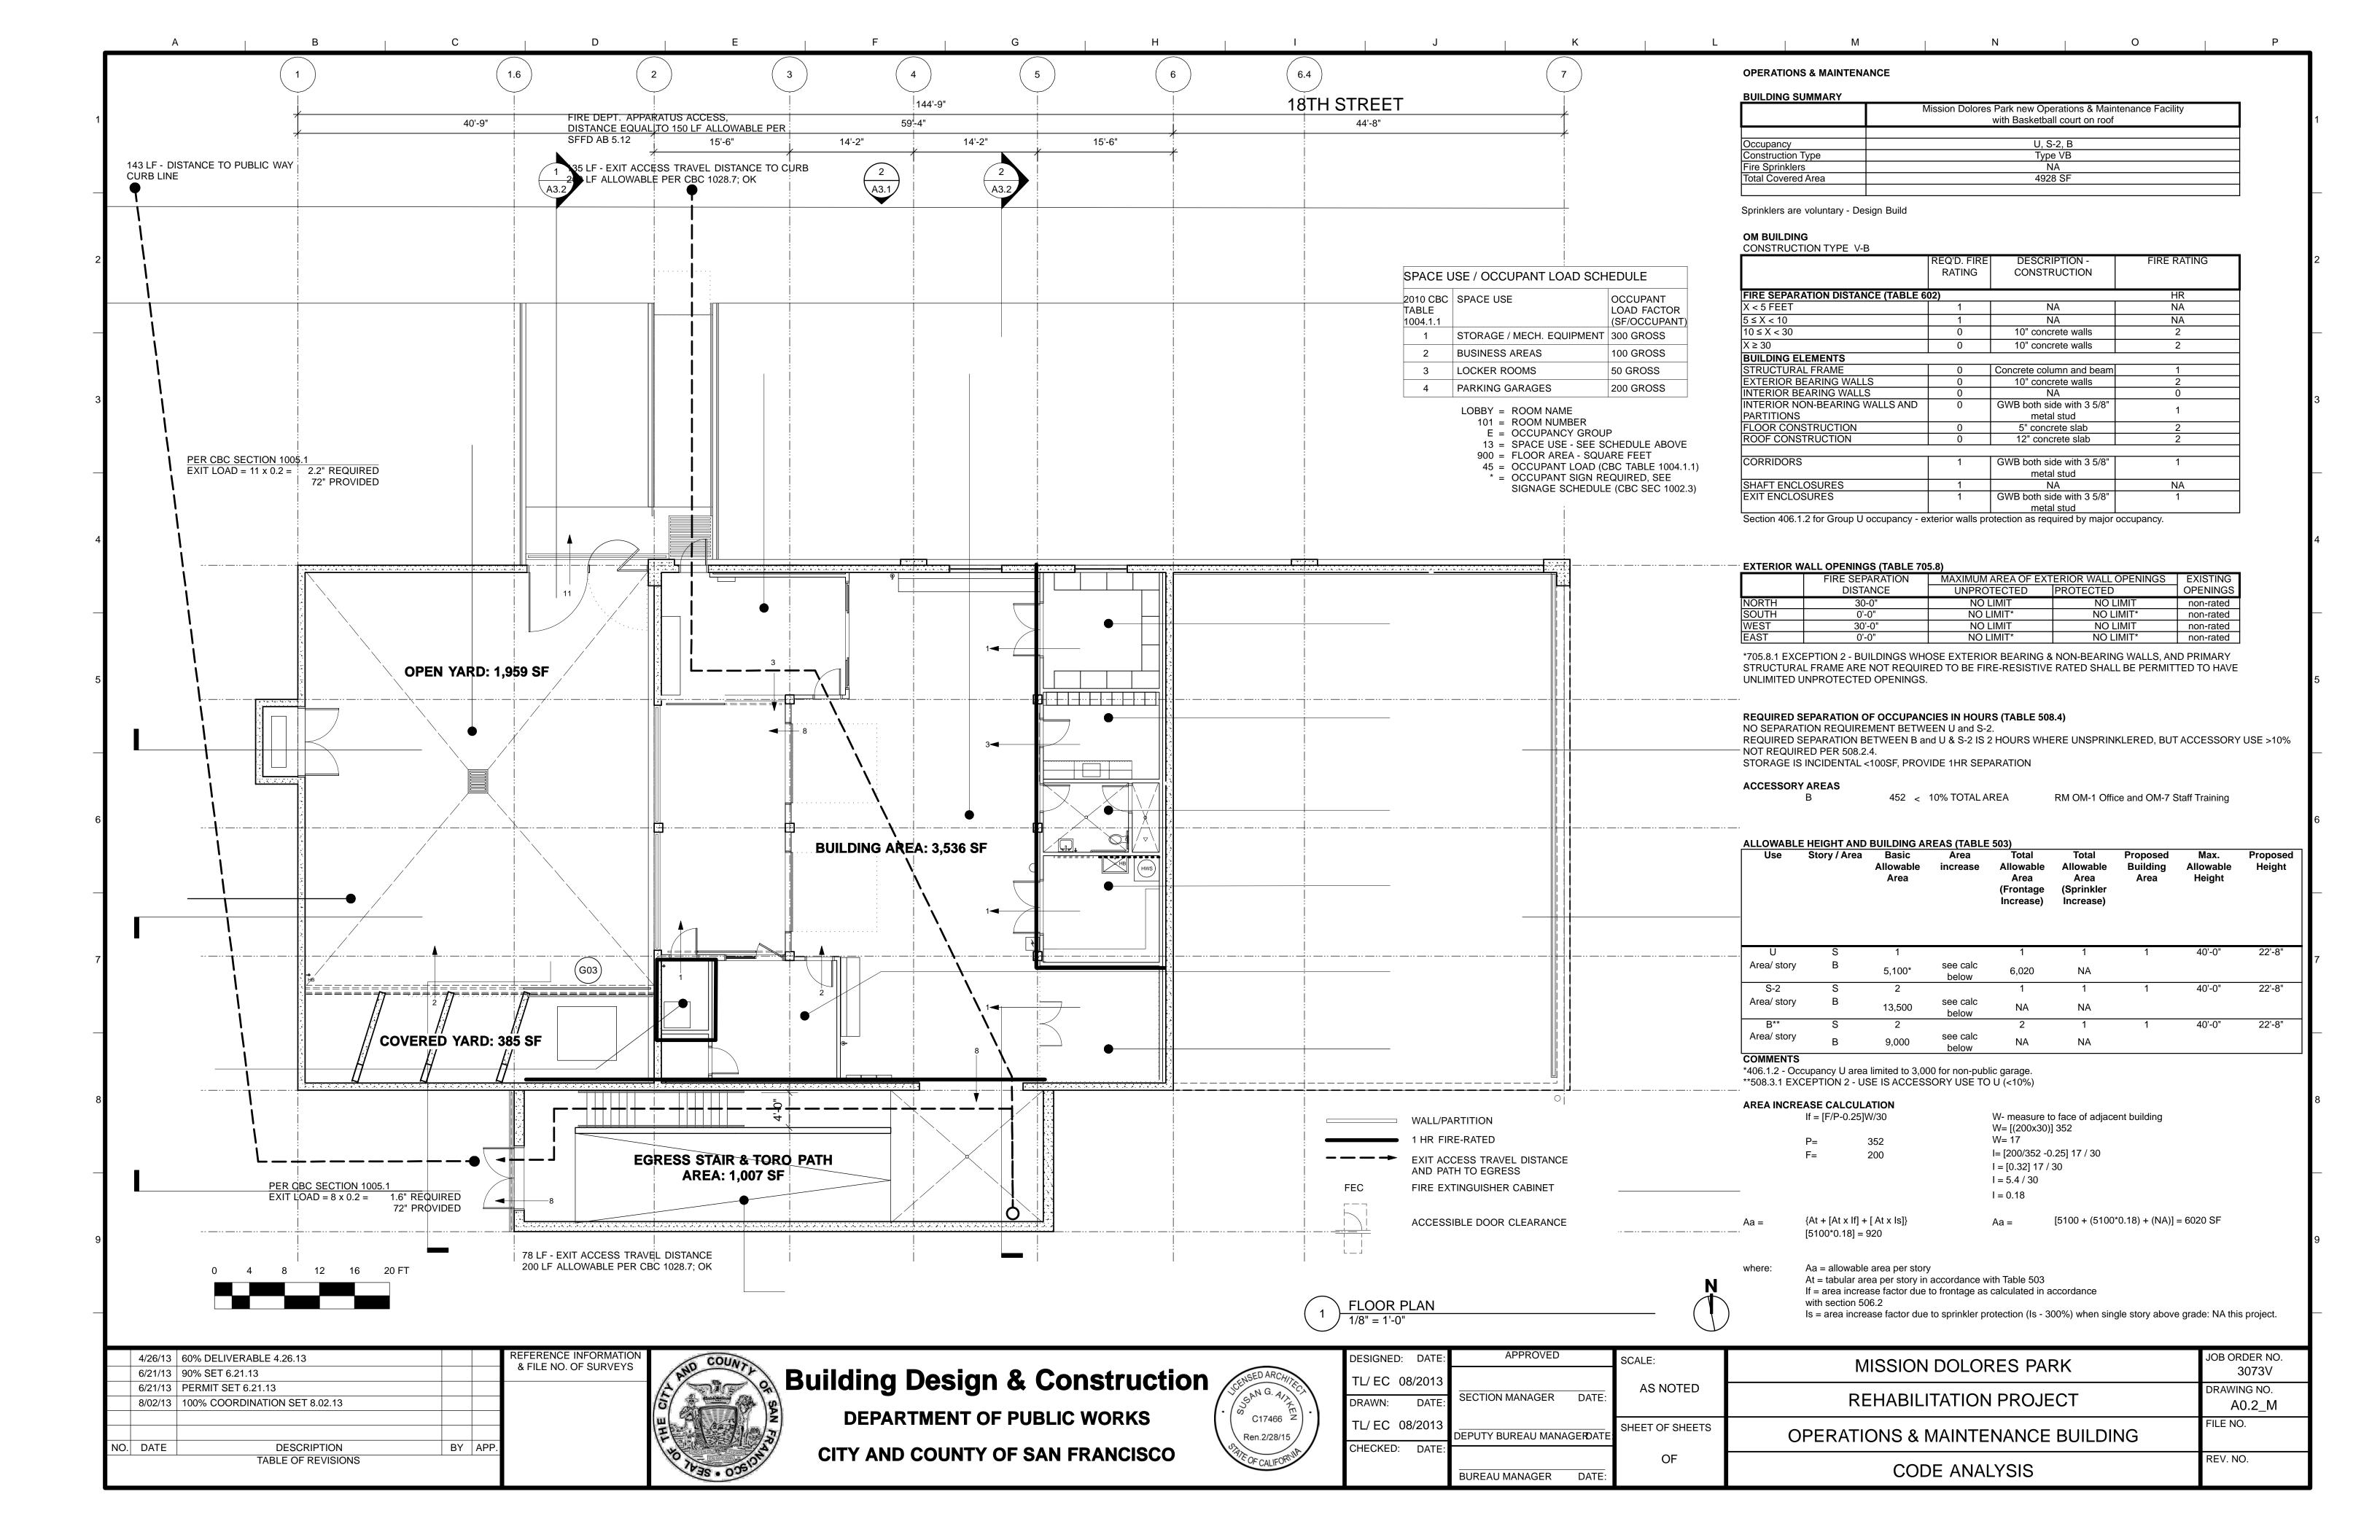
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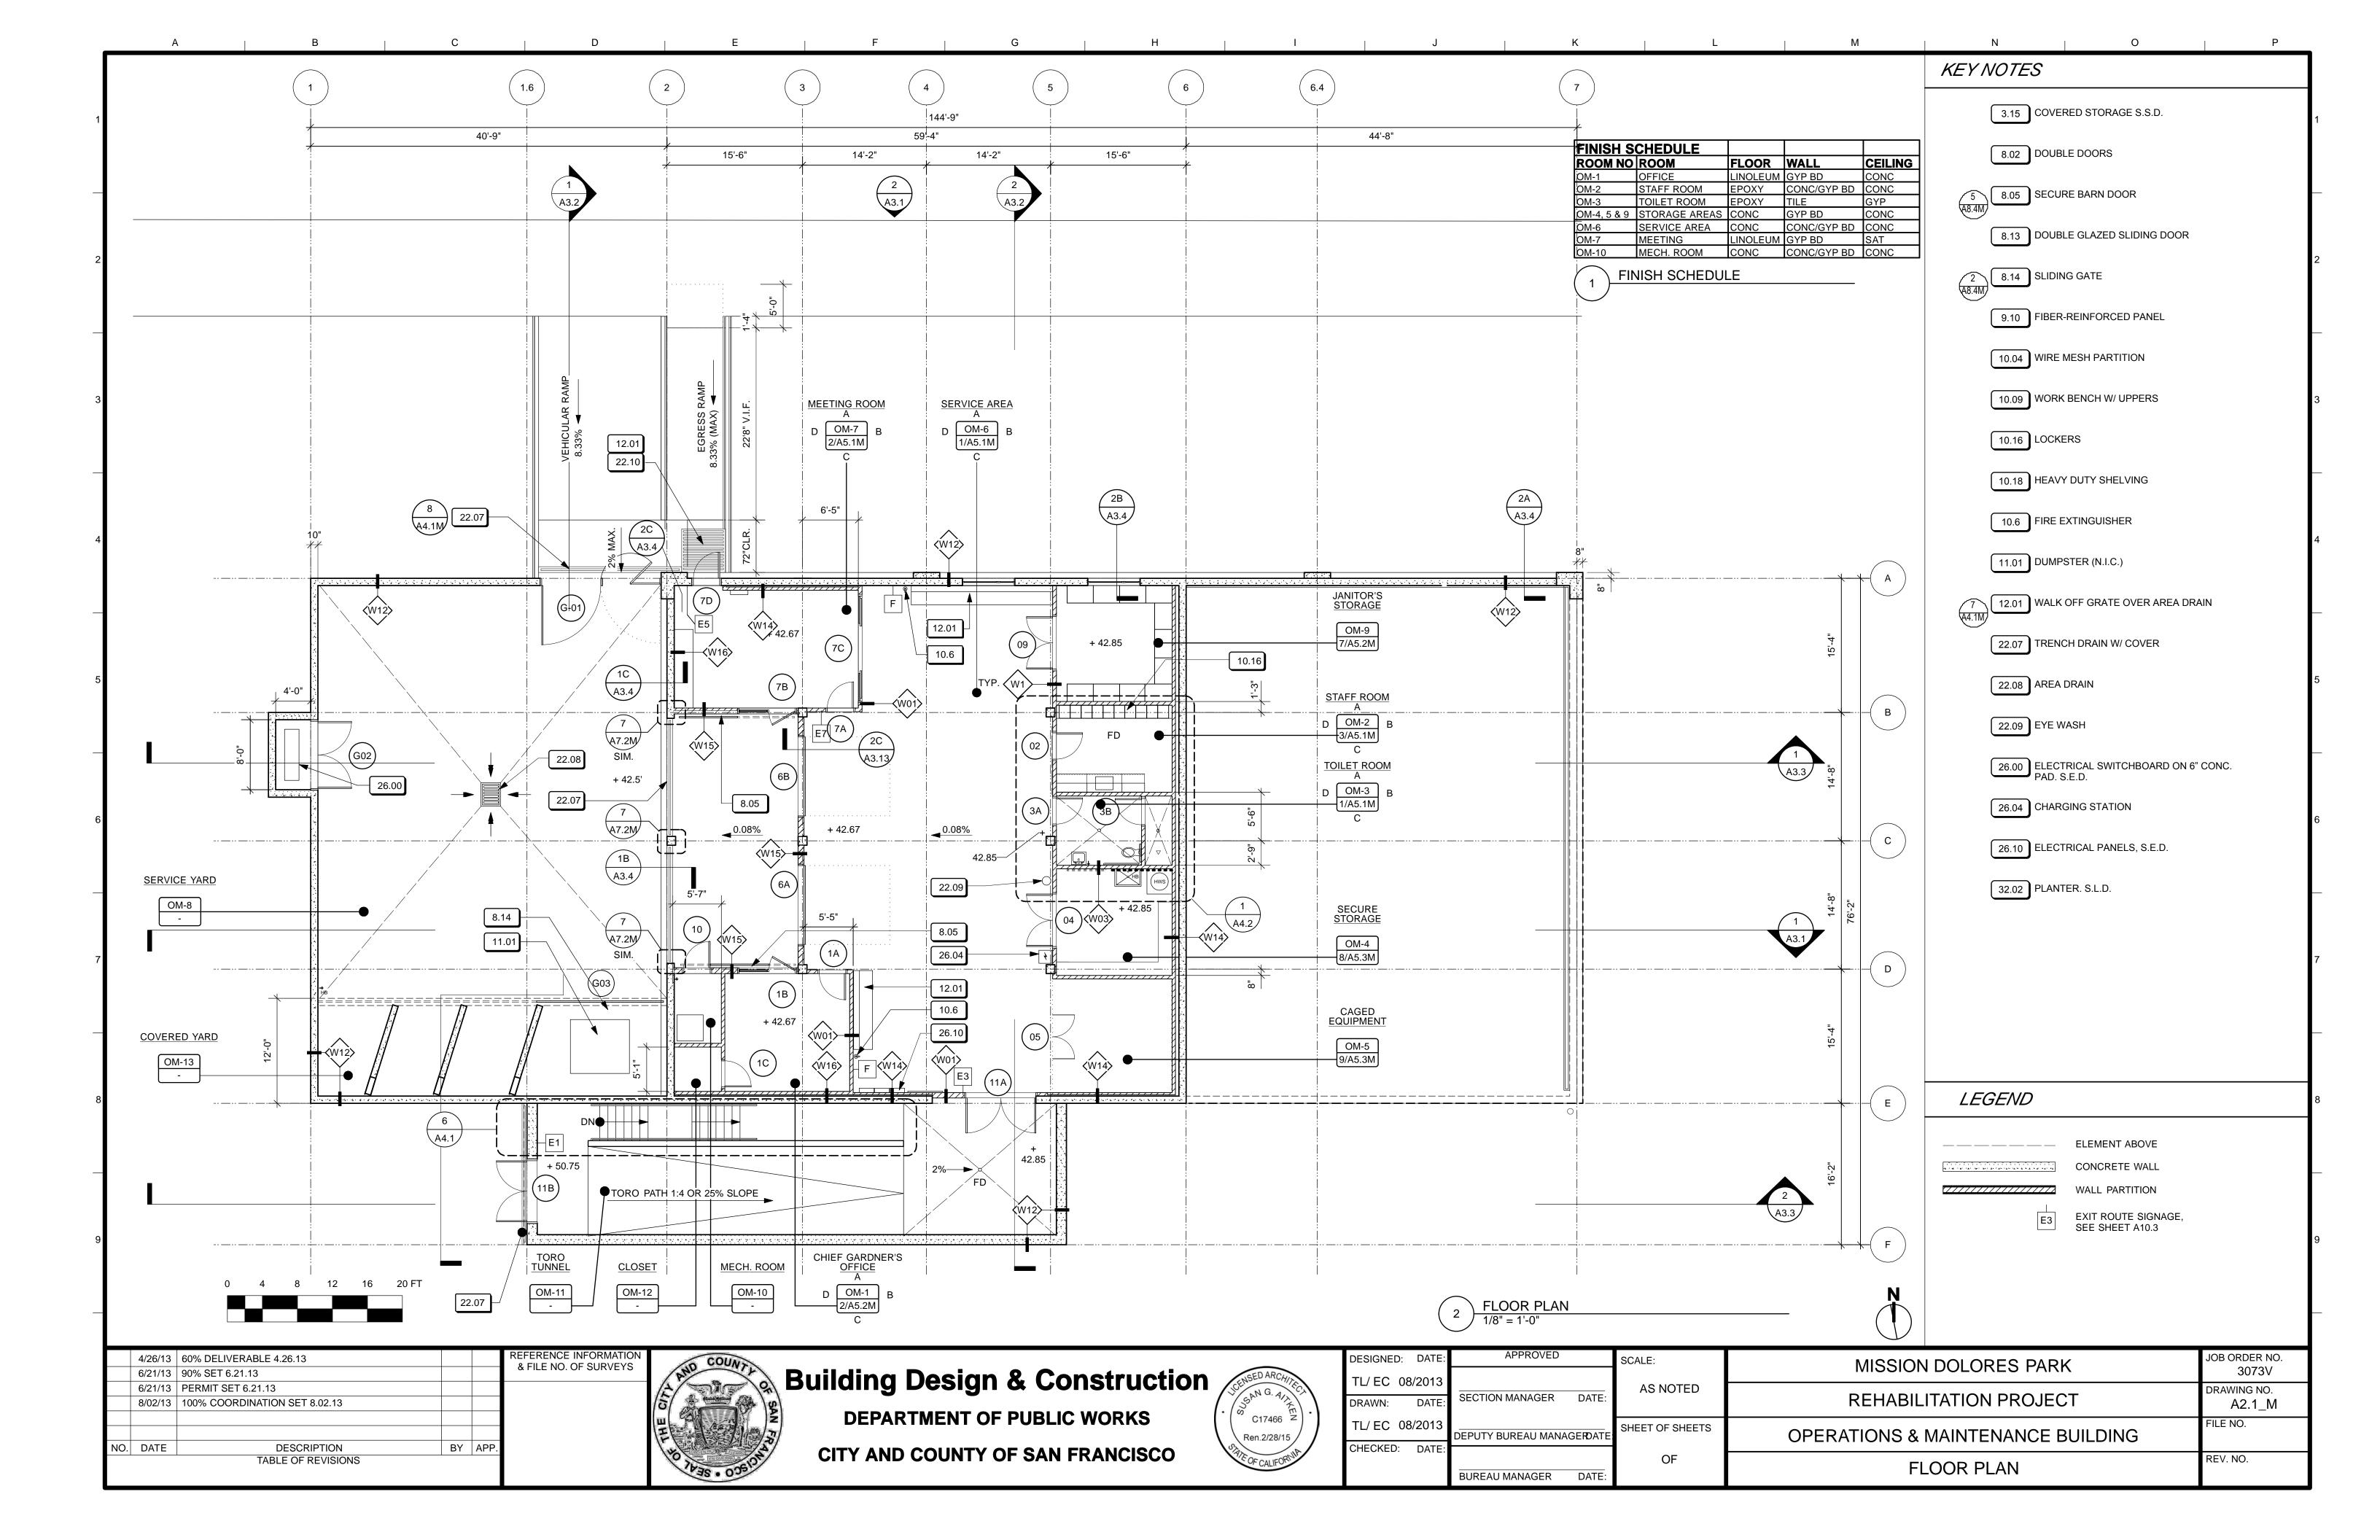
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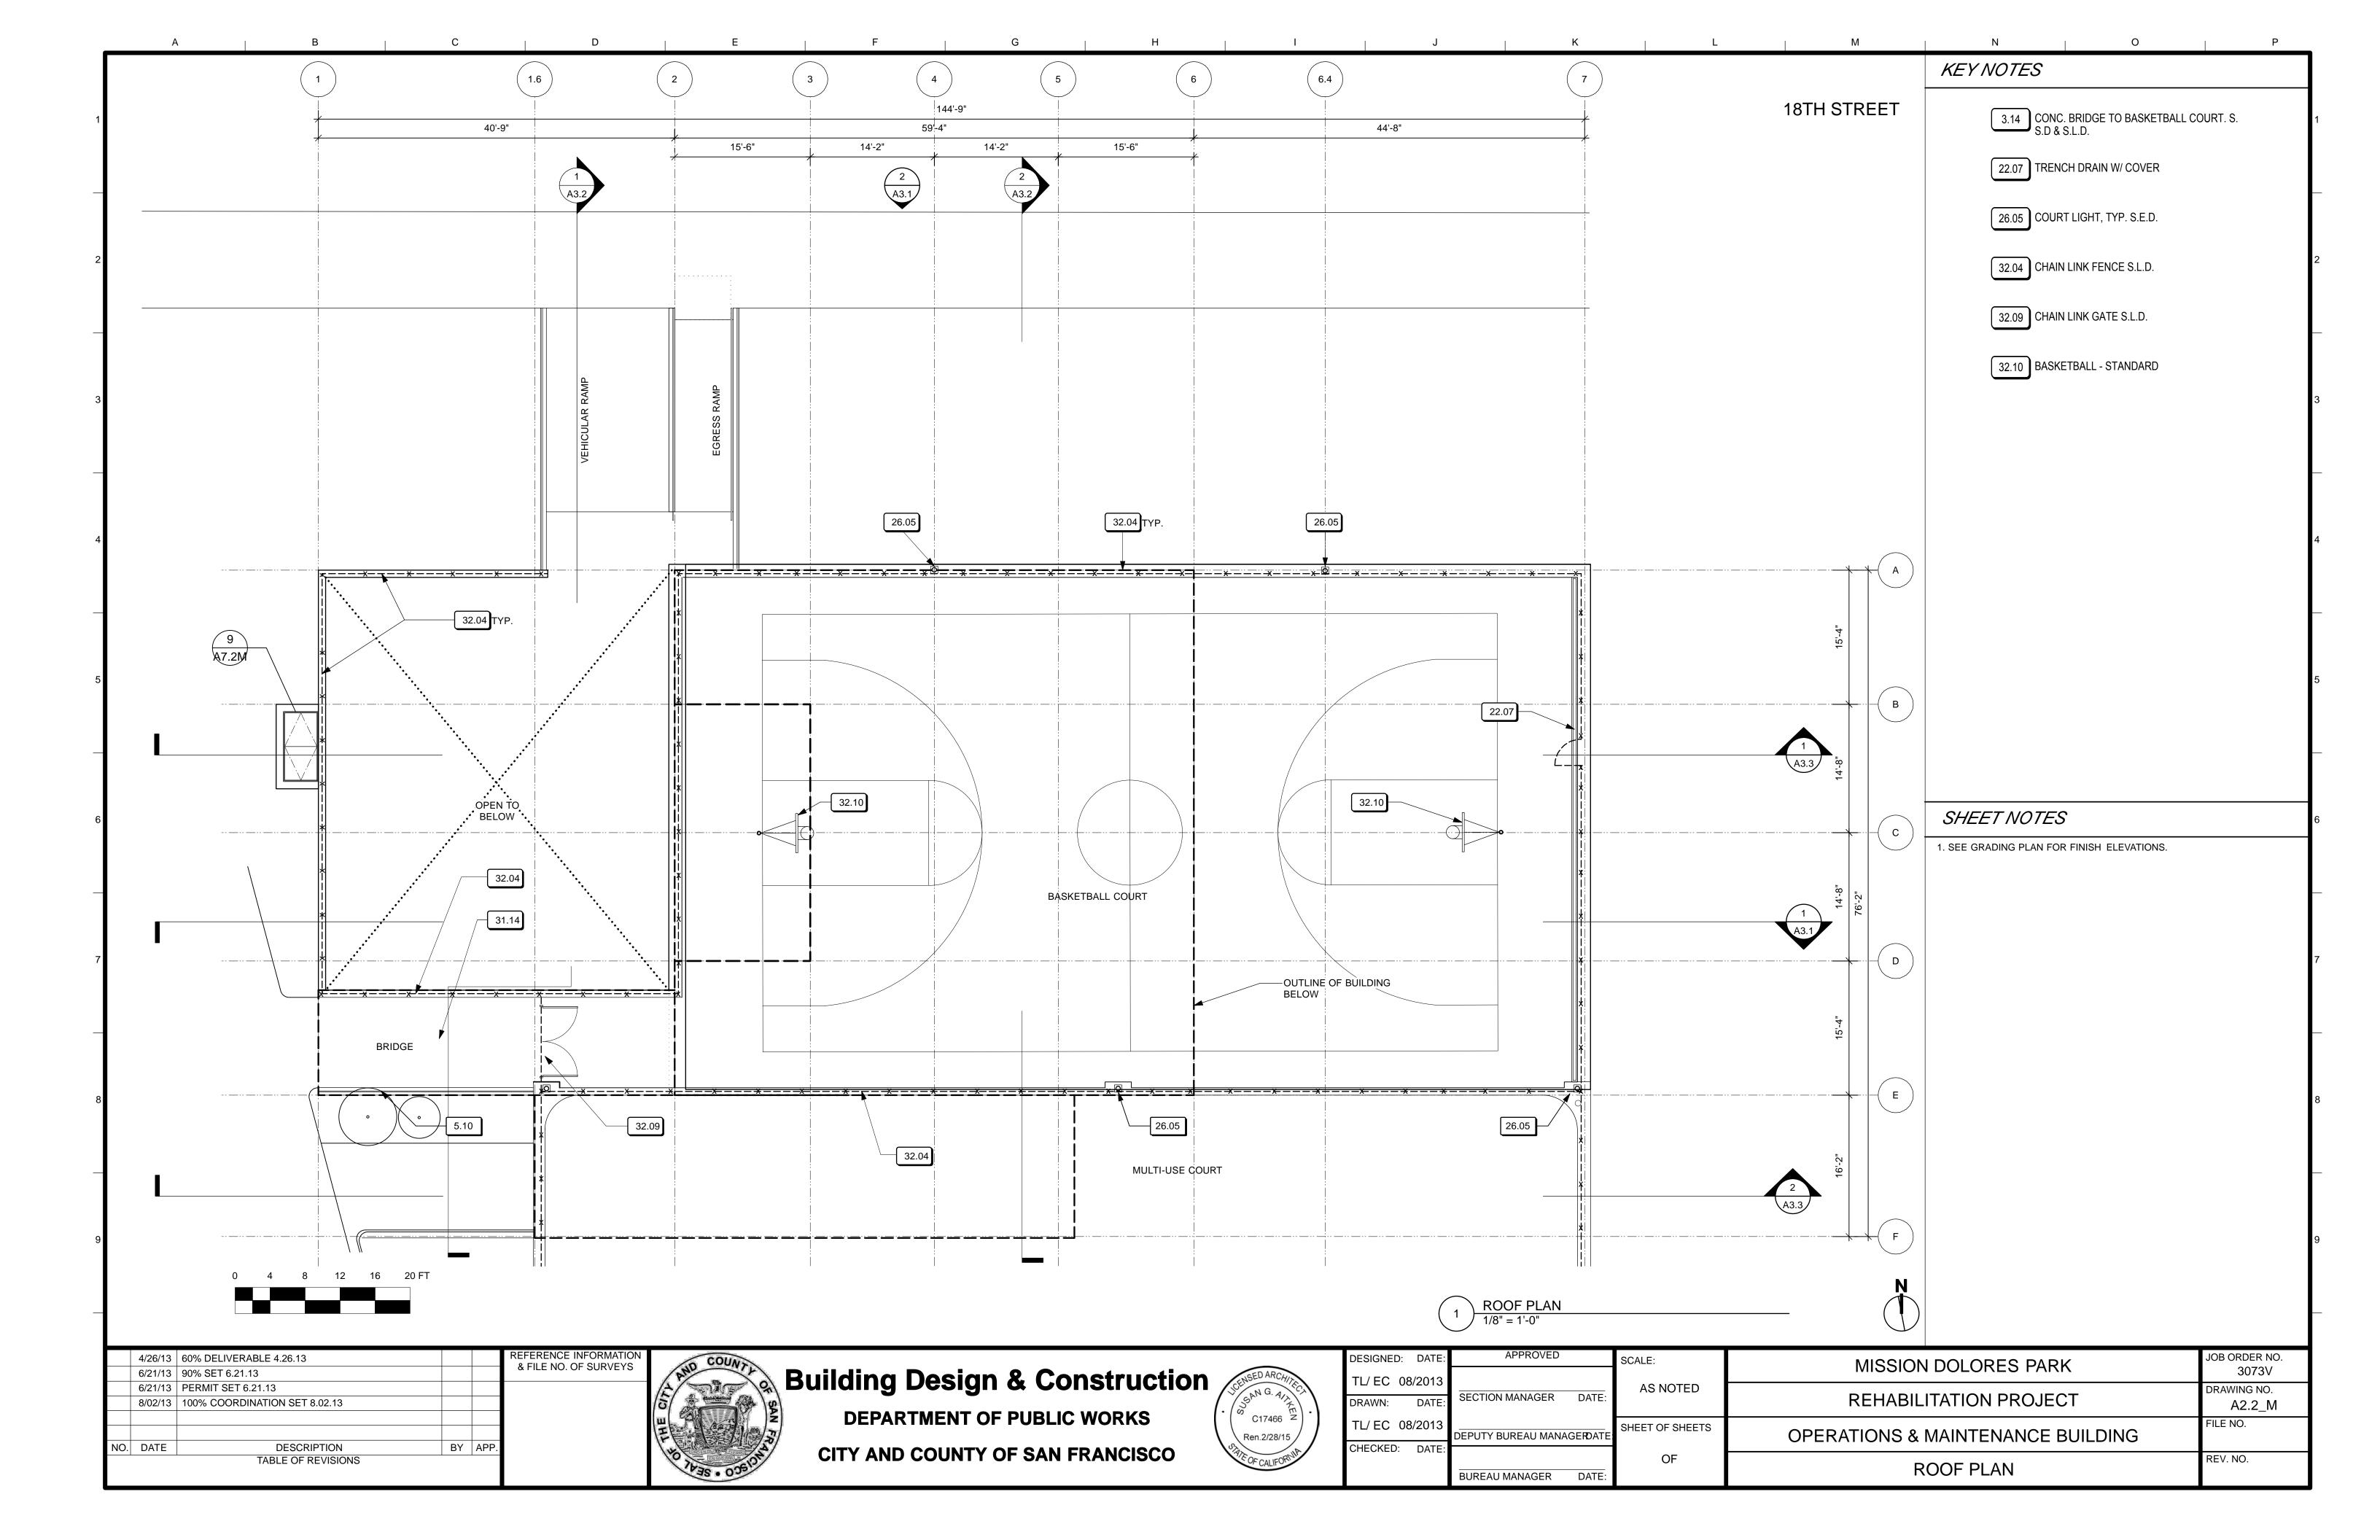
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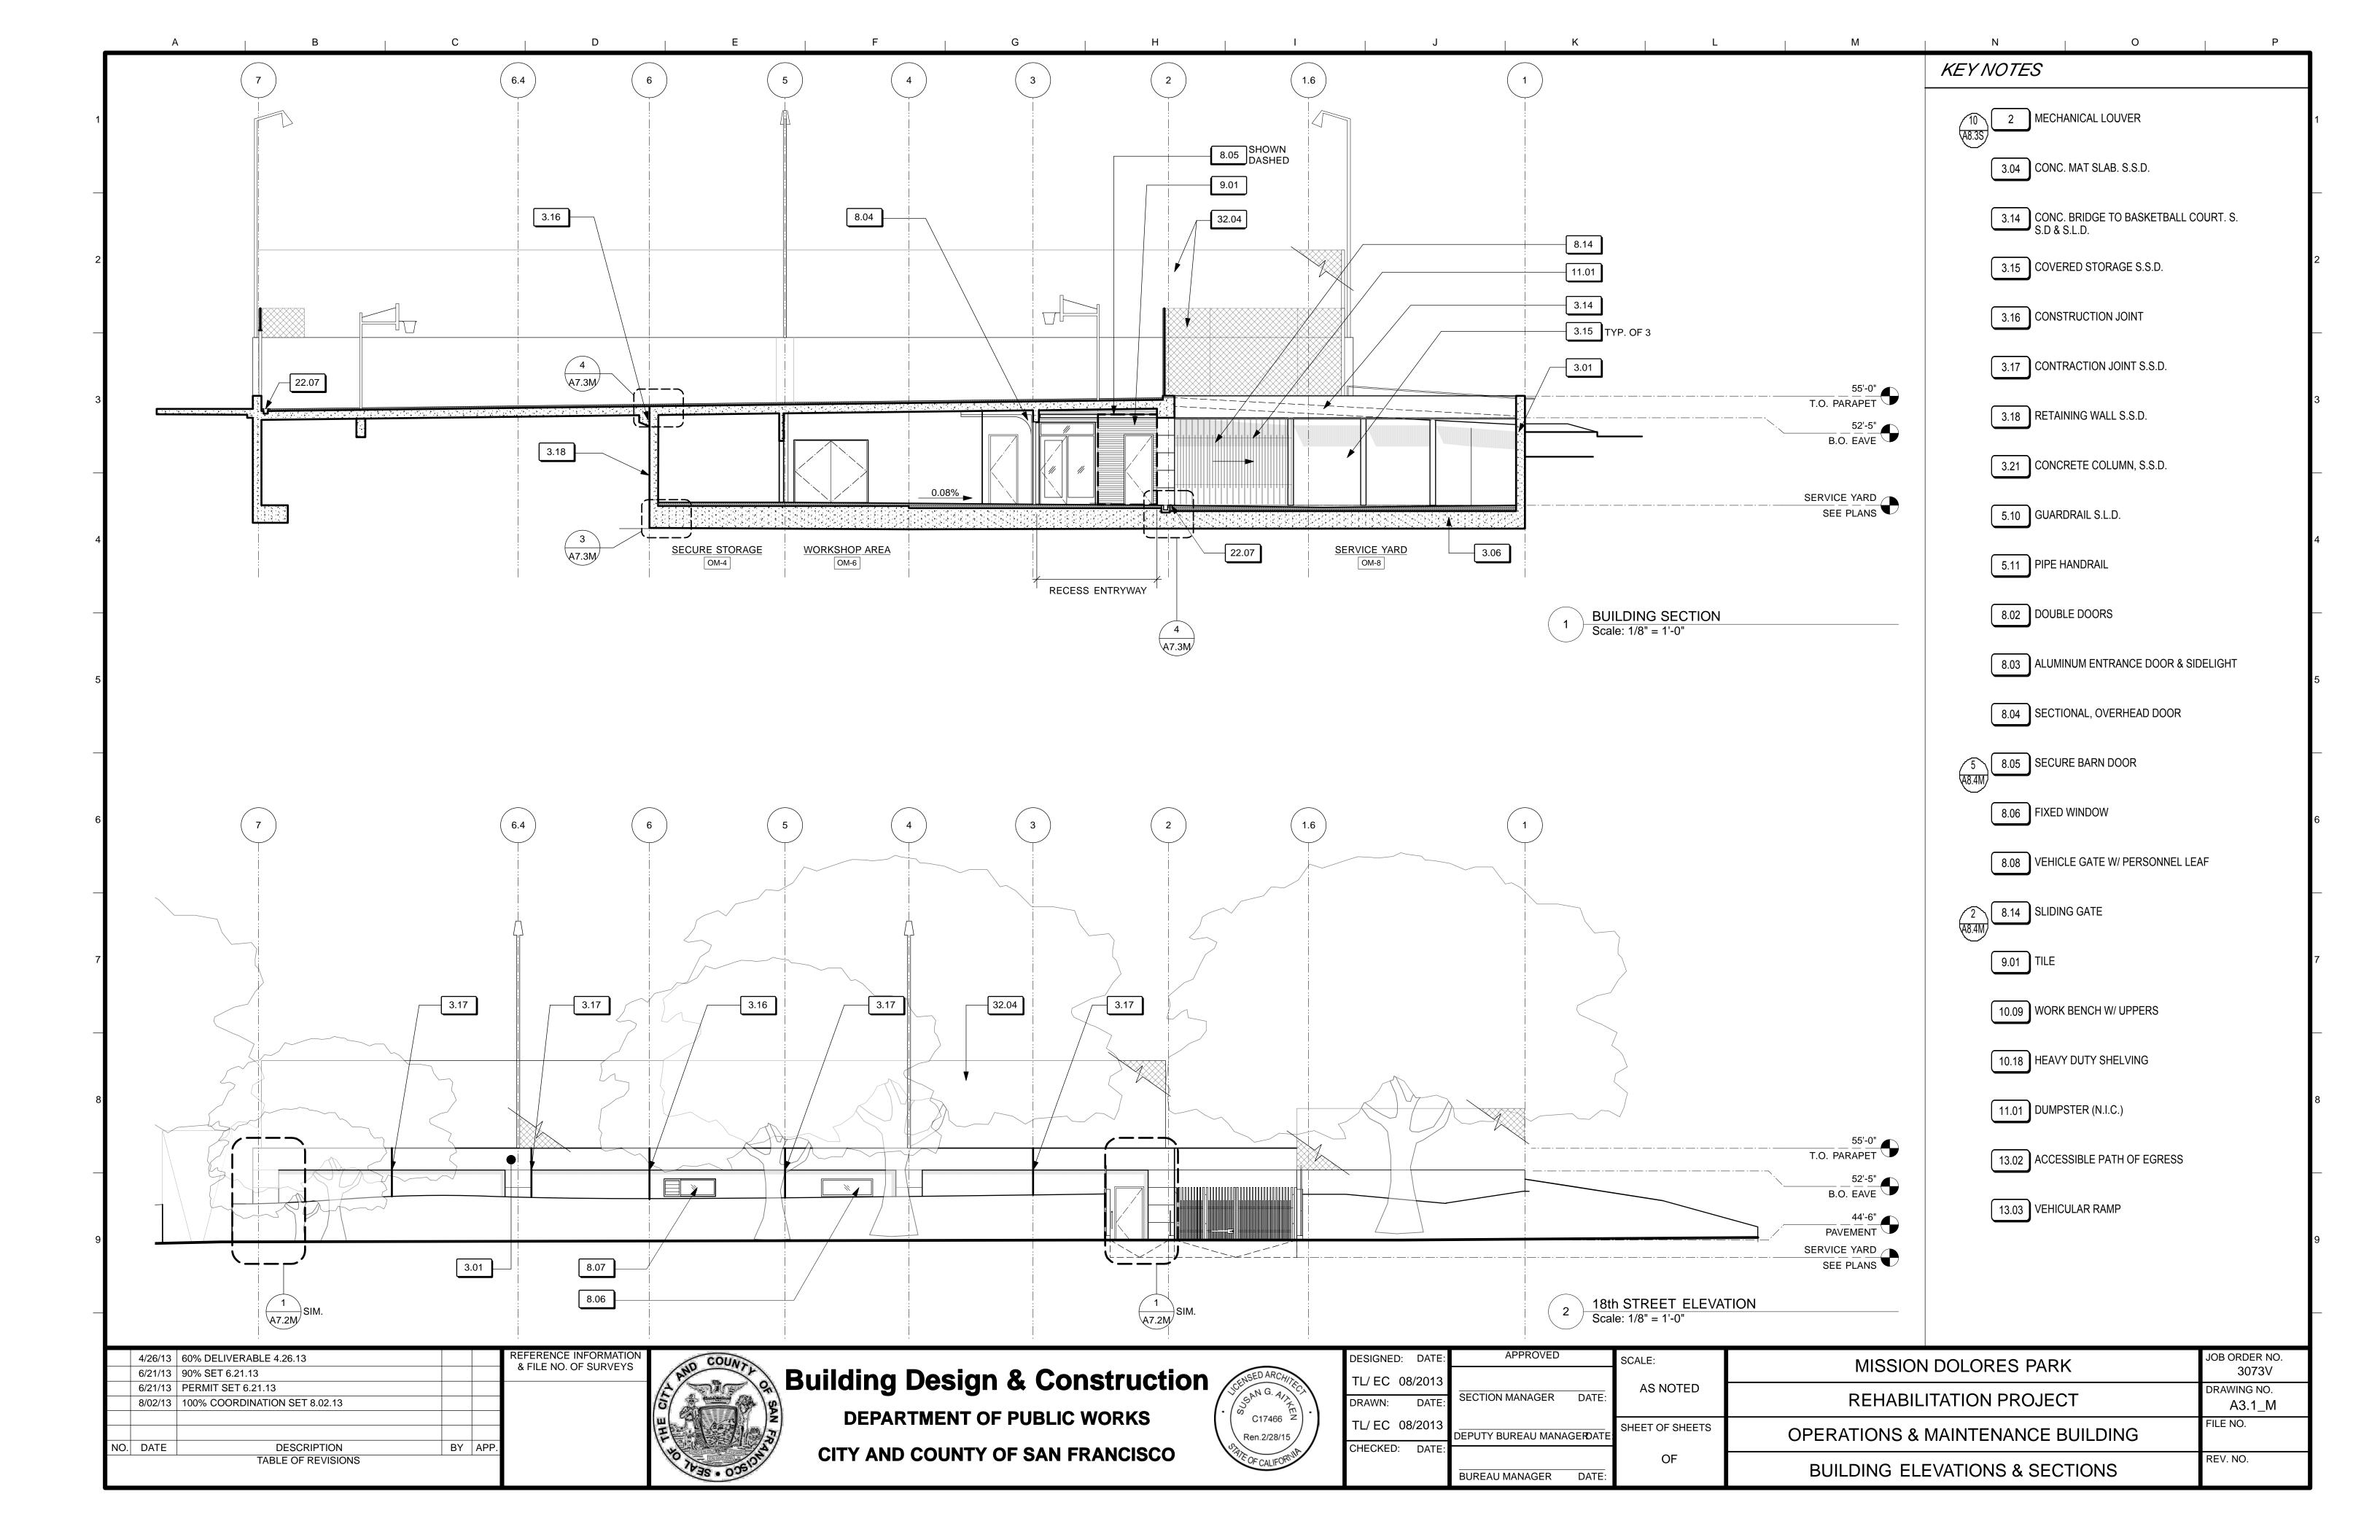
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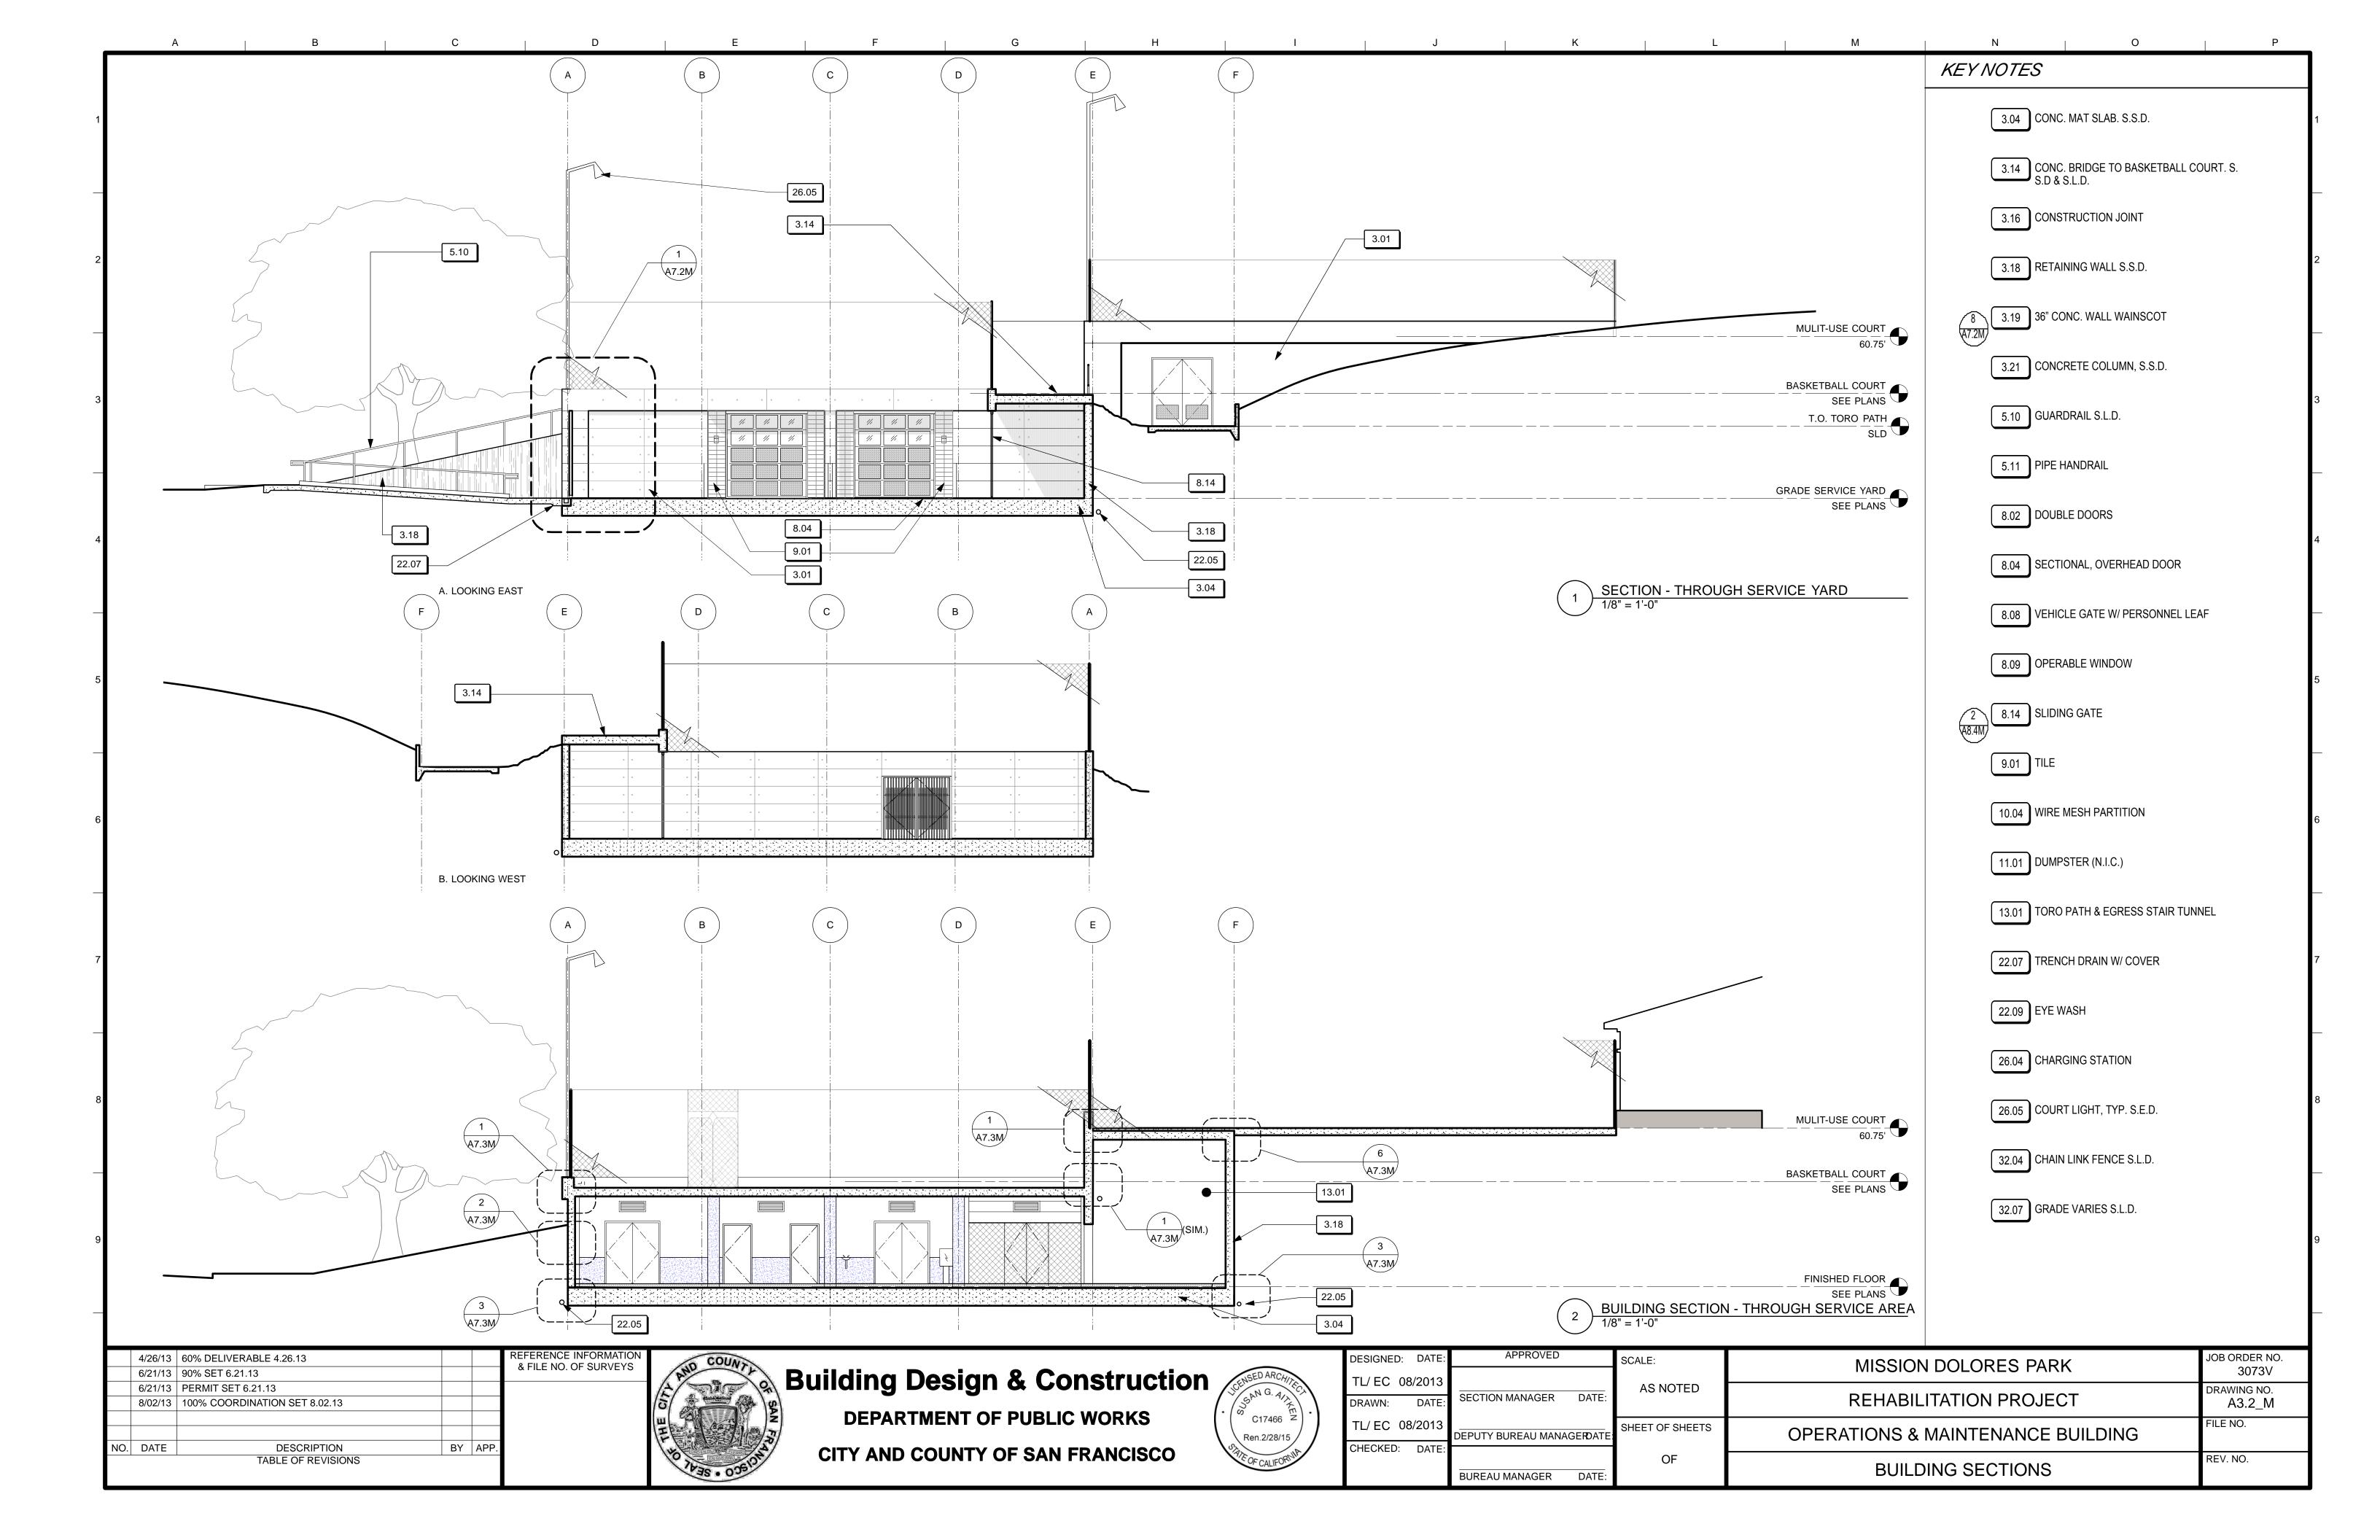
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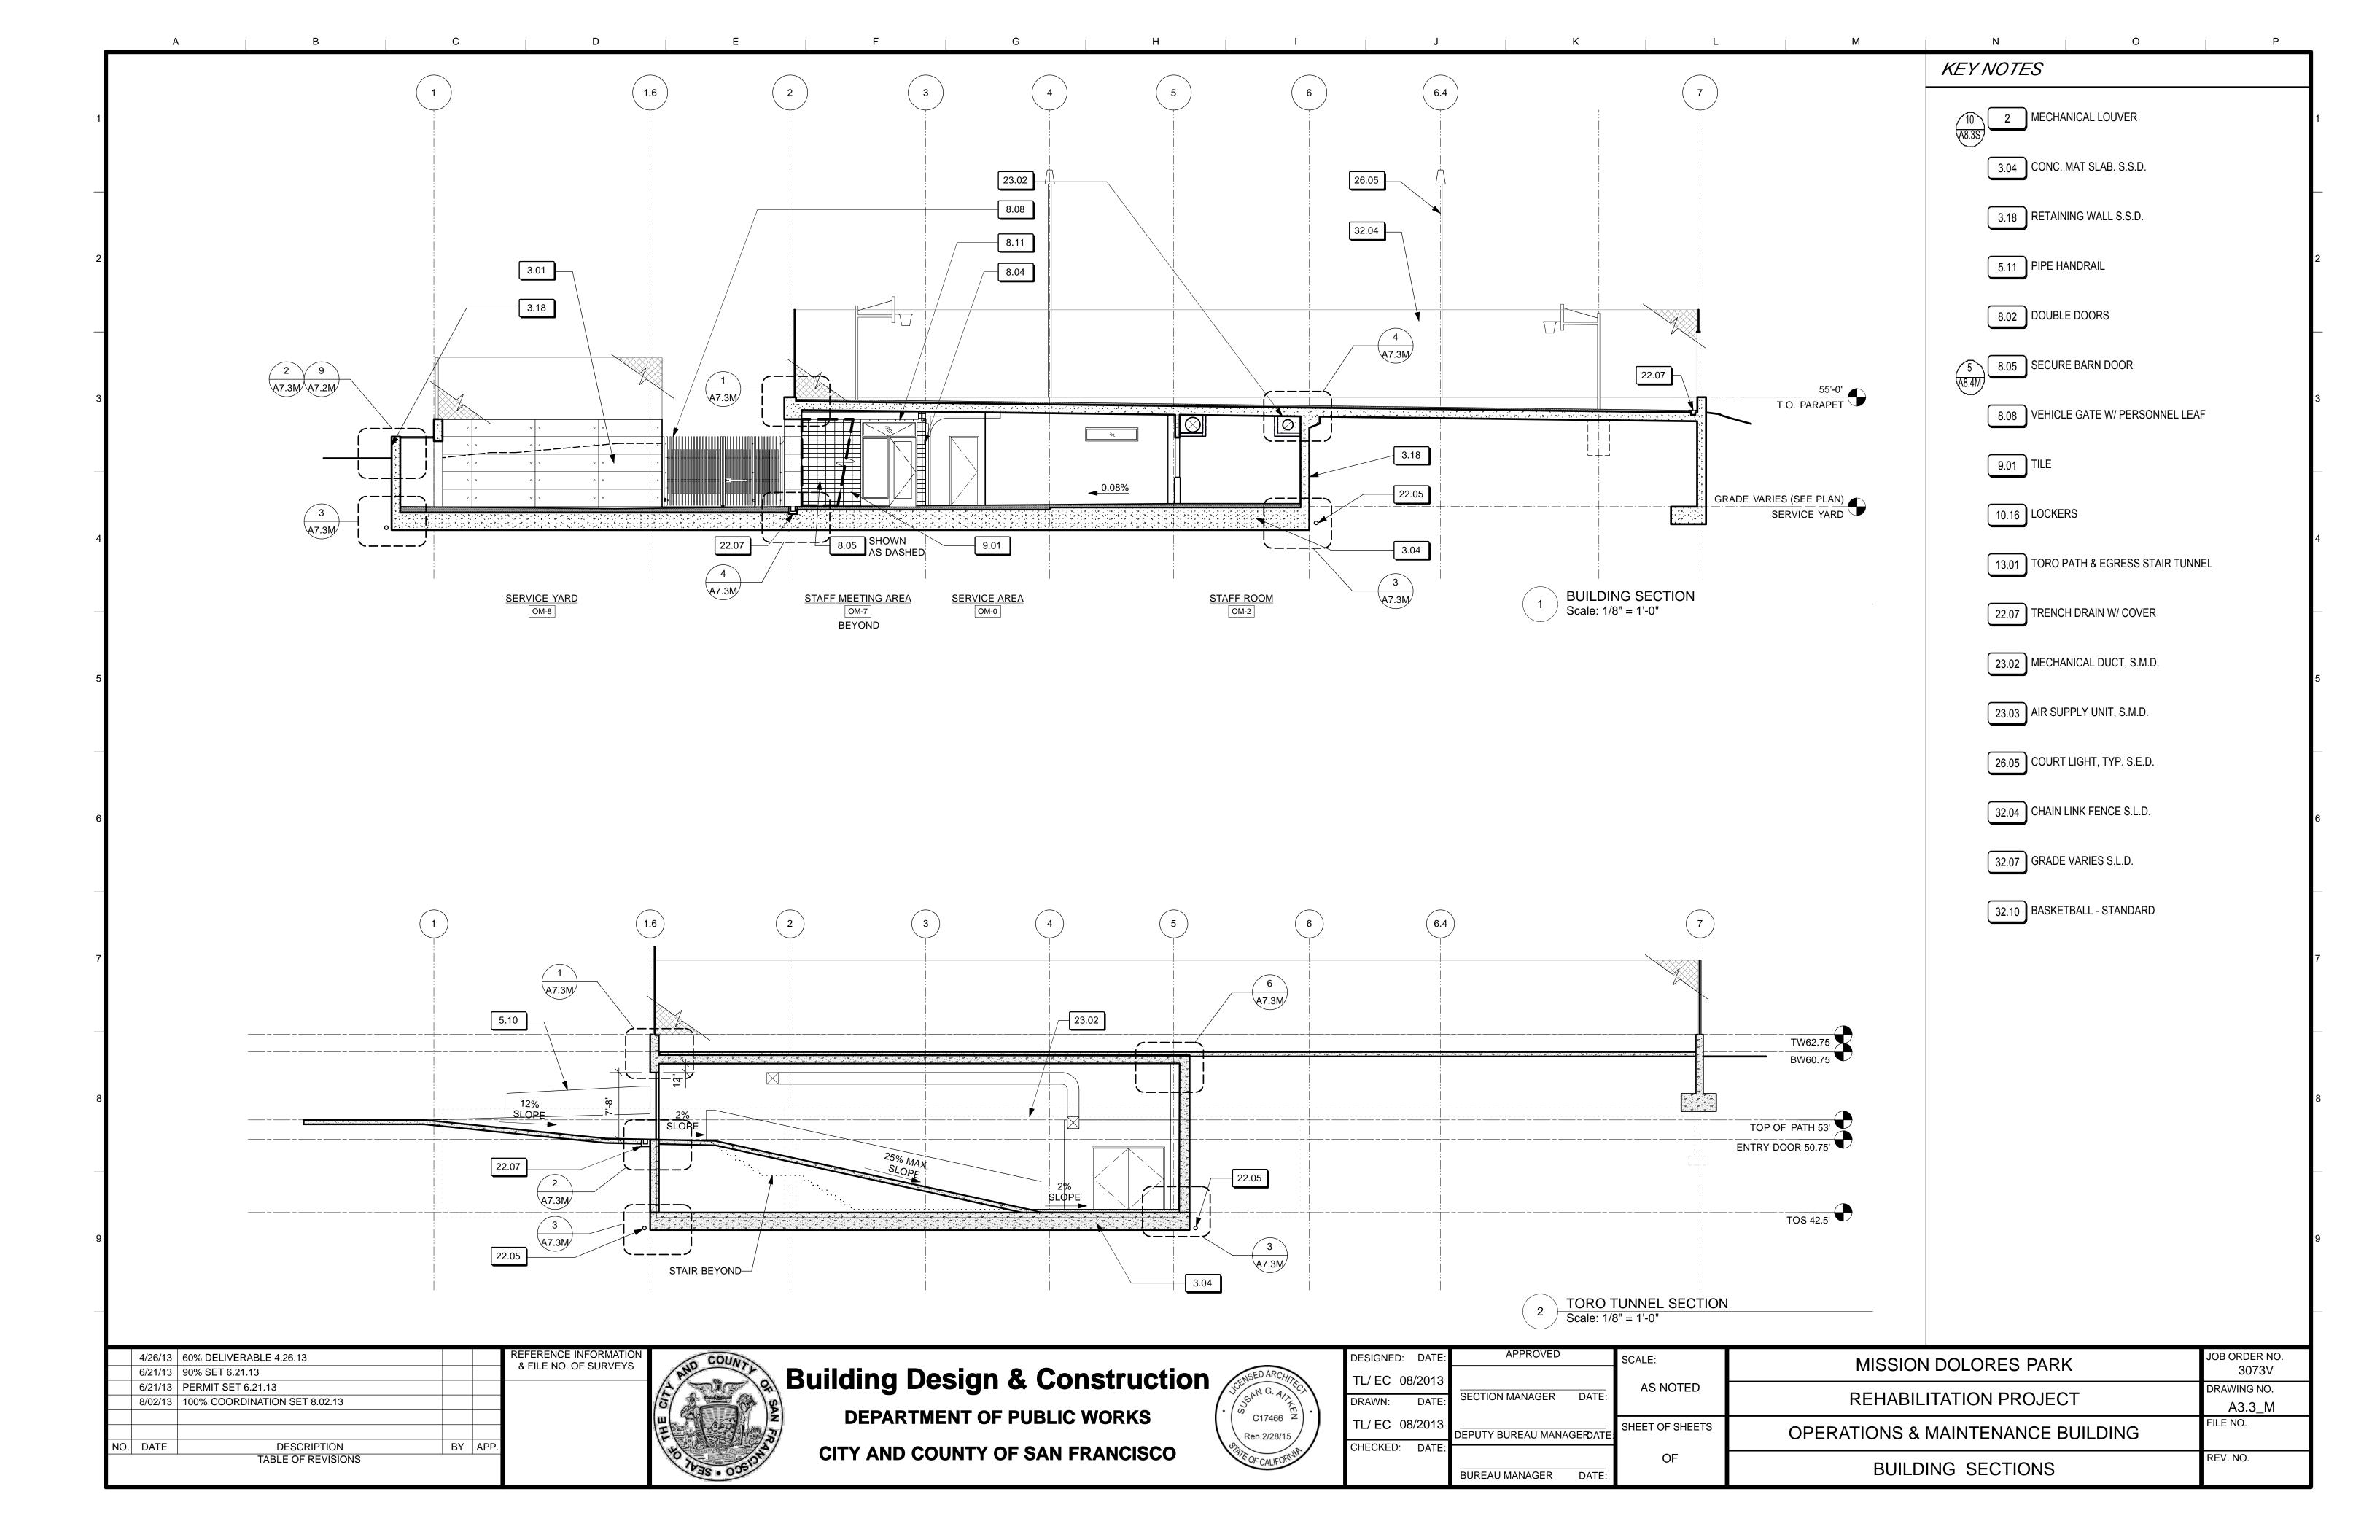

















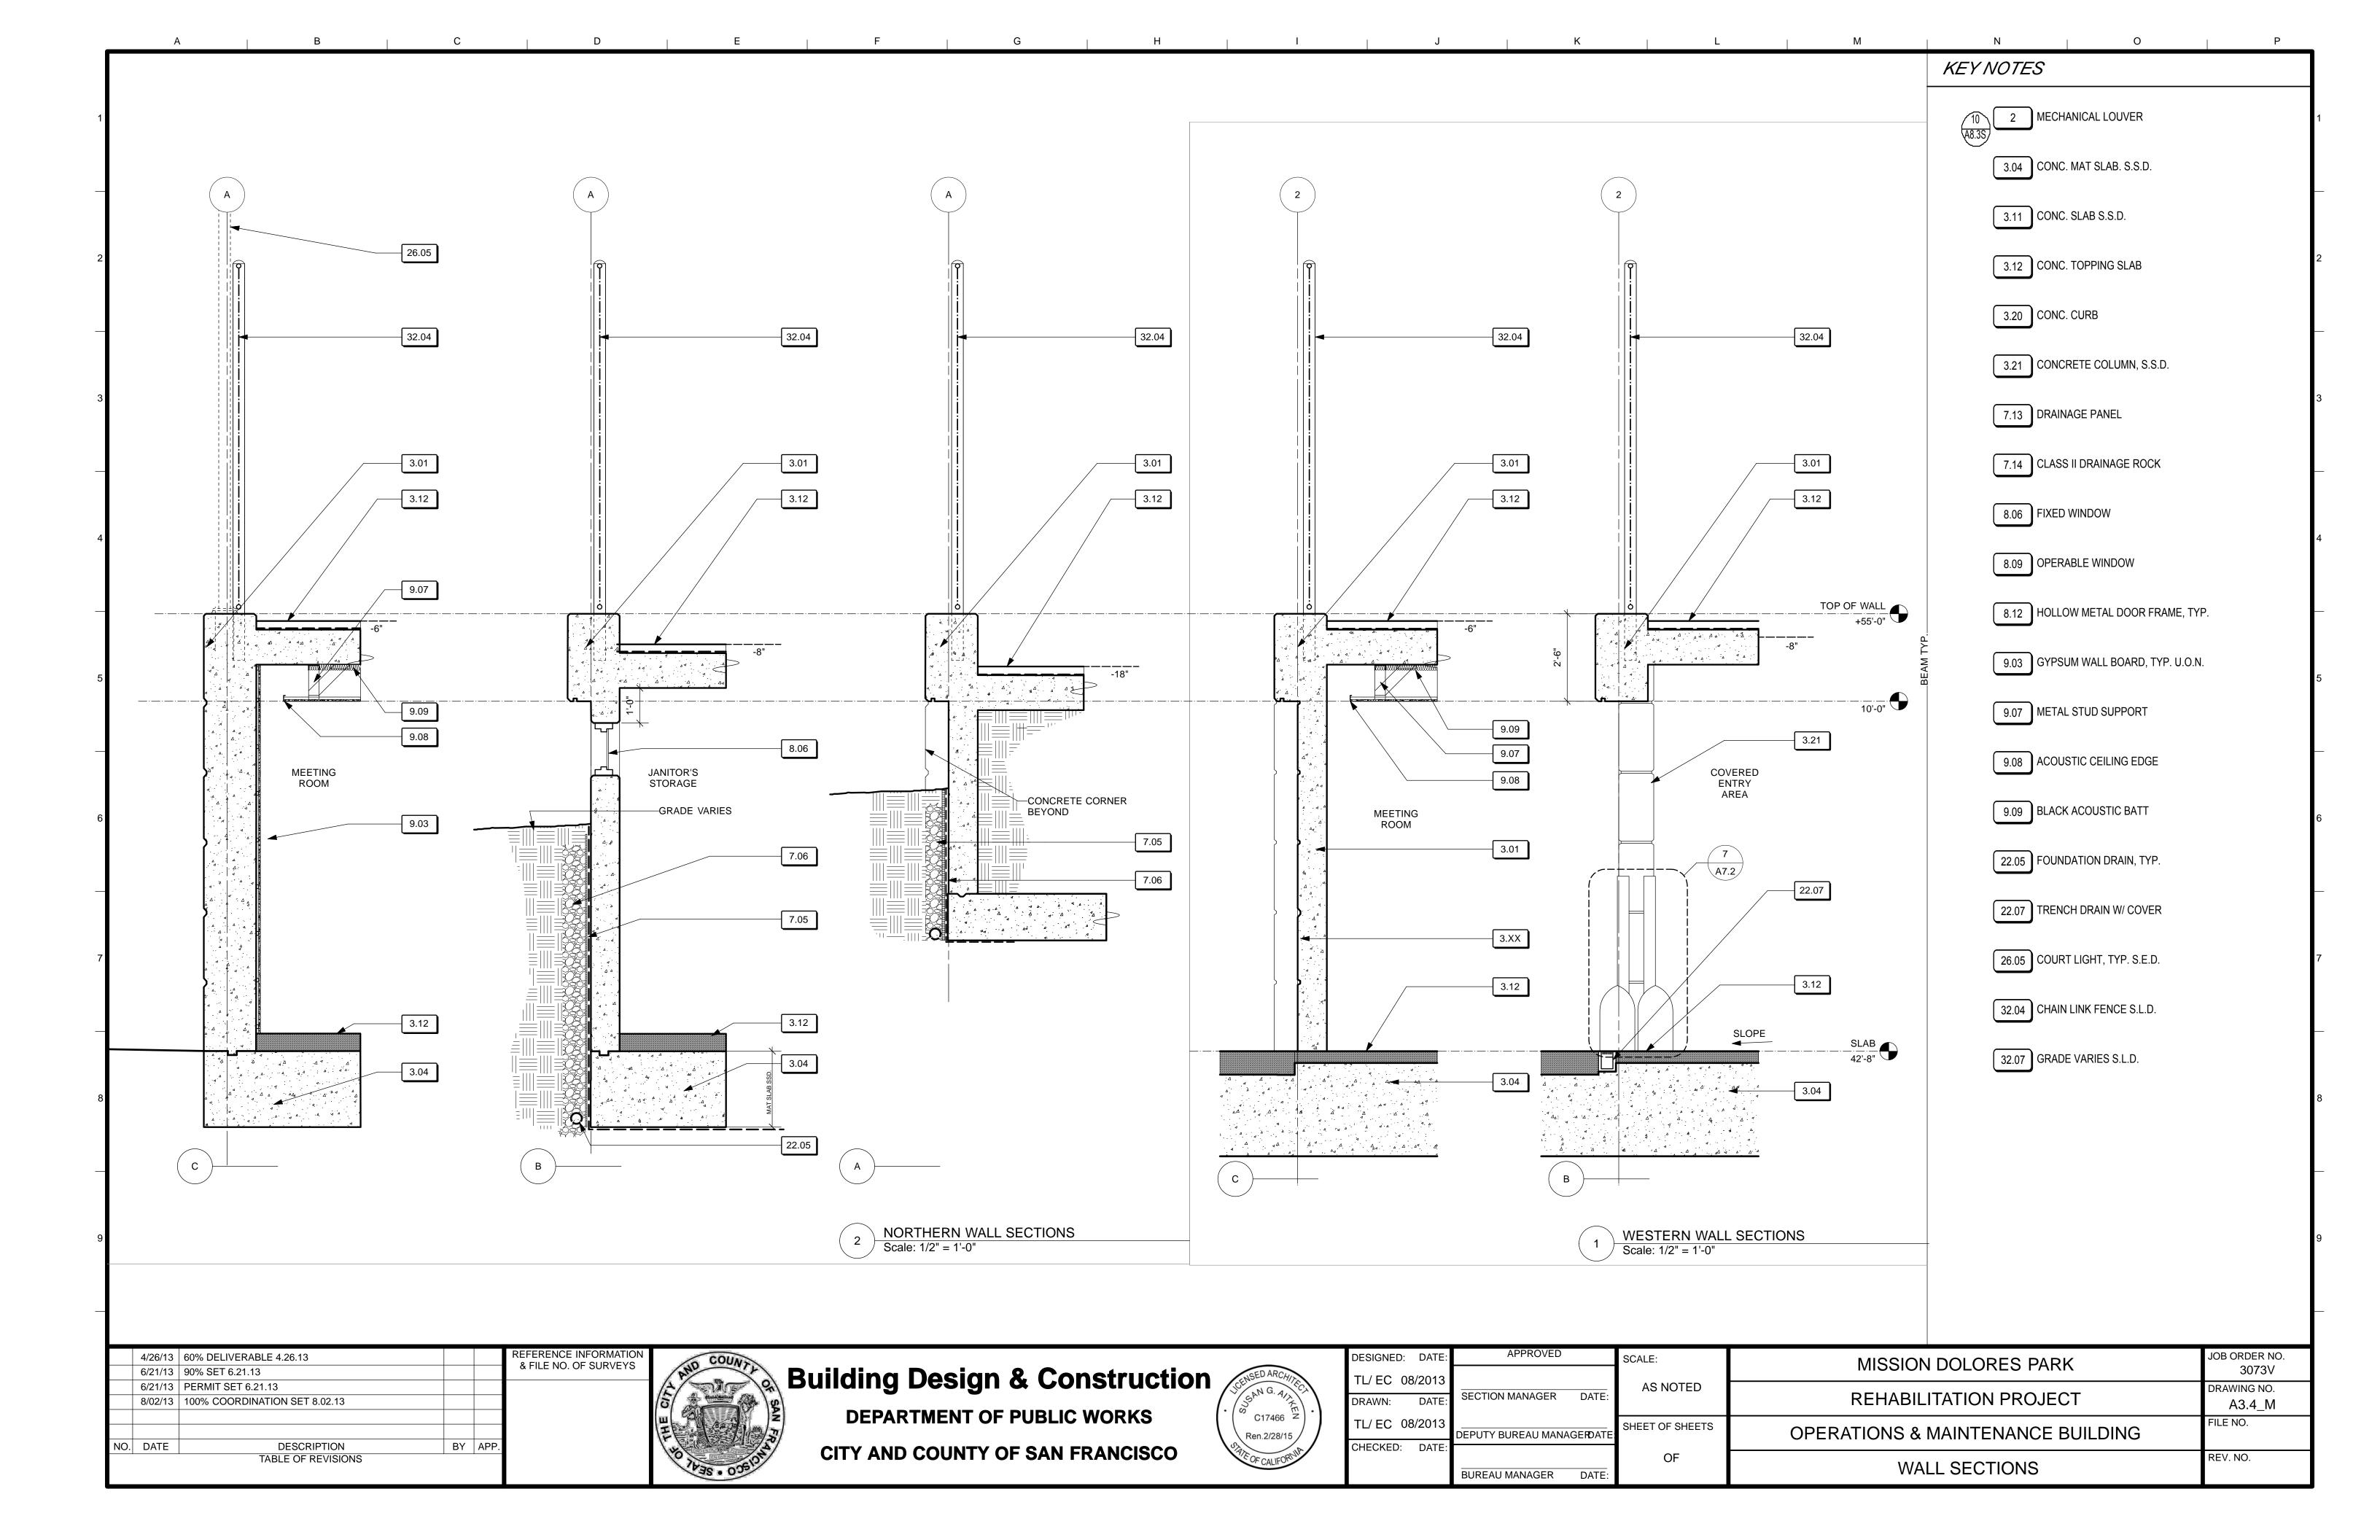


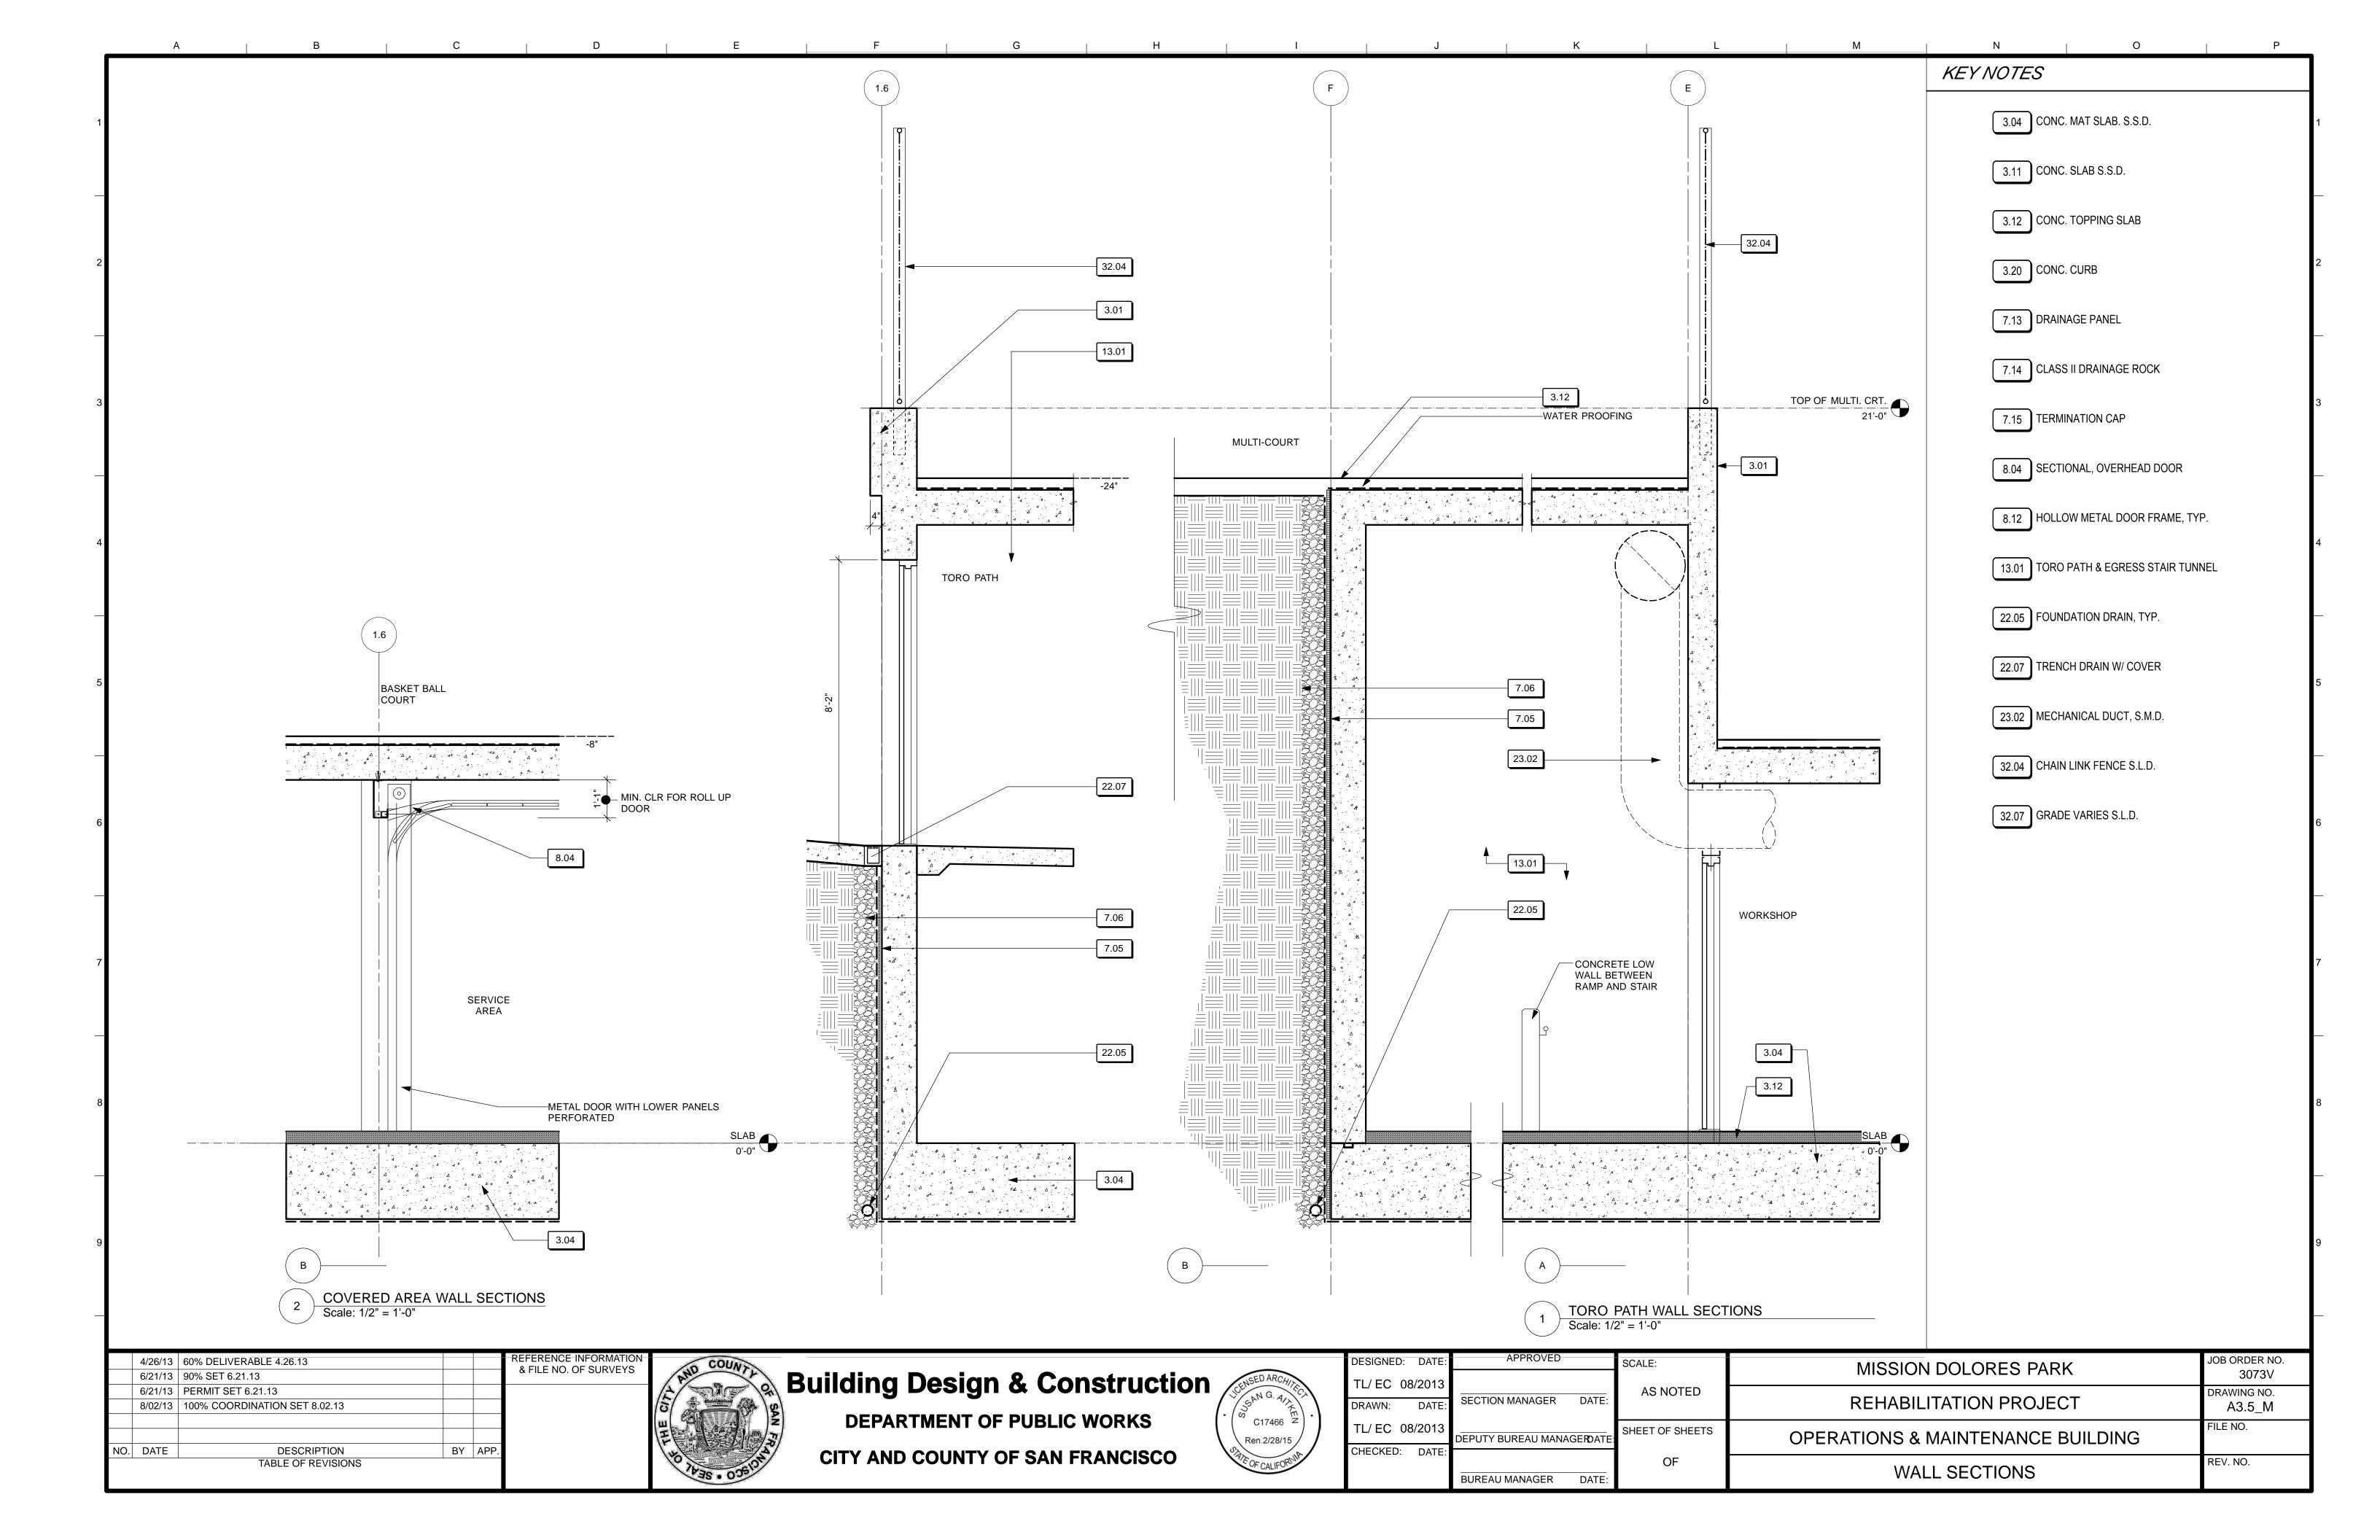


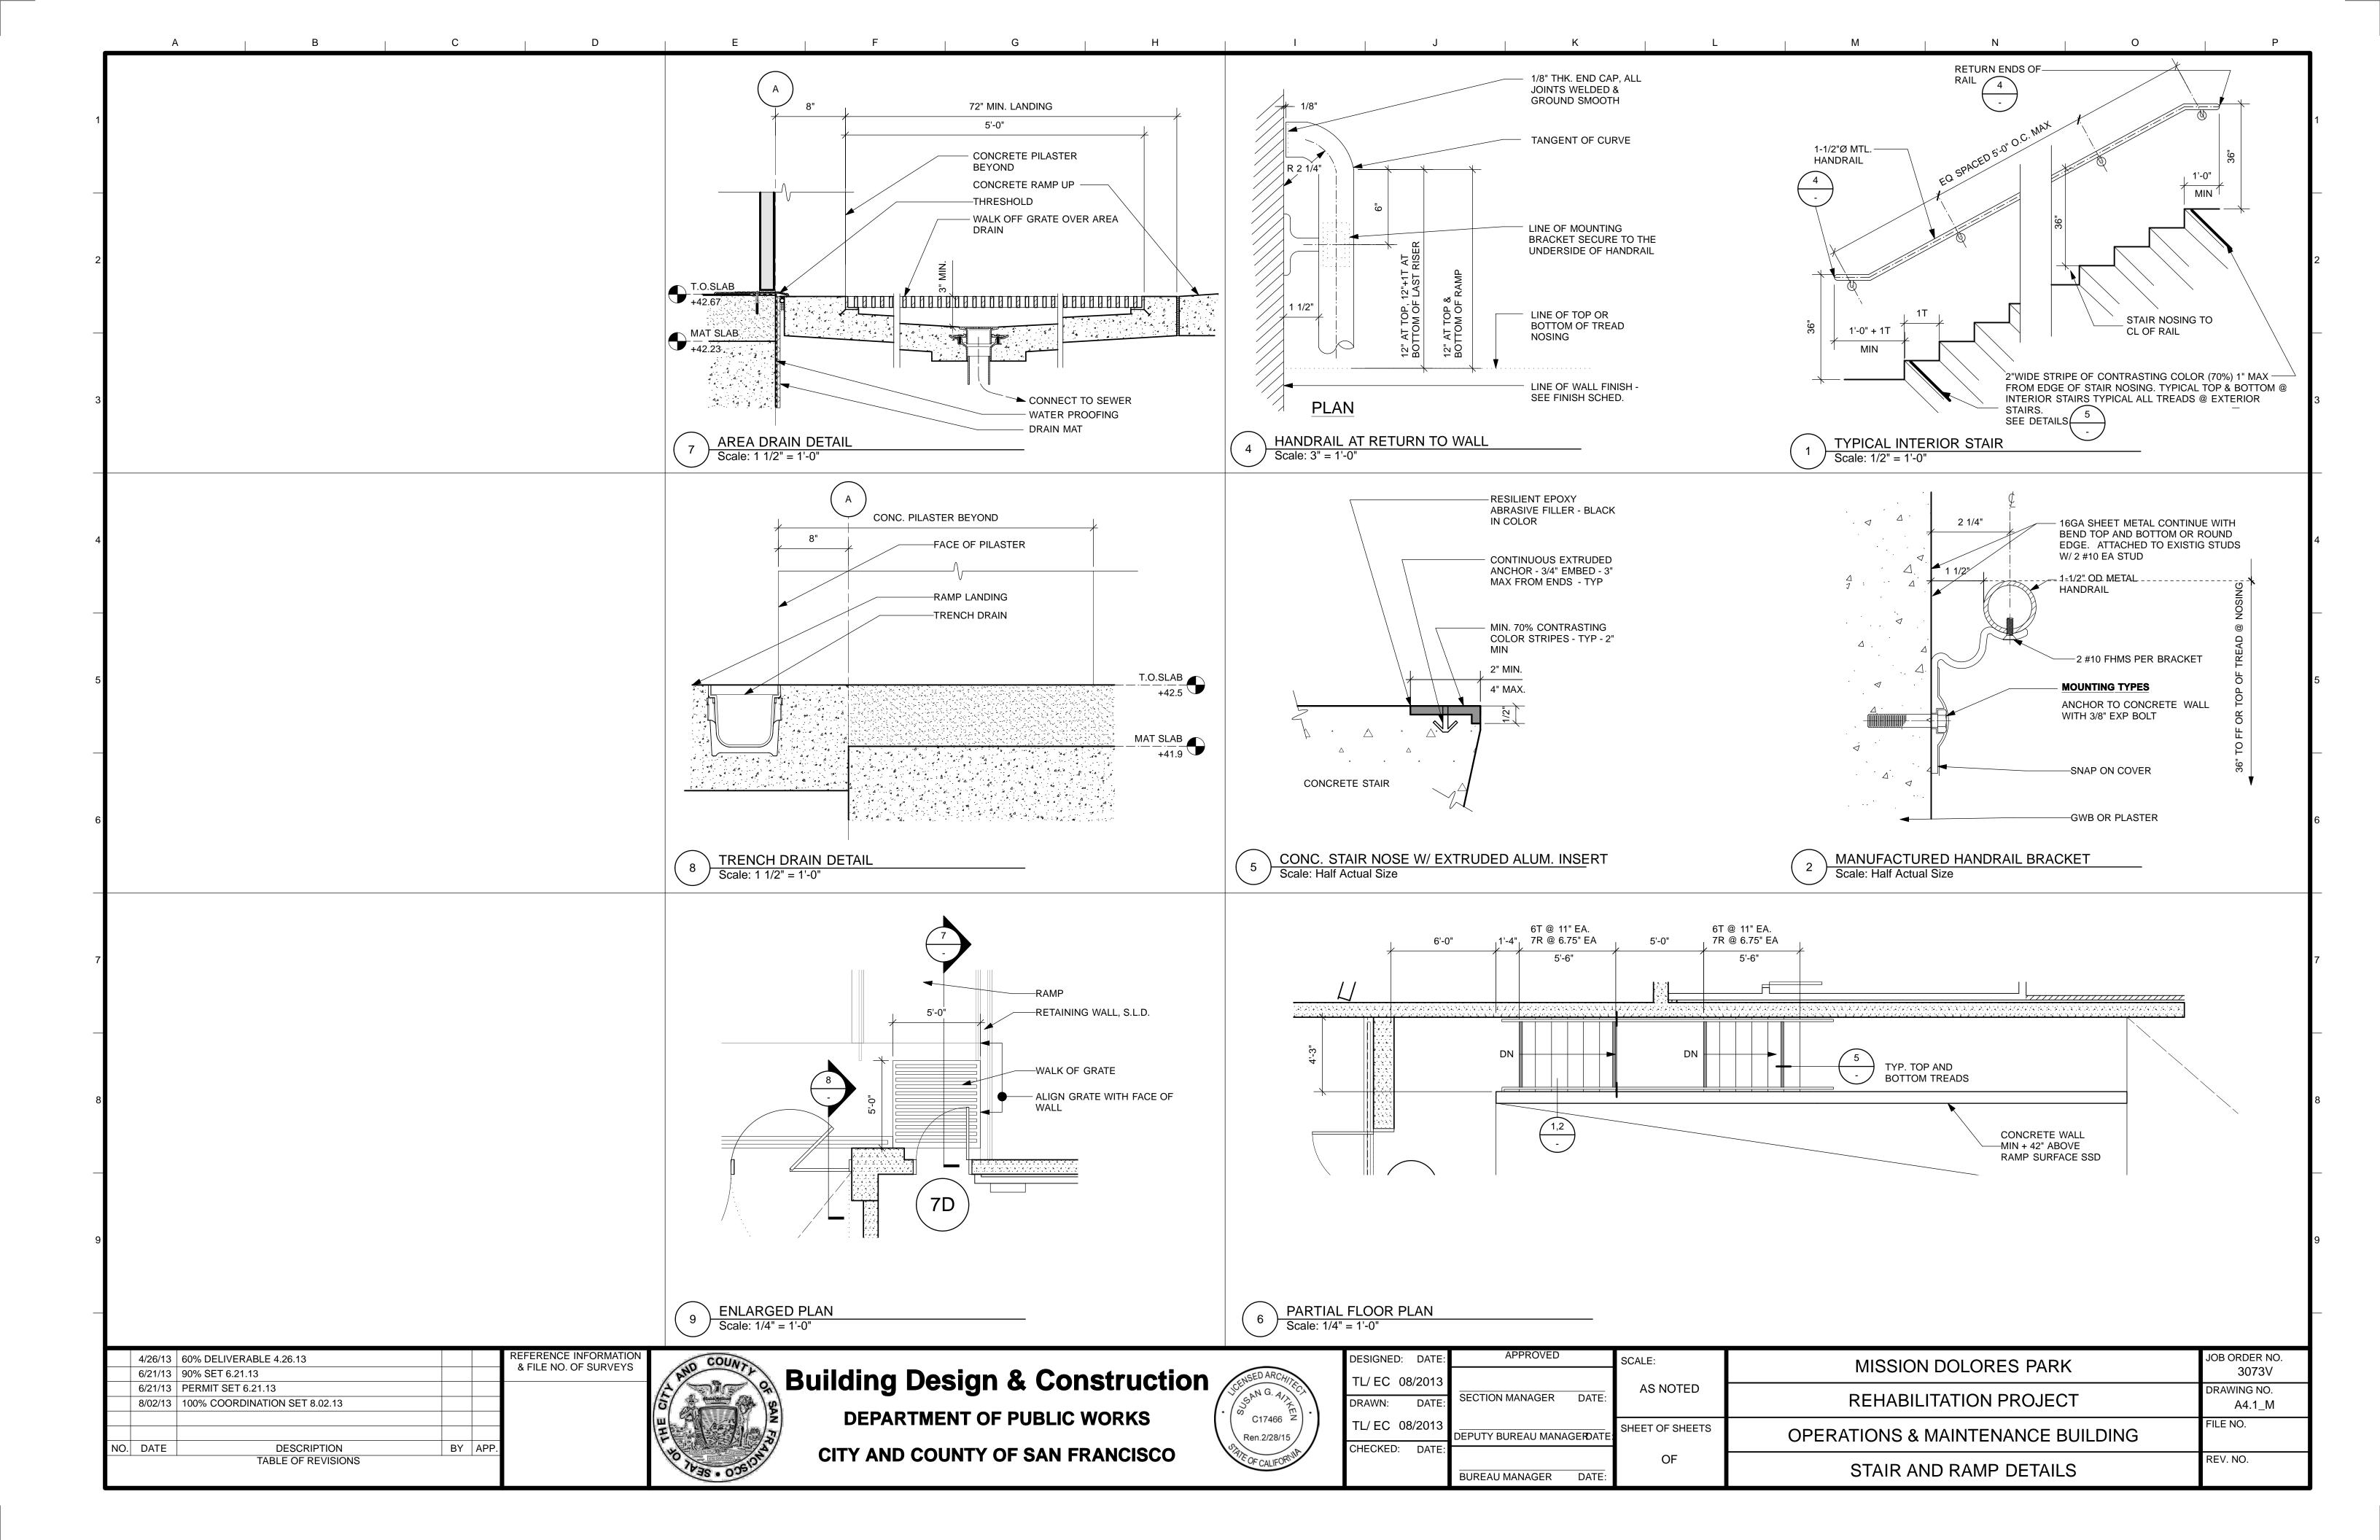


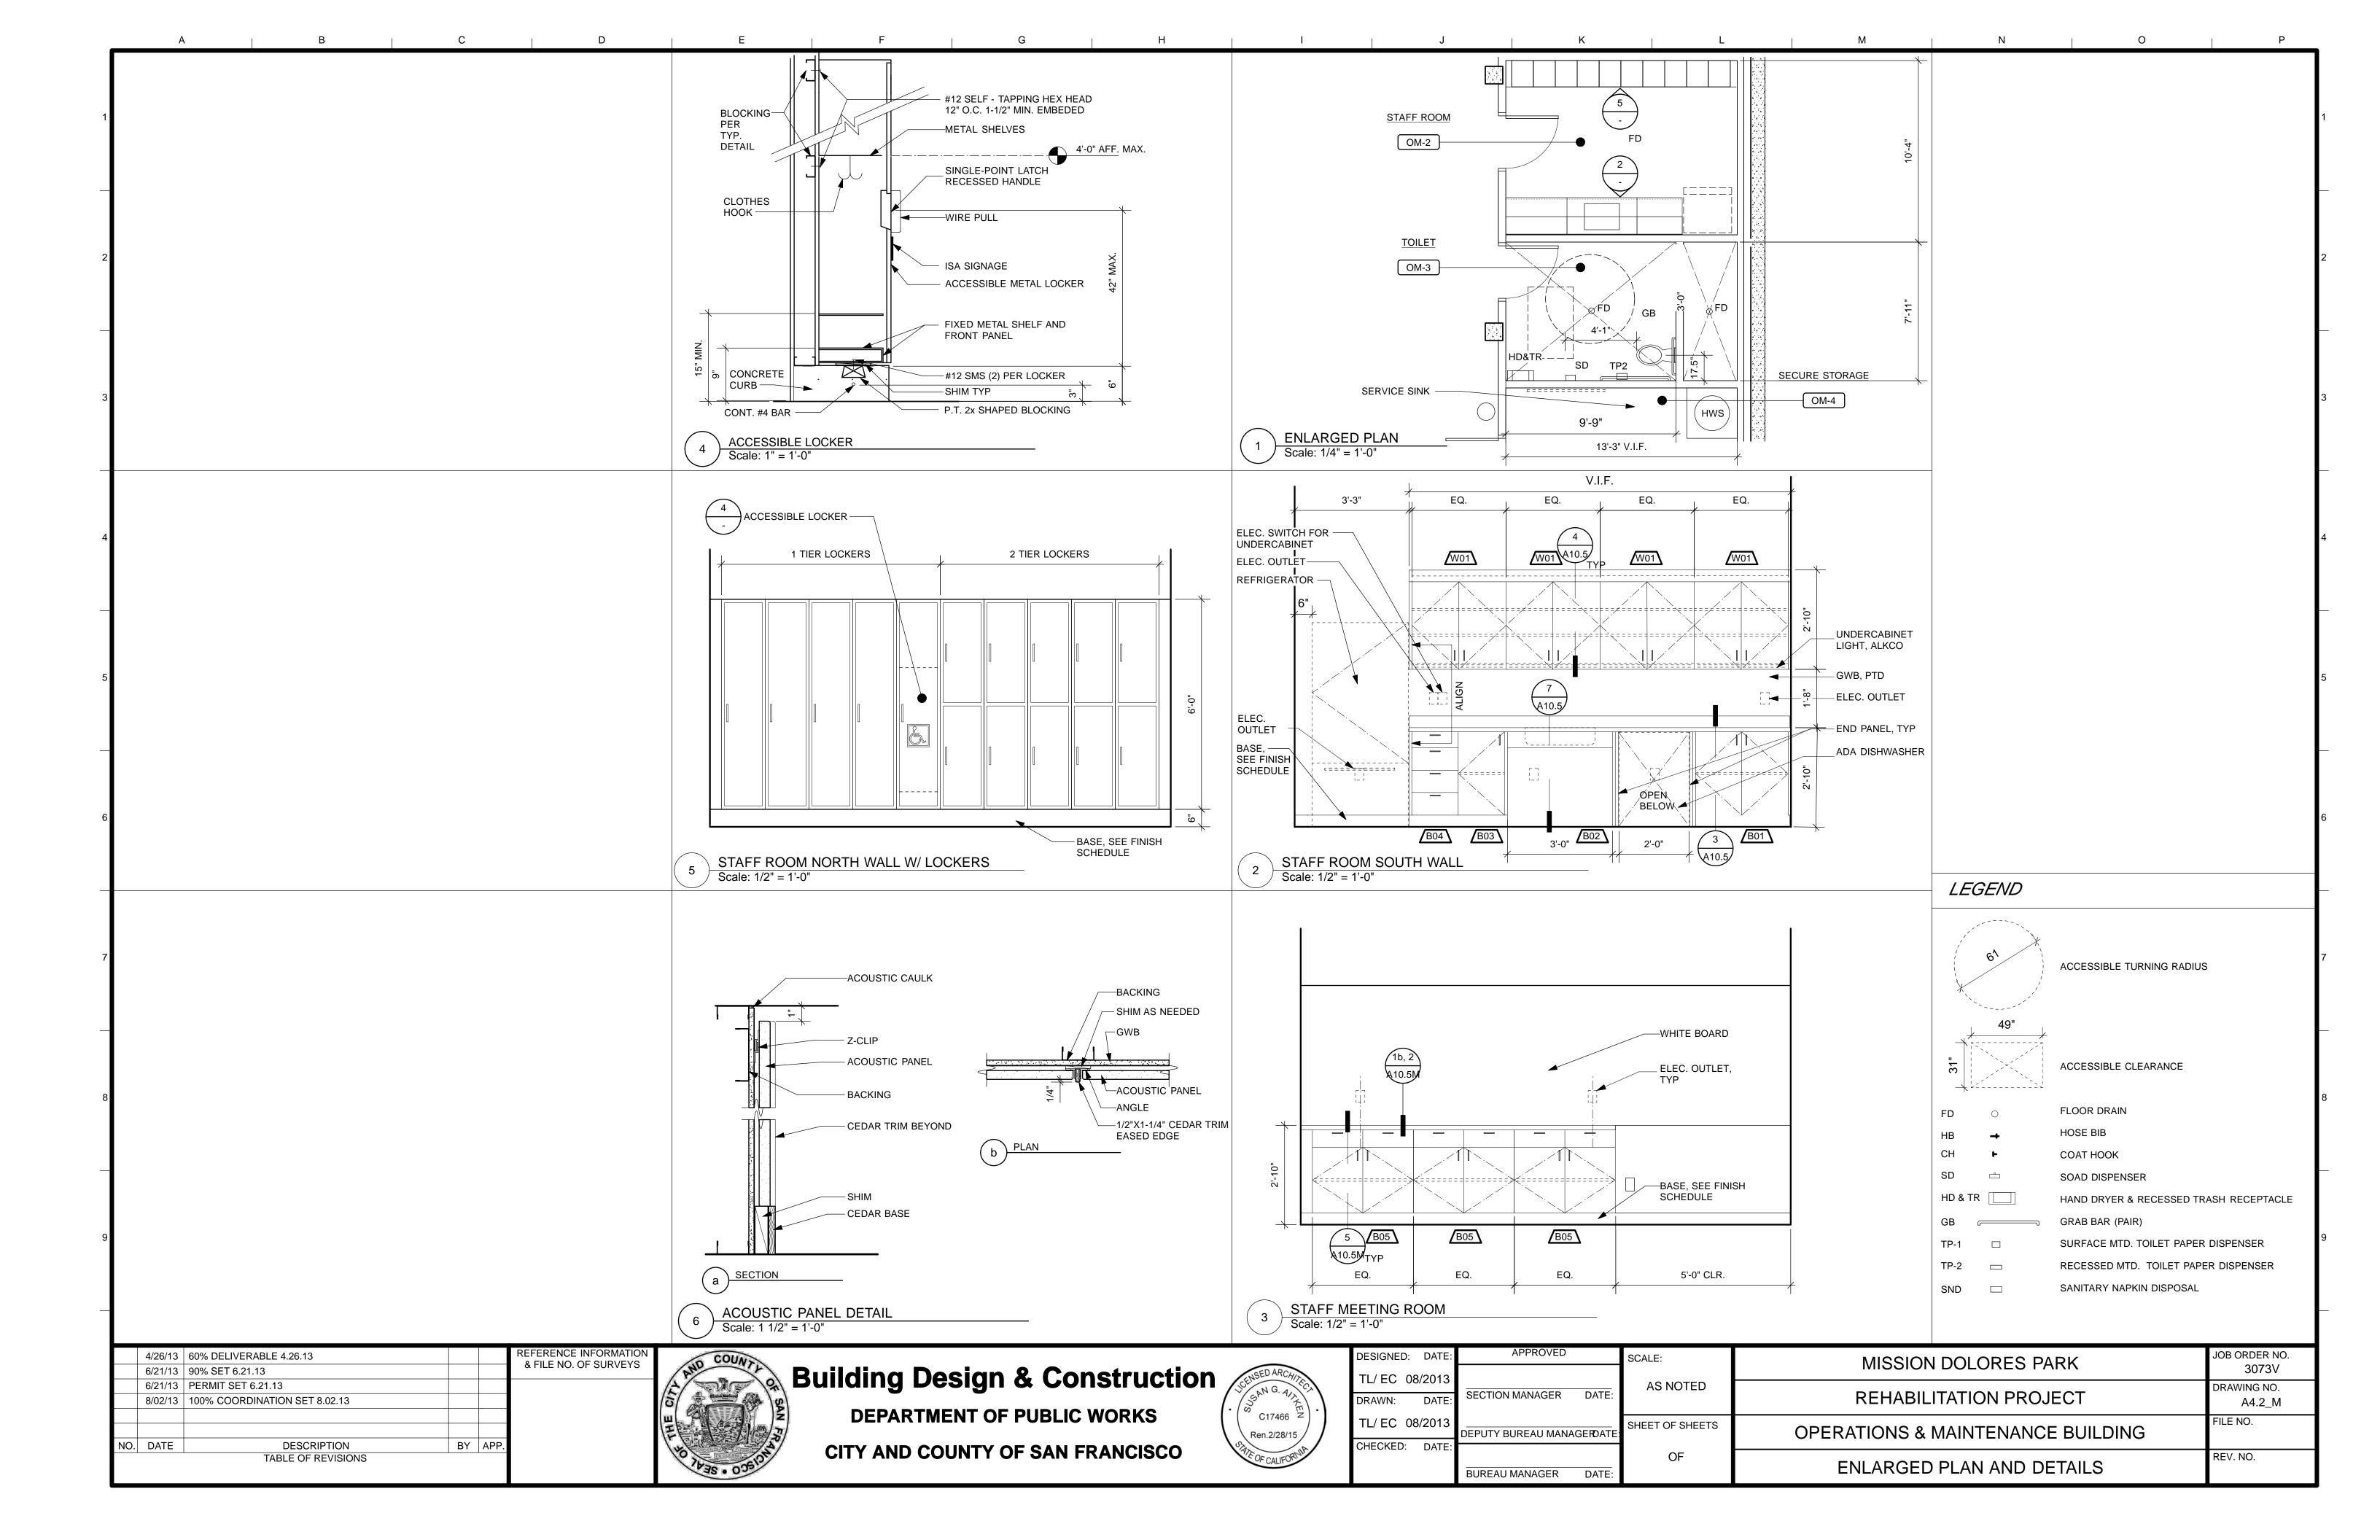


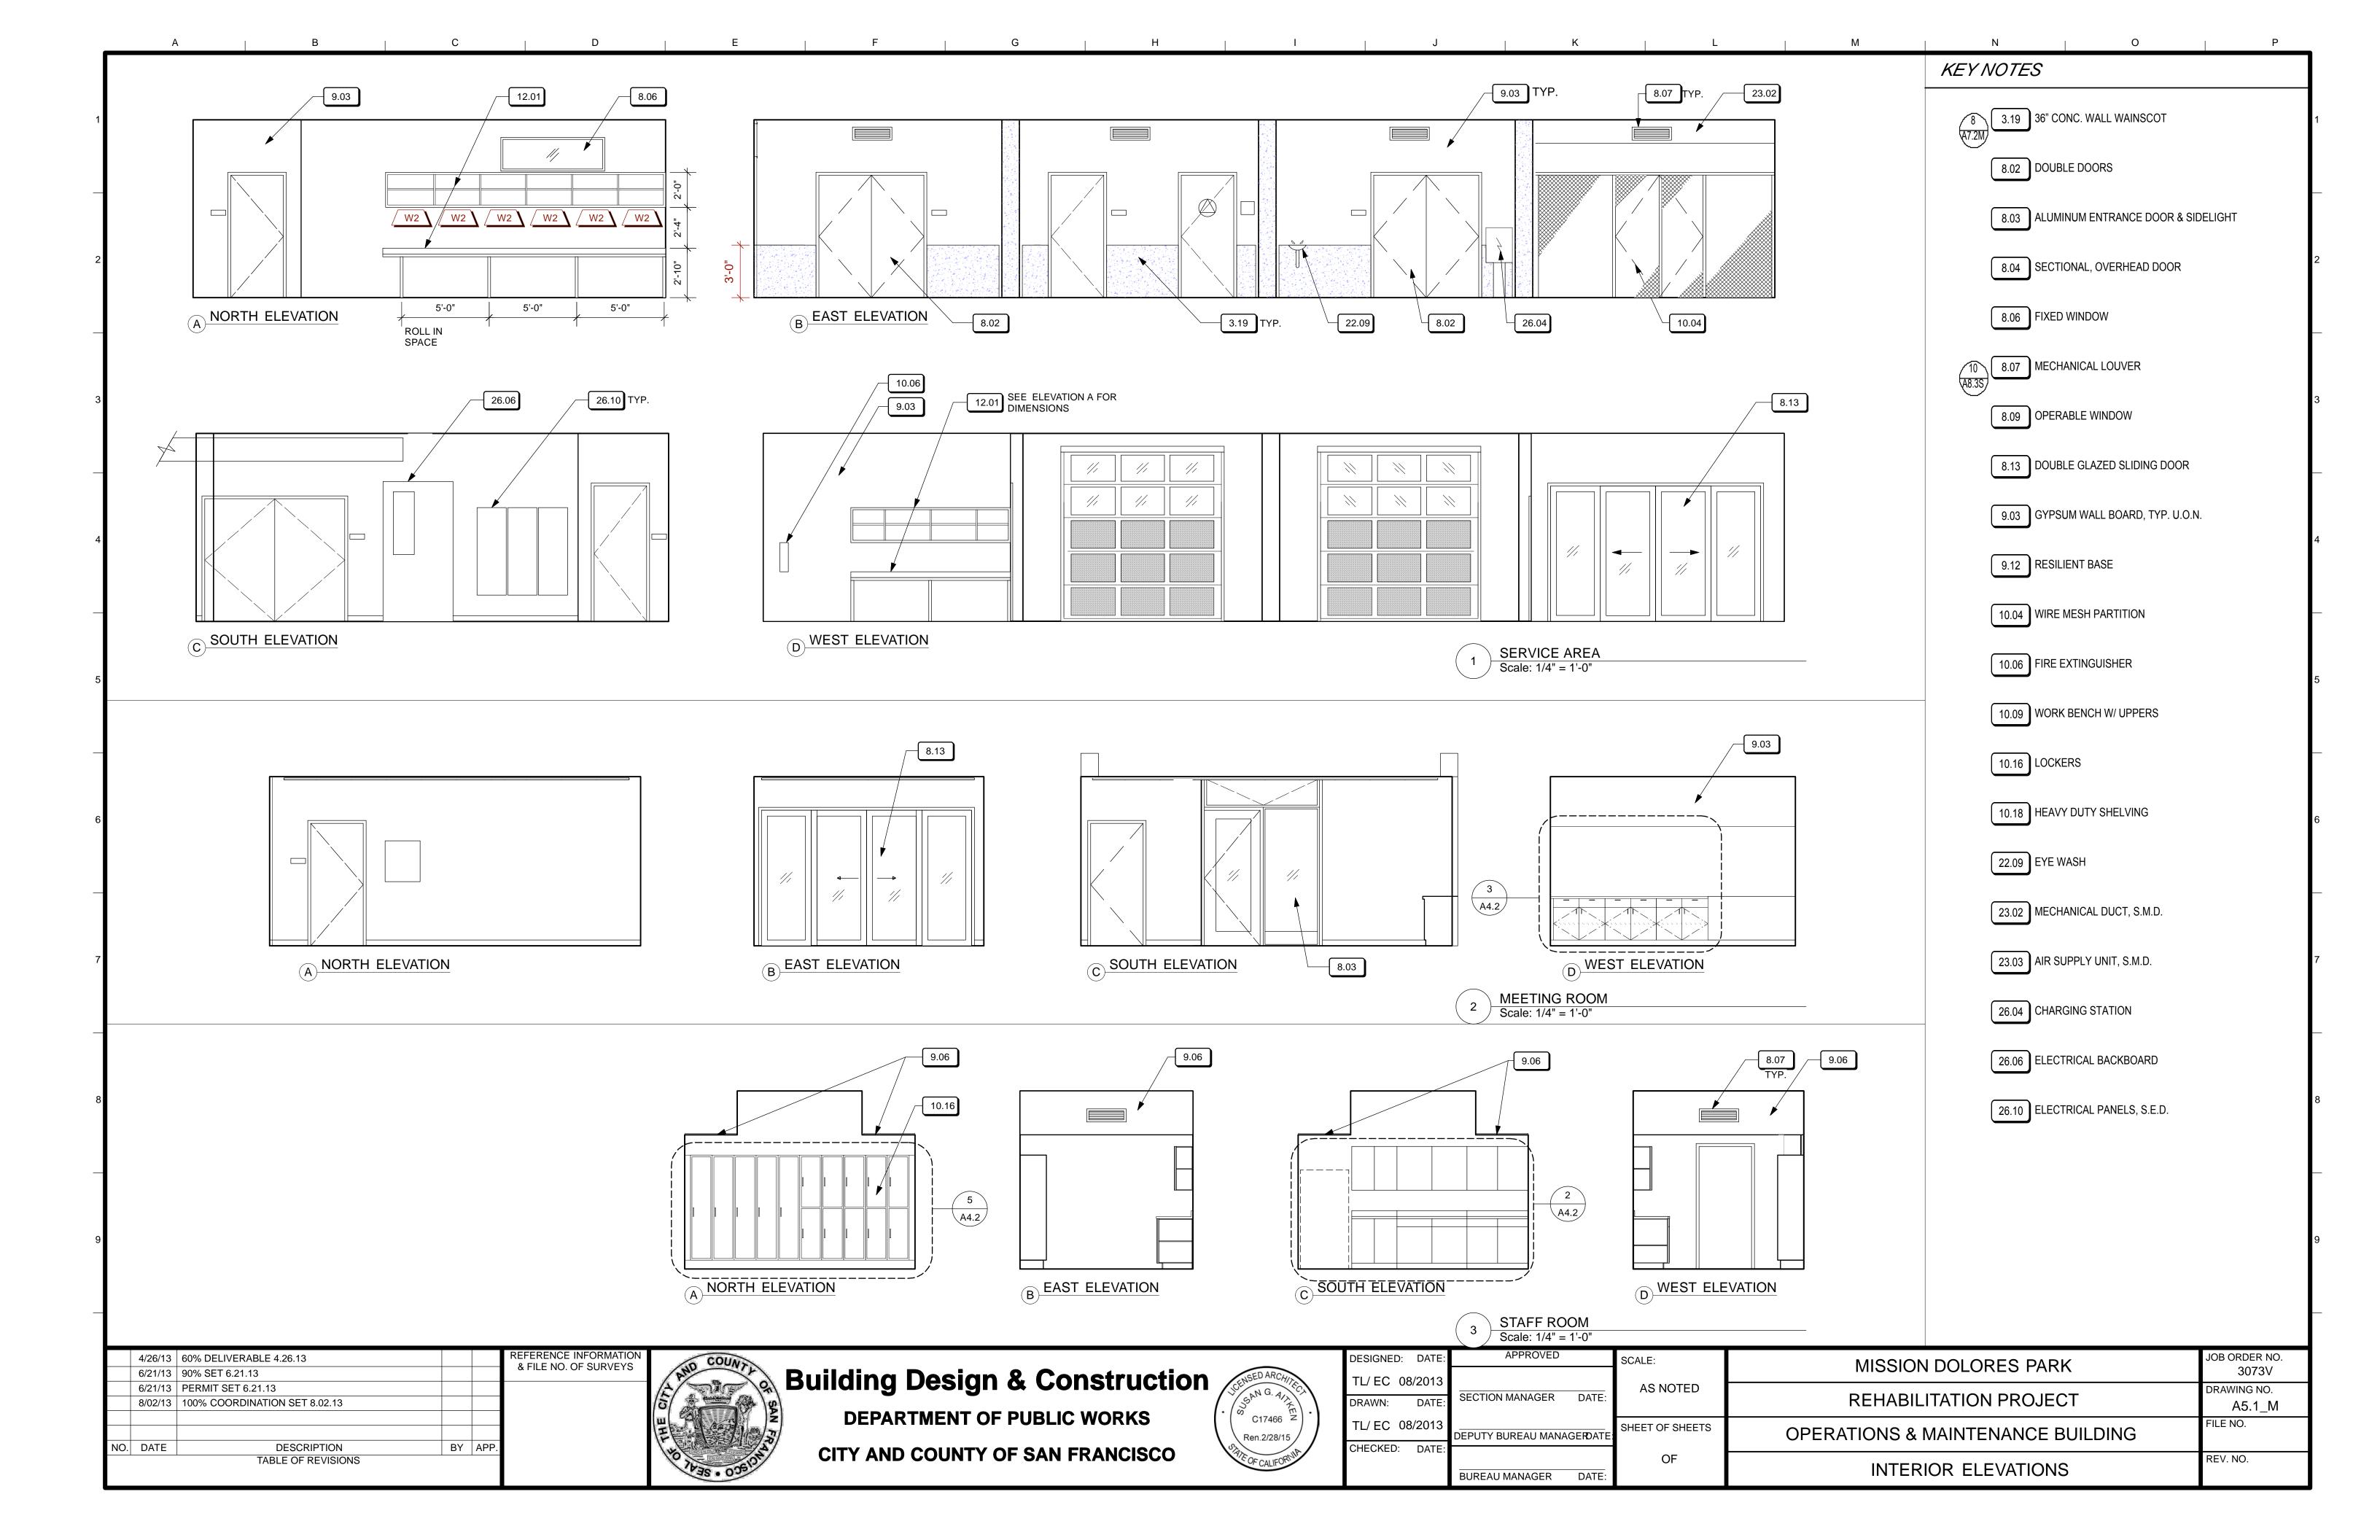


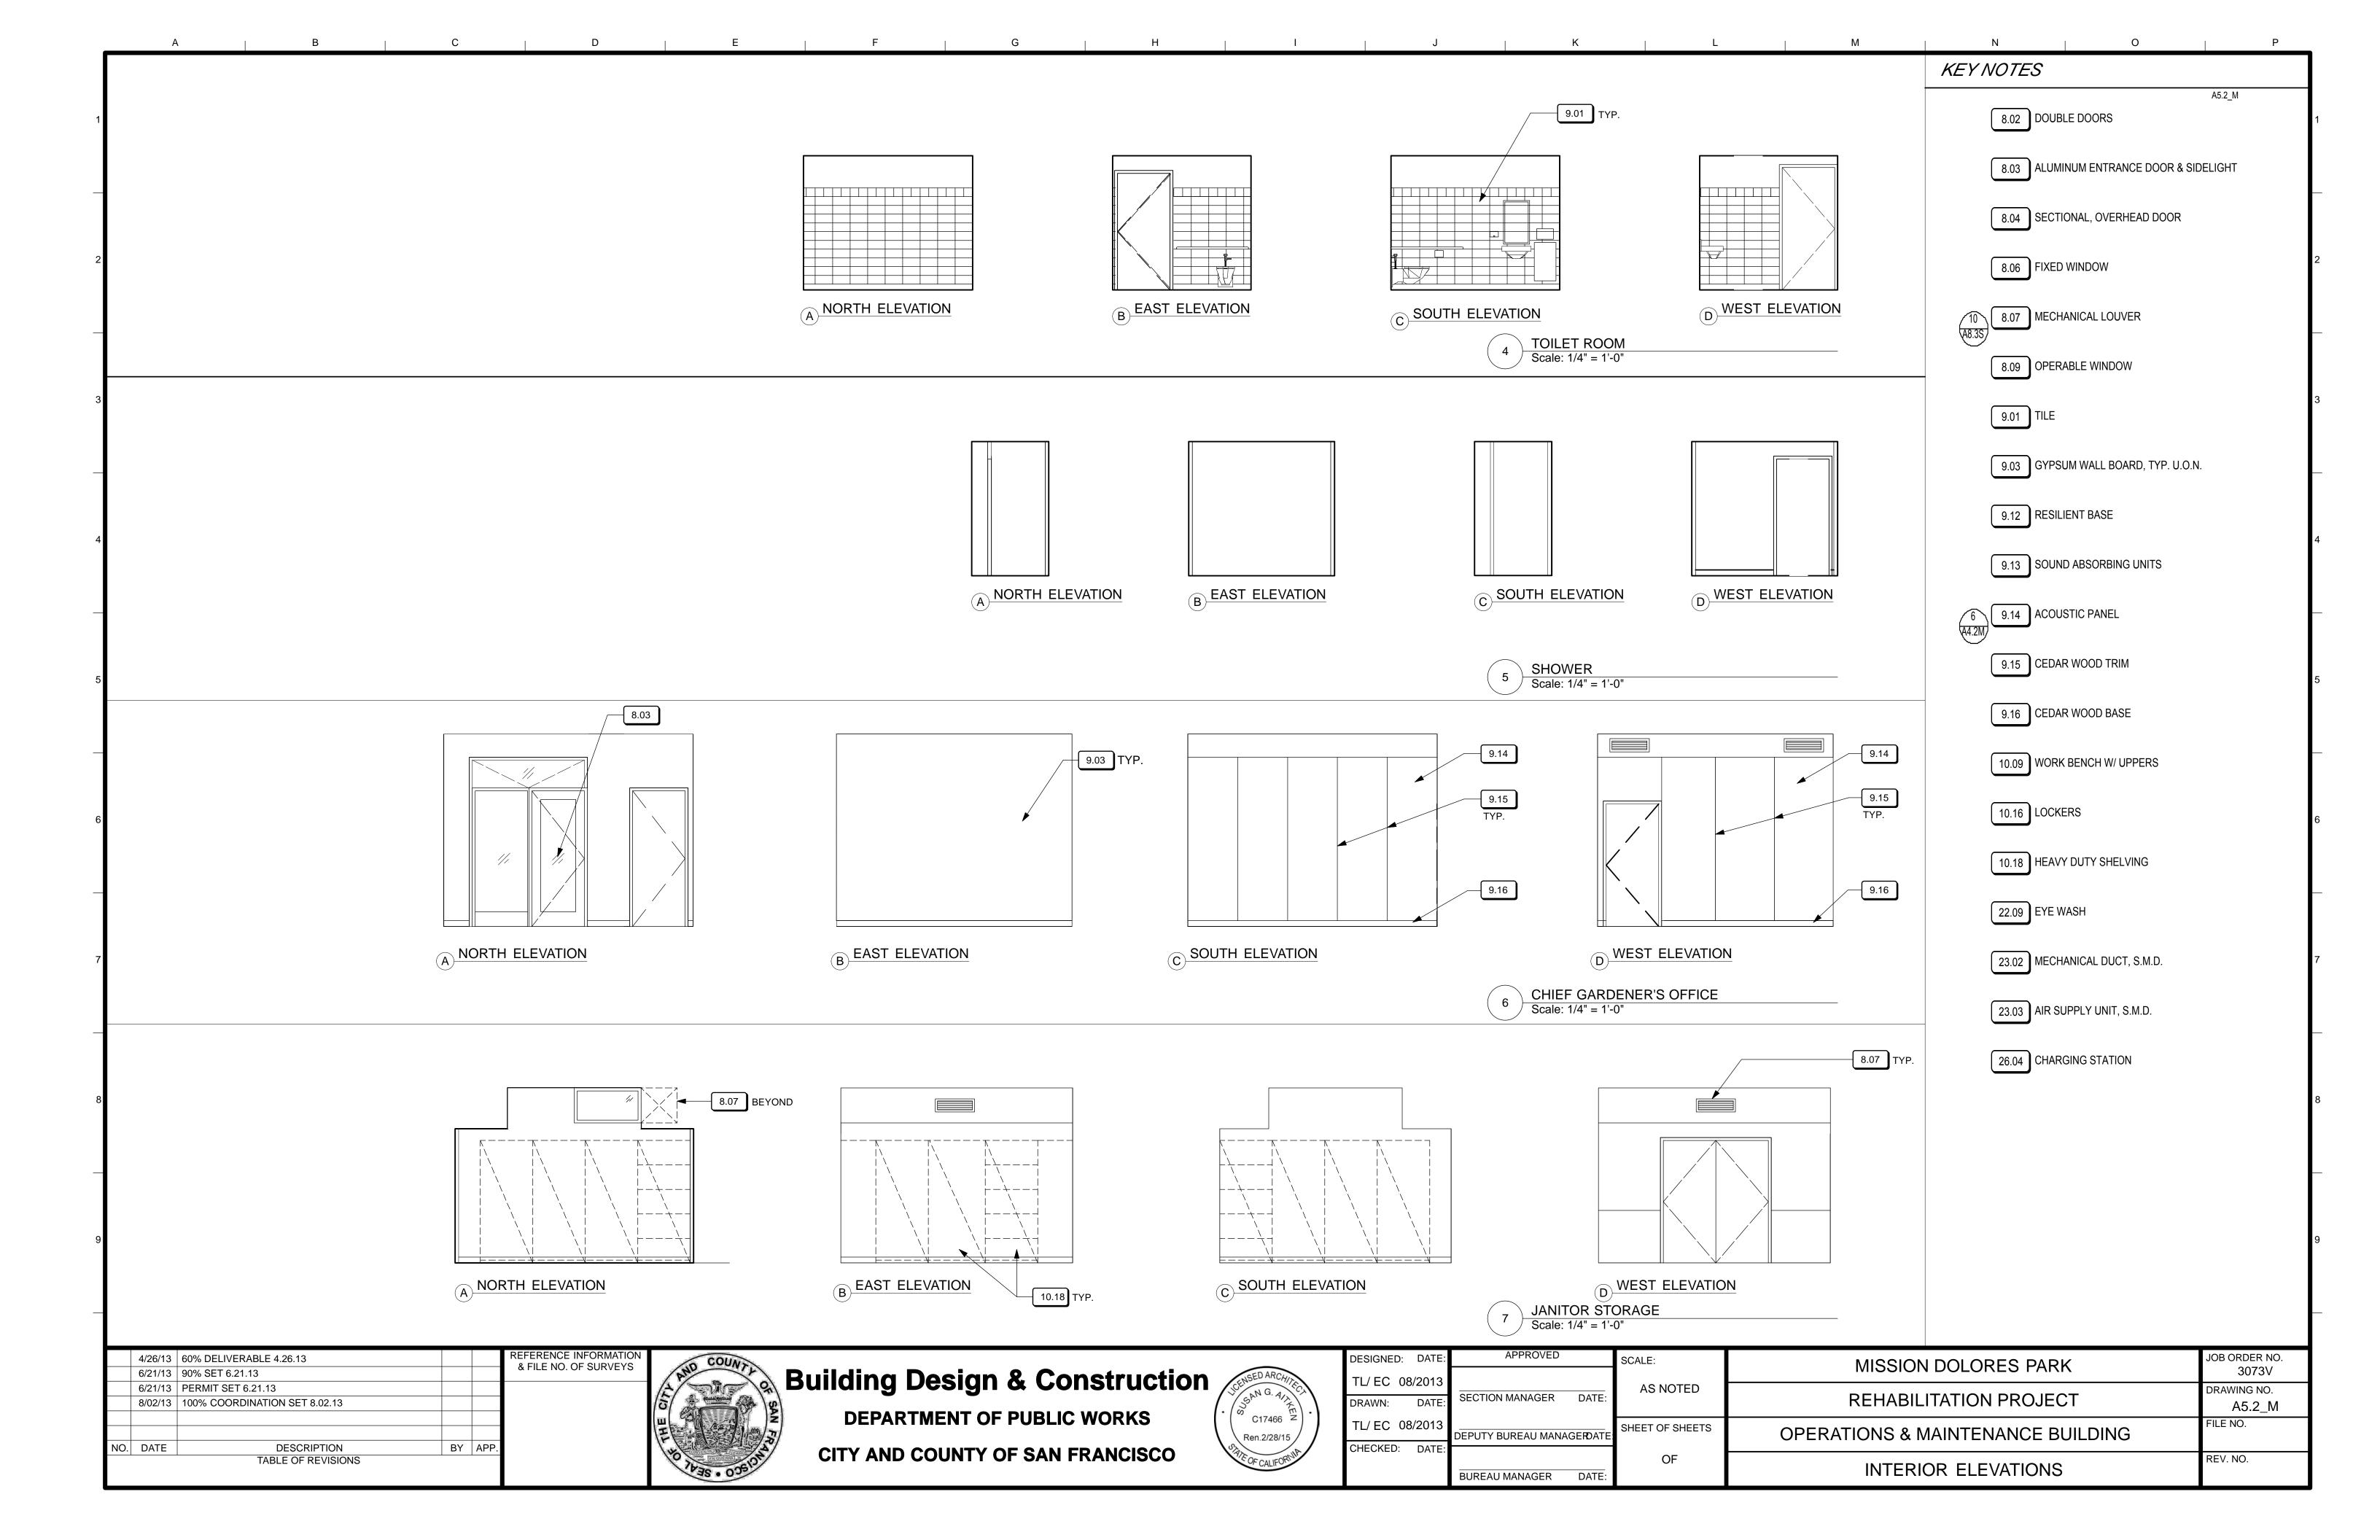


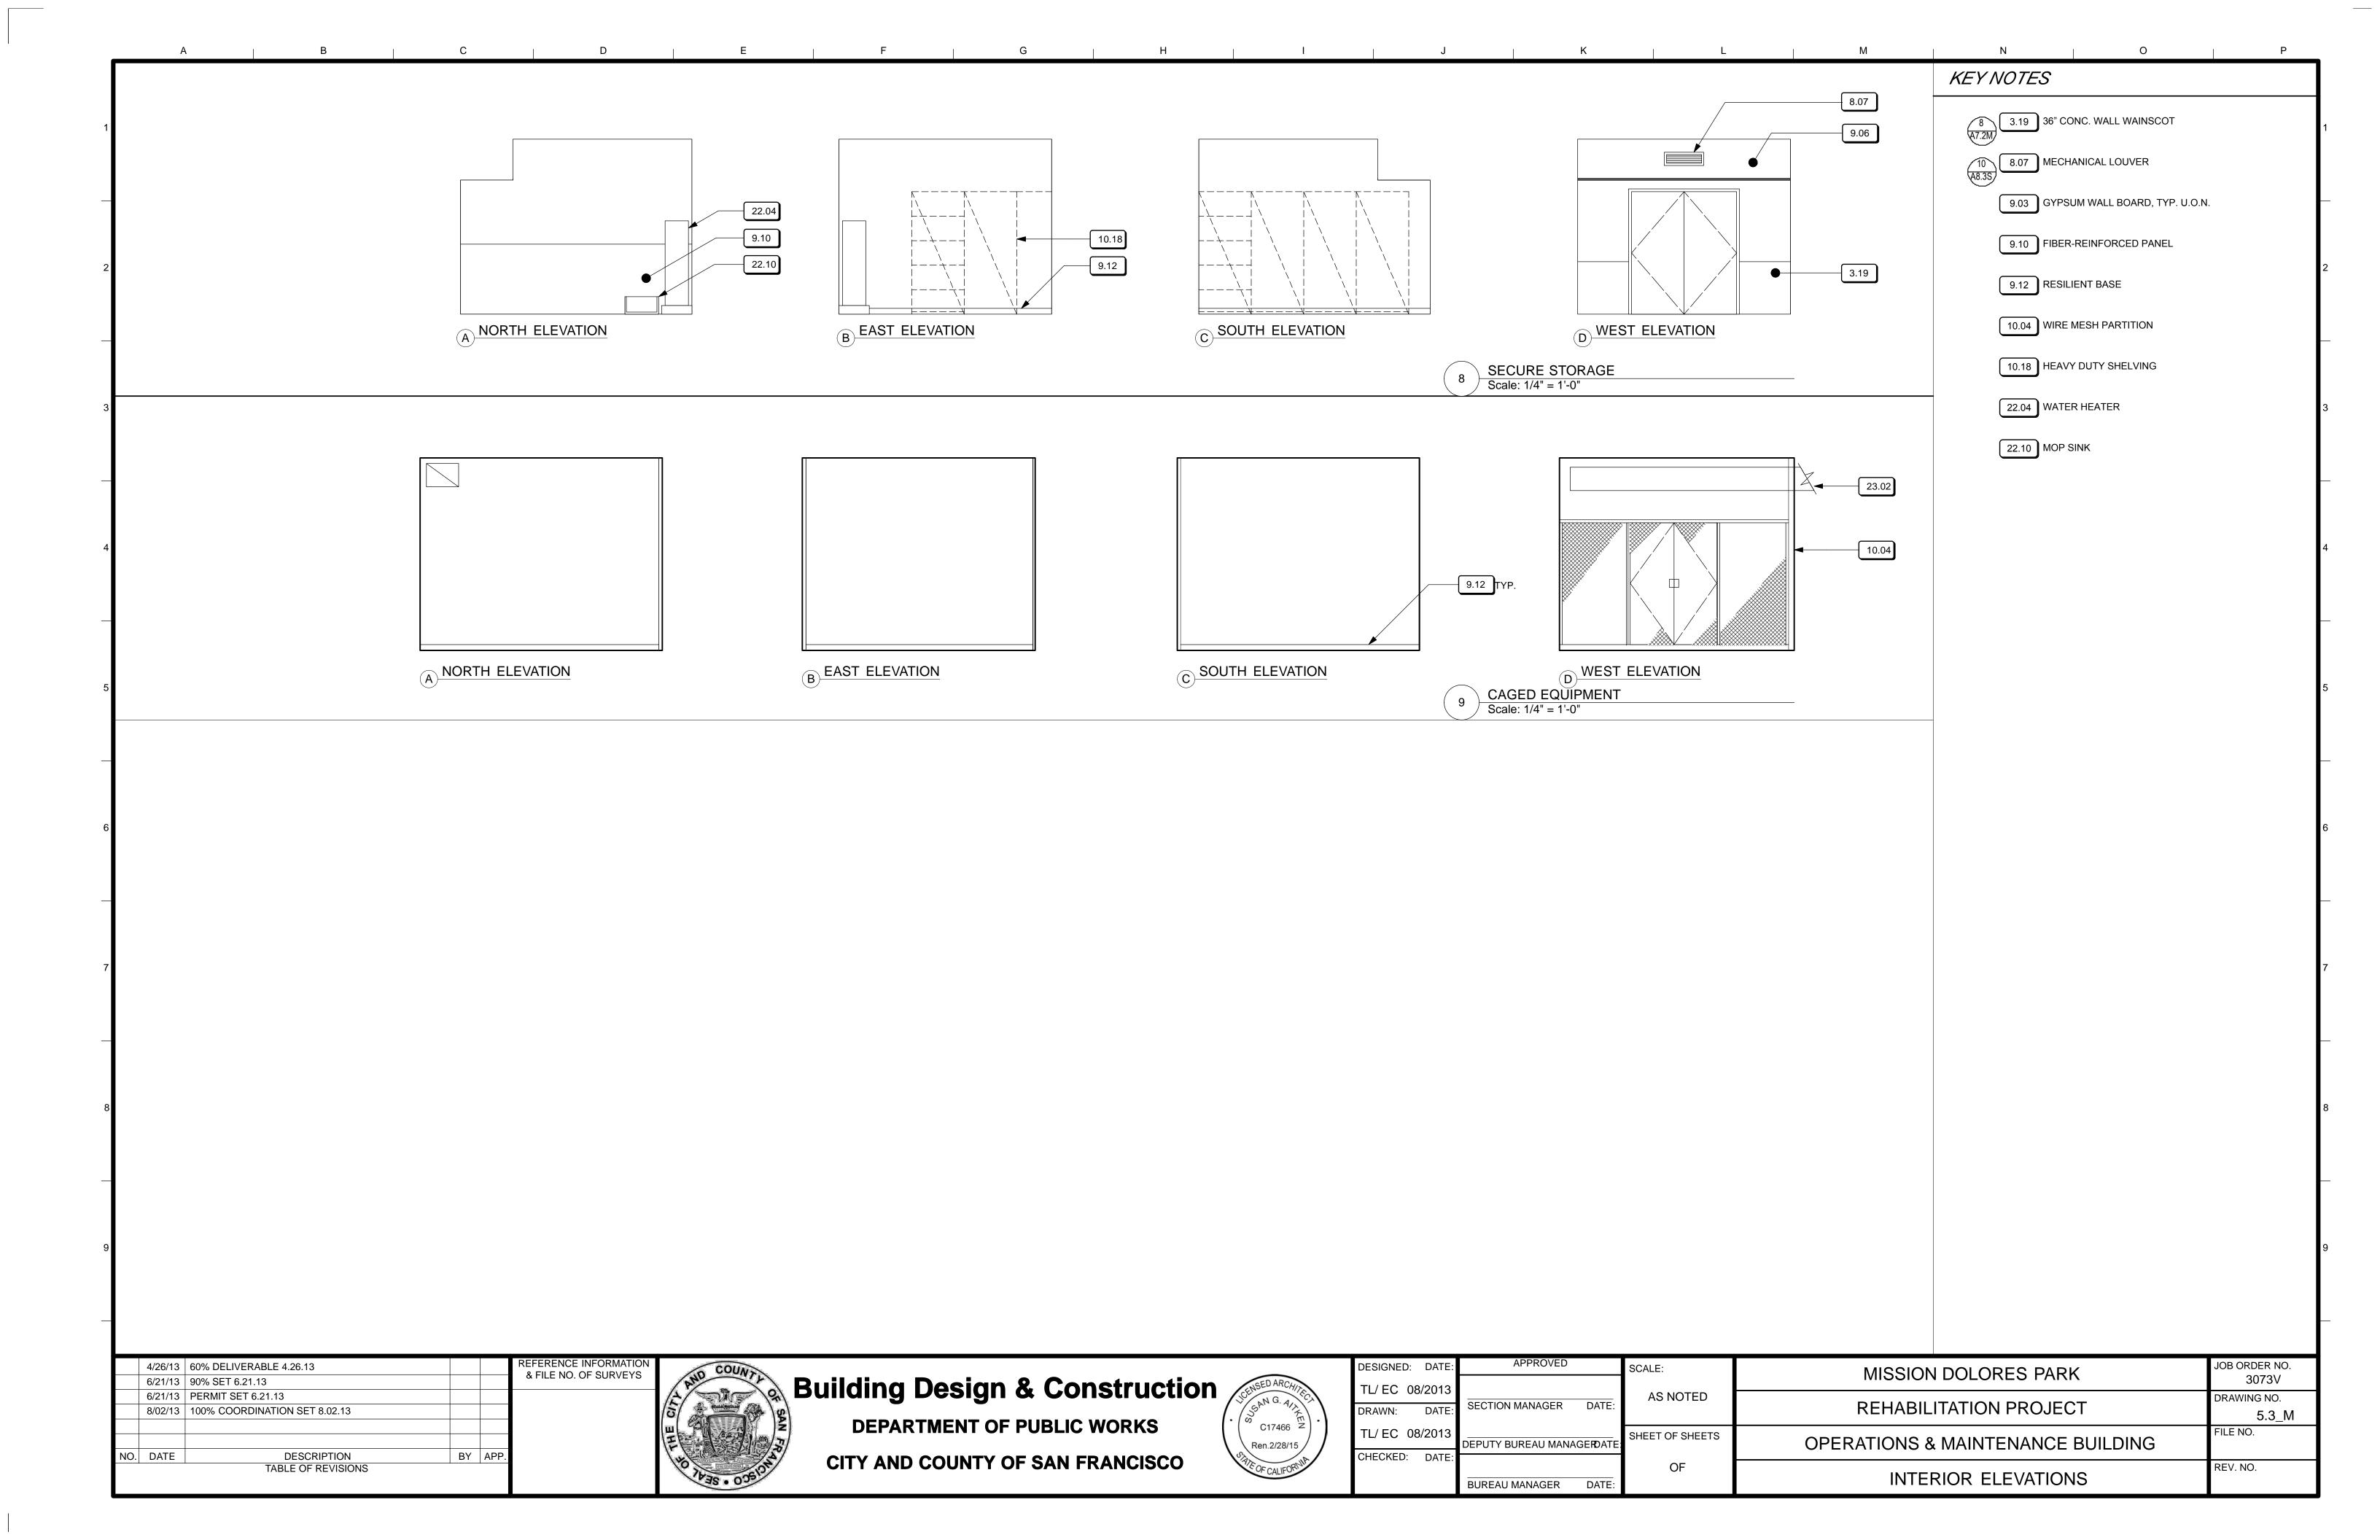


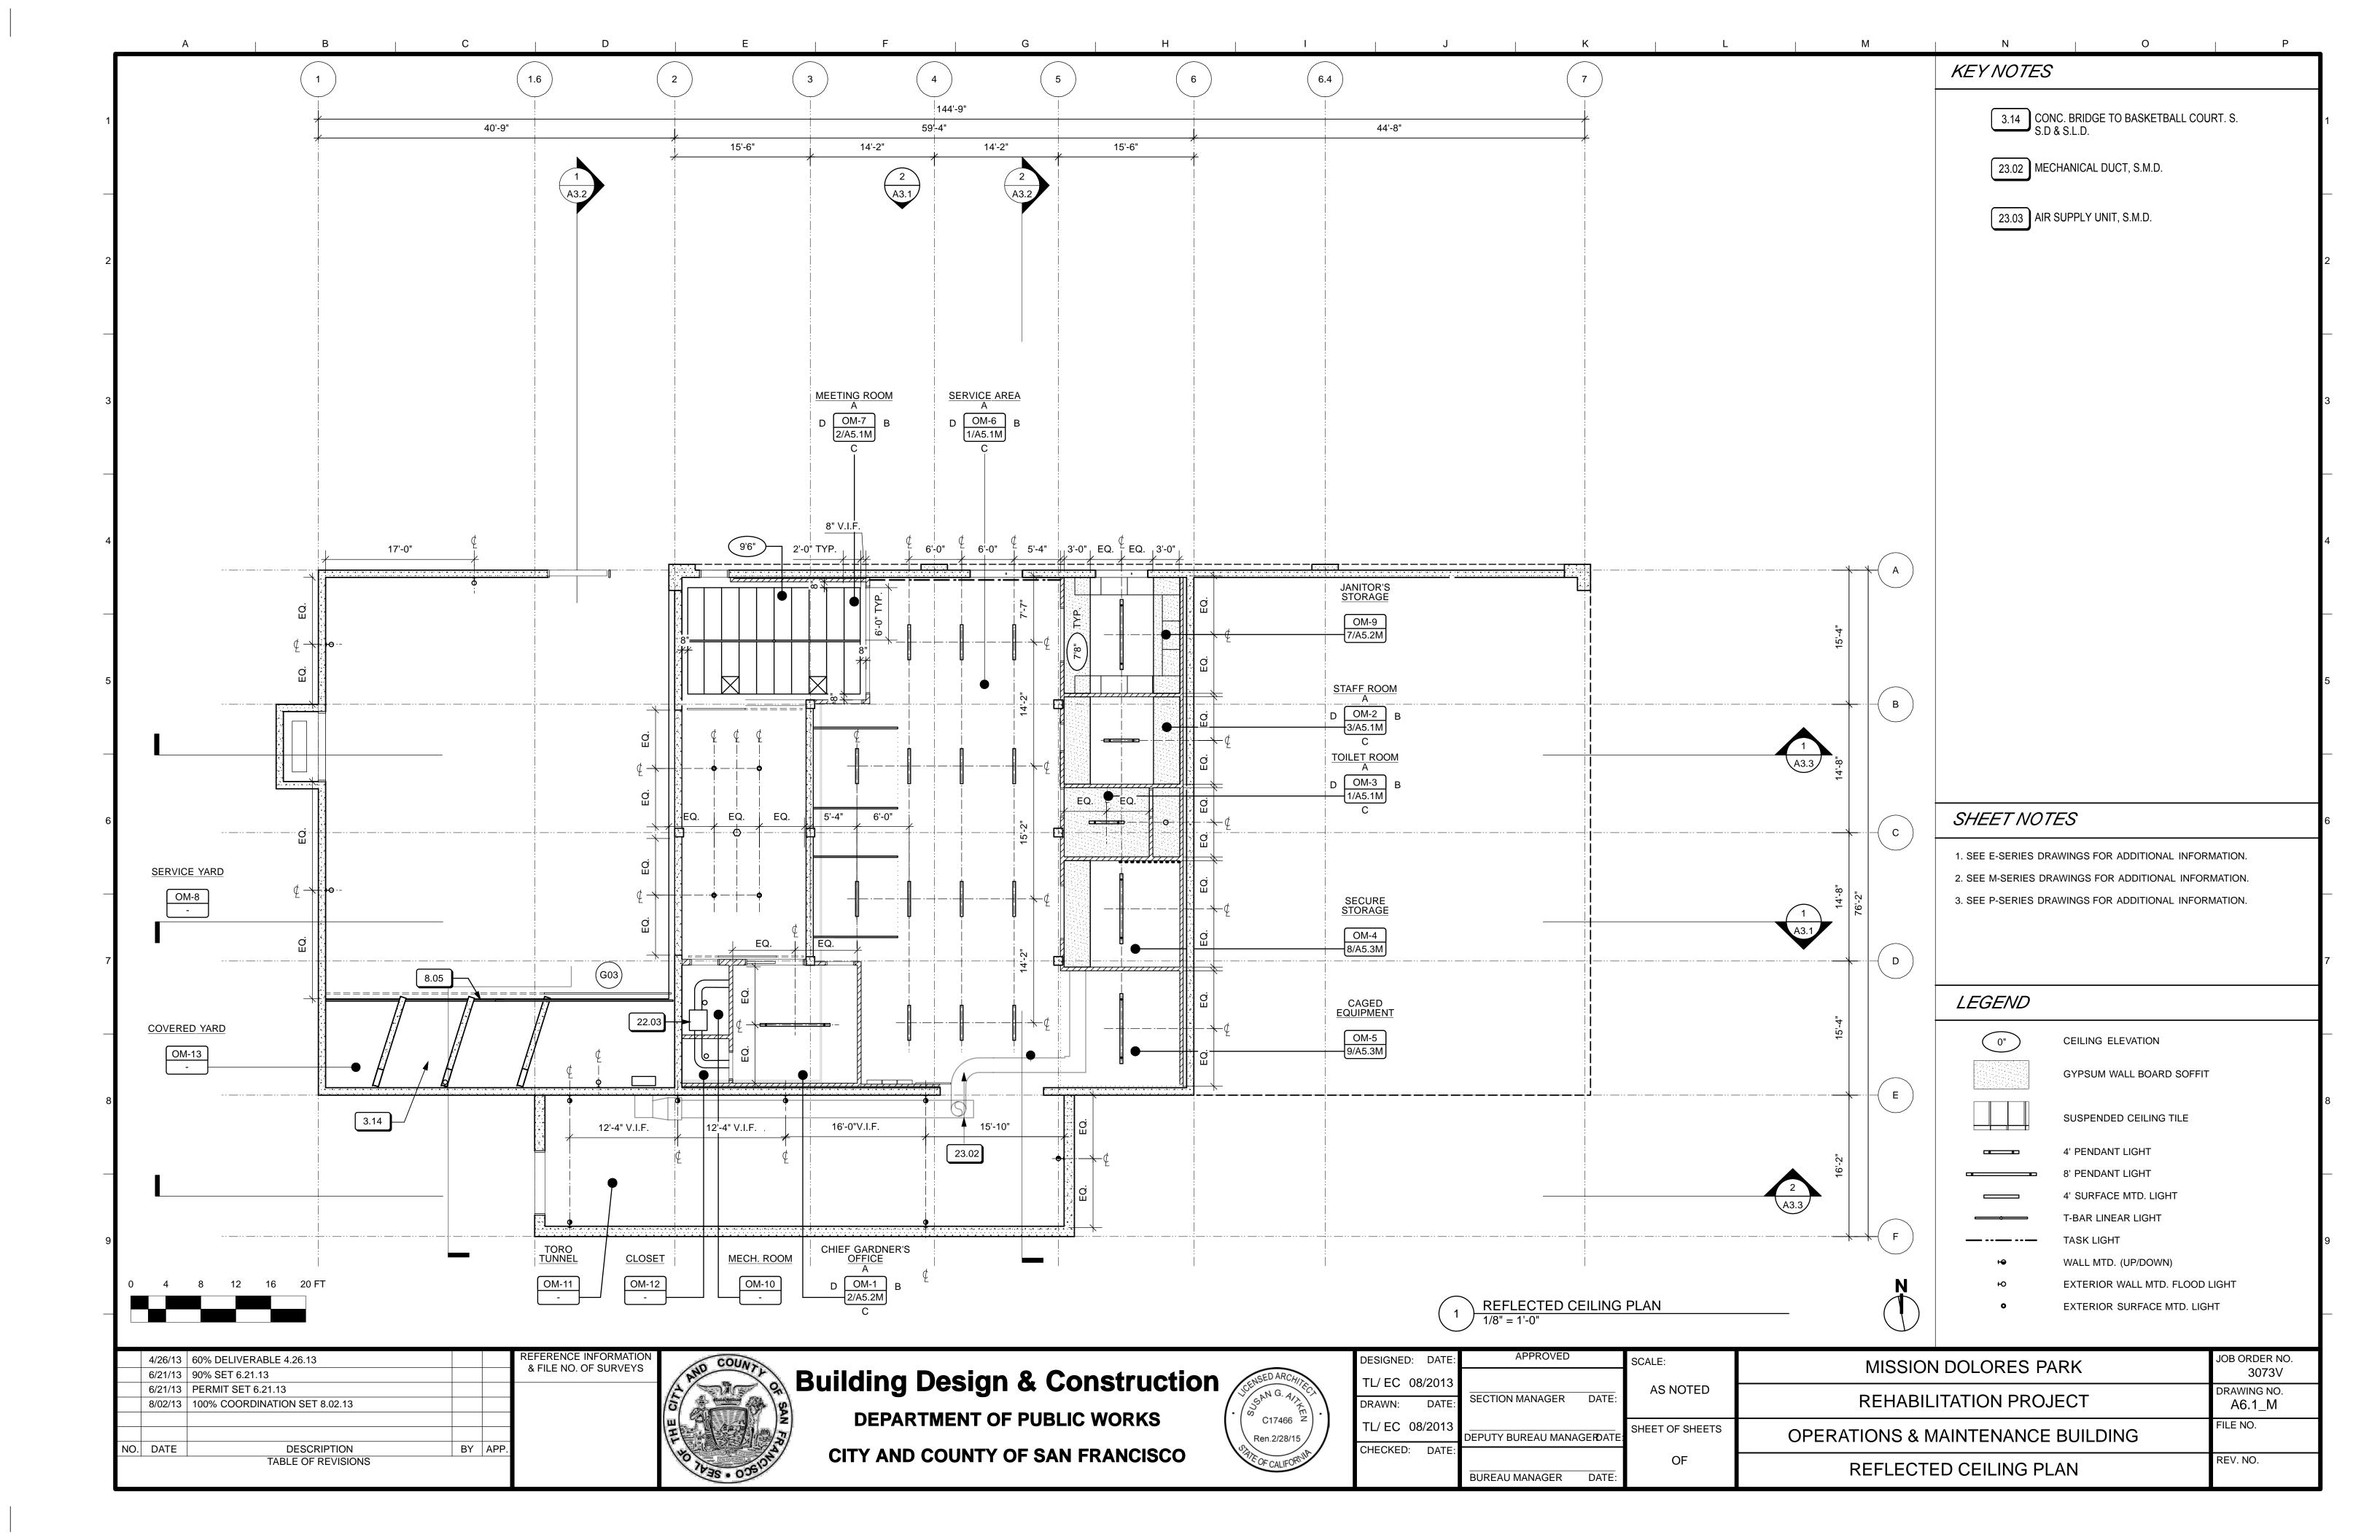

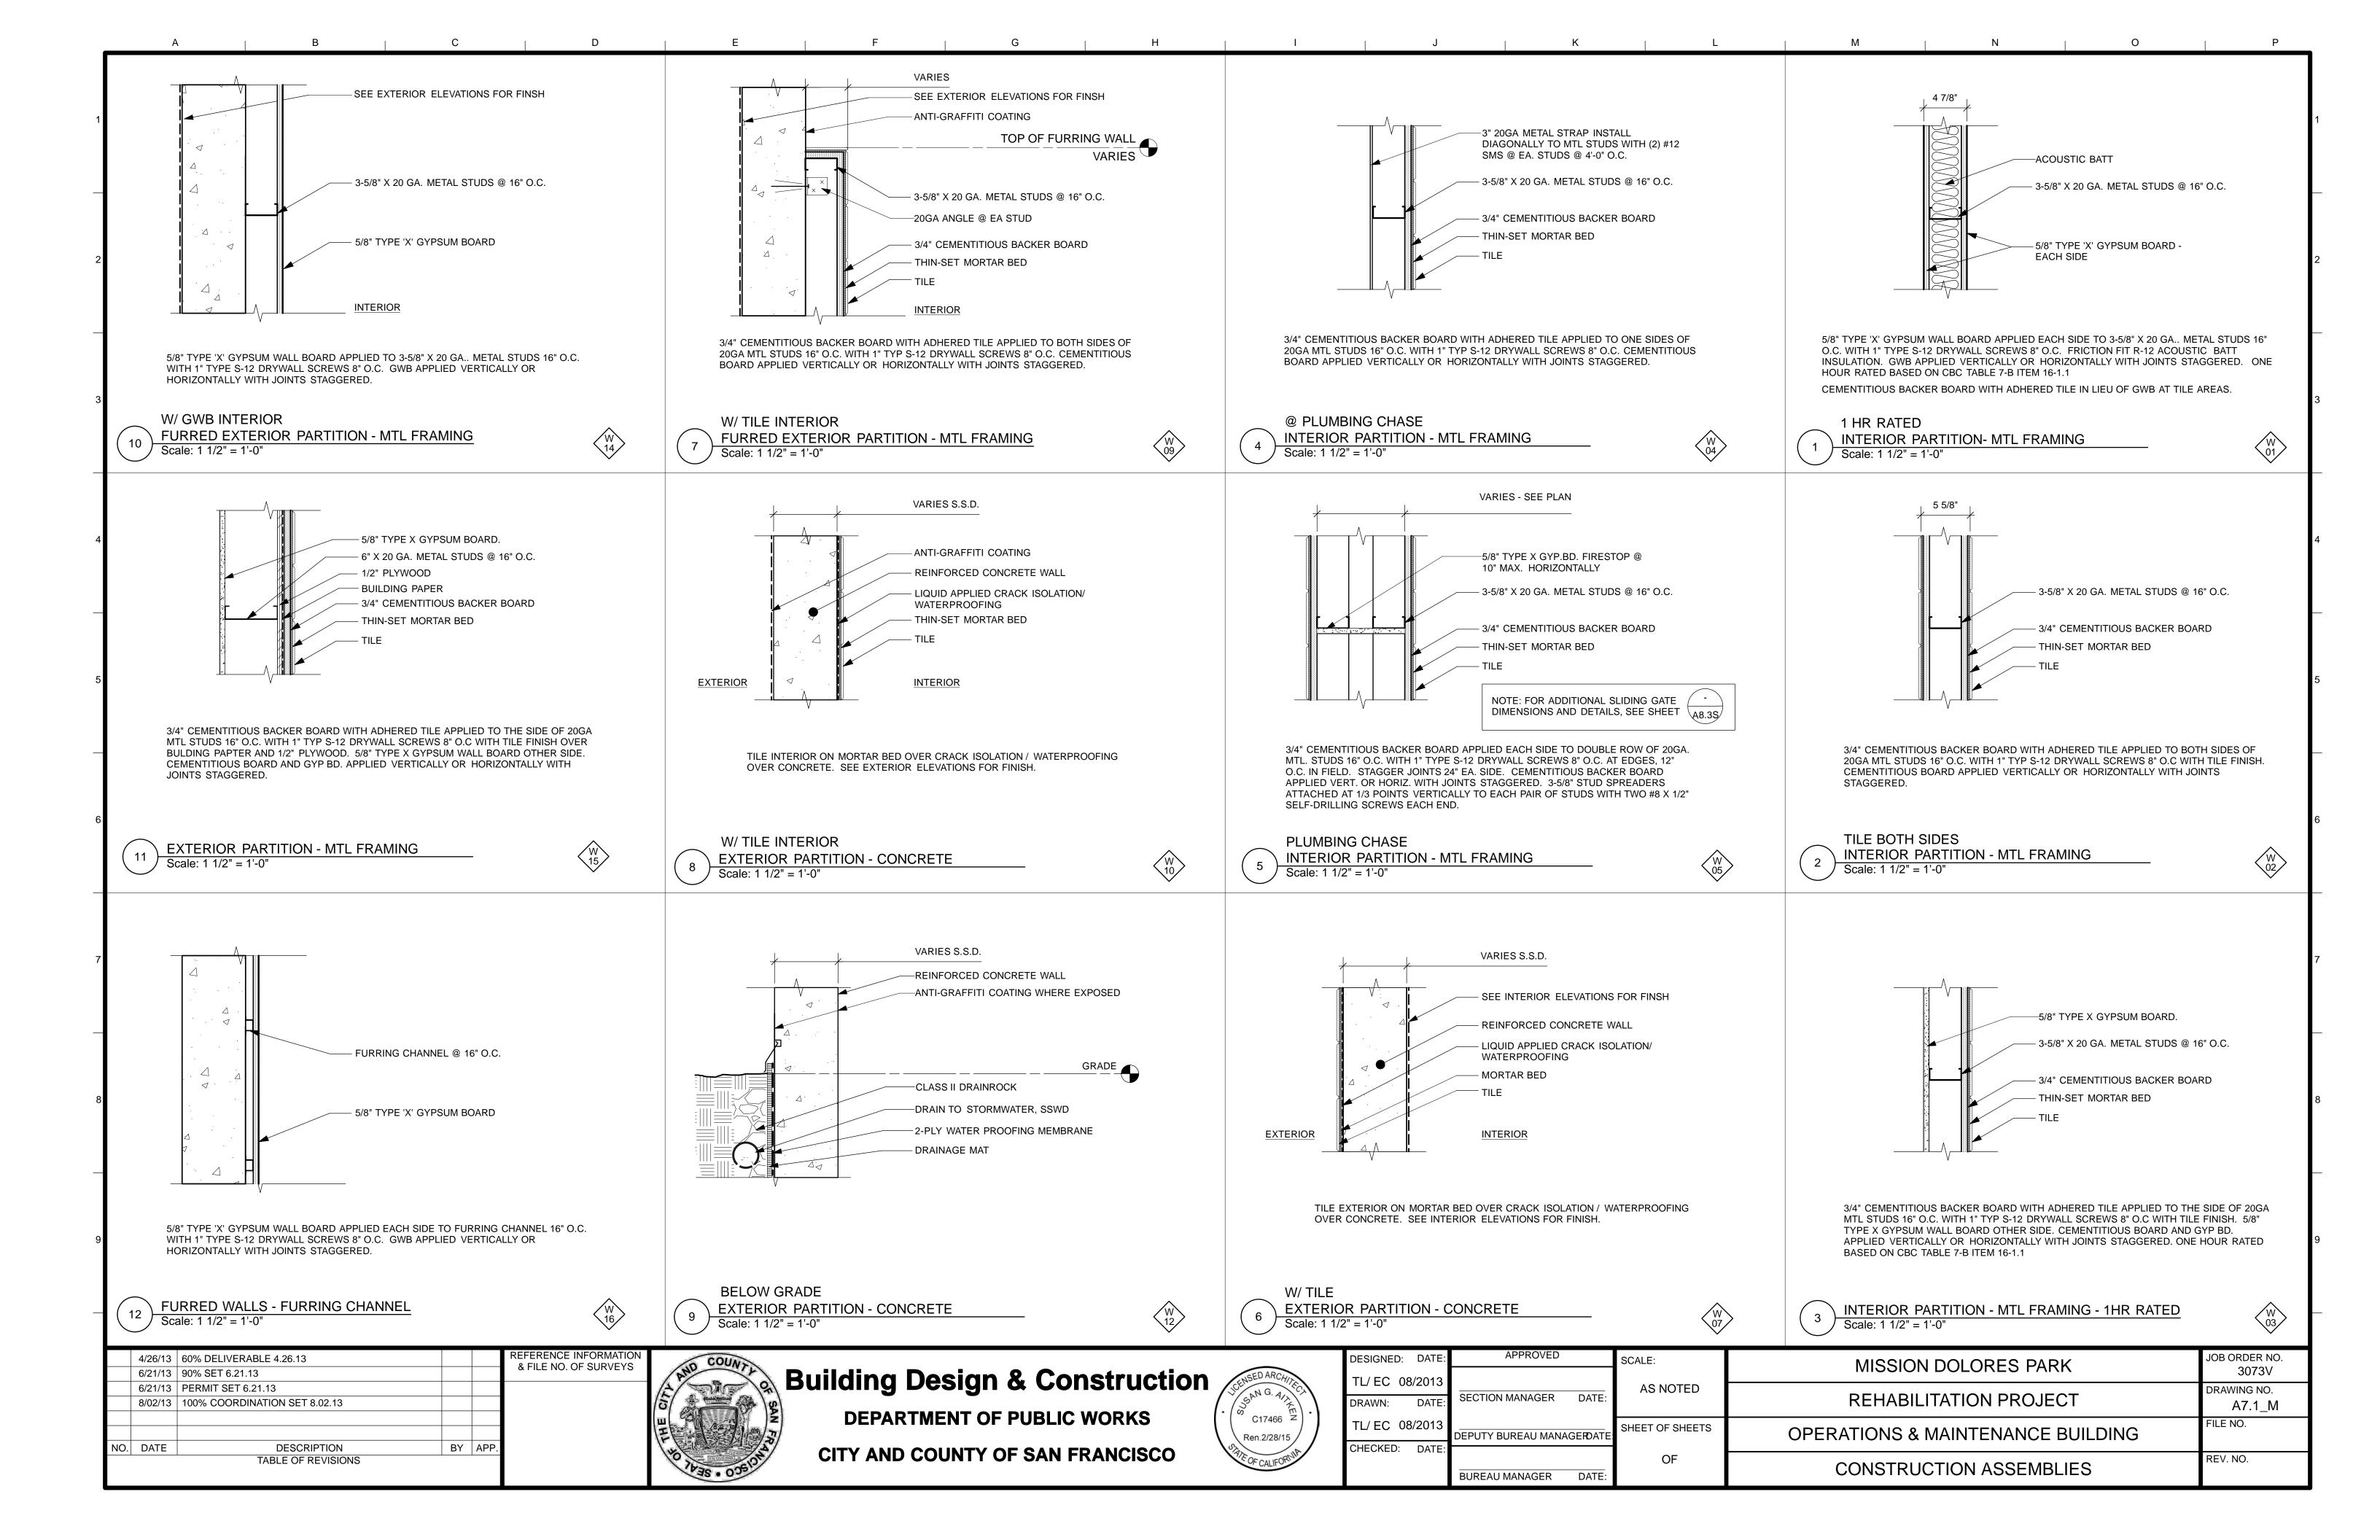

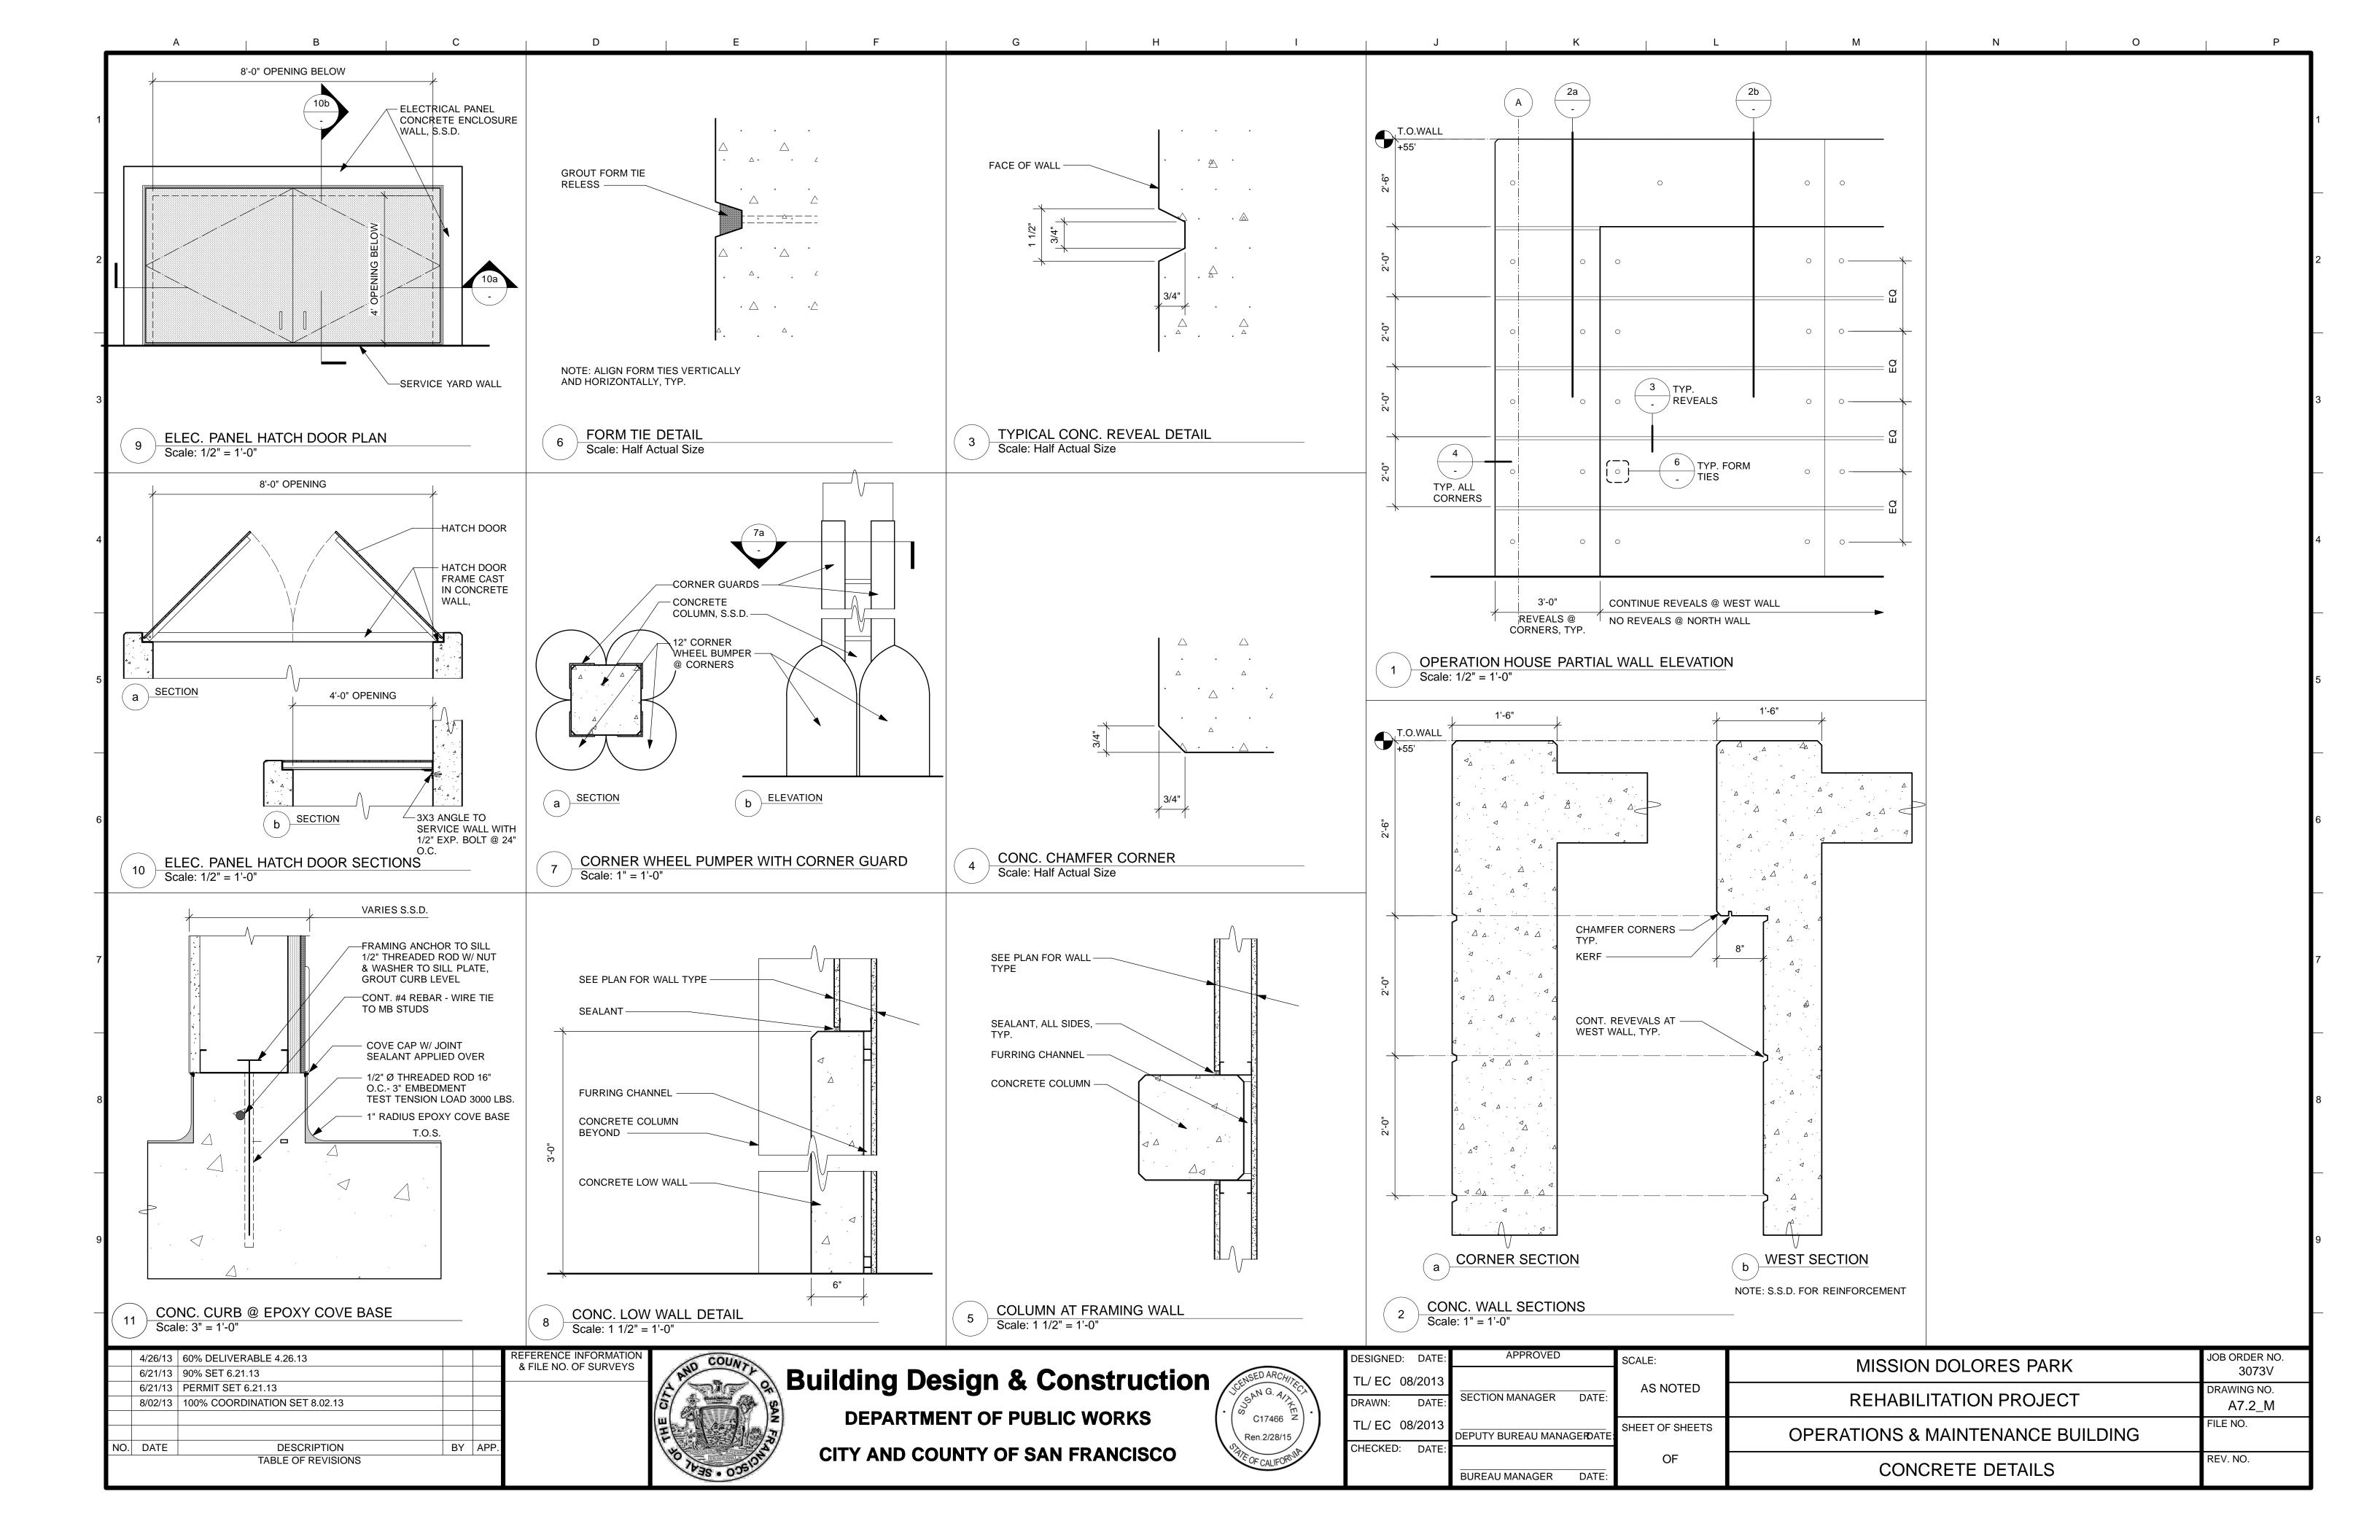

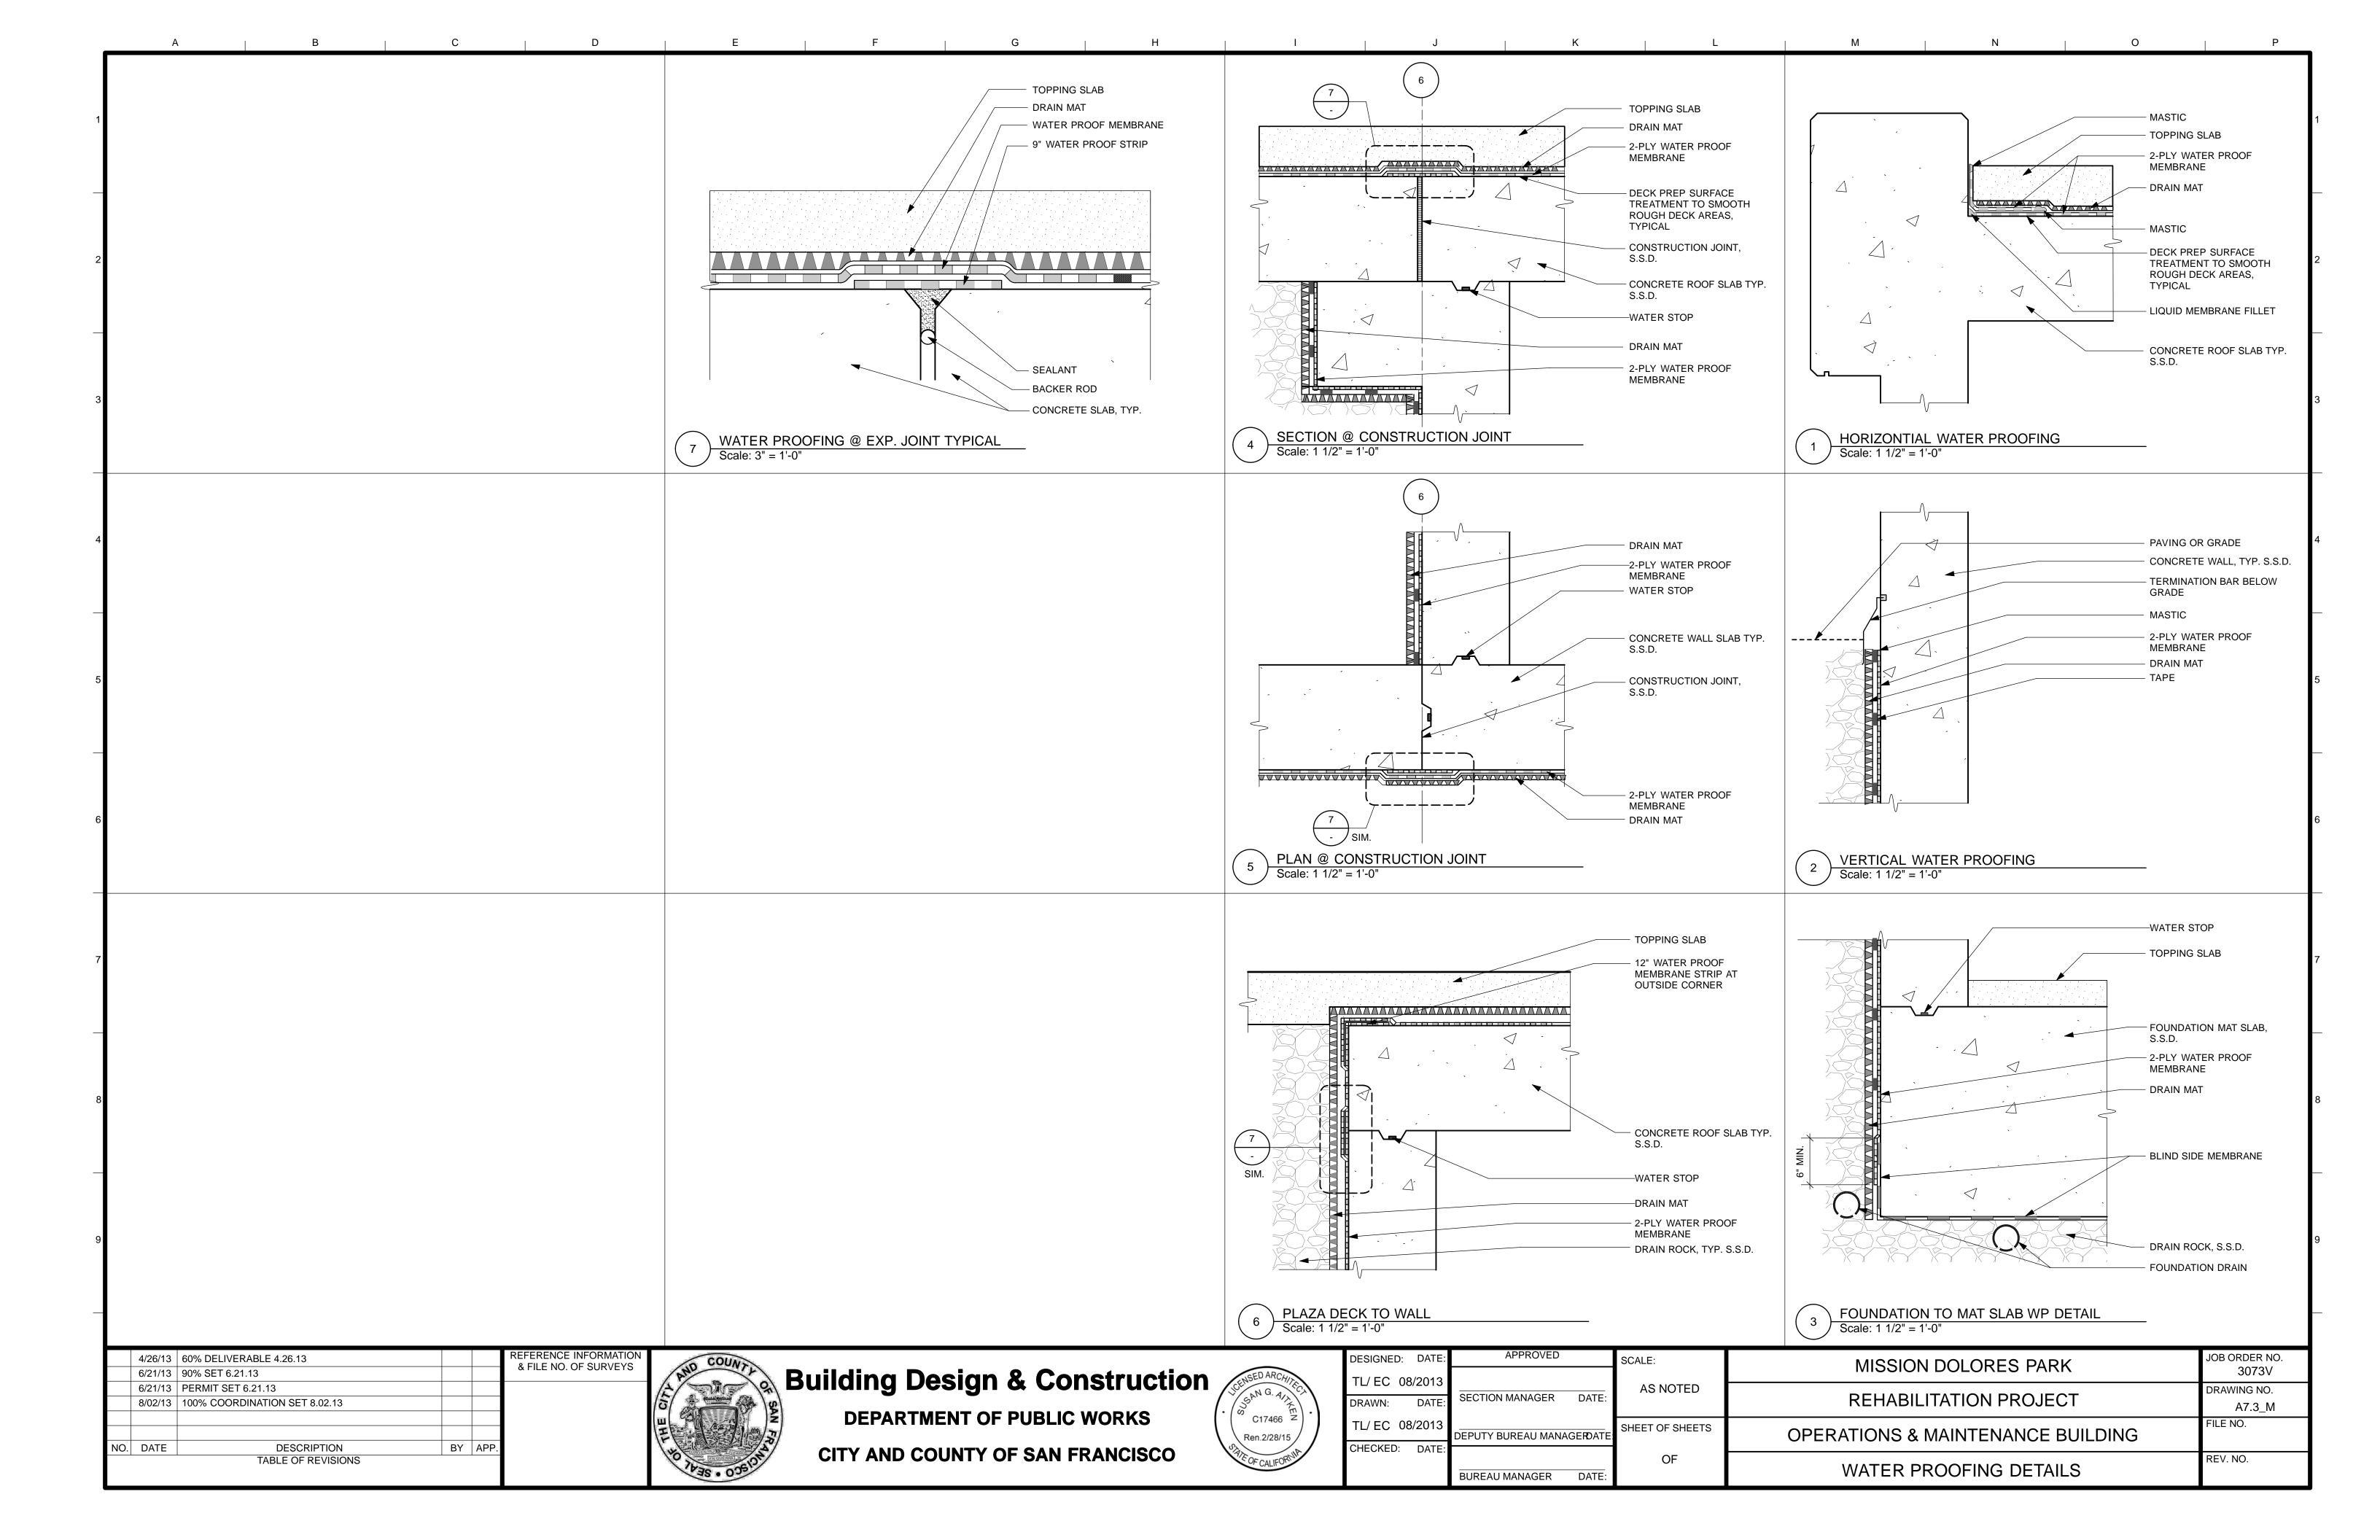

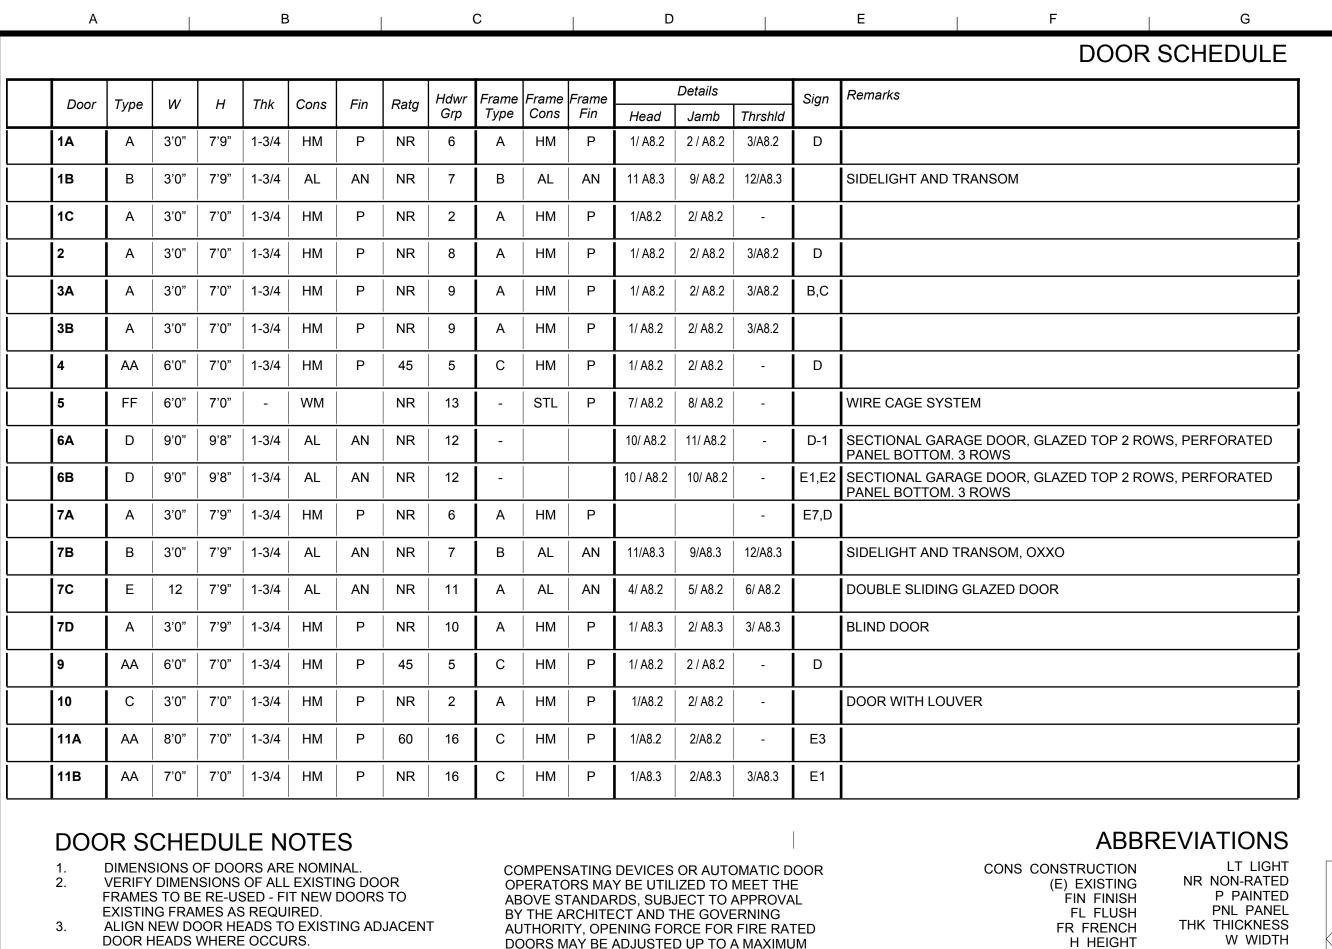

- ALL DOORS SHALL BE POSITIVE LATCHING W/ LEVER ACTING DOOR HARDWARE. ALL FIRE RATED DOORS SHALL HAVE PERIMETER SMOKE GASKETS AS REQUIRED, AND SELF-CLOSERS OR
- AUTOMATIC CLOSERS WITH SMOKE DETECTORS. ALL DOORS AND WINDOWS SHALL MEET THE MINIMUM INFILTRATION REQUIREMENTS PER SECTION 2.5311 B.E.E.S. ALL NEW EXTERIOR DOORS SHALL BE WEATHER-STRIPPED COMPLETELY.
- ALL EXIT DOORS SHALL BE OPENABLE FROM THE INSIDE WITHOUT THE USE OF A KEY OR ANY SPECIAL KNOWLEDGE OR EFFORT. NO DEADBOLTS, NO SLIDING BOLTS, ETC. (CBC SEC.
- ADJUST ALL DOOR OPENING FORCE TO THE MINIMUM REQUIRED FOR OPERATION. MAXIMUM EFFORT TO OPERATE ANY NEW DOORS SHALL NOT EXCEED 5 POUNDS FOR INTERIOR AND EXTERIOR DOORS, SUCH PULL OR PUSH EFFORT BEING APPLIED AT RIGHT ANGLES TO HINGED DOORS AND AT THE CENTER PLANE OF SLIDING OR FOLDING DOORS.


DOORS MAY BE ADJUSTED UP TO A MAXIMUM OF 15 POUNDS SUBJECT TO APPROVAL BY THE GOVERNING AUTHORITY.

ALL HAND-ACTIVATED DOOR OPENING HARDWARE SHALL BE CENTERED BETWEEN 30" AND 44" ABOVE THE FLOOR. SEE DOOR TYPES FOR DIMENSION. LATCHING AND LOCKING DOORS THAT ARE HAND ACTIVATED AND WHICH ARE IN A PATH OF TRAVEL SHALL BE OPERABLE WITH A SINGLE EFFORT BY LEVER TYPE HARDWARE. LOCKED DOORS SHALL OPERATE AS ABOVE IN THE EGRESS

DIRECTION. THE BOTTOM 10 INCHES OF ALL NEW DOORS EXCEPT AUTOMATIC AND SLIDING DOORS SHALL HAVE A SMOOTH UNINTERRUPTED SURFACE TO ALLOW THE DOOR TO BE OPENED BY A WHEELCHAIR FOOTREST WITHOUT CREATING A TRAP OR HAZARDOUS CONDITION. WHERE NARROW FRAME DOORS ARE USED, A 10" HIGH SMOOTH BOTTOM RAIL SHALL BE INSTALLED.

ALL GLAZING IN DOORS SHALL BE SAFETY GLASS, OR WIRED GLASS WHERE REQUIRED. HM HOLLOW METAL WM WIRE MESH WD WOOD


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24" MIN. @ EXT.

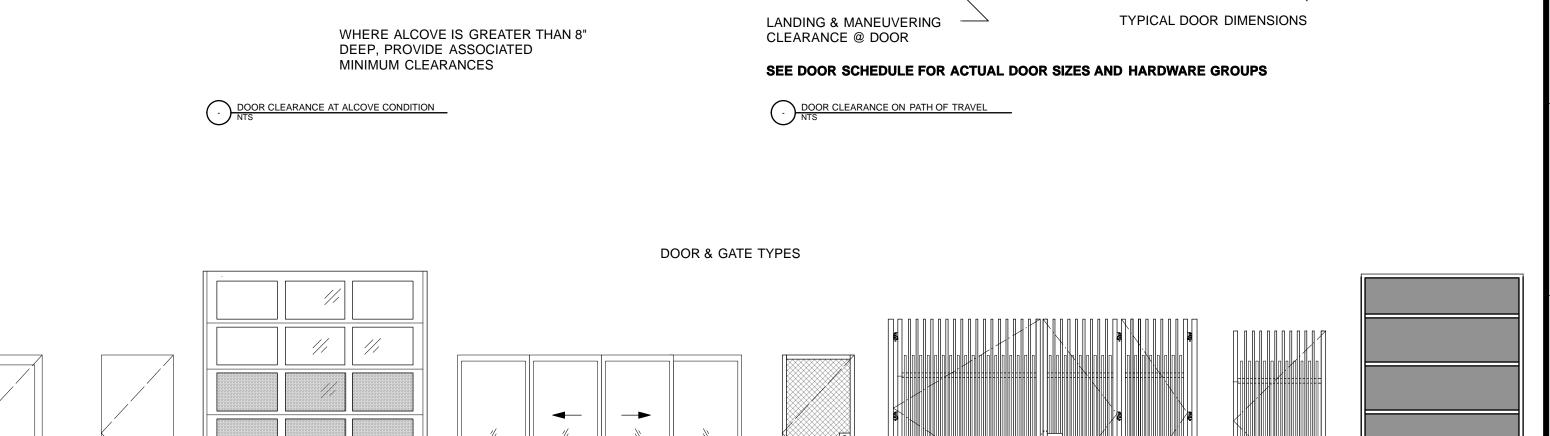18" MIN. @ INT.

32" CLEAR



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<u> 24" MIN @</u>EXT 
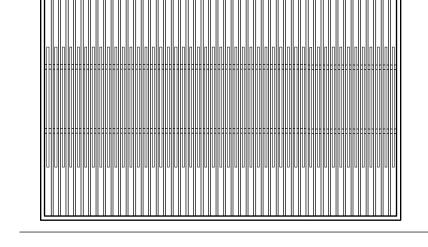
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#### **GATE SCHEDULE**

Coto	T	W			Fin	Hdwr	Details			Signage	Remarks
Gate	ate Type		Н	Cons		Grp	Head	Jamb	Thrshld		
G01	G	20'0"	9'8"	STL	Р						VEHICLE GATE WITH PERSONNEL LEAF / SEE DETAIL 6/A8.4M FOR DETAILS
G02	НН	8'0"	7'6"	STL	Р						UTILITY GATE FOR ELECTRICAL PANEL DETAIL SIM. TO 6/A8.4M
G03	К	15'	9'2"	STL	Р						SLIDING GATE, SEE DETAIL 2/A8.4M
G04	J	6'-9"	9'0"	STL	Р						BARN DOOR WITH STEEL FRAME AND PERFORATED METAL PANEL FILLS, SEE DETAIL 5/A8.4M


VERIFY DIMENSIONS AT ALL EXISTING GATE OPENINGS TO BE RE-USED - FIT NEW GATES TO ALL HAND-ACTIVATED GATE OPENING HARDWARE SHALL BE CENTERED BETWEEN 30" AND 44" ABOVE THE FLOOR. LATCHING AND LOCKING GATES THAT ARE HAND ACTIVATED AND WHICH ARE IN A PATH OF TRAVEL SHALL BE OPERABLE WITH A SINGLE EFFORT BY LEVER TYPE HARDWARE. LOCKED GATES SHALL OPERATE AS ABOVE IN THE EGRESS

THE BOTTOM 10 INCHES OF ALL NEW GATES SHALL HAVE A SMOOTH UNINTERRUPTED SURFACE TO ALLOW THE GATE TO BE OPENED BY A WHEELCHAIR FOOTREST WITHOUT CREATING A TRAP OR HAZARDOUS CONDITION.

**DEPARTMENT OF PUBLIC WORKS** 

**CITY AND COUNTY OF SAN FRANCISCO** 

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#### GATE SCHEDULE NOTES

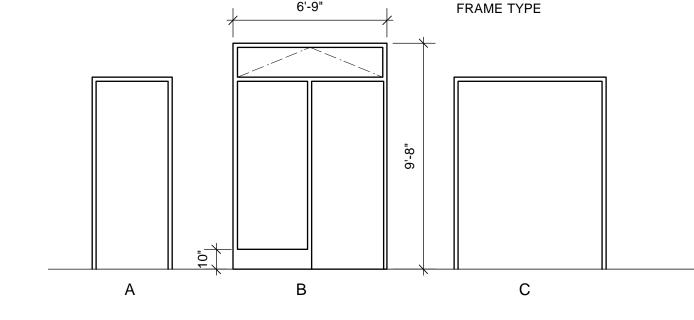
DIMENSIONS OF GATES ARE NOMINAL. EXISTING OPENINGS AS REQUIRED.


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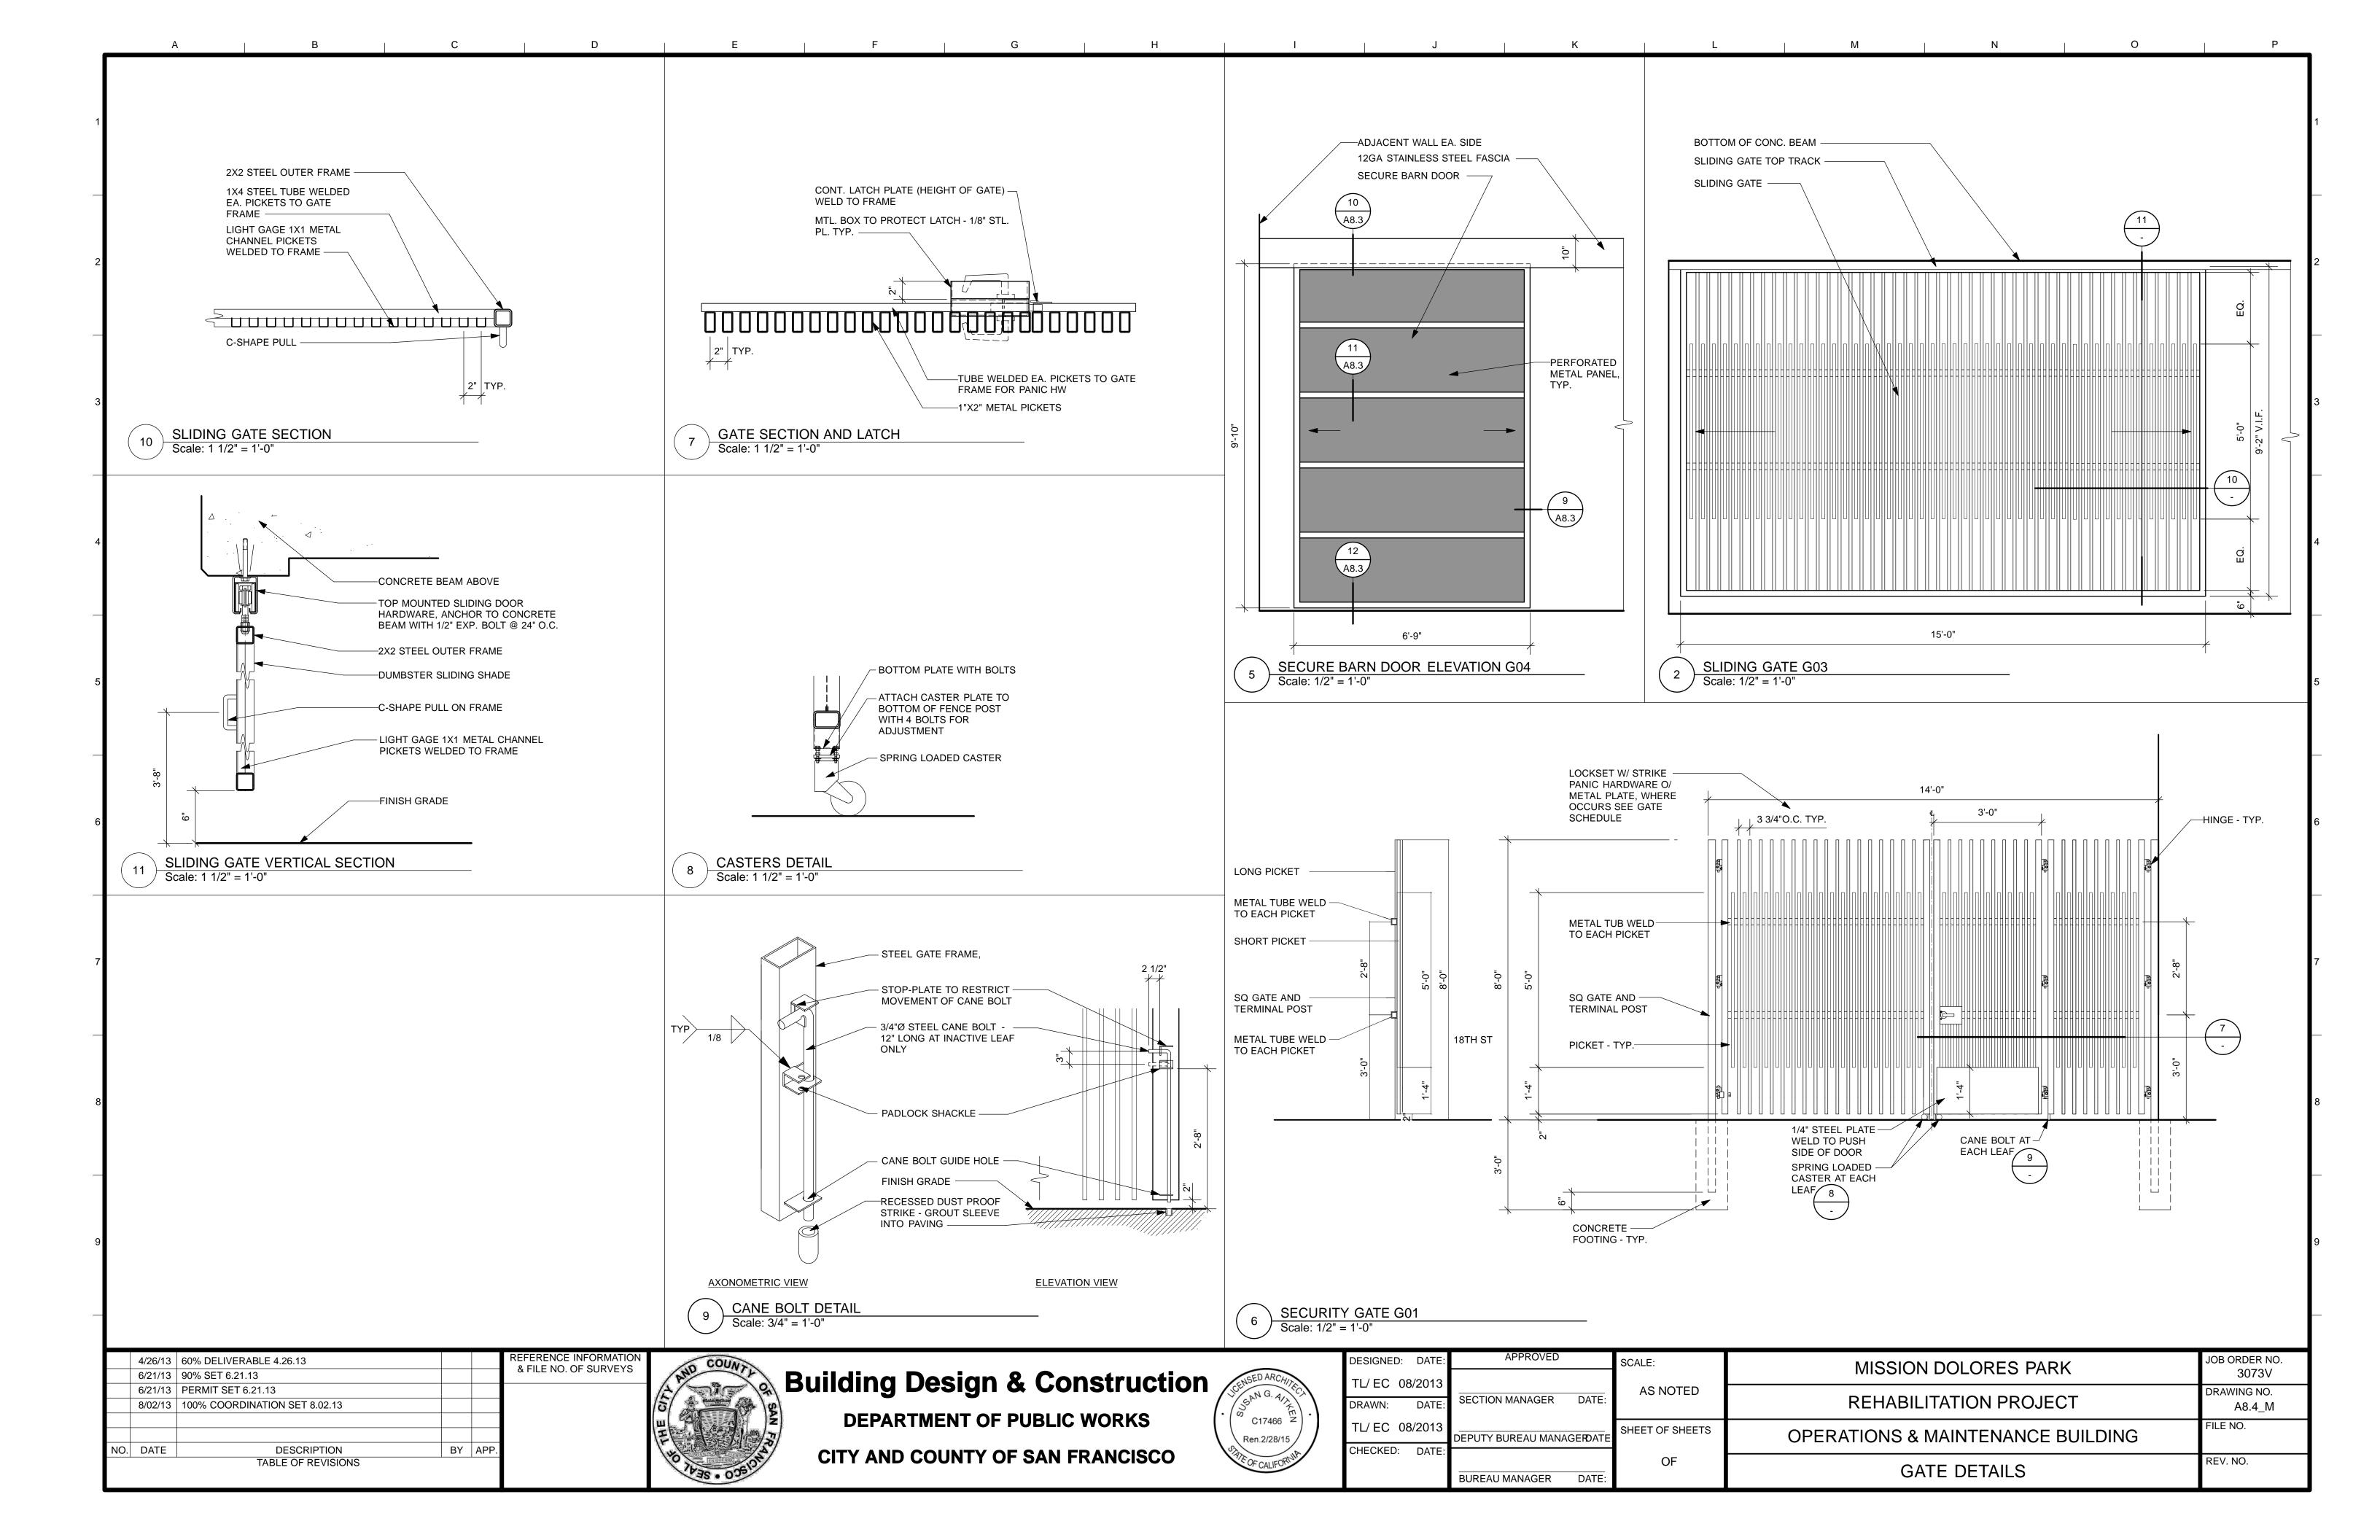
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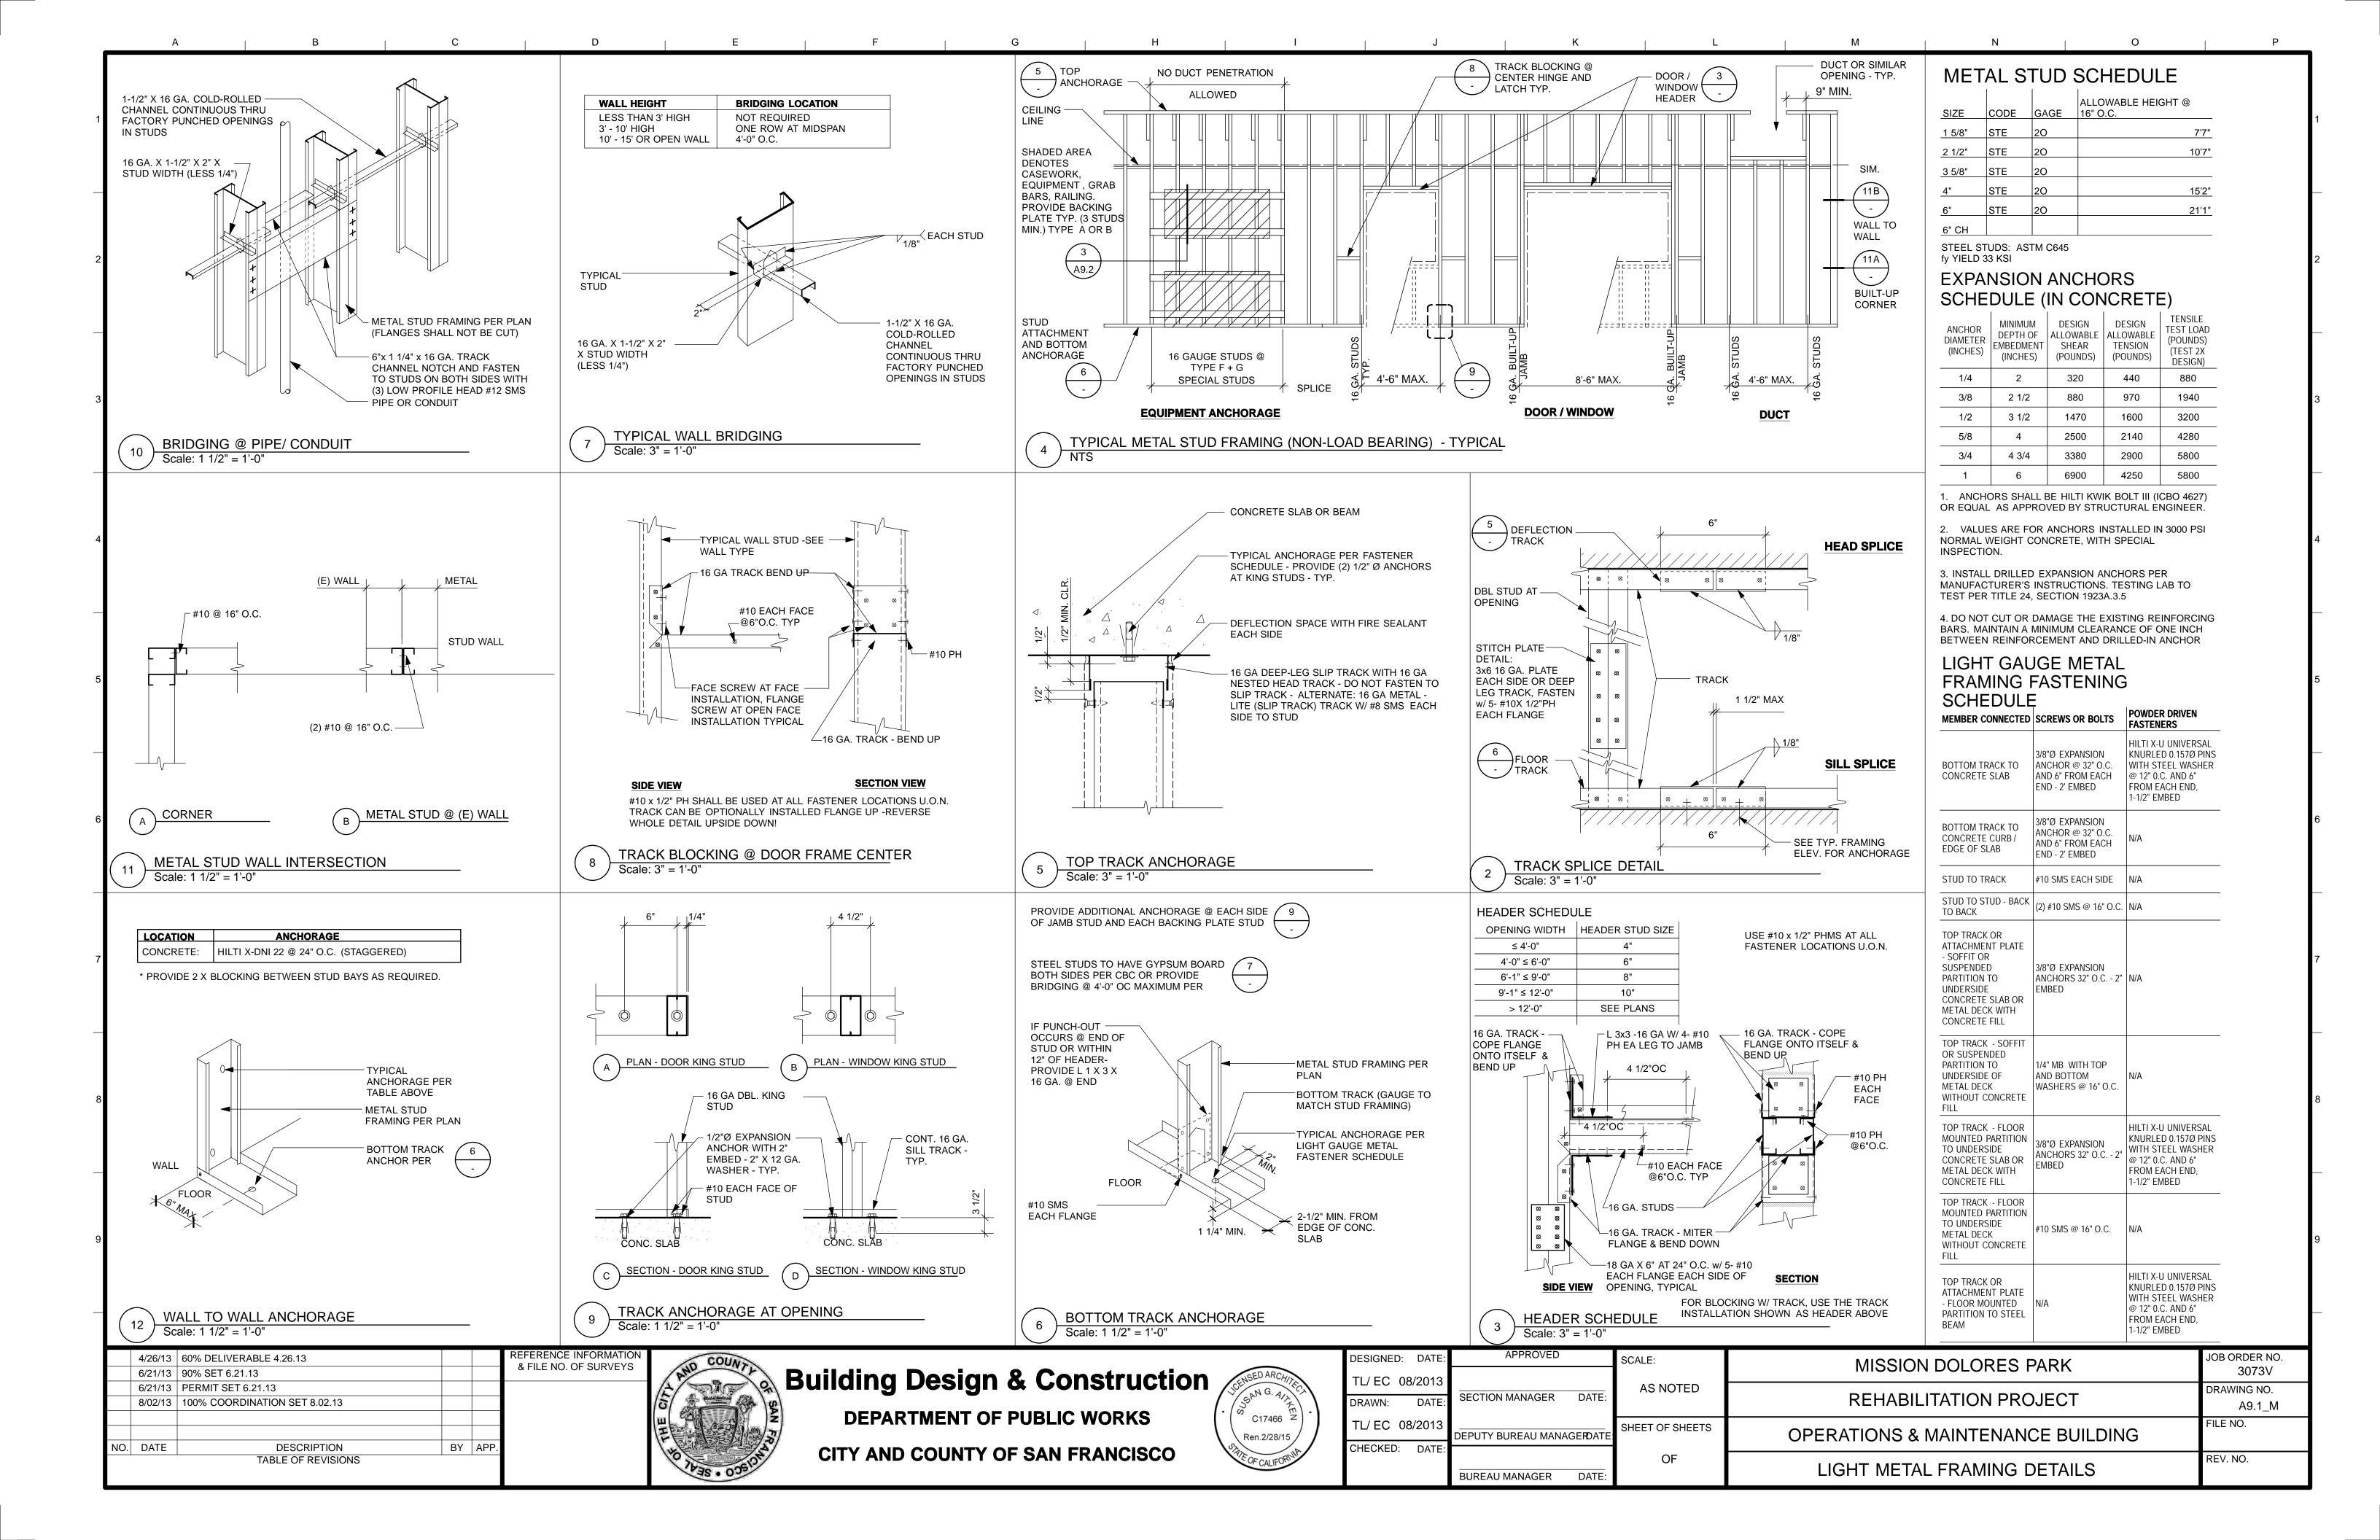
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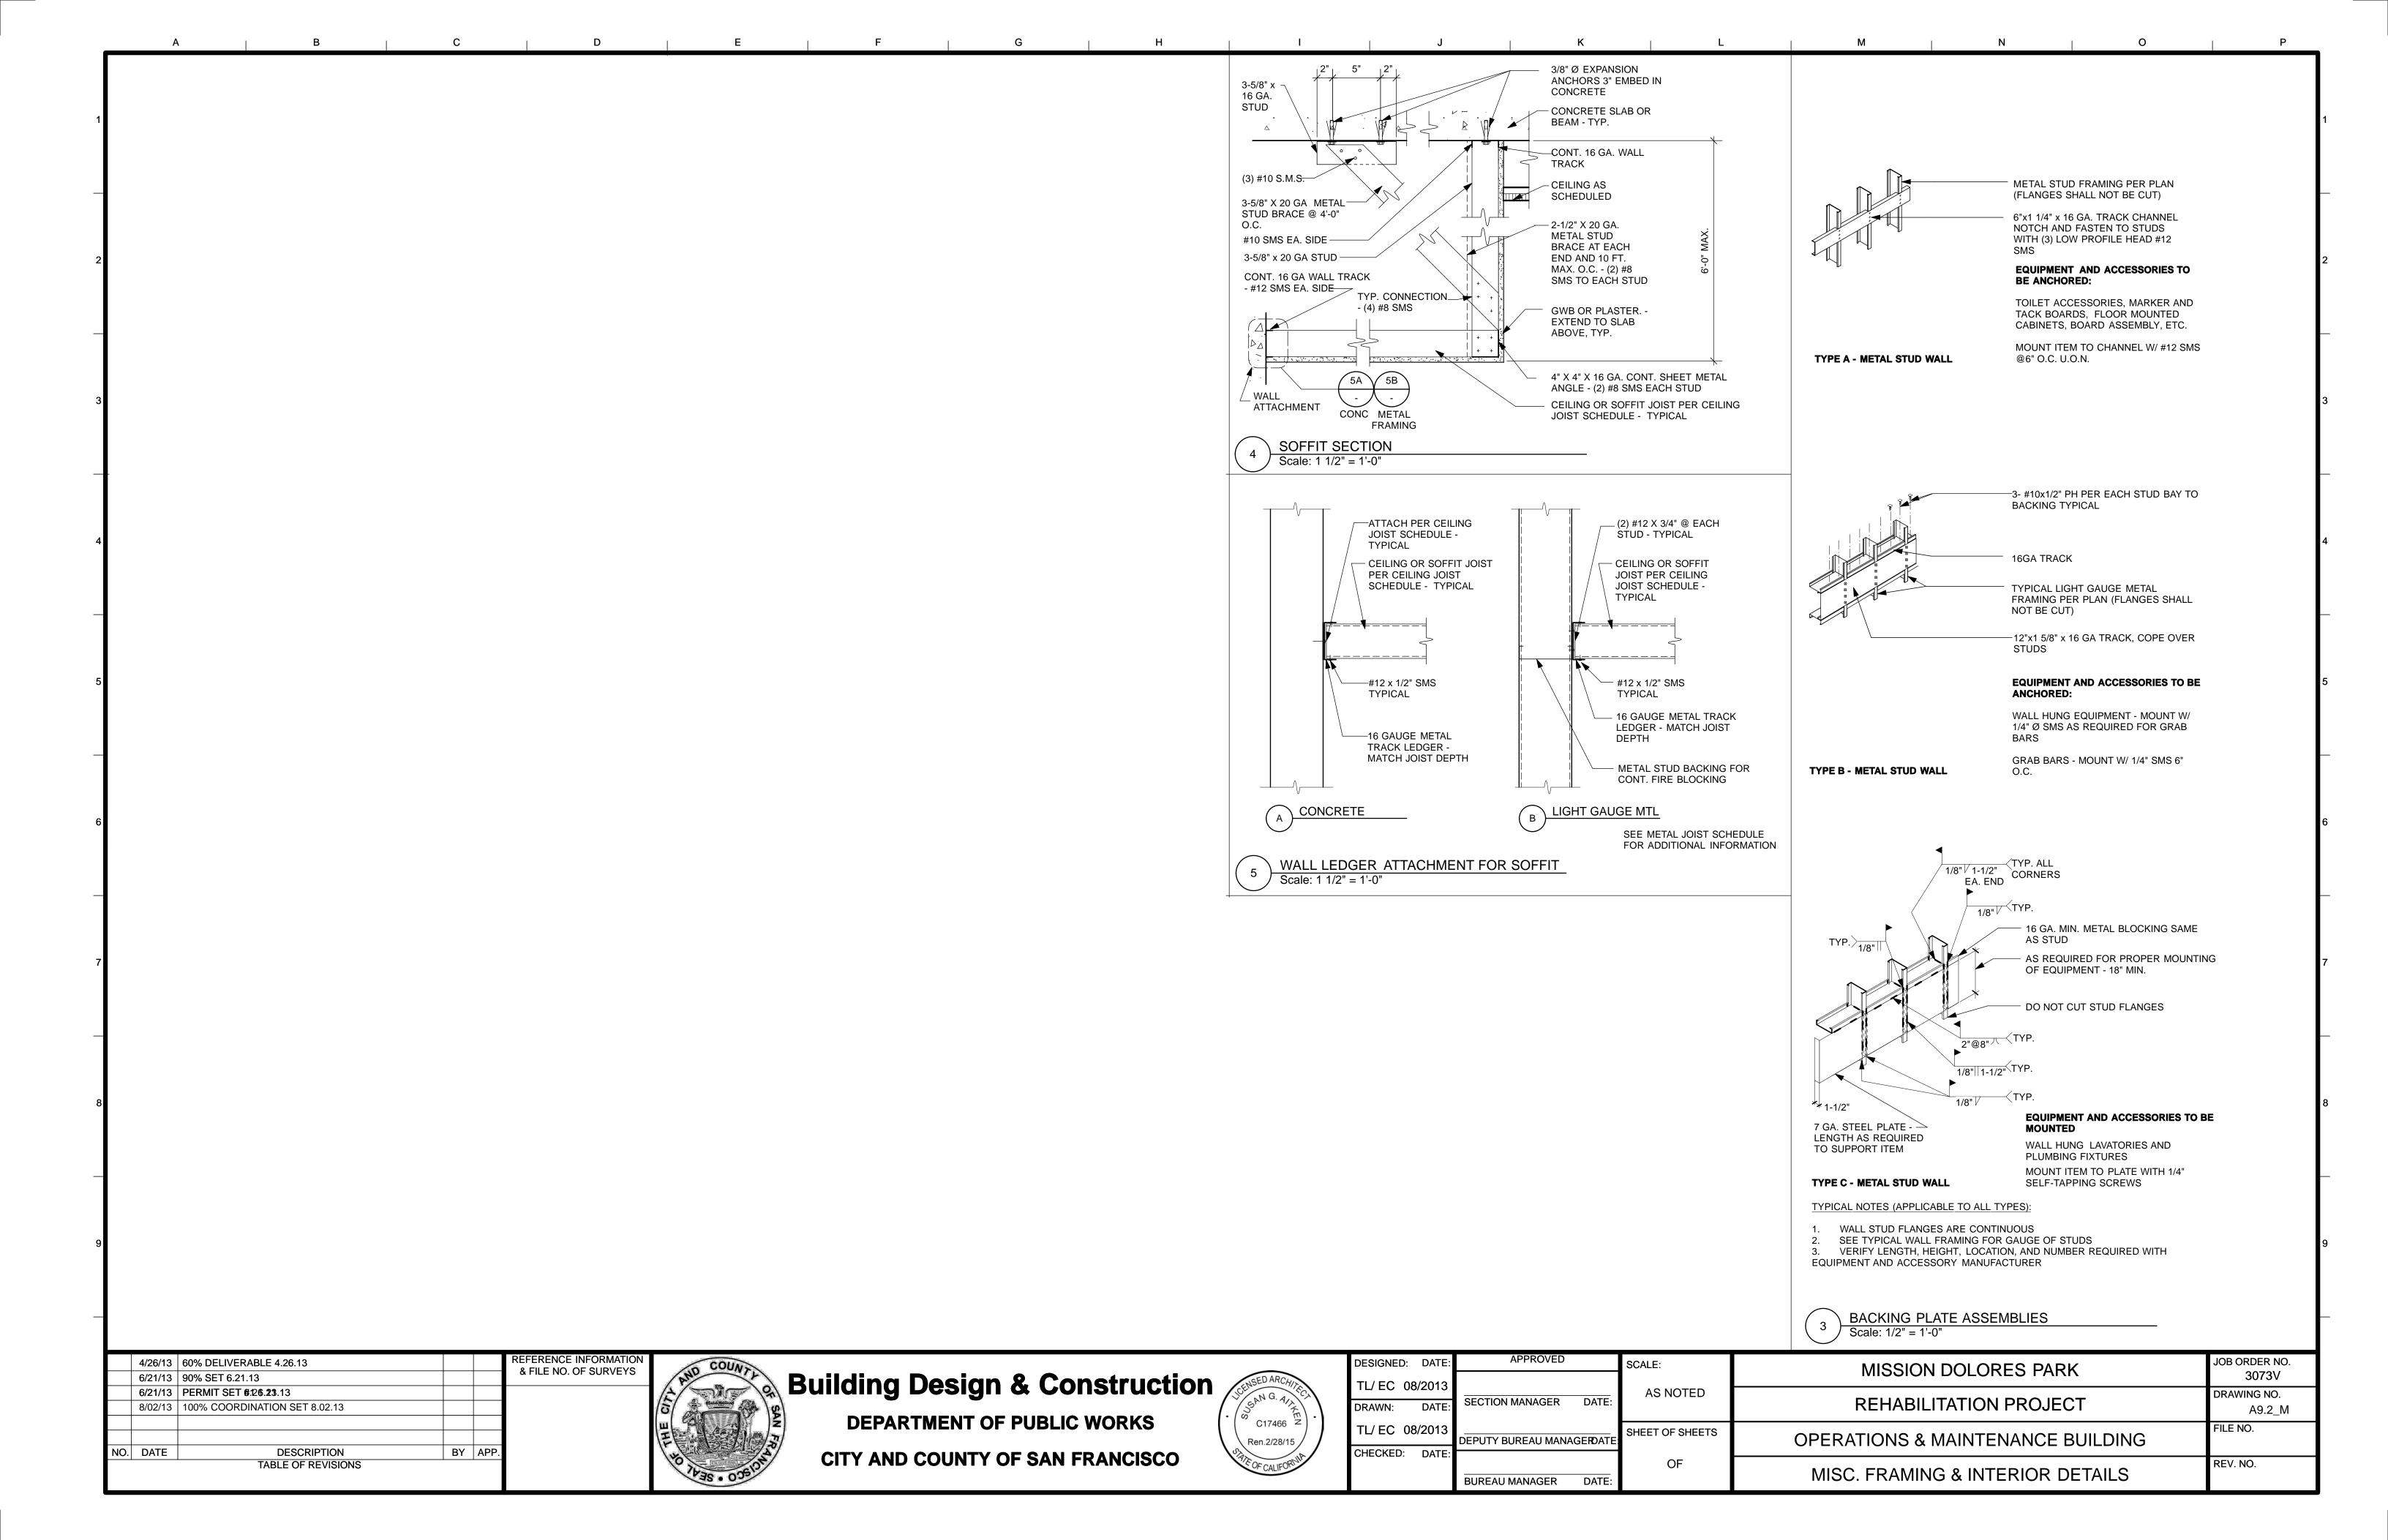
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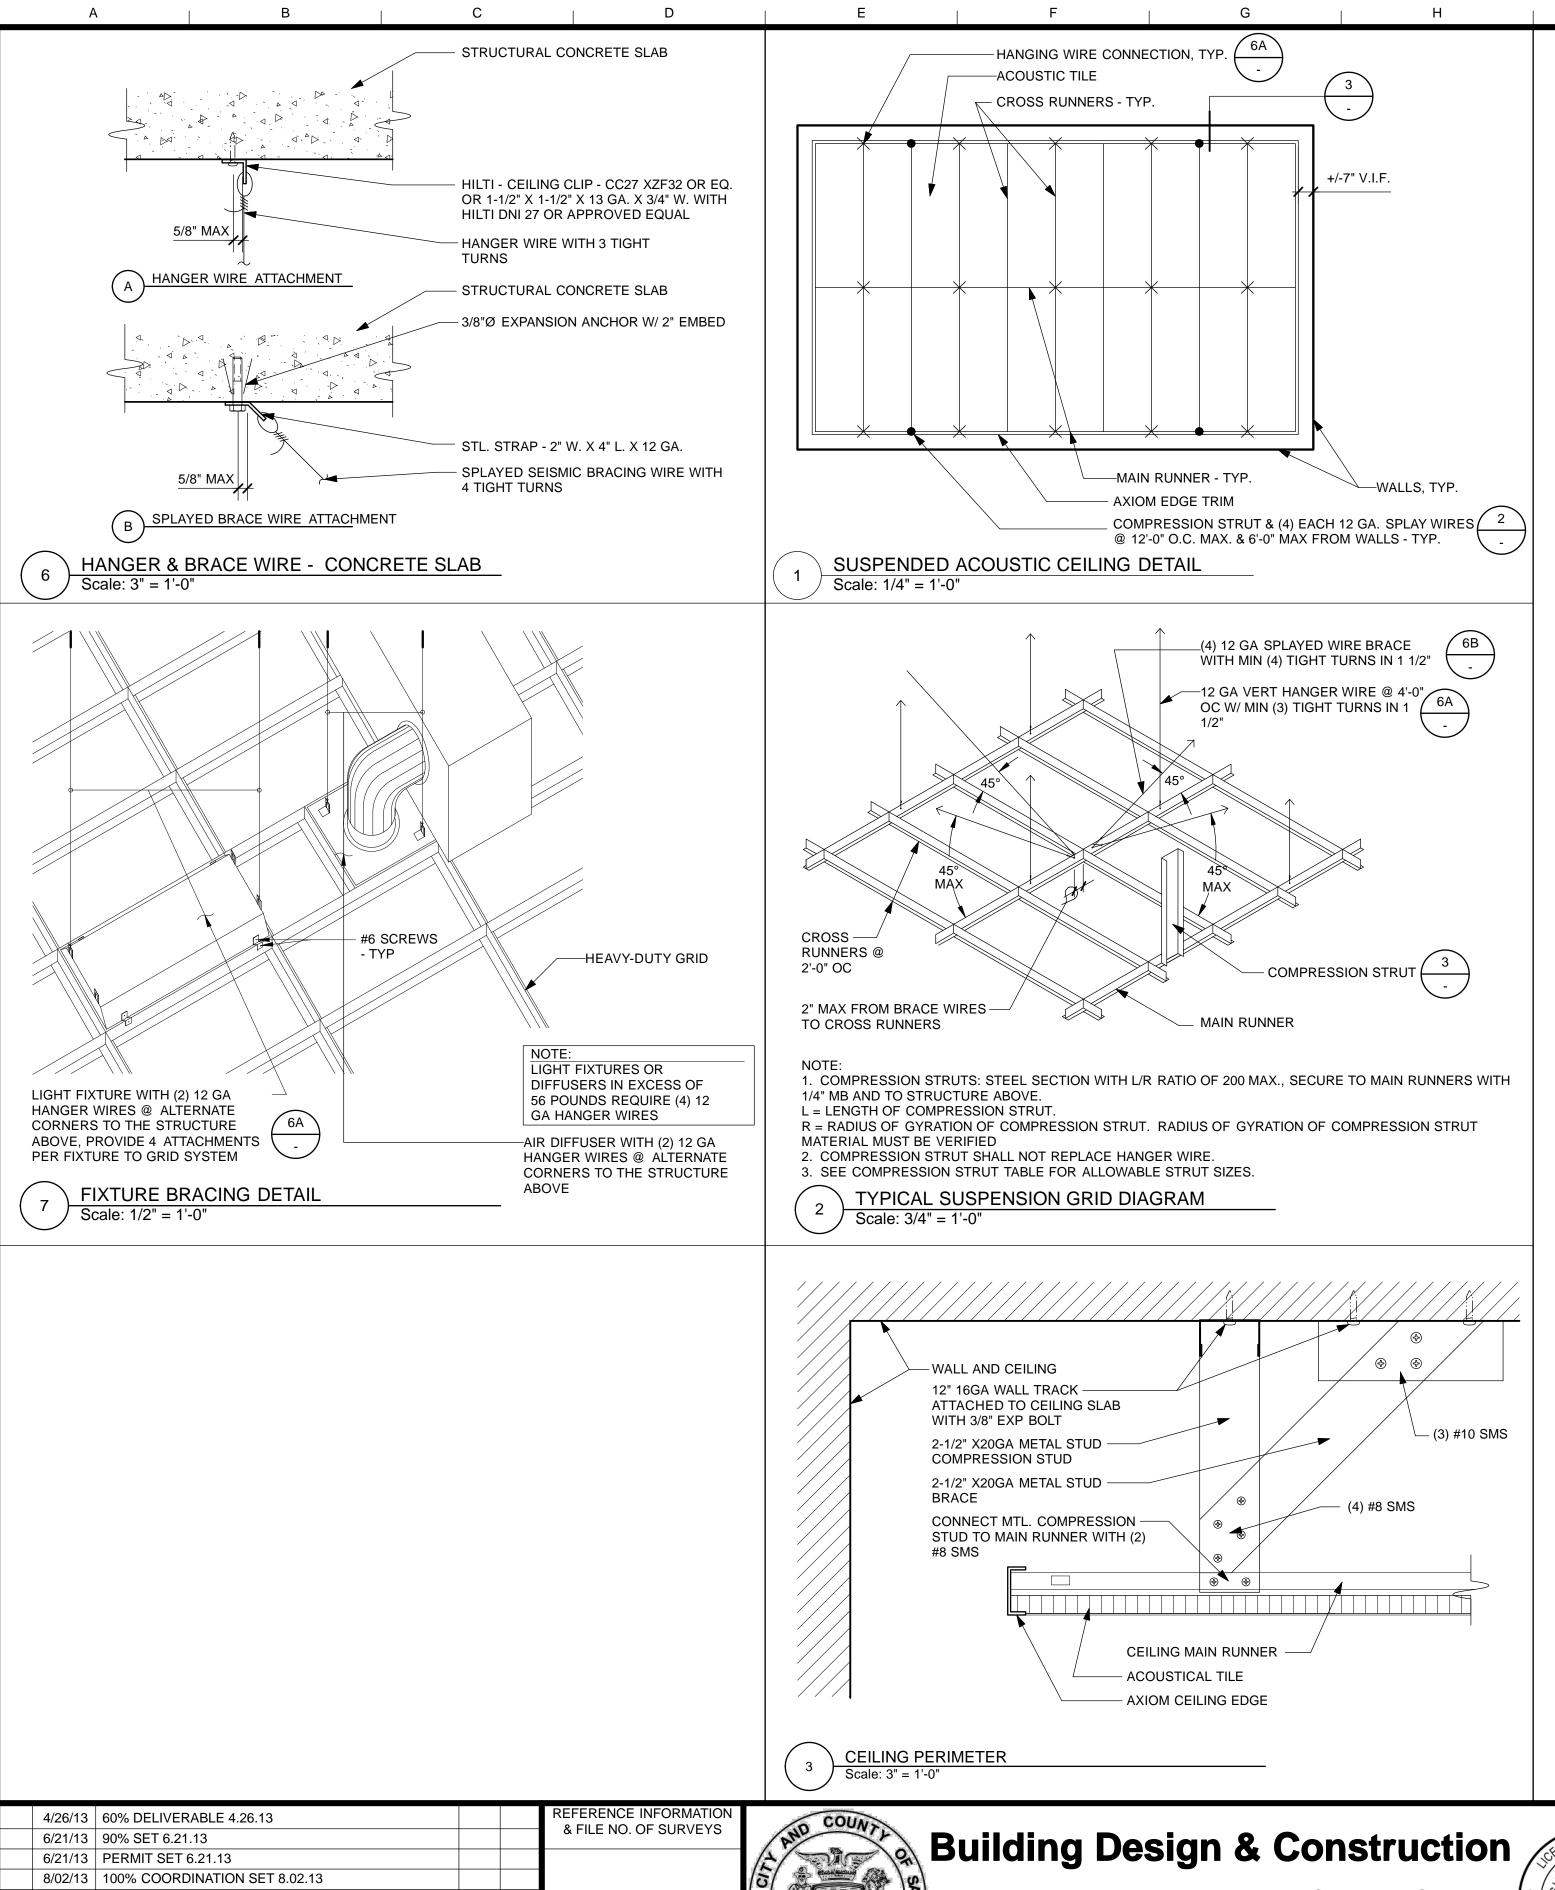








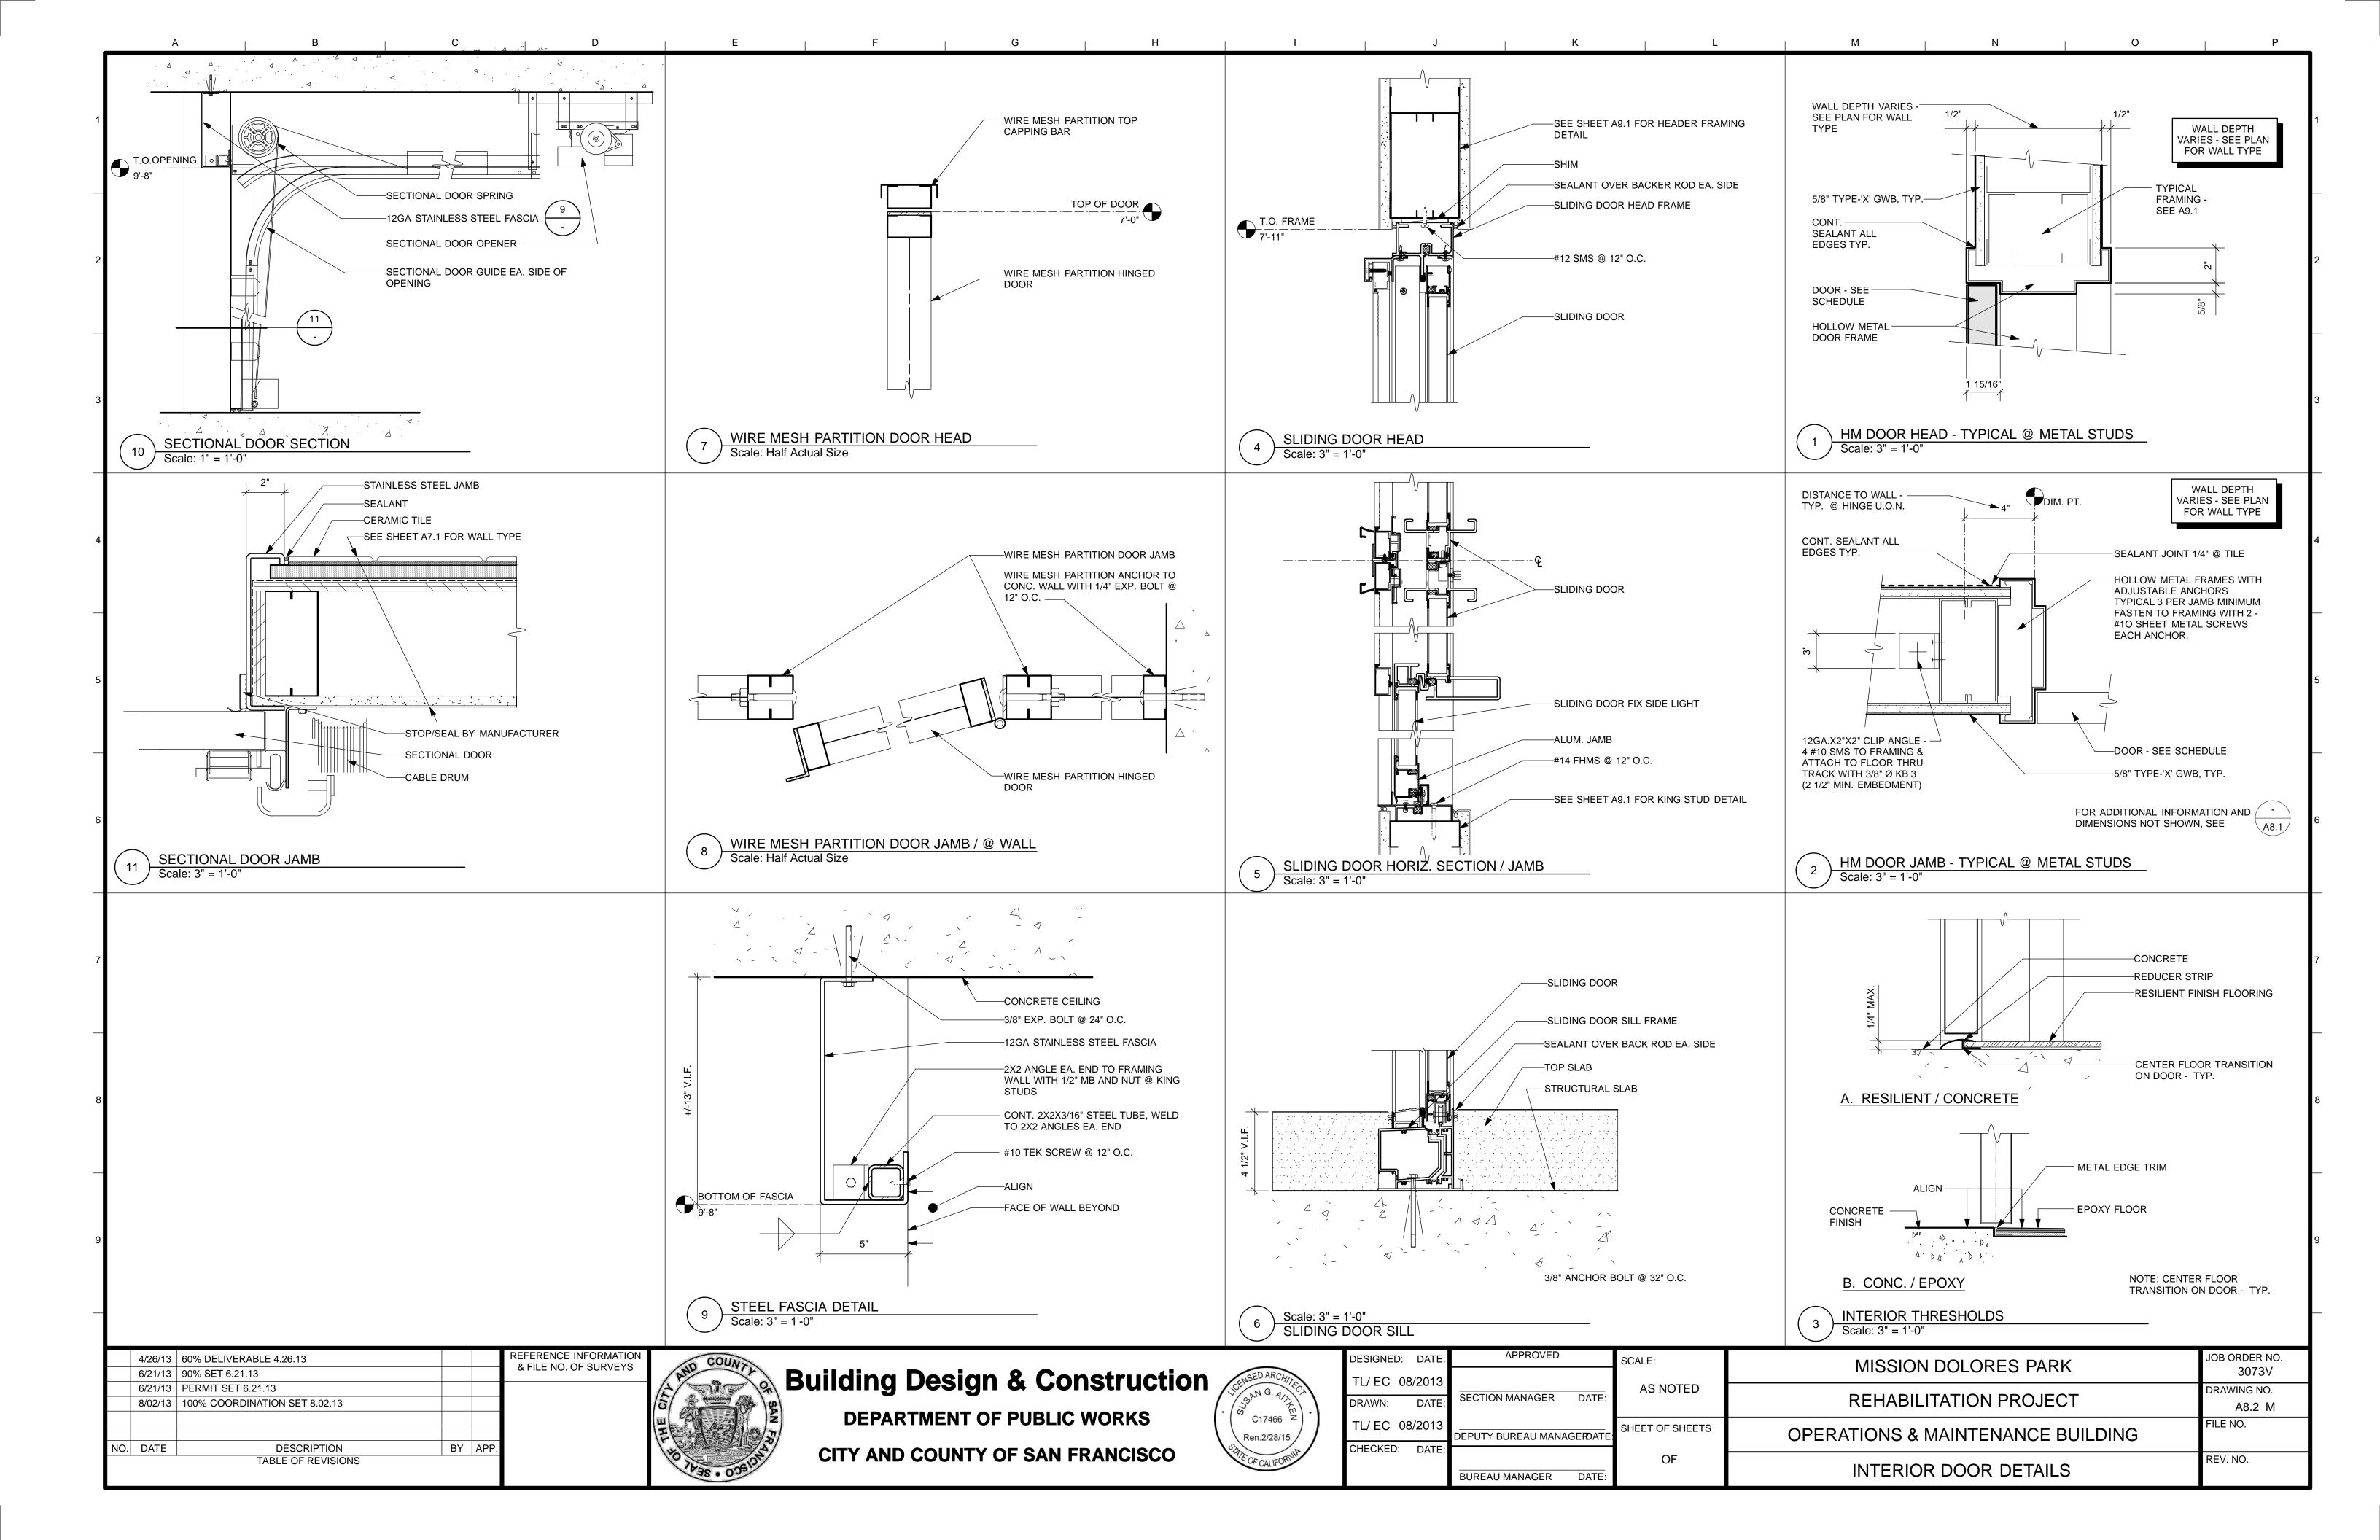

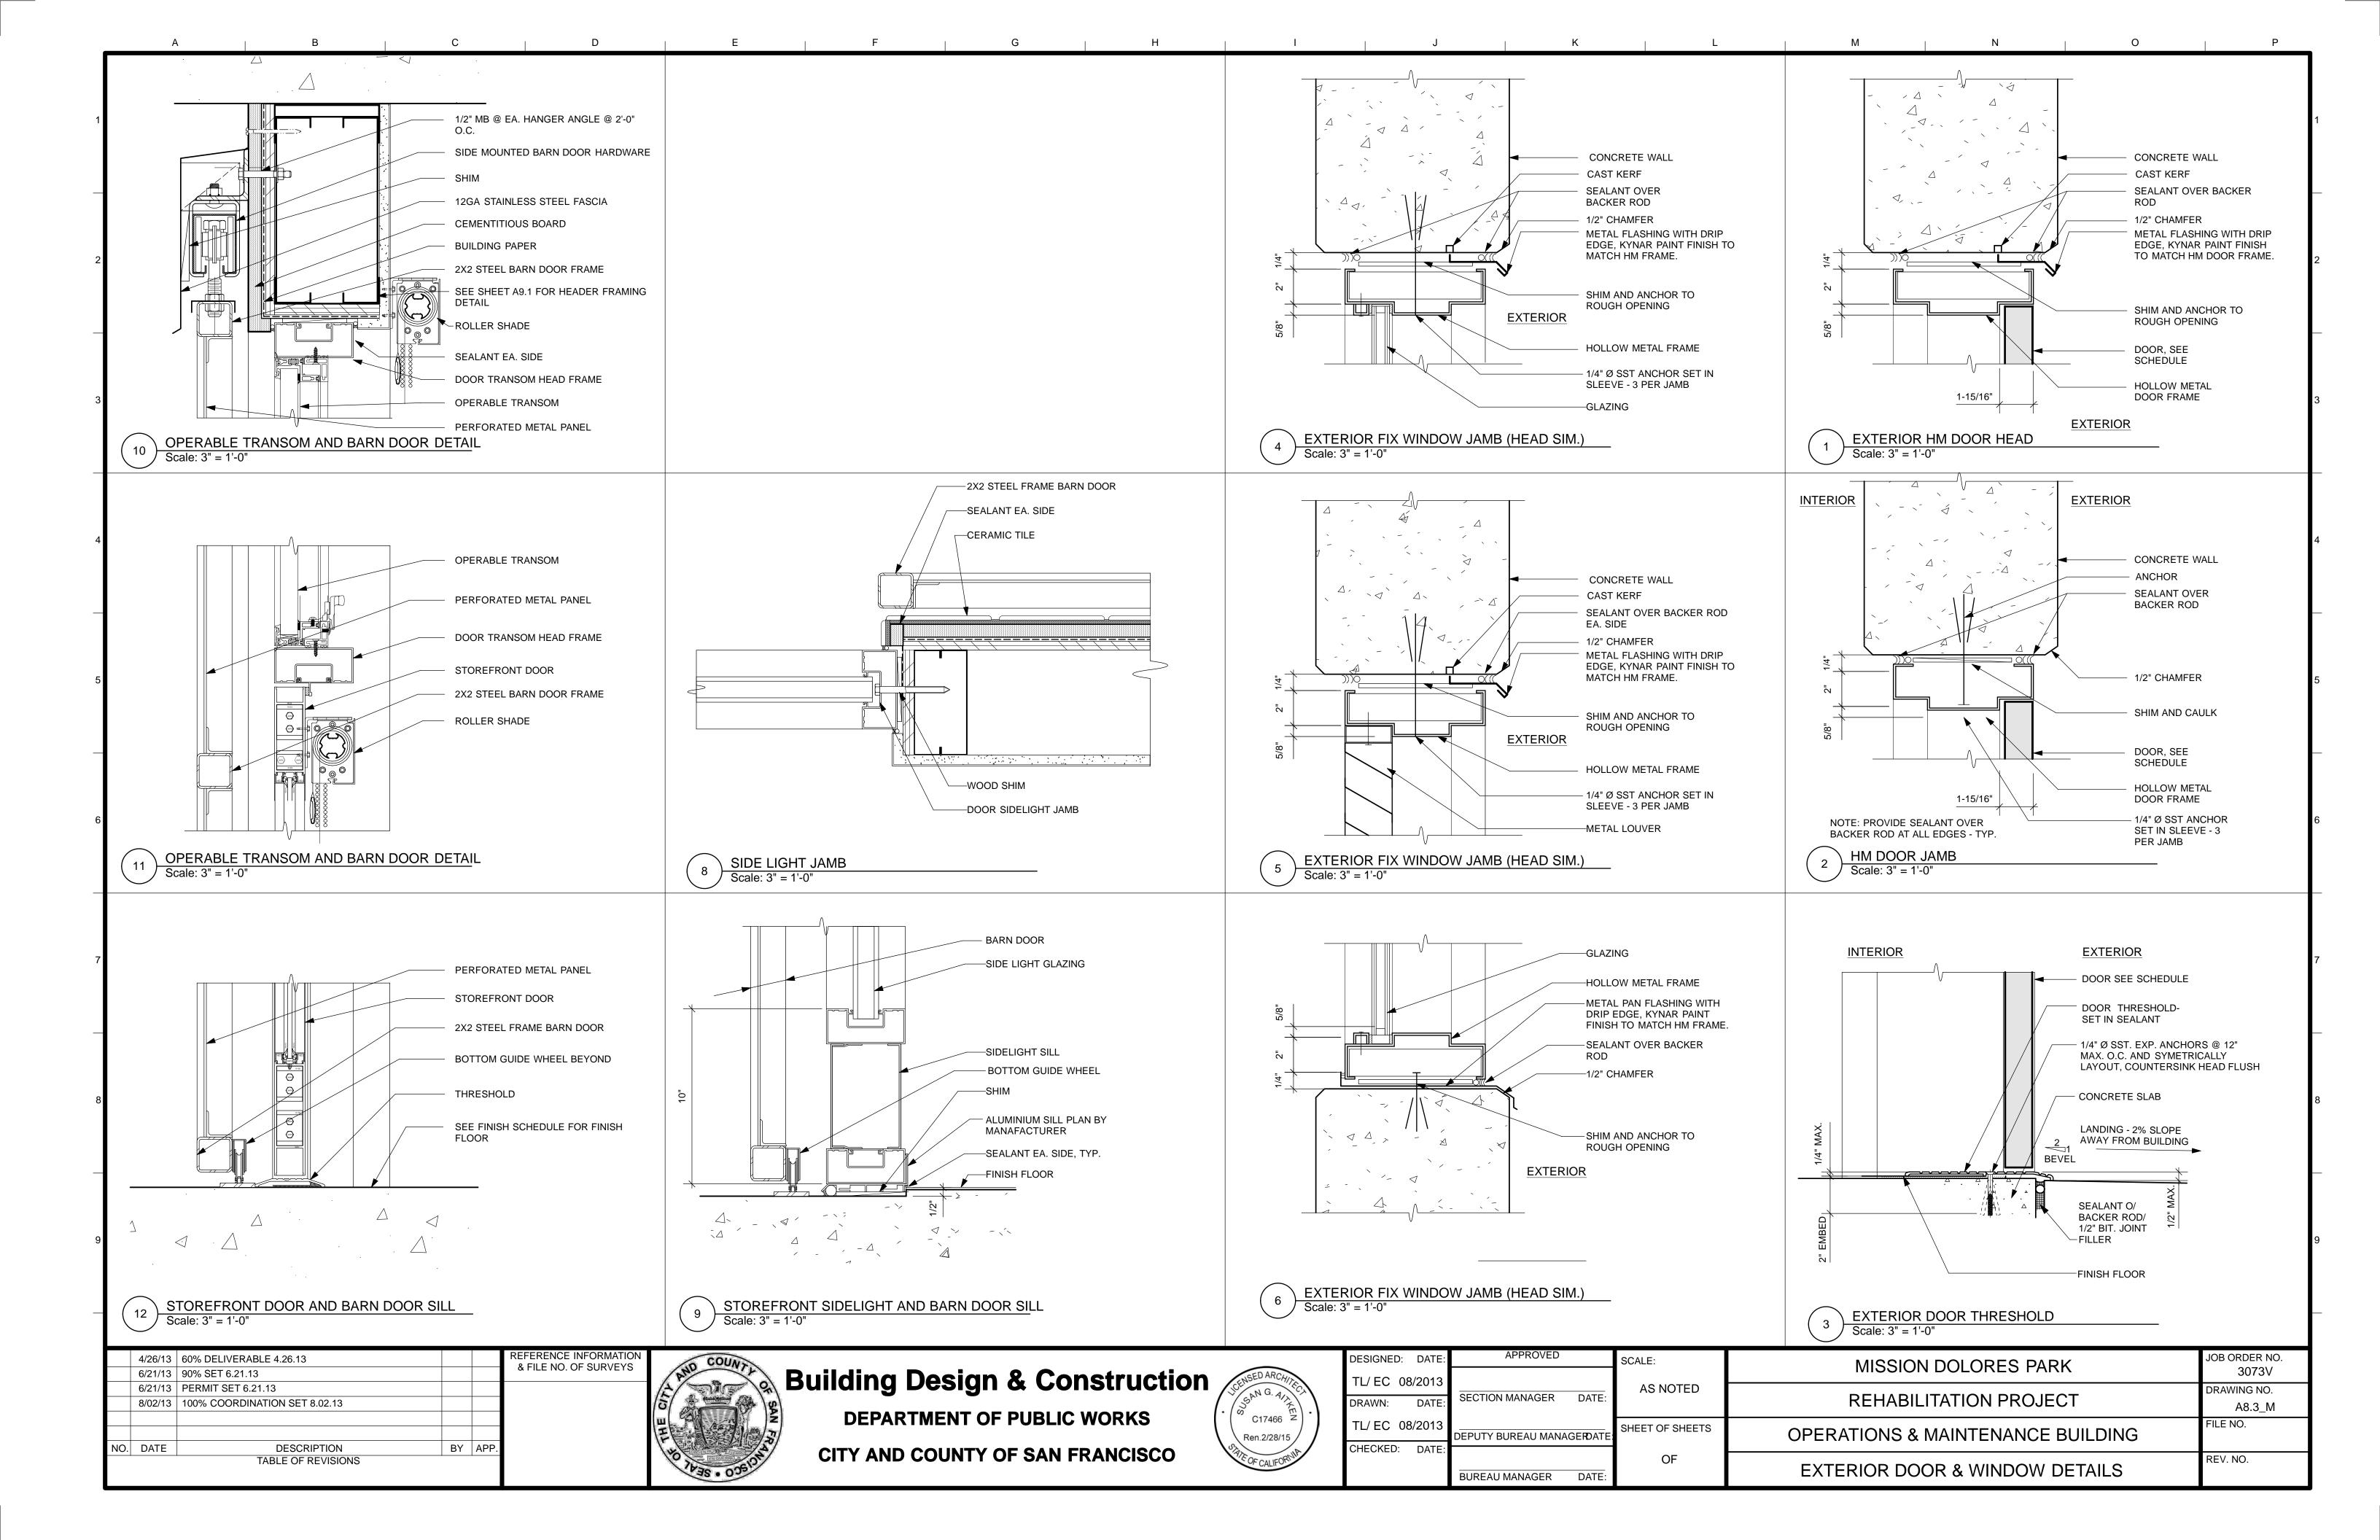

#### SUSPENDED CEILING NOTES

- 1. #12 GA. (MIN.) HANGER WIRES MAY BE USED FOR UP TO AND INCLUDING 4'-0" X 4'-0" GRID SPACING ALONG MAIN RUNNERS. SPLICES WILL NOT BE PERMITTED IN ANY HANGER WIRES UNLESS SPECIFICALLY APPROVED BY DSA/SSS.
- 2. PROVIDE 12 GA. HANGER WIRES AT THE ENDS OF ALL MAIN AND CROSS RUNNERS WITHIN 8" FROM THE SUPPORT OR WITHIN 1/4 OF THE LENGTH OF THE END TEE, WHICHEVER IS LEAST, FOR THE PERIMETER OF THE CEILING AREA. END CONNECTIONS FOR RUNNERS WHICH ARE DESIGNED AND DETAILED TO RESIST THE APPLIED VERTICAL AND HORIZONTAL FORCES MAY BE USED IN LIEU OF THE #12 GAGE HANGER WIRE, SUBJECT TO THE DIVISION OF THE STATE ARCHITECT (DSA) REVIEW AND APPROVAL.
- 3. PROVIDE TRAPEZE OR OTHER SUPPLEMENTARY SUPPORT MEMBERS AT OBSTRUCTIONS TO MAIN HANGER SPACING. PROVIDE ADDITIONAL HANGERS, STRUTS OR BRACES AS REQUIRED AT ALL CEILING BREAKS, SOFFITS, OR DISCONTINUOUS AREAS. HANGER WIRES THAT ARE MORE THAN 1 IN 6 OUT OF PLUMB ARE TO HAVE COUNTER-SLOPING WIRES.
- 4. CEILING GRID MEMBERS MAY BE ATTACHED TO NOT MORE THAN 2 ADJACENT WALLS. CEILING GRID MEMBERS SHOULD BE AT LEAST 1/2 INCH FREE OF OTHER WALLS. IF WALLS RUN DIAGONALLY TO CEILING GRID SYSTEM RUNNERS, ONE END OF MAIN AND CROSS RUNNER SHOULD BE FREE AND A MINIMUM OF 1/2 INCH CLEAR OF WALL.
- 5. AT THE PERIMETER OF THE CEILING AREA WHERE MAIN OR CROSS RUNNERS ARE NOT CONNECTED TO THE ADJACENT WALL, PROVIDE INTERCONNECTION BETWEEN RUNNERS AT THE FREE END TO PREVENT LATERAL SPREADING. A METAL STRUT OR A 16 GA. WIRE WITH A POSITIVE MECHANICAL CONNECTION TO THE RUNNER MAY BE USED. WHERE THE PERPENDICULAR DISTANCE FROM THE WALL TO THE FIRST PARALLEL RUNNER IS 12" OR LESS, THIS INTERLOCK IS NOT REQUIRED.
- 6. PROVIDE BRACING ASSEMBLIES CONSISTING OF A COMPRESSION STRUT AND FOUR 12 GA. SPLAYED BRACING WIRES ORIENTED 90° FROM EACH OTHER AT NOT MORE THAN 12'-0" X 12'-0" ON CENTER.

PROVIDE BRACING WIRES AT LOCATIONS NOT MORE THAN 6'-0" FROM EACH PERIMETER WALL AND AT THE EDGE OF VERTICAL CEILING OFFSETS.

THE SLOPE OF THESE WIRES SHOULD NOT EXCEED 45° FROM THE PLANE OF THE CEILING AND SHOULD BE TAUT WITHOUT CAUSING THE CEILING TO LIFT. SPLICES IN BRACING WIRES ARE NOT TO BE PERMITTED WITHOUT SPECIAL DSA/SSS APPROVAL.

SUSPENDED ACOUSTICAL CEILING SYSTEMS WITH A CEILING AREA OF 144 SQUARE FEET OR LESS, SURROUNDED BY WALLS WHICH CONNECT DIRECTLY TO THE STRUCTURE ABOVE, DO NOT REQUIRE BRACING ASSEMBLIES WHEN ATTACHED TO TWO ADJACENT WALLS.

7. FASTEN HANGER WIRES WITH NOT LESS THAN 3 TIGHT TURNS. FASTEN BRACING WIRES WITH 4 TIGHT TURNS. MAKE ALL TIGHT TURNS WITHIN A DISTANCE OF 1-1/2". HANGER OR BRACING WIRE ANCHORS TO THE STRUCTURE SHOULD BE INSTALLED IN SUCH A MANNER THAT THE DIRECTION OF THE ANCHOR ALIGNS AS CLOSELY AS POSSIBLE WITH THE DIRECTION OF THE WIRE.

NOTE: WIRE TURNS MADE BY MACHINE WHERE BOTH STRANDS HAVE BEEN DEFORMED OR BENT IN WRAPPING CAN WAIVE THE 1-1/2" REQUIREMENT, BUT THE NUMBER OF TURNS SHOULD BE MAINTAINED, AND BE AS TIGHT AS POSSIBLE.

8. SEPARATE ALL CEILING HANGING AND BRACING WIRES AT LEAST 6 INCHES FROM ALL UNBRACED DUCTS, PIPES, CONDUIT,

HVAC DUCTWORK, ELECTRICAL DISTRIBUTION, TELEPHONE SERVICES, COMPUTER CABLE DISTRIBUTION, AND OTHER SERVICES NORMALLY FOUND IN A CEILING SPACE, SHALL BE INDEPENDENTLY SUPPORTED AND APPROPRIATELY BRACED TO ELIMINATE ANY LATERAL FORCE ON THE CEILING MEMBRANE OR BRACING ELEMENTS.

- 9. WHEN DRILL-IN CONCRETE ANCHORS OR SHOT-IN ANCHORS ARE USED IN REINFORCED CONCRETE FOR HANGER WIRES, 1 OUT OF 10 MUST BE FIELD TESTED FOR 200 POUNDS OF TENSION. WHEN DRILLED-IN CONCRETE ANCHORS ARE USED FOR BRACING WIRES, 1 OUT OF 2 MUST BE FIELD TESTED FOR 440 LBS. OF TENSION. SHOT-IN ANCHORS IN CONCRETE ARE NOT PERMITTED FOR BRACING WIRES. IF ANY SHOT-IN OR DRILLED-IN ANCHOR FAILS, ALL ADJACENT ANCHORS MUST BE TESTED. REFER ALSO TO TESTING REQUIREMENTS OF CBC, SECTION 1923A.3.5. DRILLED-IN OR SHOT-IN ANCHORS REQUIRE SPECIAL DSA/SSS APPROVAL WHEN USED IN PRESTRESSED CONCRETE.
- 10. ATTACH ALL LIGHT FIXTURES AND CEILING MOUNTED AIR TERMINALS, TO THE CEILING GRID RUNNERS TO RESIST A HORIZONTAL FORCE EQUAL TO THE WEIGHT OF THE FIXTURES. SCREWS OR APPROVED FASTENERS ARE REQUIRED.

ALL RECESSED LIGHTING FIXTURES HAVING A NOMINAL END DIMENSION OF 24" OR GREATER, SHALL BE POSITIVELY ATTACHED TO THE CEILING GRID RUNNER(S) AT EACH END OF THE FIXTURE WITH TWO #8 SELF TAPPING TEK SCREWS, EACH SCREW SHALL BE LOCATED WITHIN 3" OF THE SIDE OF THE FIXTURE AND ATTACHED THROUGH THE BULB OF THE CEILING GRID RUNNER(S). LIGHT FIXTURES HAVING LESS THAN A NOMINAL 24" END DIMENSION SHALL BE ATTACHED WITH ONE #8 SELF TAPPING TEK SCREW AT THE CENTER OF EACH END OF THE FIXTURE, ATTACHED TO THE BULB OF THE CEILING GRID RUNNER(S). ALL ATTACHMENTS SHALL BE CAPABLE OF LATERALLY SUPPORTING THE WEIGHT OF THE FIXTURE. ALL FIXTURES REGARDLESS OF WEIGHT OR SIZE SHALL HAVE INTERLOCKING CEILING GRID RUNNER(S) ON ALL 4 SIDES OF THE FIXTURE.

- 11. CEILING-MOUNTED AIR TERMINALS OR SERVICES SHALL BE POSITIVELY ATTACHED TO THE CEILING SUSPENSION MAIN RUNNERS OR TO CROSS RUNNERS WITH THE SAME CARRYING CAPACITY AS THE MAIN RUNNER. AIR TERMINALS WITH A NOMINAL DIMENSION OF 24" OR LESS SHALL BE POSITIVELY ATTACHED TO THE CEILING GRID RUNNER(S) ON AT LEAST TWO OPPOSING SIDES WITH ONE #8 SELF TAPPING TEK SCREW ON EACH SIDE. EACH SCREW SHALL BE LOCATED IN THE CENTER OF THE AIR TERMINAL AND SHALL BE ATTACHED THROUGH THE BULB OF THE CEILING GIRD RUNNER(S). AIR TERMINALS IN EXCESS OF 24" IN LENGTH SHALL BE ATTACHED WITH TWO #8 SELF TAPPING TEK SCREWS ON EACH END OF DIFFUSER ATTACHED TO THE BULB OF THE CEILING GRID RUNNER(S). ALL ATTACHMENTS SHALL BE CAPABLE OF LATERALLY SUPPORTING THE WEIGHT OF THE AIR TERMINAL. ALL AIR TERMINALS REGARDLESS OF WEIGHT OR SIZE SHALL HAVE INTERLOCKING CEILING GRID RUNNER(S) ON ALL 4 SIDES OF THE AIR TERMINAL
- 12. FLUSH OR RECESSED LIGHT FIXTURES AND AIR TERMINALS WEIGHING LESS THAN 56 LBS., MAY BE SUPPORTED DIRECTLY ON THE RUNNERS OF A HEAVY DUTY GRID SYSTEM BUT, IN ADDITION, THEY MUST HAVE A MINIMUM OF TWO 12 GA SLACK SAFETY WIRES ATTACHED TO THE FIXTURE AT DIAGONAL CORNERS AND ANCHORED TO THE STRUCTURE ABOVE. ALL 4'-0" X 4'-0" LIGHT FIXTURES MUST HAVE SLACK SAFETY WIRES AT EACH CORNER. ALL FLUSH OR RECESSED LIGHT FIXTURES AND AIR TERMINALS WEIGHING 56 POUNDS OR MORE MUST BE INDEPENDENTLY SUPPORTED BY NOT LESS THAN 4 TAUT 12 GA. WIRES EACH ATTACHED TO THE FIXTURE AND TO THE STRUCTURE ABOVE REGARDLESS OF THE TYPE OF CEILING GRID SYSTEM USED. THE 4 TAUT 12 GA. WIRES INCLUDING THEIR ATTACHMENT TO THE STRUCTURE ABOVE MUST BE CAPABLE OF SUPPORTING 4 TIMES THE WEIGHT OF THE UNIT.
- 13. ALL FIXTURES AND AIR TERMINALS SUPPORTED ON INTERMEDIATE DUTY GRID SYSTEMS MUST BE INDEPENDENTLY SUPPORTED BY NOT LESS THAN 4 TAUT 12 GA. WIRES EACH ATTACHED TO THE FIXTURE OR TERMINAL AND TO THE STRUCTURE ABOVE.
- 14. SUPPORT SURFACE MOUNTED LIGHT FIXTURES BY AT LEAST TWO POSITIVE DEVICES WHICH SURROUND THE CEILING RUNNER AND WHICH ARE EACH SUPPORTED FROM THE STRUCTURE ABOVE BY A 12 GA. WIRE. SPRING CLIPS OR CLAMPS THAT CONNECT ONLY TO THE RUNNER ARE NOT ACCEPTABLE. PROVIDE ADDITIONAL SUPPORTS WHEN LIGHT FIXTURES ARE 8 FEET OR LONGER.
- 15. SUPPORT PENDANT MOUNTED LIGHT FIXTURES DIRECTLY FROM THE STRUCTURE ABOVE WITH HANGER WIRES OR CABLES PASSING THROUGH EACH PENDANT HANGER AND CAPABLE OF SUPPORTING 4 TIMES THE WEIGHT OF THE FIXTURE. A BRACING ASSEMBLY, AS DESCRIBED IN NOTE 6 OF THESE SUSPENSION SYSTEM NOTES, SHALL BE REQUIRED WHERE THE PENDANT HANGER PENETRATES THE CEILING. SPECIAL DETAILS ARE REQUIRED TO ATTACH THE PENDANT HANGER TO THE BRACING ASSEMBLY TO TRANSMIT HORIZONTAL FORCES.

- 16. METAL PANELS AND PANELS WEIGHING MORE THAN 1/2 PSF, OTHER THAN ACOUSTICAL TILE, ARE TO BE POSITIVELY ATTACHED TO THE CEILING SUSPENSION RUNNERS.
- 17. WHERE GYPSUM BOARD OR OTHER CEILING FINISHES ARE ATTACHED TO THE BUILDING FLOOR OR ROOF FRAMING, SPECIAL DETAILS WILL BE REQUIRED FOR THE VERTICAL HANGER WIRE AND LATERAL BRACING WIRE SUPPORT CONNECTIONS TO THE FRAMING.
- 18. WHEN THERE IS REUSE OF EXISTING CEILING HANGER WIRES AND SPLAY WIRES, THE GAUGE AND SPACING OF THE WIRES MUST COMPLY WITH CURRENT APPLICABLE CODES. ALL EXISTING CEILING HANGER WIRES MUST BE TESTED TO 200 LBS IN TENSION. ALL EXISTING SPLAYED BRACING WIRES MUST BE FIELD TESTED TO 440 LBS IN TENSION. IF A NEW WIRE IS TO BE SPLICED TO AN EXISTING WIRE, THE FOLLOWING IS REQUIRED:
- A. THE ARCHITECT OR STRUCTURAL ENGINEER IN GENERAL RESPONSIBLE CHARGE MUST SUBMIT TO DSA/SSS A DETAIL AND SPECIFICATION OF HOW THE SPLICE IS TO BE MADE. B. ALL NEW WIRES, AFTER BEING SPLICED TO THE
- EXISTING WIRES, MUST BE FIELD TESTED AS STATED ABOVE C. ALL FIELD TESTS MUST BE PERFORMED IN THE PRESENCE OF THE PROJECT INSPECTOR.

19. COMPONENTS SHALL COMPLY WITH THE FOLLOWING SCHEDULE:

MANUFACTURER	MAIN RUNNER	CROSS RUNNER	DSA/SSS APPRV. NO
ARMSTRONG	7301	XL 7300	PA-041
CHICAGO METALLIC	200	1204(2)	PA-026

FOOTNOTES: (1) FOR 2 X 2 GRID USE 7324 (2) FOR 2 X 2 GRID USE 1226

(3) FOR 2 X 2 GRID USE DX216

DONN CORPORATION DX26

20. ALTERNATE MANUFACTURERS AND SYSTEMS MUST BE SUBMITTED FOR REVIEW AND APPROVAL BY THE DIVISION OF THE STATE ARCHITECT.

DX424(3) PA-030

#### 21. ANCHORS FOR WALL ANGLES:

- A. AT WOOD STUD WALL: 4D COMMON NAIL @ 16" OC. B. AT METAL STUD WALL: 1-1/8" TYPE "S" BUGLE HEAD DRYWALL SCREW AT 16" OC.
- C. AT MASONRY WALL: 1/4" DIA. X 1-1/2" LONG KWIK CON II ANCHOR SCREW @ 16" OC. ICBO NO. 5259.

#### SUSPENDED GYPSUM BOARD CEILING SYSTEM NOTES

- VERTICAL HANGER WIRES SHALL BE NO. 8 GAGE AND GALVANIZED.
- 2. MAIN RUNNERS 1 1/2" X 1.12# / FT. HOT ROLLED STEEL CHANNELS.
- 3. CROSS-FURRING 7/8" X 25 GAGE GALVANIZED HAT CHANNELS AT 24" O.C. MAXIMUM.
- 4. HANGERS SHALL BE SADDLE-TIED AROUND MAIN RUNNERS TO DEVELOP THE FULL STRENGTH OF THE HANGERS.
- 5. CROSS-FURRING SHALL BE SADDLE-TIED TO THE MAIN RUNNER WITH ONE STRAND OF NO. 16 OR TWO STRANDS OF NO. 18 GAGE TIE WIRE.
- 6. MAIN RUNNERS SHALL BE SPLICED BY LAPPING AND INTERLOCKING FLANGES 12" MINIMUM AND TYING NEAR EACH END WITH DOUBLE LOOPS OF NO. 16 GAGE WIRE.
- 7. CROSS-FURRING SHALL BE SPLICED BY LAPPING AND INTERLOCKING THE PIECES 8" MINIMUM AND TYING NEAR EACH END WITH DOUBLE LOOPS OF NO. 16 GAGE WIRE.
- 8. THESE NOTES ARE IN ADDITION TO "SUSPENDED CEILING
- IF MAIN RUNNERS ARE AT 4'-0" HANGER WIRE SHALL BE 3'-0" O.C.

IF MAIN RUNNERS ARE AT 3'-6" HANGER WIRE SHALL BE 3'-6" O.C.

IF MAIN RUNNERS ARE AT 3'-0" HANGER WIRE SHALL BE 4'-0" O.C.


NO. DATE **DESCRIPTION** BY APF TABLE OF REVISIONS




# **DEPARTMENT OF PUBLIC WORKS** CITY AND COUNTY OF SAN FRANCISCO




DESIGNED: DATE:	APPROVED	SCALE:	MISSION DOLORES PARK	JOB ORDER NO. 3073V
TL/ EC 08/2013		AS NOTED		DRAWING NO.
DRAWN: DATE:	SECTION MANAGER DATE:	NOTICE	REHABILITATION PROJECT	A9.3_M
TL/ EC 08/2013	DEPUTY BUREAU MANAGERDATE:	SHEET OF SHEETS	OPERATIONS & MAINTENANCE BUILDING	FILE NO.
CHECKED: DATE:	BUREAU MANAGER DATE:	OF	CEILING DETAILS	REV. NO.

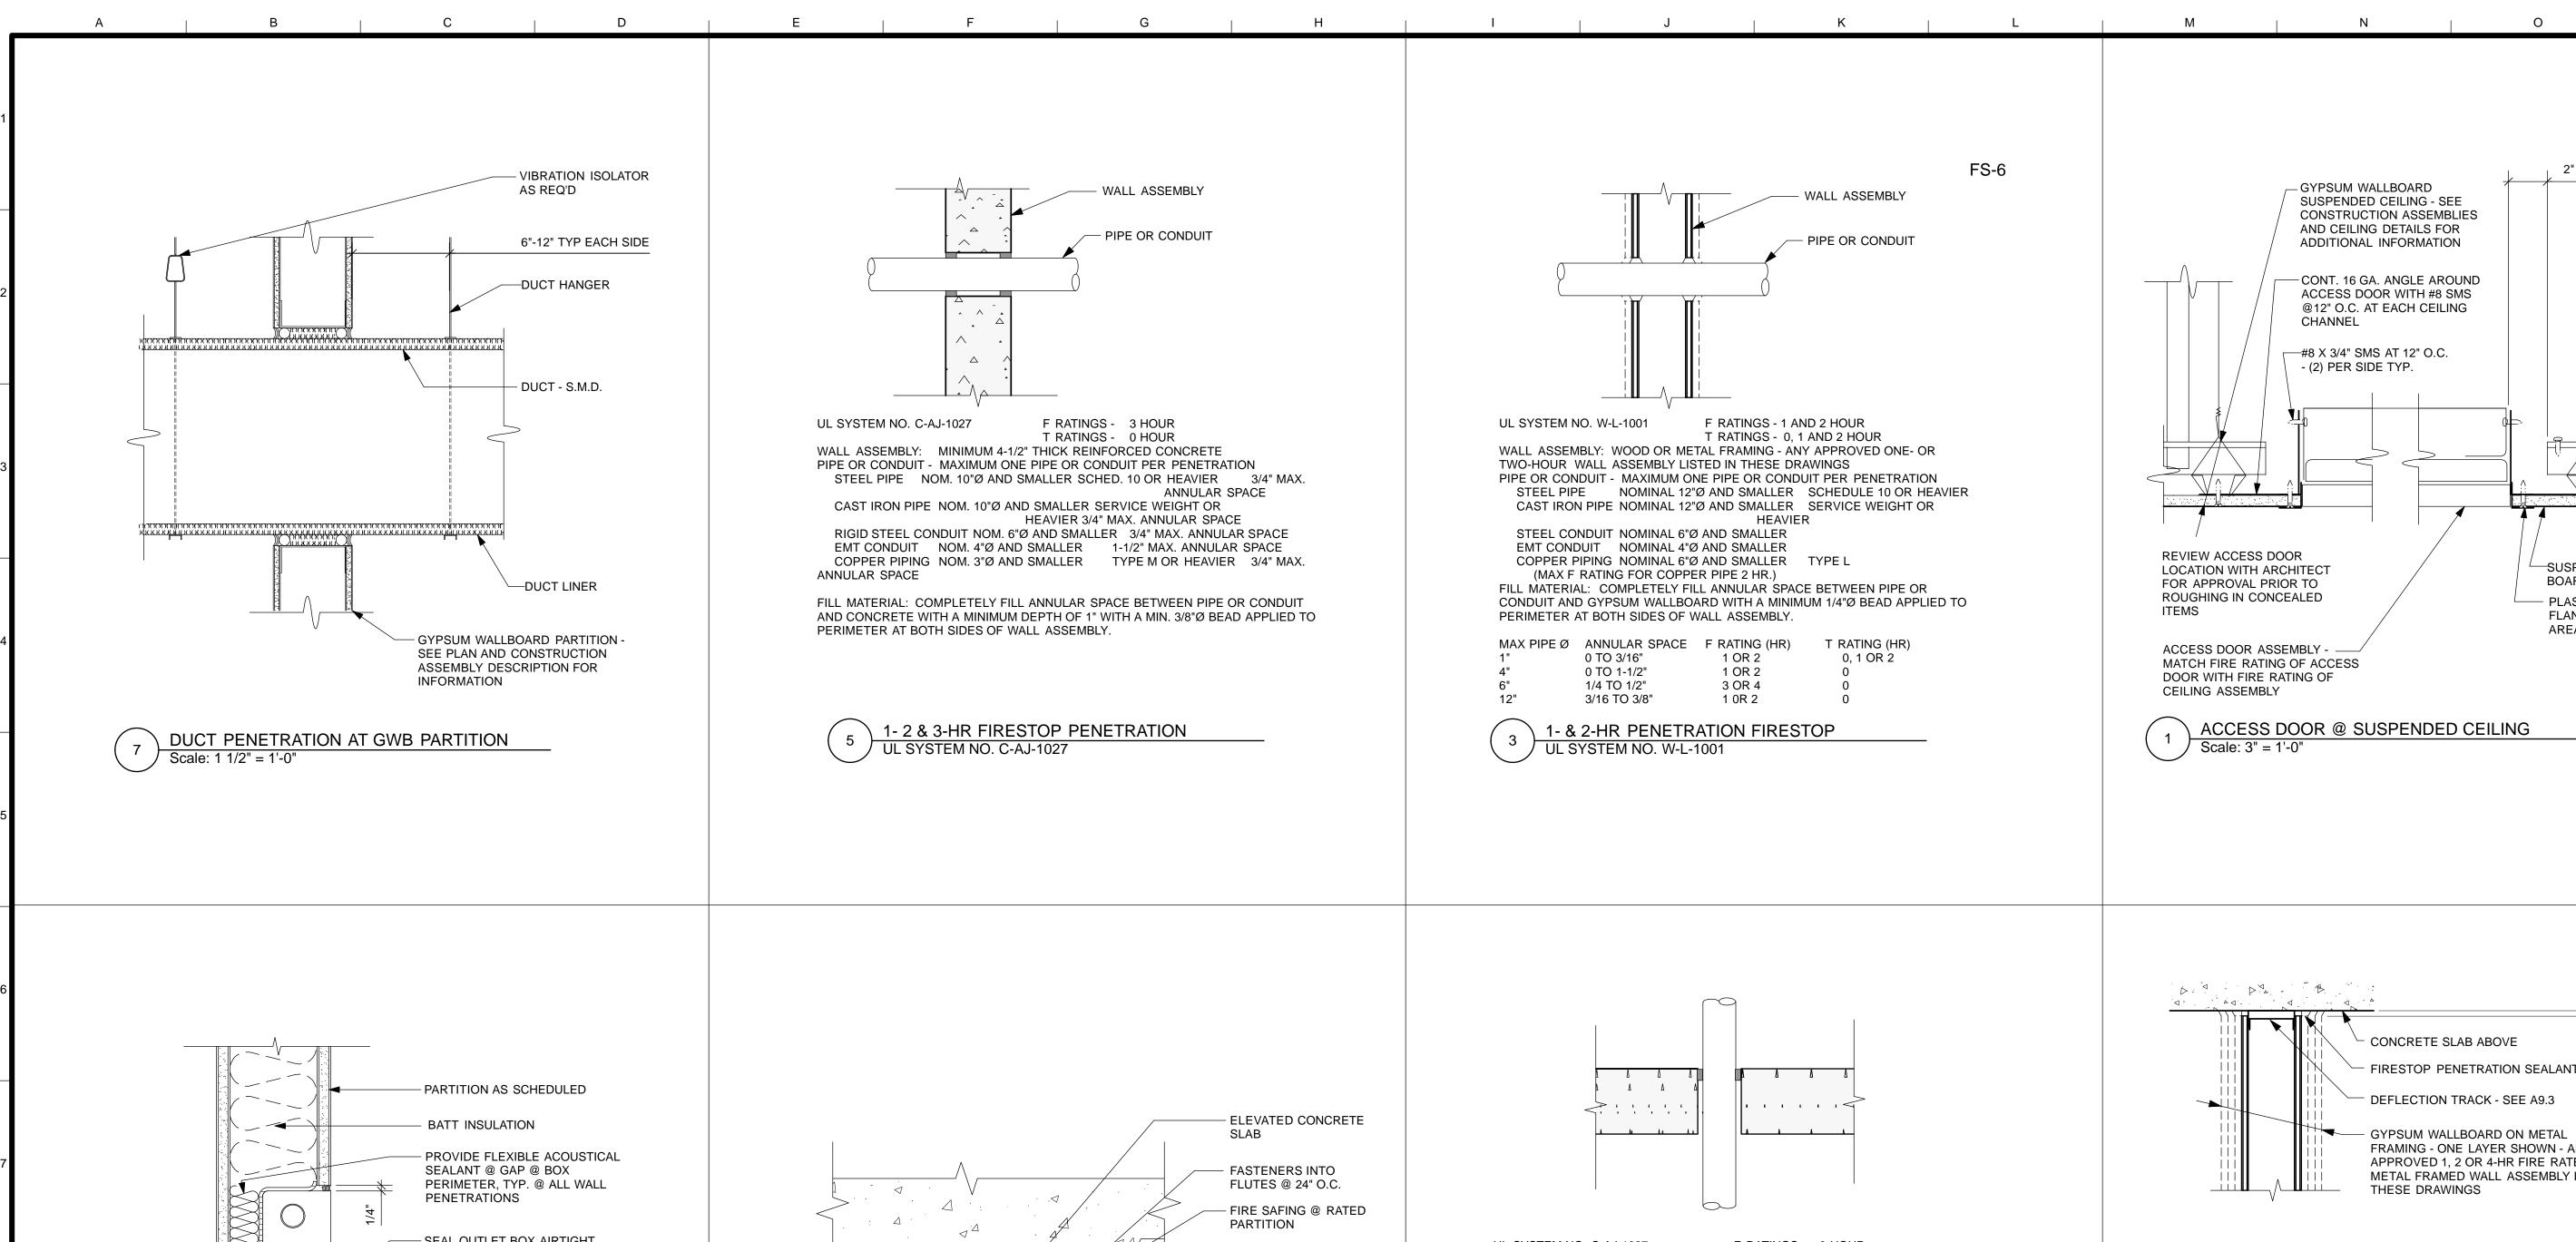

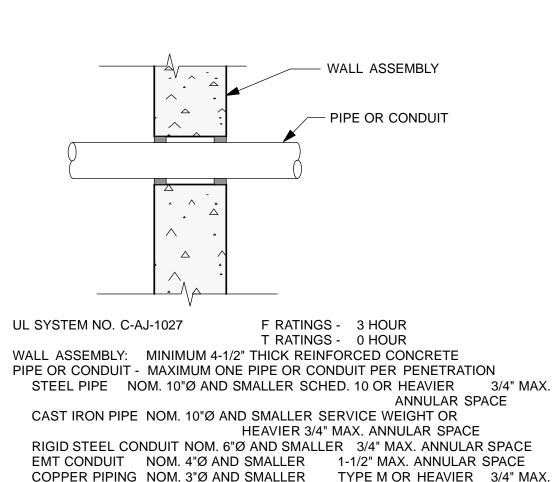

ANNULAR SPACE FILL MATERIAL: COMPLETELY FILL ANNULAR SPACE BETWEEN PIPE OR CONDUIT AND CONCRETE WITH A MINIMUM DEPTH OF 1" WITH A MIN. 3/8"Ø BEAD APPLIED TO PERIMETER AT BOTH SIDES OF WALL ASSEMBLY.

1- 2 & 3-HR FIRESTOP PENETRATION UL SYSTEM NO. C-AJ-1027

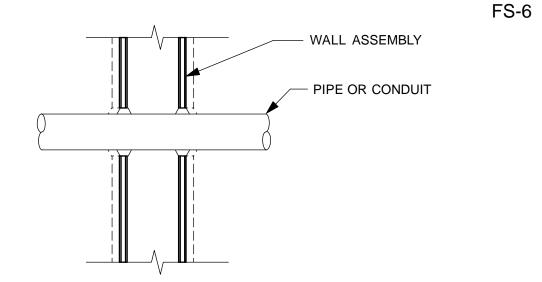


F RATINGS - 1 AND 2 HOUR UL SYSTEM NO. W-L-1001 T RATINGS - 0, 1 AND 2 HOUR WALL ASSEMBLY: WOOD OR METAL FRAMING - ANY APPROVED ONE- OR TWO-HOUR WALL ASSEMBLY LISTED IN THESE DRAWINGS PIPE OR CONDUIT - MAXIMUM ONE PIPE OR CONDUIT PER PENETRATION STEEL PIPE NOMINAL 12"Ø AND SMALLER SCHEDULE 10 OR HEAVIER CAST IRON PIPE NOMINAL 12"Ø AND SMALLER SERVICE WEIGHT OR


EMT CONDUIT NOMINAL 4"Ø AND SMALLER COPPER PIPING NOMINAL 6"Ø AND SMALLER TYPE L (MAX F RATING FOR COPPER PIPE 2 HR.) FILL MATERIAL: COMPLETELY FILL ANNULAR SPACE BETWEEN PIPE OR CONDUIT AND GYPSUM WALLBOARD WITH A MINIMUM 1/4"Ø BEAD APPLIED TO PERIMETER AT BOTH SIDES OF WALL ASSEMBLY.

MAX PIPE	Ø ANNULAR SPACE	F RATING (HR)	T RATING (HR
1"	0 TO 3/16"	1 OR 2	0, 1 OR 2
4"	0 TO 1-1/2"	1 OR 2	0
6"	1/4 TO 1/2"	3 OR 4	0
12"	3/16 TO 3/8"	1 0R 2	0


1- & 2-HR PENETRATION FIRESTOP UL SYSTEM NO. W-L-1001

STEEL CONDUIT NOMINAL 6"Ø AND SMALLER

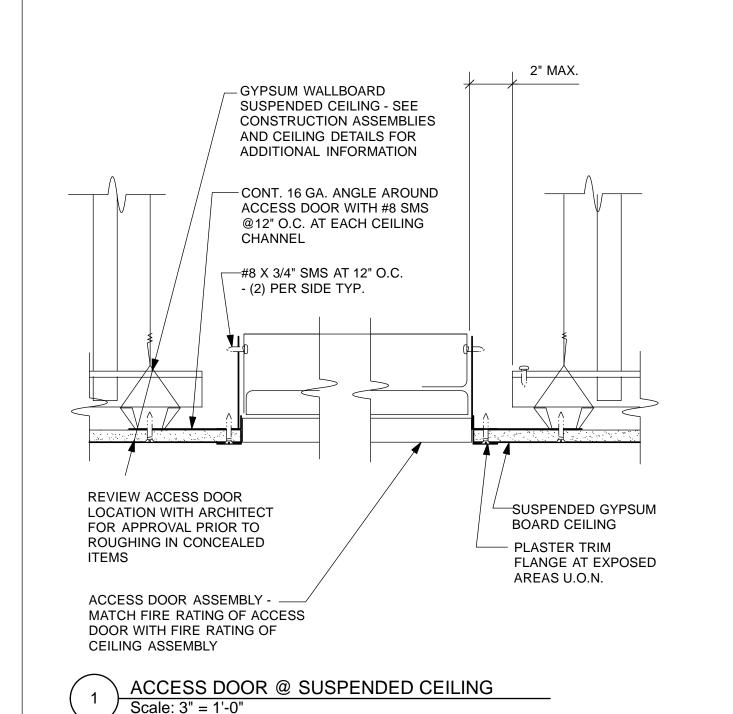


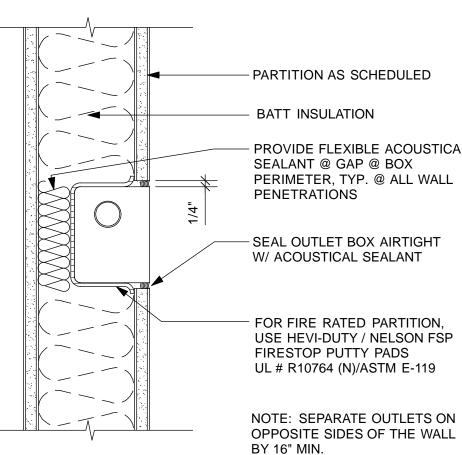



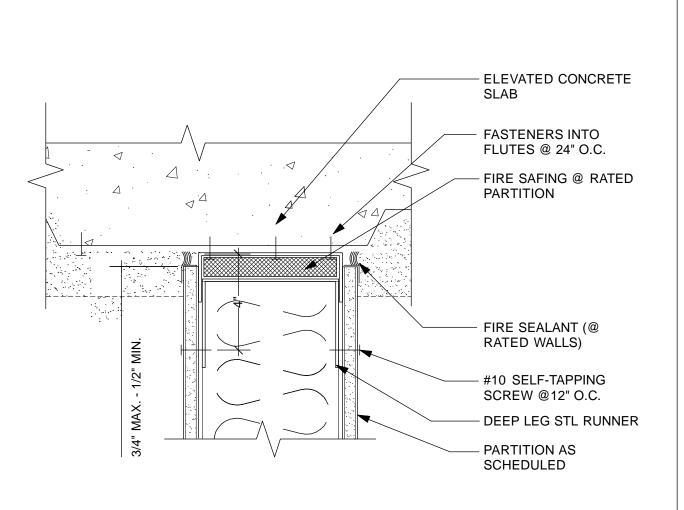

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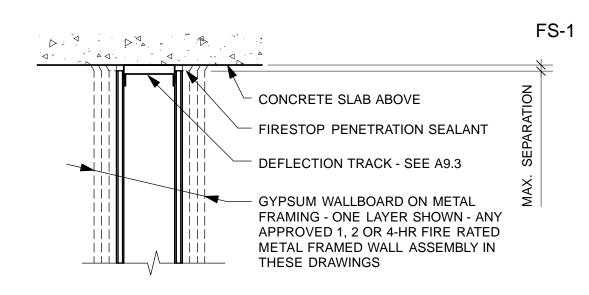


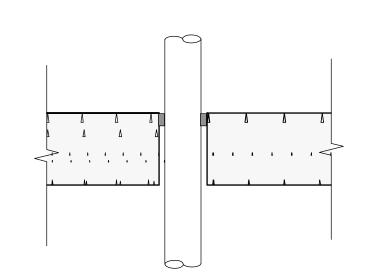UL SYSTEM NO. C-AJ-1027 F RATINGS - 3 HOUR T RATINGS - 0 HOUR FLOOR ASSEMBLY: MINIMUM 4-1/2" THICK REINFORCED CONCRETE PIPE OR CONDUIT - MAXIMUM ONE PIPE OR CONDUIT PER PENETRATION STEEL PIPE NOM. 10"Ø AND SMALLER SCHED. 10 OR HEAVIER 3/4" MAX.

ANNULAR SPACE CAST IRON PIPE NOM. 10"Ø AND SMALLER SERVICE WEIGHT OR HEAVIER 3/4" MAX. ANNULAR SPACE RIGID STEEL CONDUIT NOM. 6"Ø AND SMALLER 3/4" MAX. ANNULAR SPACE EMT CONDUIT NOM. 4"Ø AND SMALLER 1-1/2" MAX. ANNULAR SPACE COPPER PIPING NOM. 3"Ø AND SMALLER TYPE M OR HEAVIER 3/4" MAX. ANNULAR SPACE

FILL MATERIAL: COMPLETELY FILL ANNULAR SPACE BETWEEN PIPE OR CONDUIT AND CONCRETE WITH A MINIMUM DEPTH OF 1" WITH A MIN. 3/8"Ø BEAD APPLIED TO PERIMETER AT BOTH SIDES OF WALL ASSEMBLY.

1- & 2-HR PENETRATION FIRESTOP UL SYSTEM NO. C-AJ-1027



UL SYSTEM NO. HW-D-0044 ASSEMBLY RATINGS - 1, 2, 3 AND 4 HOUR NOMINAL JONT WIDTHS - 1 AND 2 INCH FLOOR ASSEMBLY - 4-1/2" MIN. REINFORCED CONCRETE WALL ASSEMBLY: METAL FRAMING - ANY APPROVED ONE-, TWO- OR 4-HOUR WALL ASSEMBLY LISTED IN THESE DRAWINGS

MAXIMUM SEPARATION BETWEEN TOP OF GYPSUM WALLBOARD AND CONCRETE SLAB -2" MAX. FOR 1 AND 2-HOUR RATING 1" MAX. FOR 3 AND 4-HOUR RATING

- 4HR PERIMETER FIRESTOP UL SYSTEM NO. HW-D-0044

4/26/13 60% DELIVERABLE 4.26.13		REFERENCE INFORMAT & FILE NO. OF SURVE
6/21/13 90% SET 6.21.13		& FILE NO. OF SURVE
6/21/13 PERMIT SET 6.21.13		
8/02/13 100% COORDINATION SET 8.02.13		
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TL/ EC 08/2013	DEPUTY BUREAU MANAGERDATE:	SHEET OF SHEETS	OPERATIONS & MAINTENANCE BUILDING	FILE NO.
CHECKED: DATE:				
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