2008 PARK BOND RESTROOM REPLACEMENT PROJECT CONTEMPORARY DESIGN

REPLACEMENT GROUP 2 - DUPONT TENNIS COURTS RESTROOMS

	JOB NUMBE	ER 3092V-2	2 (DPW ID No. FCP13041)	
LOCATION DATA	ABBREVIATIO	DNS	SCOPE	E OF WORK
DUPONT TENNIS COURTS RESTROOMS 340 31st Ave, San Francisco, CA 94121 Block No.1403 - Lot No. 007	Angle FL. Floor Angle FLASH. Flashing Conterline F.O.C. Face of Conc. Diameter or Round F.O.F. Face of Finish Existing F.O.S. Face of Studs	PL. Plate P. LAM. Plastic Laminate PLAS. Plaster PLYWD. Plywood PR. Pair	under the jurisdiction of the Recreation and Park Department.	ng free-standing restroom buildings and provide universal access in public parks OURTS as part of the RESTROOM BOND PROGRAM includes the demolition of
PROJECT DATA	(N) New F.O.W. Face of Wall (D) Demolition F.S. Full Size A.D. Area Drain FT. Foot or Feet	PT. Point R. Riser RAD. Radius REF. Reference		en's and women's and plumbing chase, all in compliance with ADA regulations,
SITE AREA EXISTING PROPERTY SQ. FT. UNCHOCCUPANCY B UNCHOCCUPANCY TYPE OF CONSTRUCTION TYPE V-B UNCH	ED Disabilities Act FURR. Furring ADJ. Adjustable FUT. Future A.F.F. Above Finish Floor GA. Gauge	REFR. Refrigerator RGTR. Register REINF. Reinforcement	DRAWING INDEX	GENERAL NOTES
NUMBER OF STORIES 1 UNCH FLOOR AREA 290 SQ. FT. 270 S.	AL. Aluminum APPROX.Approximate ARCH. Architectural B.D. Board BLDG. Building AL. Aluminum GL. Glass GND. Ground GR. Grade GYP. Gypsum	REQ. Required RESIL. Resilient RM. Room R.O. Rough Opening RWD. Redwood R.W.L. Rain Water Leadel		ALL CONSTRUCTION AND INSTALLATION WORK SHOWN IN DRAWINGS OR INDICATED IN SPECIFICATIONS SHALL CONFORM TO ALL APPLICABLE CODES AND ORDINANCES OF GOVERNMENTAL AGENCIES HAVING JURISDICTION OVER THE PROJECT. PROTECT ALL UTILITIES, IMPROVEMENTS AND STRUCTURES AND RESTORE TO NEW CONDITION AT NO ADDITIONAL COST TO THE CITY IF DAMAGED DURING THE COURSE OF WORK.
OCCUPANCY LOAD 2 OFF STREET OPEN PARKING 0 CURB SIDE PARKING 0	BLK. Block GFI. Ground Fault Interrupter CEM. Cement H.B. Hose Bibb CER. Ceramic H.C. Hollow Core CLG. Ceiling HDWD. Hardwood CLKG. Caulking HDWE. Hardware	S. South S.C. Solid Core SCHED. Schedule SECT. Section SHR. Shower SHT. Sheet	A2.1 CONCRETE FORM PATTERN FLOOR PLAN & ELEVATIONS A3.0 ELEVATIONS & SECTIONS A3.1 WALL SECTIONS & DETAILS A4.0 INTERIOR ELEVATIONS A7.0 DOOR & WINDOW DETAILS A8.0 EXTERIOR DETAILS	 VERIFY THAT EXISTING CONDITIONS ARE AS INDICATED ON THE DRAWINGS AND SPECIFICATIONS. VERIFY ALL (E) BUILDING DIMENSIONS PRIOR TO STARTING CONSTRUCTION. NOTIFY THE CITY REPRESENTATIVE IMMEDIATELY OF VARIATIONS OR DISCREPANCIES. DO NOT PROCEED WITH AFFECTED WORK UNTIL THE VARIATIONS OR DISCREPANCIES ARE RESOLVED BY THE CITY REPRESENTATIVE. 4 SUBMIT SHOP DRAWINGS FOR ALL CUSTOM WORK.
BUILDING FOOTPRINT AREA: TOTAL: 270 S.F.	CLO. Closet H.M. Hollow Metal CLR. Clear HORIZ. Horizontal HR. Hour CONC. Concrete CONN. Connection CONSTR.Construction H.M. Hollow Metal HR. Hour HT. Height I.D. Inside Diameter	SIM. Similar SPEC. Specification SQ. Square S.S.D. See Structural	A11.0 ACCESSIBILITY INFORMATION A11.1 ACCESSIBILITY DETAILS A11.2 ACCESSIBILITY DETAILS A11.3 (E) RESTROOM PLUMBING CHASE PHOTOS STRUCTURAL - 15 SHEETS	 5 ALL LARGE SCALE DRAWINGS TAKE PRECEDENCE OVER SMALLER SCALE DRAWINGS. DETAILS TAKE PRECEDENCE OVER ALL DRAWINGS. 6 ALL DIMENSIONS SHOWN ARE TO FACE OF STUD, U.O.N. ALL DIMENSIONS NOTED "CLEAR" OR "CLR." MUST BE STRICTLY MAINTAINED. 8 "SIMILAR" OR "SIM." MEANS HAVING COMPARABLE CHARACTERISTICS FOR THE CONDITIONS NOTED. VERIFY DIMENSIONS AND ORIENTATION ON PLAN AND/OR FLEVATIONS

CODE COMPLIANCE

THE GENERAL CONTRACTOR IS RESPONSIBLE FOR COMPLETING THE CONSTRUCTION OF THIS PROJECT IN ACCORDANCE WITH THE FOLLOWING FEDERAL, STATE AND LOCAL CODES INCLUDING THEIR MOST RECENT AMENDMENTS AND REVISIONS.

2010 CALIFORNIA BUILDING CODE (CBC) WITH 2010 SAN FRANCISCO AMENDMENTS

2010 CALIFORNIA ELECTRICAL CODE (CEC) WITH 2010 SAN FRANCISCO AMENDMENTS

2010 CALIFORNIA MECHANICAL CODE (CMC) WITH 2010 SAN FRANCISCO AMENDMENTS

2010 CALIFORNIA PLUMBING CODE (CPC) WITH 2010 SAN FRANCISCO AMENDMENTS

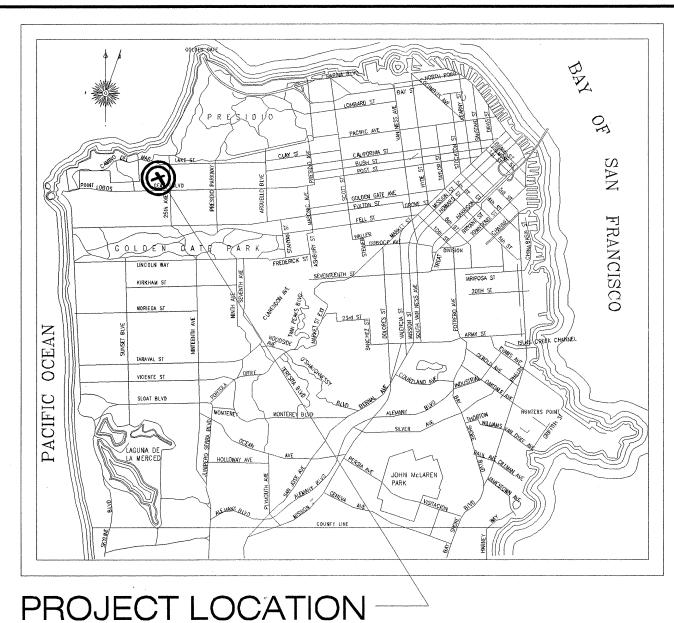
2010 CALIFORNIA ENERGY CODE

INCLUDING LATEST ADA REGULATIONS AND ALL AMENDMENTS TO THE ABOVE

2010 ADA STANDARDS FOR ACCESSIBLE DESIGN

IN ACCORDANCE WITH THE PROVISIONS OF THE CALIFORNIA PUBLIC CONTRACT CODE SECTION 03300, A BID SUBMITTED TO A PUBLIC AGENCY BY A CONTRACTOR WHO IS NOT LICENSED IN ACCORDANCE WITH CHAPTER 9 OF THE BUSINESS AND PROFESSIONS CODE SHALL BE REJECTED BY THE PUBLIC AGENCY. AT THE TIME THE CONTRACT IS BID, THE CONTRACTOR SHALL POSSESS CLASS 'B' GENERAL ENGINEERING OR CLASS 'B' GENERAL BUILDING CONTRACTOR'S LICENSE.

PROJECT LOCATION



N.T.S. Not to Scale Overall OBS. Obscure

Mullion North Not In Contract Number NOM. Nominal O.C. On Center OPNG. Opening Owner Furnishing Contractor Install

Joint

MECH. Mechanical

MEMB. Membrane

MIN.

M.O.

Metal

Mirror

Kitchen

Laminate

Lavatory

Maximum

Continuous

Corridor

Center

Double

Detail

Down

Door

Drawing

Elevation

Electrical

Equipment

Elevator

Existing

Exposed

Exterior

Finish

Expansion

Floor Drain

Foundation

Diameter

Door Opening

Drinking Fountain

Expansion Joint

DBL.

DET.

DIA.

DIM

DN. D.O DR.

DWG DF.

ELEV

EQPT

EXST

EXPO

EXP.

EXT

FDN.

FIN.

T.P. Minimum T.V. T.W. Miscellaneous TYP. Masonry Opening W.C.

Television Top of Wall

TEL.

THK

Typical Unfinished Unless Otherwise Noted Vertical Vestibule Verify in field West Water Closet Wood Without Waterproof WSCT Wainscot Weight

Window

Drawings

Standard

Storage

Structural

Suspended

Symmetrical

Top of Curb

Top of Pavement

Telephone

Thick

Stainless Steel

E-2 E-4 E-5 E-6

S1.2

\$1.3

S1.5

\$2.1

\$4.1

S4.2

S5.1

S6.2

S6.3

\$6.4

L-2.0

L-5.0

L-5.1

L-5.2

L-5.3

P-5

M-1

M-2

SINGLE LINE DIAGRAM AND PANEL SCHEDULE INDOOR TITLE 24 DOCUMENTATION **OUTDOOR TITLE 24 DOCUMENTATION** ELECTRICAL SITE PLAN ELECTRICAL LIGHTING PLAN & POWER PLAN MECHANICAL / PLUMBING - 7 SHEETS

ELECTRICAL LEGEND & ABBREVIATIONS

STRUCTURAL GENERAL NOTES

STRUCTURAL GENERAL NOTES

STRUCTURAL GENERAL NOTES

TYPICAL CONCRETE DETAILS

TYPICAL CONCRETE DETAILS

FOUNDATION DETAILS

WALL ELEVATIONS

ROOF DETAILS

DETAILS

FOUNDATION AND ROOF PLANS

WALL SECTIONS AND DETAILS

RETAINING WALL DETAILS

RETAINING WALL DETAILS

ACCESSIBILITY PLAN

CONSTRUCTION DETAILS

CONSTRUCTION DETAILS

CONSTRUCTION DETAILS

CONSTRUCTION DETAILS

LAYOUT PLAN

GRADING PLAN

PLANTING PLAN

GENERAL NOTES

RETAINING WALLS PLAN AND ELEVATION

DRAWING INDEX, NOTES & ABBREVIATIONS

EXISTING CONDITIONS AND DEMOLITION PLAN

PLUMBING ABBREVIATIONS, SYMBOLS AND LEGEND, GENERAL NOTES & DRAWING LIST PLUMBING SCHEDULES SITE PLAN PLUMBING FLOOR AND ROOF PLANS

LANDSCAPE - 10 SHEETS

ELECTRICAL - 7 SHEETS

PLUMBING DETAILS MECHANICAL ABBREVIATIONS, SYMBOLS AND LEGEND, AND DRAWING LIST MECHANICAL FLOOR PLAN, SCHEDULES AND GENERAL NOTES

HAZARDOUS MATERIALS REMOVAL

TOTAL SHEETS: 52? 53

NOTES

- WORK SHOWN IN DRAWINGS OR INDICATED IN APPLICABLE CODES AND ORDINANCES OF DICTION OVER THE PROJECT.
- AS INDICATED ON THE DRAWINGS AND DIMENSIONS PRIOR TO STARTING SENTATIVE IMMEDIATELY OF VARIATIONS OR
- AFFECTED WORK UNTIL THE VARIATIONS OR
- EDENCE OVER SMALLER SCALE DRAWINGS. RAWINGS.
- F STUD, U.O.N. ALL DIMENSIONS NOTED INTAINED.
- ARABLE CHARACTERISTICS FOR THE IS AND ORIENTATION ON PLAN AND/ OR
- ELEVATIONS. UPON COMPLETION OF THE WORK OR SHORTLY BEFORE, THE CONTRACTOR SHALL PREPARE A "PUNCH-LIST" OF CORRECTIONS UNSATISFACTORY, AND/OR INCOMPLETE
- WHEN PROJECT IS COMPLETE CLEAN AND POLISH ALL NEW GLASS, HARDWARE. RESILIENT FLOORING, CERAMIC TILE AND OTHER SUCH ITEMS WITH FACTORY FINISH. REMOVE ALL DUST WITH TREATED DUST CLOTHS OR VACUUM CLEANERS.
- PROVIDE AND MAINTAIN TEMPORARY BARRICADES, CLOSURE WALLS, ETC., AS REQUIRED TO PROTECT THE PUBLIC DURING PERIOD OF CONSTRUCTION.
- 12 INSTALL MANUFACTURED MATERIALS AND EQUIPMENT ACCORDING TO MANUFACTURER'S RECOMMENDATIONS AND INSTRUCTIONS, (U.O.N.) 13 WORK REQUIRED UNDER THIS CONTRACT INCLUDES ALL LABOR, MATERIALS, EQUIPMENT,
- ETC. NECESSARY TO COMPLETE THE PROJECT.
- "TYPICAL" OR "TYP." SHALL INDICATE STANDARD FOR OTHER LIKE CONDITIONS THROUGHOUT THE WORK.
- 15 DO NOT SCALE DRAWINGS. USE DIMENSIONS SHOWN

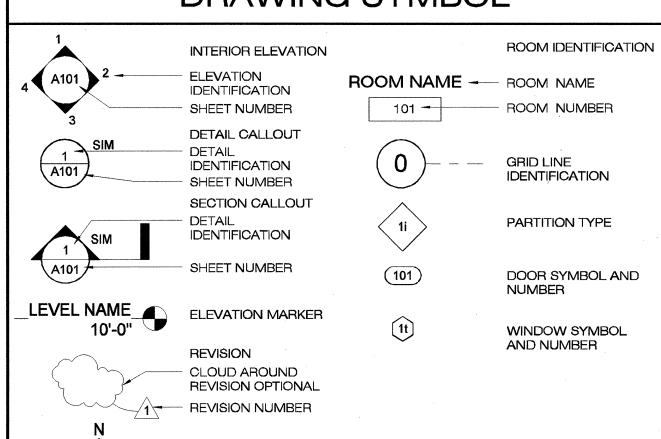
WORK FOR THE ARCHITECT'S REVIEW.

16 INSTALL ALL WORK PLUMB, LEVEL AND STRAIGHT.

0 AND DIVISION 1 OF THE SPECIFICATIONS.

- 17 ALL DIMENSIONS NOTED "CLEAR" OR "CLR." MUST BE STRICTLY MAINTAINED. 18 ALL PARTITION LOCATIONS, DIMENSIONS, TYPES, ETC., AND ALL DOOR LOCATIONS SHALL BE AS SHOWN ON FLOOR PLANS. IN CASE OF CONFLICT, DISCREPANCIES SHALL BE
- RESOLVED BY THE ARCHITECT. OR SHALL BE LOCATED 4 INCHES FROM FINISHED WALL TO EDGE OF THE DOOR AT THE
- JAMB OPENING, UNLESS OTHERWISE NOTED. 20 WOOD USED IN ALL EXTERIOR LOCATIONS INCLUDING THE ROOF OR LOCATED WITHIN 6 INCHES OF EARTH/SOIL SHALL BE PRESSURE TREATED WOOD. ALL EXTERIOR PLYWOOD SHEATING OR PLYWOOD LOCATED ON THE ROOF SHALL BE EXTERIOR GRADE WATER RESISTANT PLYWOOD, SIZE AND GRADE AS SPECIFIED AND AS SHOWN ON THE
- THE CONTRACTOR SHALL BE SOLELY RESPONSIBLE FOR SECURITY OF THE SITE DURING THE TERM OF THE CONTRACT. ANY DAMAGE OR LOSS OF PROPERTY DURING THE TERM OF THE CONTRACT SHALL BE REPAIRED OR REPLACED BY THE CONTRACTOR AT NO COST
- 22 IN ACCORDANCE WITH CALIFORNIA PUBLIC CONTRACT CODE SECTION 3300, THE CITY HAS DETERMINED THAT THE CONTRACTOR SHALL POSSESS A VALID GENERAL BUILDING CLASS B CONTRACTOR'S LICENSE AT THE TIME THAT THE CONTRACT IS AWARDED.
- 23 ALL ASBESTOS CONTAINING MATERIAL WILL BE REMOVED BY CONTRACTOR BEFORE BUILDING DEMOLITION PHASE. REMOVAL AND DISPOSAL OF LEAD CONTAINING PAINT AS EXISTS ON BUILDING CONSTRUCTION TO BE DEMOLISHED SHALL BE PERFORMED BY THE GENERAL CONTRACTOR. HAZARDOUS ABATEMENT SUBCONTRACTOR(S) HIRED TO PERFORM SUCH WORK SHALL LICENSED PER THE REQUIREMENTS OUTLINED IN DIVISION
- ALL WORK AS SHOWN BY THE NOTES ON THE DRAWINGS IS ASSUMED TO BE NEW WORK (N), UNLESS OTHERWISE INDICATED AS (E) OR EXISTING WORK TO REMAIN.

DRAWING SYMBOL



PROJECT NORTH

DEPARTMENT OF PUBLIC WORKS CITY AND COUNTY OF SAN FRANCISCO

Fuad S. Sweiss - City Engineer

BUILDING DESIGN & CONSTRUCTION



Architecture • Construction

Tara D. Lamont - Acting Deputy Division Manager 30 Van Ness Avenue San Francisco, CA Fax (415)557-4701

Project

94102-6028

2008 PARK BOND RESTROOM REPLACEMENT PROJECT **CONTEMPORARY DESIGN**

(415)557-4700

DUPONT TENNIS COURTS RESTROOMS 340 31st Ave, San Francisco, CA 94121 Block No.1403 - Lot No. 007

Consultant

BID SET

		No.	Date	Revisions
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Т				
2				
3				
	l .		***************************************	

Section Head T. LEUNG Proj. Mgr. Proj. Arch. T. LEUNG Drawn JG/AP SEP 2012 Phase

Drawing Title

GENERAL INFORMATION

Sheet No.

As indicated Job No. 3092V-2

Original Sheet Size: 22"x34"

INDOOR WATER USE COMPLIANCE FORMS

PRESCRIPTIVE APPROACH

Each fixture must not exceed the maximum flow rates at 20% reduction in Table 13C.5.303.2.3. All fixtures must meet the standards referenced in Table 13C.5.303.6. Tables are summarized below:

Fixture Type	Maximum Prescriptive Flow Rate	Referenced Standard from Table 13C.5.303.5		
Showerheads ²	2 gpm @80 psi	n/a		
Lavatory faucets - nonresidential	0.4 gpm @ 60 psi	ASME A112.18.1/CSAB125.1		
Kitchen faucets	1.8 gpm @ 60 psi	n/a		
Wash fountains	1.8 [rim space (in.)/20 gpm @ 60 psi]	n/a		
Metering faucets	.20 gallons/cycle	ASME A112.18.1/CSAB125.1		
Metering faucets for wash foun- tains	.20 [rim space (in.)/20 gpm @ 60 psi]	n/a		
Tank-type water closets	1.28 gallons/flush ¹	U.S. EPA WaterSense Tank-Type High Efficiency Toilet Specification		
Flushometer valve water closets	1.28 gallons/flush1	ASME A112.19.2/CSA B45.1 - 1.28 gal (4.8 L)		
Urinals	0.5 gallons/flush	ASME A112.19.2/CSA B45.1 - 0.5 gal (1.9 L)		

1) For dual flush toilets, effective flush volume is defined as the average volume of two reduced flushes and one full flush. The eferenced standard is ASME A112.19.14 and USEPA WaterSense Tank-Type High Efficiency Toilet Specification - 1.28 gal (4.8 2) The combined flow rate of all showerheads in one shower stall not exceed the maximum flow rate for one showerhead, or the shower shall be designed to allow only one showerhead to be in operation at a time (13C.5.303.2.1.3). Table above is a summary

PERFORMANCE APPROACH

only. See full text of San Francisco Building Code for details.

ill in all blank cells in both tables below. The number of occupants using each fixture type must be the same in both the Base and Design cases. If there are no fixtures of a type in your project, enter "0" for number of occupants. Multiply each row to mine the amount of water used in each fixture type, then sum the last column to determine the total daily water use. Take 809 baseline case to be the maximum allowable water use (corresponding to the required 20% reduction). The Total Design Case Daily Water Usage use from Worksheet WS-2 must not exceed the Total Allowable

Daily Water Usage from Worksheet WS-1.

Norksheet WS-1 (summary) Baseline & Allowable Water Use

Fixture Type	Daily Use		Occupants ²		Baseline Flow Rate		Bas line Usage (gallons per day)
Showerhead	5 ain.	х		x	2.5 gpm	=	
Showerhead - residential	8 min	х		х	2.5 gpm	==	
Lavatory faucets	0.25 min	×		x	0.5 gpm	: :::::::::::::::::::::::::::::::	
Lavatory faucets -	0.75 min.			х	2.2 gpm	=	
Kitchen faucets	4 min.	x		х	2.2 gpm	1	
Metering faucets	3	x		×	0.25 gal	=	
Water closets (all types)	1 male ¹ 3 female	x		x	1.6 gal	deplication of the state of the	
Urinals	2 male	х	V	x	10 gal	=	٧
:			Total Bas	line	Case Daily U	lsage:	

 The daily use number shall be increased to three if urinals are not installed in the room.
 For non-residential occupancies, refer to table A, chapter 4, 2010 California Plumbing Code for occupant load 3) Fixtures and fittings must meet the standards referenced in Table 13C5.303.6, see above.

4) Table above is a summary only. See full text of San Francisto Building Code for details.

3 female

Workshoot WS-2 (summary) - Design Water Use (gallons per day) 5 min. faucets -

Total Baseline Case Daily Usage:

City and County of San Francisco Green Building Submittal: **Specific Locally Required Measures Only**

REQUIREMENTS

Check the box by each measure to indicate that you intend to comply with the listed requirement. For each requirement, use the "Plan Set Location" column to indicate where in the submittal documents compliance with the requirement can be verified.

An abbreviated summary of each requirement is included for reference. Projects seeking LEED certification may voluntarily use the "LEED" submittal as an alternative to this form.

(If items in the "Reference" column are not applicable, indicate "N/A."

2) Table above is a summary only. See full text of San Francisco Building Code for details.

3. Requirements for additions or alterations apply to applications received on or after July 1, 2012.

1) This submittal form is approved for all applicable projects submitting initial application for building permit beginning January 1, 2011. (Form last updated July 18, 2012)

REQUIRED MEASURES			Reference (Indicate Plan Set Sheet & Detail, or Specification, where applicable)
Type of Project:	Other New Non-Residential	Addition >2,000 sq ft OR Alteration >500,000 ³	
Construction Waste Management - 100% of mixed debris must be transported by a registered hauler to a registered facility and be processed for recycling, in compliance with the San Francisco Construction & Demolition Debris Ordinance		•	
Recycling by Occupants: Provide adequate space and equal access for storage, collection and loading of compostable, recyclable and landfill materials. (13C.5.410.1, et al) - See Administrative Bulletin 088.	•	•	
Energy Efficiency: Demonstrate a 15% energy use reduction compared to 2008 California Energy Code, Title 24, Part 6 (13C.5.201.1.1)	•	n/r	
Construction Site Runoff Pollution Prevention: Provide a construction site Stormwater Pollution Prevention Plan (13C.5.103.1.6)	•	If applicable	
Stormwater Control Plan: Projects disturbing ≥ 5,000 square feet must implement a Stormwater Control Plan meeting SFPUC Stormwater Design Guidelines (13C.5.103.1.6)	•	If applicable	
Water Efficiency Irrigation: Projects that include ≥ 1,000 square feet of new or modified landscape must comply with the San Francisco Water Efficient Irrigation Ordinance	•	If applicable	
Bicycle parking: Provide short-term and long-term bicycle parking for 5% of total motorized parking capacity each, or meet San Francisco Planning Code Sec 155, whichever is greater (or LEED credit SSc4.2), (13C.5.106.4)	•	•	
Fuel efficient vehicle and carpool parking: Provide stall marking for low-emitting, fuel efficient, and carpool/van pool vehicles; approximately 8% of total spaces (13C.5.106.5)	•	•	
Light pollution reduction: Contain lighting within each source. No more than .01 horizontal footcandles 15 feet beyond site (or LEED credit SS 8), (13C.5.106.8)	•	n/r	
Water Meters: Provide submeters for spaces projected to consume >1,000 gal/day, or >100 gal/day if in buildings over 50,000 sq. ft. (13C.5.303.1)	•		
Indoor Water Efficiency: Reduce overall use of potable water within the building by 20% for showerheads, lavatories, kitchen faucets, wash fountains, water closets, and urinals (13C.5.303.2)	•	•	PLUMBING FIXTURES FLOW RATES COMPLY WITH INDOOR WATER USE COMPLIANCE PRESCRIPTIVE APPROACH PER PLUMBING FIXTURE SCHEDULE, DWG P-2
Commissioning: For new buildings greater than 10,000 square feet, commissioning shall be included in the design and construction of the project to verify that the building systems and components meet the owner's project requirements (13C.5.410.2)	OR	● (Testing &	
OR for buildings less than 10,000 square feet, testing and adjusting of systems is required (13C.5.410.4). Protect duct openings and mechanical equipment during construction (13C.5.504.3)		Adjusting)	
Adhesives, sealants, and caulks: Comply with VOC limits in SCAQMD Rule 1168 VOC limits and			IOINIT CEALANITE COECIFICATION CECTION 07.00.00.1 OF A.7.
California Code of Regulations Title 17 for aerosol adhesives (13C.5.504.4.1) Paints and coatings: Comply with VOC limits in the Air Resources Board Architectural Coatings			JOINT SEALANTS SPECIFICATION SECTION 07 92 00, 1.05, A,7 PAINTING SPECIFICATION SECTION 09 91 00, 1.5, D
Carpet: All carpet must meet one of the following: 1. Carpet and Rug Institute Green Label Plus Program 2. California Department of Public Health Standard Practice for the testing of VOCs (Specification 01350) 3. NSF/ANSI 140 at the Gold level 4. Scientific Certifications Systems Sustainable Choice AND Carpet cushion must meet CRI Green Label, AND Carpet adhesive must not exceed 50 g/L VOC content (13C.5.504.4.4)	•	•	N/A
Composite wood: Meet CARB Air Toxics Control Measure for Composite Wood (13C.5.504.4.5)	•	•	N/A
Resilient flooring systems: For 50% of floor area receiving resilient flooring, install resilient flooring complying with the VOC-emission limits defined in the 2009 Collaborative for High Performance Schools (CHPS) criteria or certified under the Resilient Floor Covering Institute (RFCI) FloorScore Program (13C.5.504.4.6)	•	•	N/A
Environmental Tobacco Smoke: Prohibit smoking within 25 feet of building entries, outdoor air intakes, and operable windows (13C.5.504.7)	•	•	
Air Filtration: Provide at least MERV-8 filters in regularly occupied spaces of mechanically ventilated buildings (13C.5.504.5.3)	•	Limited exceptions. See CalGreen 5.714.6	
Acoustical Control: Wall and roof-ceilings STC 50, exterior windows STC 30, party walls and floor ceilings STC 40 (13C.5.507.4)	. •	See CalGreen 5,714.7	
CFC and Halons: Do not install equipment that contains CFCs or Halons (13C.5.508.1)	•	•	N/A
Additional Requirement for New A, B, I, OR M Occupancy Projects 5,000 - 25,000 Square Feet			
Construction Waste Management - Divert 75% of construction and demolition debris (i.e. 10% more than required by the San Francisco Construction & Demolition Debris Ordinance)	•	Meet Construction & Demolition Ordinance	
Renewable Energy or Enhanced Energy Efficiency - Effective January 1, 2012: Generate renewable energy on-site equal to ≥1% of total annual energy cost (LEED EAc2), OR demonstrate an additional 10% energy use reduction (total of 25% compared to Title 24 Part 6 2008), OR purchase Green-E certified renewable energy credits for 35% of total electricity use (LEED EAc6).	•	n/r	

Please indicate how fulfillment of green building requirements will be verified. A separate "FINAL COMPLIANCE VERIFICATION" form will be required prior to

DUPONT TENNIS COURTS RESTROOMS

Project Name

1403/007

Block/Lot

Gross Building Area

MAURICE CHEE

DEPARTMENT OF PUBLIC WORKS,

To the best of my knowledge, it is my professional opinion the Green Building requirements of the City of San Francisco will be met for the above referenced project. have been retained by the project sponsor to review all submittal documents and asssure that approved construction documents and construction properly reflect the Green Building requirements of Chapter 13C. I will notify the Department of Building Inspection if I believe to the best of my knowledge that the project will, for any reason, not substantially comply with these green building requirements, or if I am no longer the Green Building

Affix professional stamp:

Licensed Professional: Sign & Date

VERIFICATION

final Certificate of Completion. For details, see Administrative Bulletin 93, Page 6.

340 31ST AVENUE, SF CA 94121

Address

Primary Occupancy

270 SQUARE FEET

The Green Building Compliance Professional of Record for the project

CITY AND COUNTY OF SAN FRANCISCO,

INFRASTRUCTURE DESIGN AND CONSTRUCTION DIVISION

M026610

Architectural or Engineering License

I am a LEED Accredited Professional # of Certified LEED Projects Completed:

Compliance Professional of Record fo this project.

Section Head

Proj. Mgr. Proj. Arch.

SEP 2012

Drawing Title

SPECIFIC LOCALLY REQUIRED **MEASURES ONLY**

Sheet No.

A0.1

As indicated Job No. 3092V-2

Original Sheet Size: 22"x34"

BID SET

Date	1 (CVISIONS

DEPARTMENT OF PUBLIC WORKS CITY AND COUNTY OF SAN FRANCISCO

Fuad S. Sweiss - City Engineer

BUILDING DESIGN &

CONSTRUCTION

Architecture • Construction

Tara D. Lamont - Acting Deputy Division Manager

2008 PARK BOND RESTROOM

REPLACEMENT PROJECT CONTEMPORARY DESIGN

DUPONT TENNIS COURTS RESTROOMS 340 31st Ave, San Francisco, CA 94121

Block No.1403 - Lot No. 007

Fax (415)557-4701

(415)557-4700

30 Van Ness Avenue

San Francisco, CA

94102-6028

Consultant

Project

T. LEUNG

T. LEUNG JG/AP

LOCATION MAP

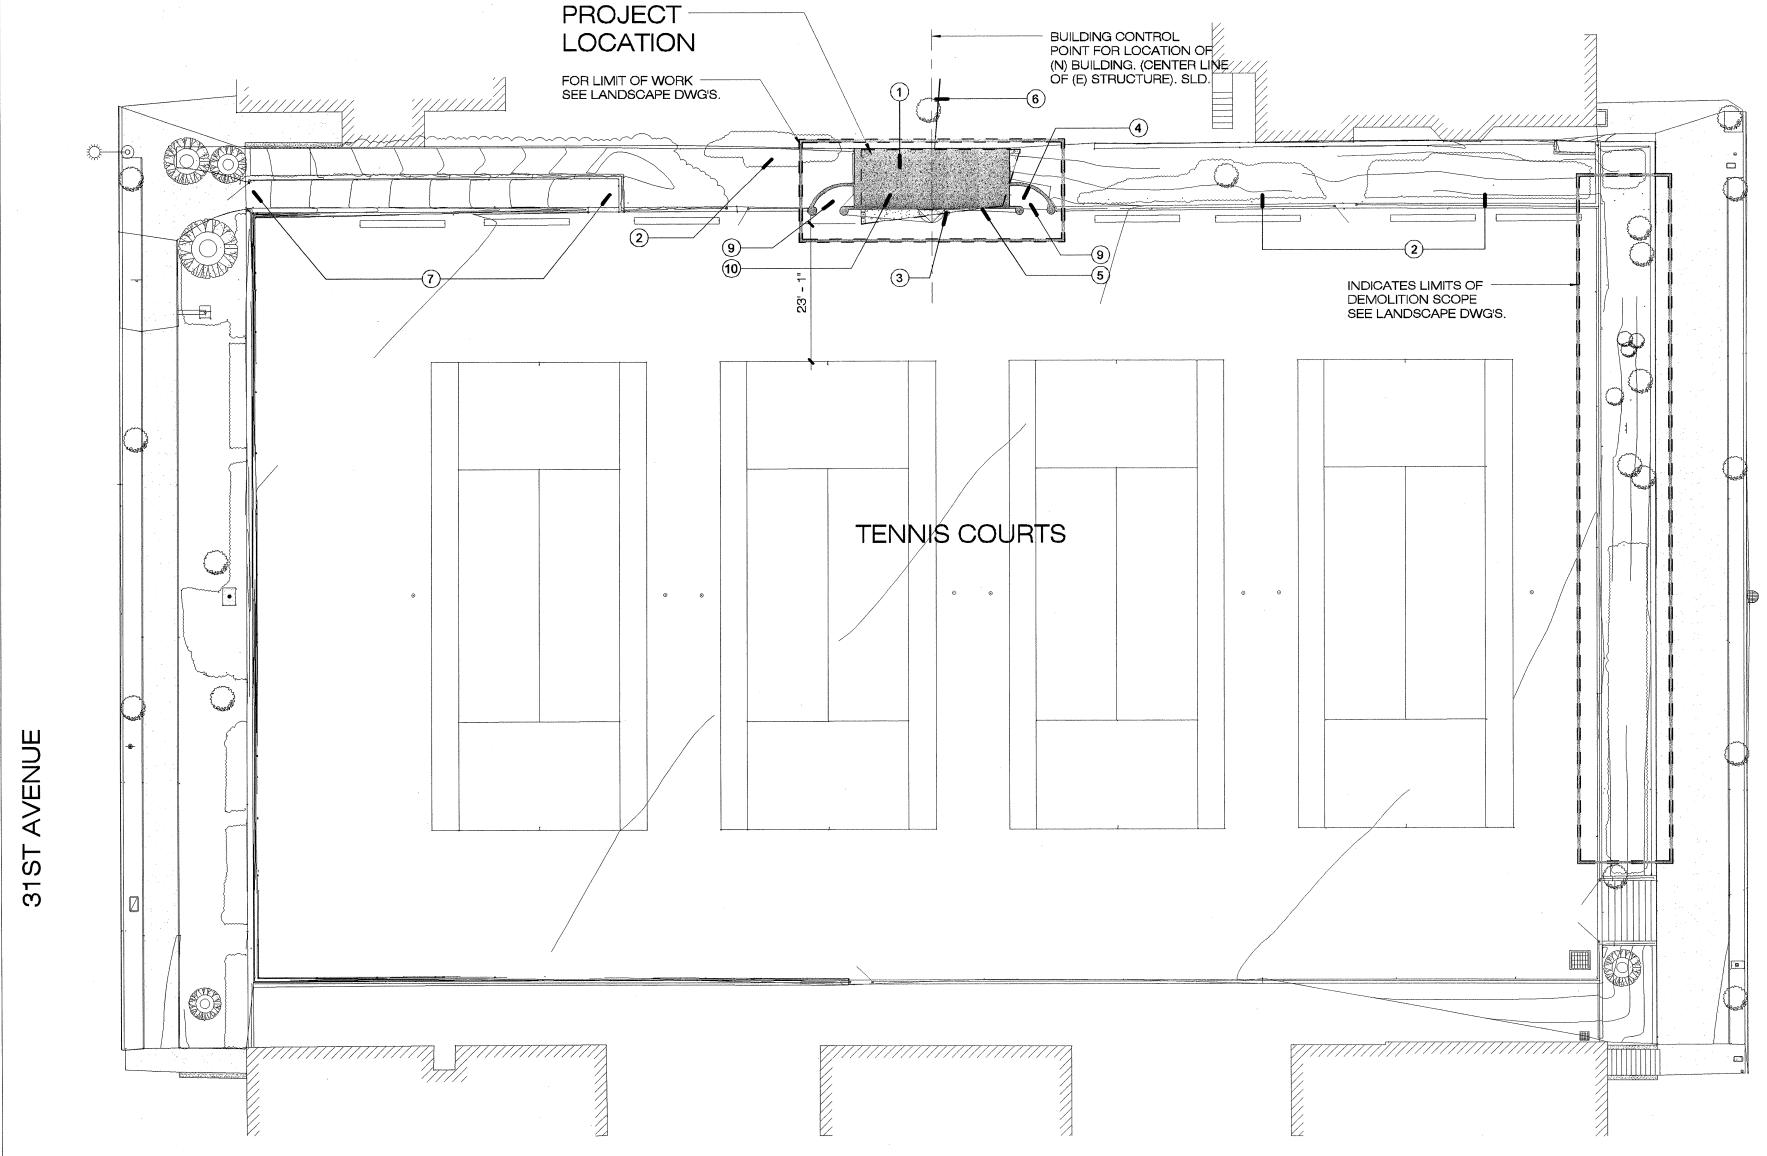
SITE DEMOLITION NOTES - DUPONT COURTS

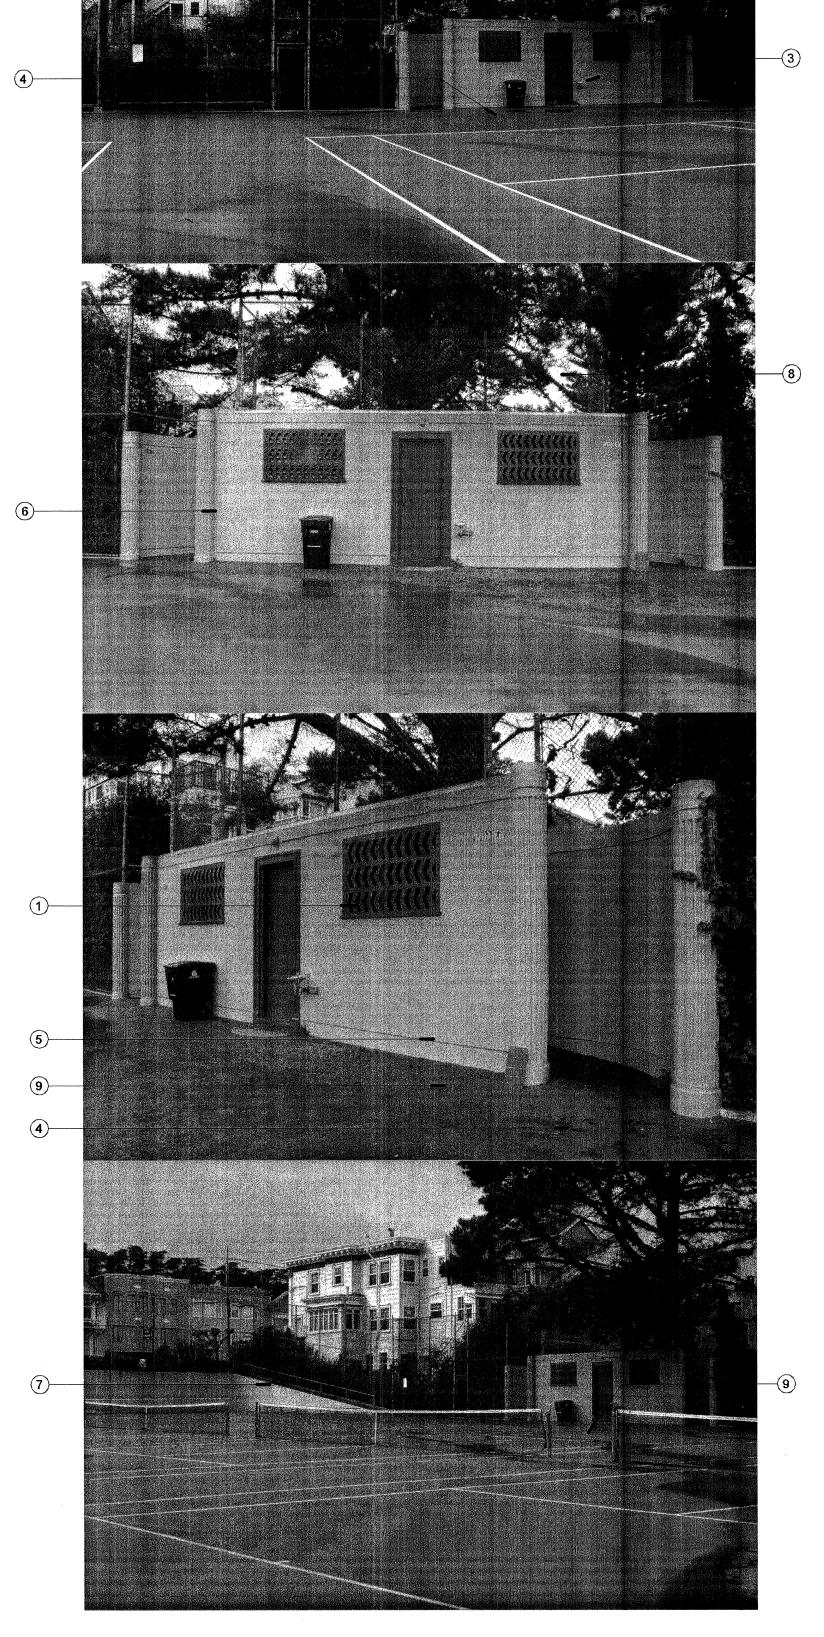
- ONLY SOME OF THE (E) BLDG. COMPONENTS ARE SHOWN FOR CLARITY, SCOPE OF WORK INCLUDES DEMOLITION & REMOVAL OF ALL BLDG. ELEMENTS AND UTILITY CONNECTIONS WHETHER SHOWN OR NOT. U.O.N. BY THESE DRAWINGS & SPECIFICATIONS.
- 2 (E) TREES & VEGETATION TO REMAIN U.O.N. PROTECT DURING CONSTRUCTION. SEE LANDSCAPE FOR ADDITIONAL INFORMATION ON PRESERVATION AND/ OR REPLACMENT. 3 REMOVE (E) DRINKING FOUNTAIN AND PEDESTAL. CAP AND SEAL WATER AND SEWER
- 4 (E) AC PAVING, CONCRETE, CURBS, SITE FURNISHINGS AND PLANTING AROUND (E) BLDG. TO BE REMOVED U.O.N. SEE LANDSCAPE DWG'S. PROVIDE STRAIGHT, CLEAN SAWCUT ALONG (E) PAVING FOR FUTURE TIE-IN OF (N) WORK.
- 5 REMOVE (E) BUILDING PERIMETER FOUNDATION.
- 6 (E) WOOD FENCE IN ADJACENT NEIGHBOOR PROPERTY TO REMAIN. SEE GENERAL NOTE 7 ON THIS SHEET REMOVAL IS REQUIRED.
- 7 (E) CONC. RAMP TO REMAIN, SEE LANDSCAPE DWG'S FOR THE LOCATION OF (N) ACCESSIBLE ENTRY & RAMP.
- 8 REMOVE (E) FENCE ABOVE BUILDING. SEE LANDSCAPE DWG'S FOR ESPECIFIC EXTENT OF THE REMOVAL.
- 9 REMOVE (E) CONC. PAVING AT BLDG. ENTRIES TYP.
- 10 REMOVE AND (E) ELECTRICAL METER, REMOVE CONDUITS TO GROUND LEVEL, ELECTRICAL LINES TO REMAIN FOR FUTURE CONNECTION TO (N) BUILDING.

GENERAL NOTES:

LINES PER CODE.

- 1. CONTRACTOR MUST VERIFY EXISTING SITE CONDITIONS, REQUIREMENTS AND EXACT LOCATION OF UTILITIES.
- 2. (E) WATER AND SEWER LINES TO BE REUSED ON NEW BUILDING, CAP AND SEAL ALL WATER AND SEWER LINES PER CODE.
- 3. CONTRACTOR TO VERIFY IF (E) ELECTRICAL LINES CAN BE REUSED ON NEW BUILDING. OTHERWISE CONTRACTOR SHOULD PROVIDE NEW PG&E RECONNECTION SERVICES. SEE ELECTRICAL DRAWINGS.
- 4. SEE SPECIFICATIONS FOR ADDITIONAL INFORMATION AND REMOVAL OF SELECTED ITEMS.
- 5. SEE SPECIFICATIONS FOR HAZARDOUS MATERIAL REMOVAL.
- 6. SEE LANDSCAPE DWG'S FOR: PATH OF TRAVEL TO ACCESSIBLE PARKING STALL/ CURB RAMPS, PAVING, AND RESTORATION.
- 7. CONTRACTOR SHALL BE RESPONSIBLE FOR THE PROTECTION AND SHALL REPAIR ADJACENT EXISTING AND/ OR NEW SURFACES, AREAS AND PROPERTY THAT MAY BE DAMAGED AS RESULT OF ANY DEMOLITION AND/ OR NEW WORK.





DEPARTMENT OF PUBLIC WORKS CITY AND COUNTY OF SAN FRANCISCO

Fuad S. Sweiss - City Engineer

BUILDING DESIGN & CONSTRUCTION



Architecture • Construction

Tara D. Lamont - Acting Deputy Division Manager Suite 4100 Fax (415)557-4701 (415)557-4700 30 Van Ness Avenue San Francisco, CA

94102-6028

Project

2008 PARK BOND RESTROOM REPLACEMENT PROJECT **CONTEMPORARY DESIGN**

DUPONT TENNIS COURTS RESTROOMS 336 31st Ave, San Francisco, CA 94121 Block No.1403 - Lot No. 007

Consultant

BID SET Revisions

No.

Section Head T. LEUNG Proj. Mgr.

Proj. Arch. Drawn

Drawing Title

SITE PLAN AND **DEMOLITION WORK**

Sheet No.

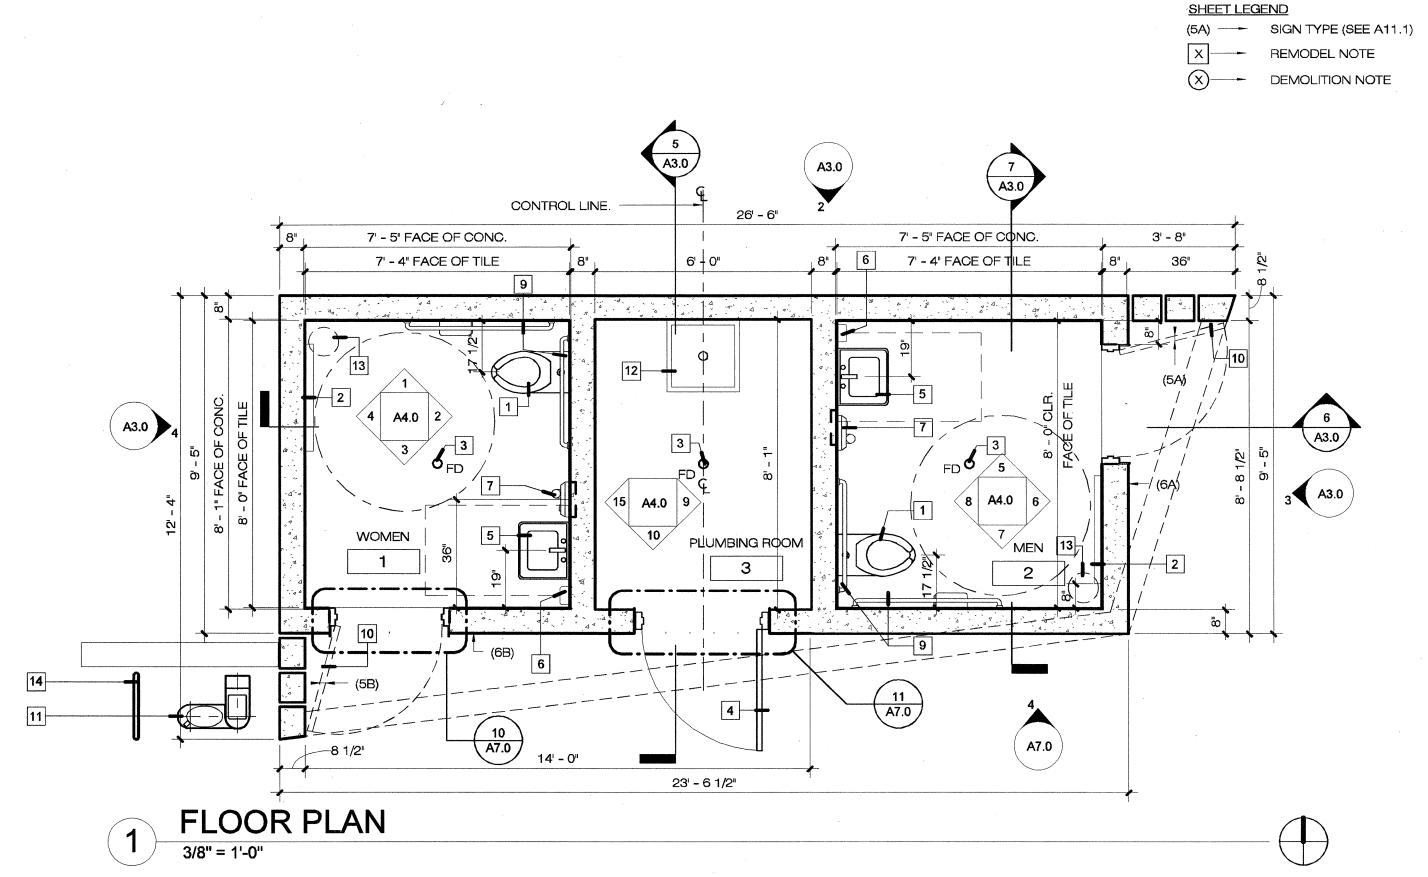
A1.0

As indicated Job No. 3092V-2

SITE PLAN - DUPONT COURTS

30TH

DUPONT COURTS EXISTING VIEWS 3



ROOF PLAN - DUPONT COURTS

GENERAL NOTES:

1. ALL DIMENSIONS ARE GIVEN TO FACE OF WALL, U. O. N.

2. VERIFY EXISTING SITE CONDITIONS, REQUIREMENTS AND EXACT


LOCATION OF UTILITIES.

3. CONTRACTOR SHALL BE RESPONSIBLE FOR THE PROTECTION AND SHALL REPAIR ADJACENT EXISTING AND/ OR NEW SURFACES, AREAS AND PROPERTY THAT MAY BE DAMAGED AS RESULT OF ANY DEMOLITION AND/OR NEW WORK.

4. SEE LANDSCAPE DRAWINGS FOR LOCATION OF DRINKING FOUNTAIN AND WATER BOTTLE FILLER.

FLOOR PLAN NOTES - DUPONT TENNIS COURTS

- 1 STAINLESS STL. WALL MOUNTED TOILET.
- 2 BABY CHANGING STATION (INSTALL 8" OFF FROM ADJACENT WALL TYP.) 3 FLOOR DRAIN
- 4 EXTERIOR MTL. DOOR & FRAME W/ PADLOCK BOX. SEE SHEET A7.0 FOR DETAILS.
- 5 STAINLESS STL. SINK
- 6 SOAP DISPENSER
- 7 | ELECT. HAND DRYER. (O.F.C.I.) SEMI-RECESSED MOUNTED, 4" MAX PROTUSION. SEAL ENTIRE PERIMETER WITH SEALANT TYP. (COORDINATE W/ R&P OFFICIALS TO REQUEST EQUIPMENT AND MOUNTING RECESSED HARDWARE, CONTRACTOR SHALL COORDINATE THE CONCRETE FORM WORK TO PREPARE MOUNTING HARDWARE RECESSED AREA.)
- 9 STAINLESS STL. GRAB BARS. TYP.
- 10 EXTERIOR MTL. DOOR & FRAME W/ WINDOW GRILLE ABOVE. SEE SHEET A7.0 FOR DETAILS.
- 11 STAND ALONE DRINKING FOUNTAIN/ WATER BOTTLE FILLER COMBO. SLD
- 12 FLOOR MOUNTED UTILITY SINK
- 13 TRASH CAN N.I.C.
- 14 DRINKING FOUNTAIN MTL GUARDRAIL. SLD.

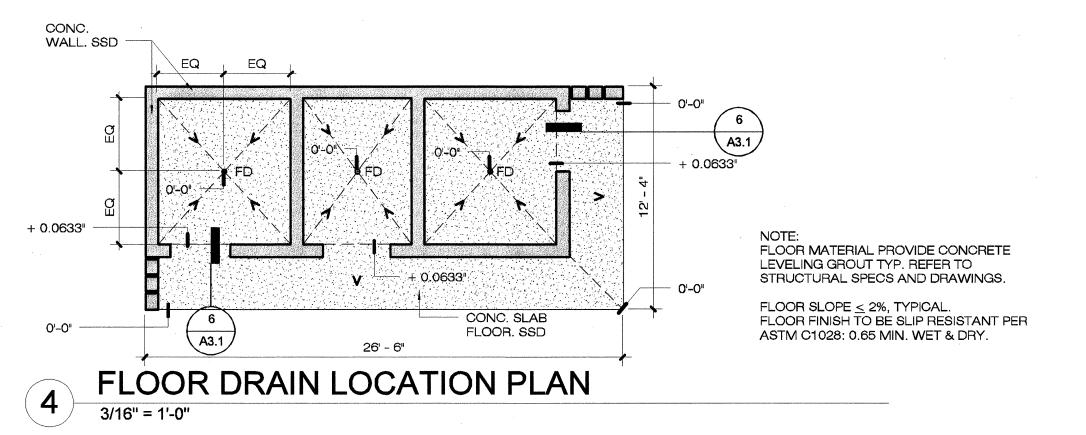


REFLECTING CEILING PLAN - DUPONT COURTS



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Tara D. Lamont - Acting Deputy Division Manager 30 Van Ness Avenue

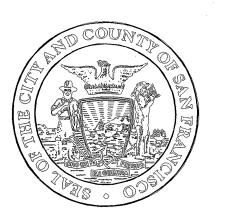Suite 4100 San Francisco, CA Fax (415)557-4701 (415)557-4700


Project

94102-6028

2008 PARK BOND RESTROOM REPLACEMENT PROJECT **CONTEMPORARY DESIGN**

DUPONT TENNIS COURTS RESTROOMS 340 31st Ave, San Francisco, CA 94121 Block No.1403 - Lot No. 007

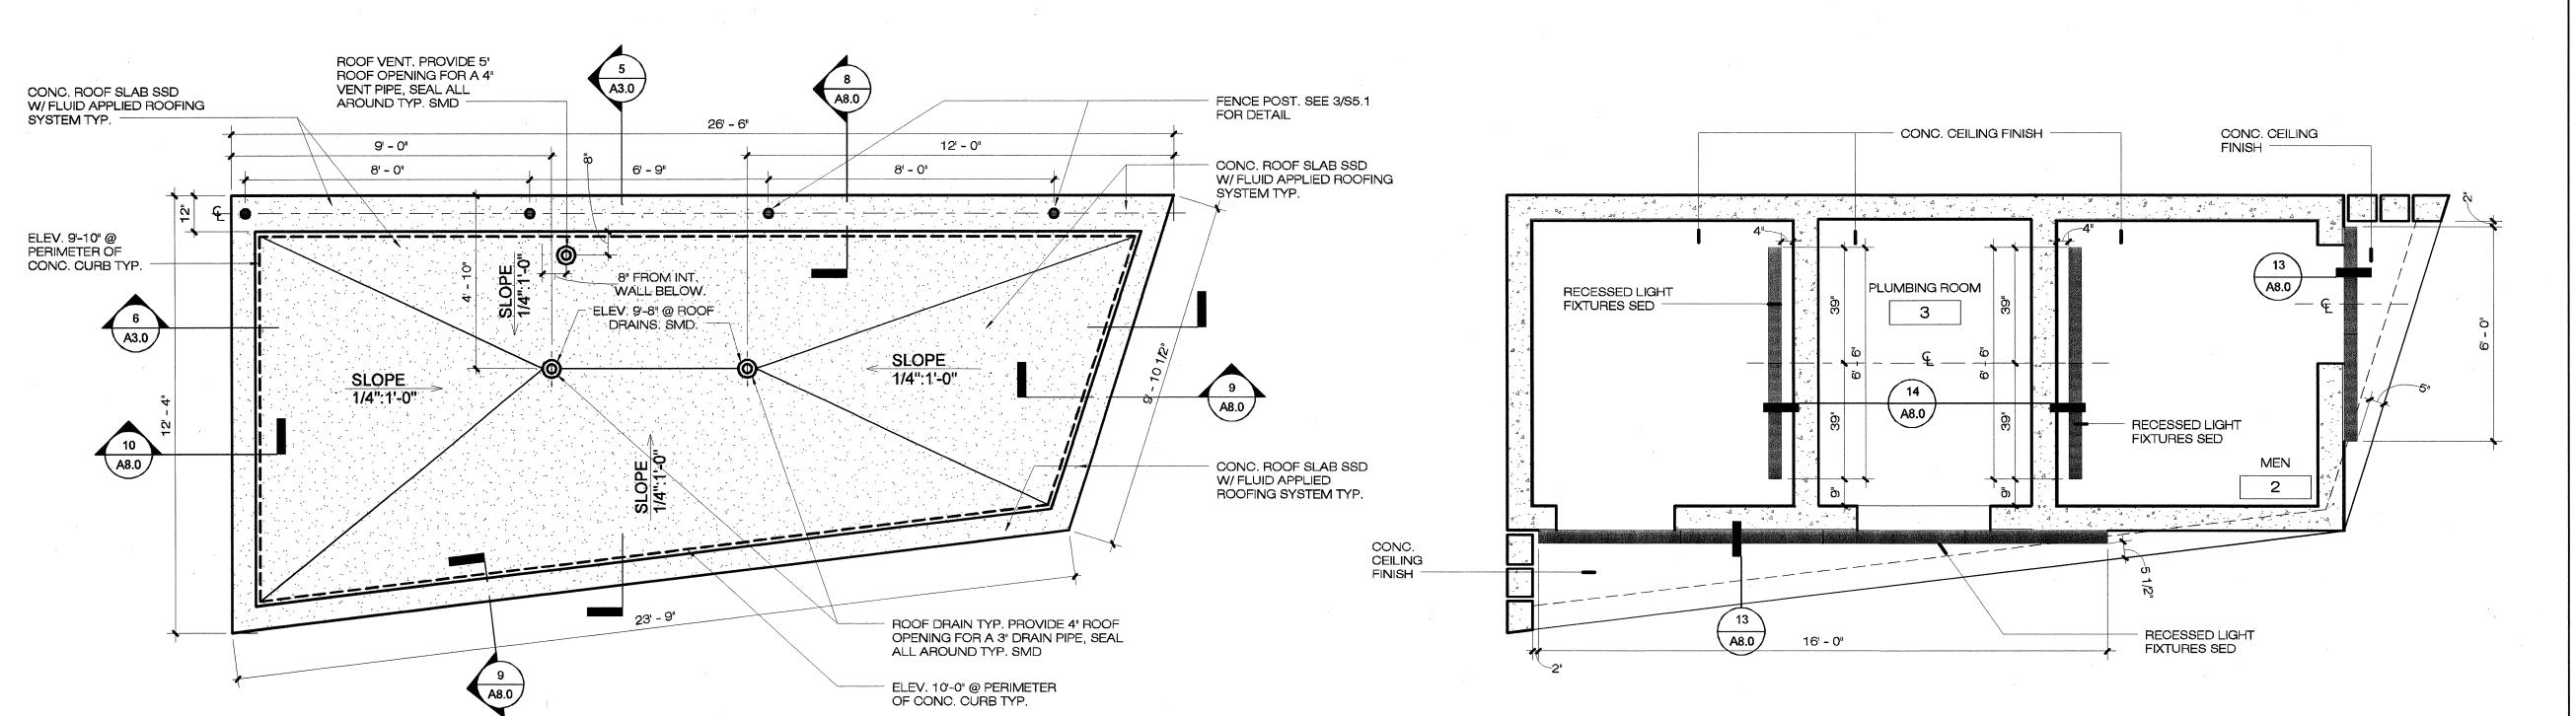Consultant



BID SET

Revisions

Date


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FLOOR, ROOF & CEILING **PLANS**

Sheet No.


A2.0

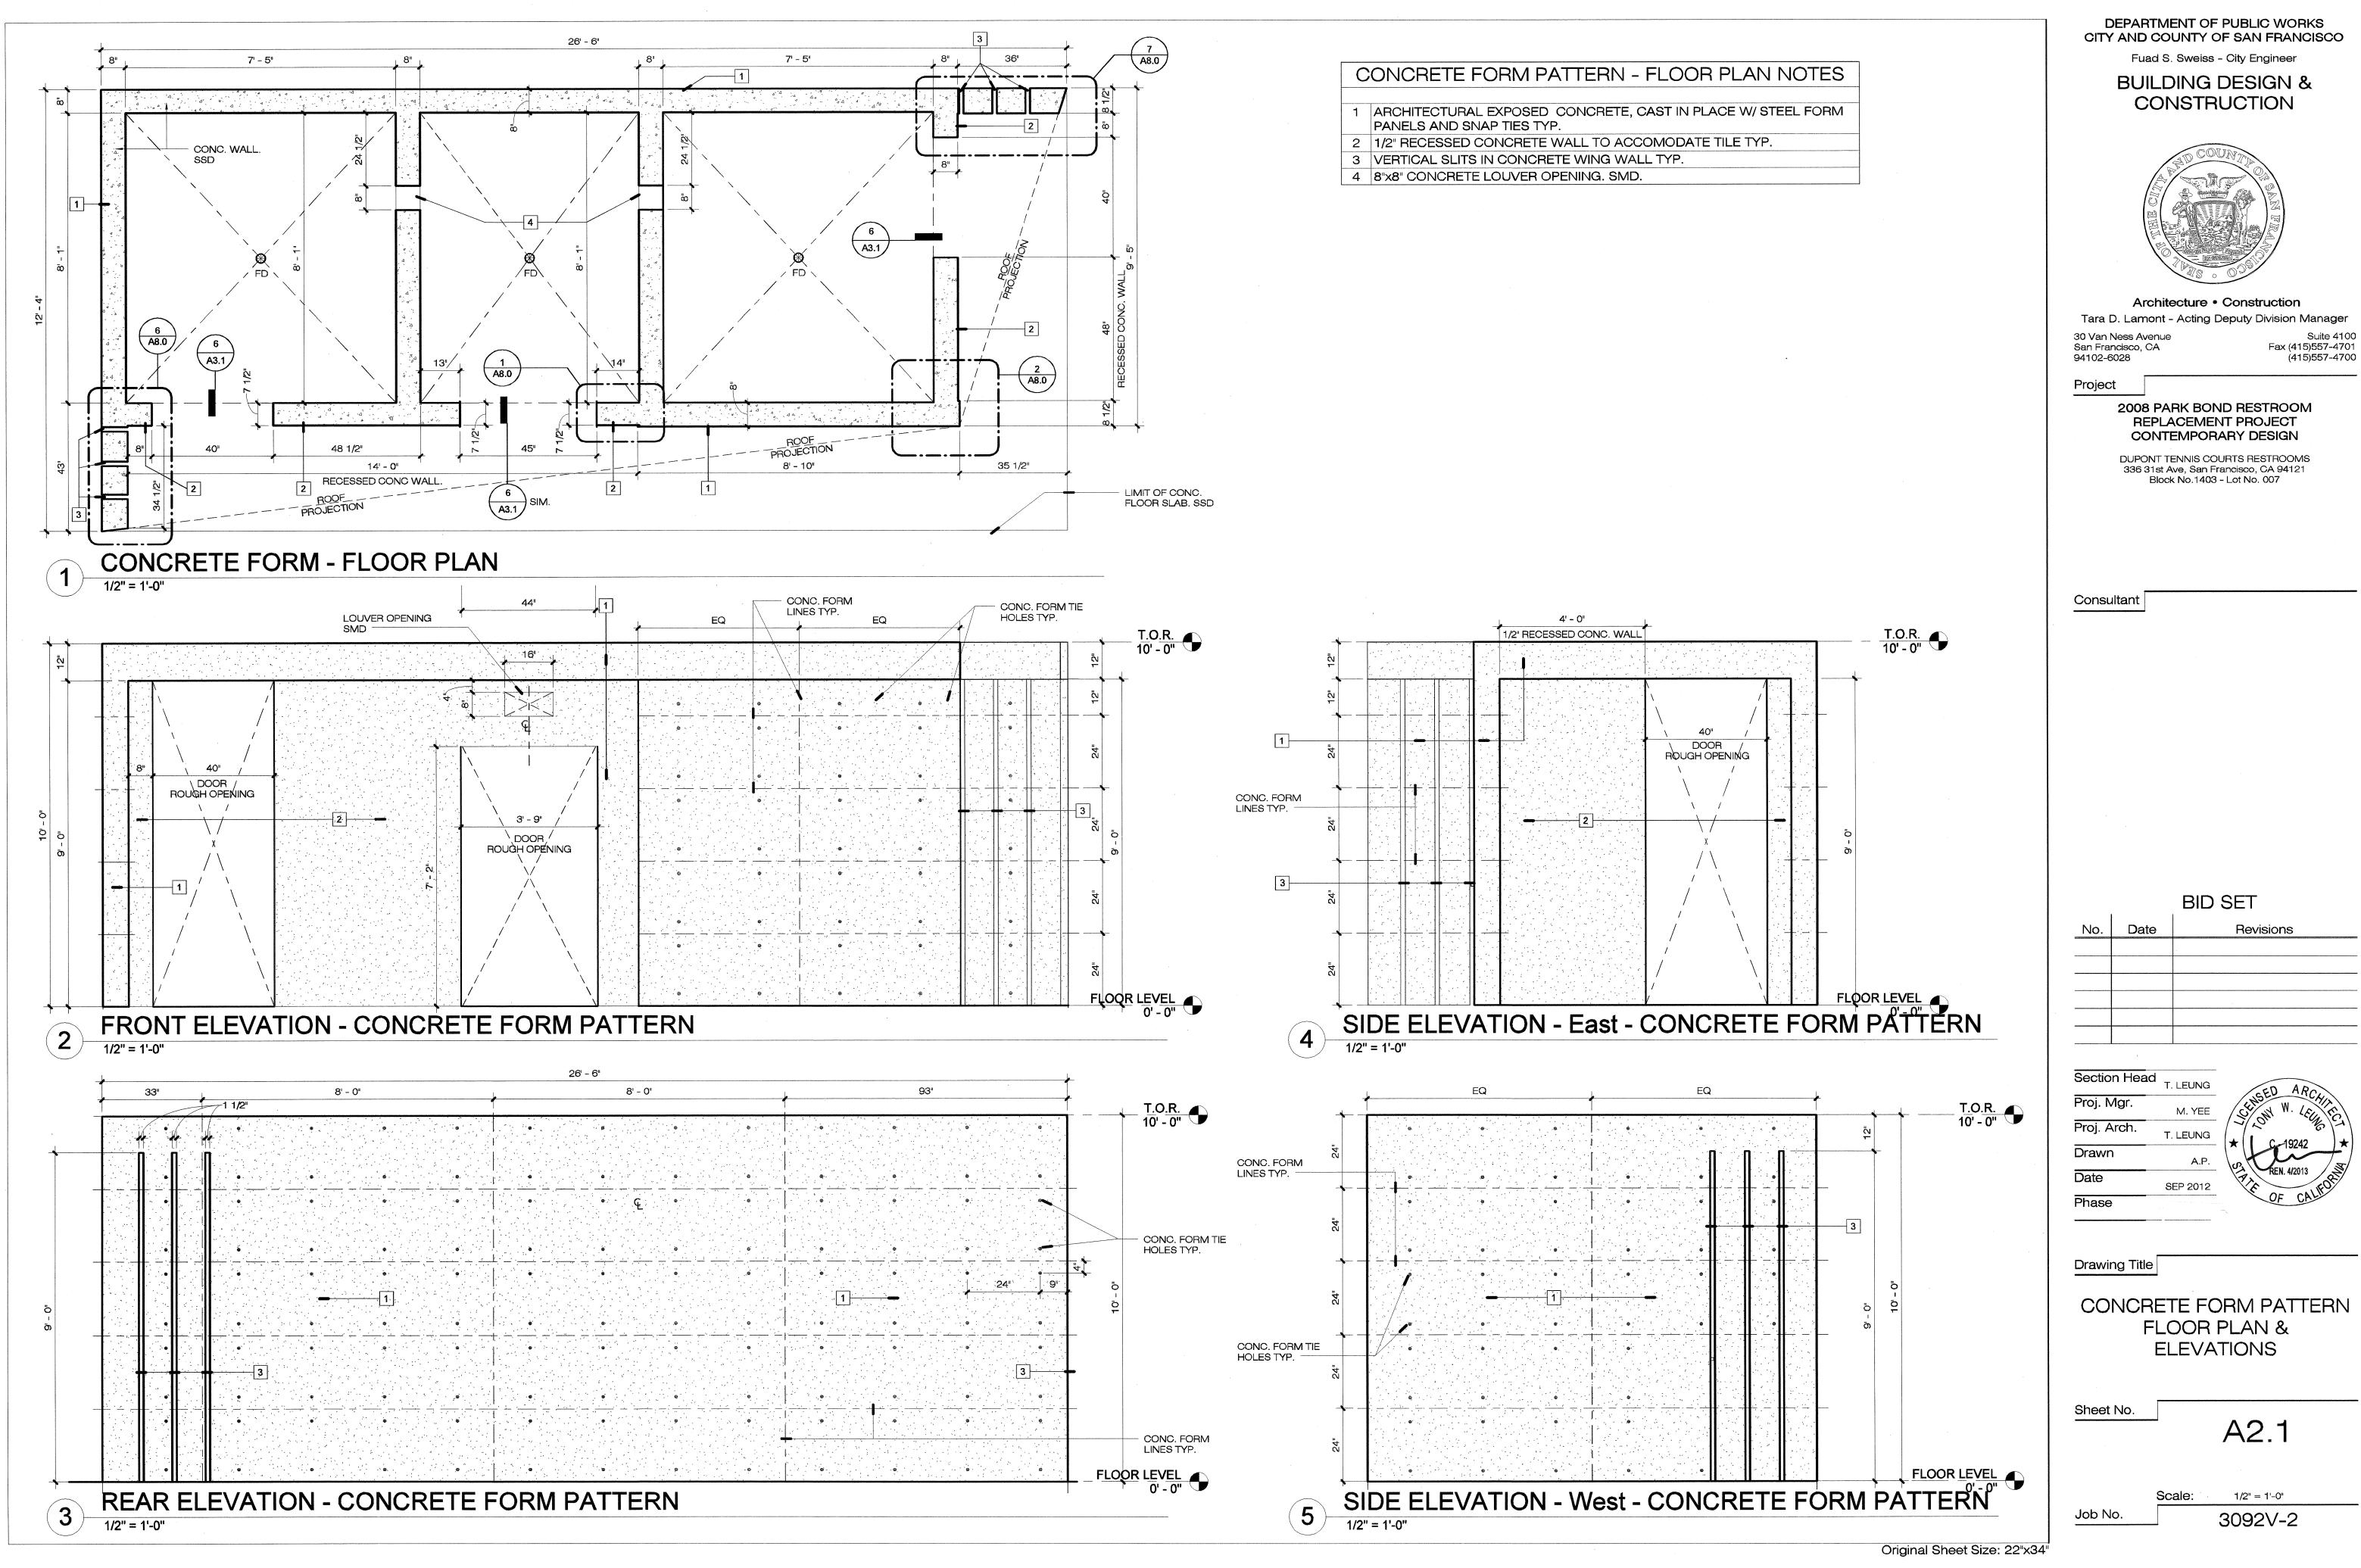As indicated Job No. 3092V-2



DEPARTMENT OF PUBLIC WORKS CITY AND COUNTY OF SAN FRANCISCO

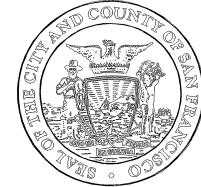BUILDING DESIGN &




2008 PARK BOND RESTROOM REPLACEMENT PROJECT

Revisions

FLOOR PLAN &

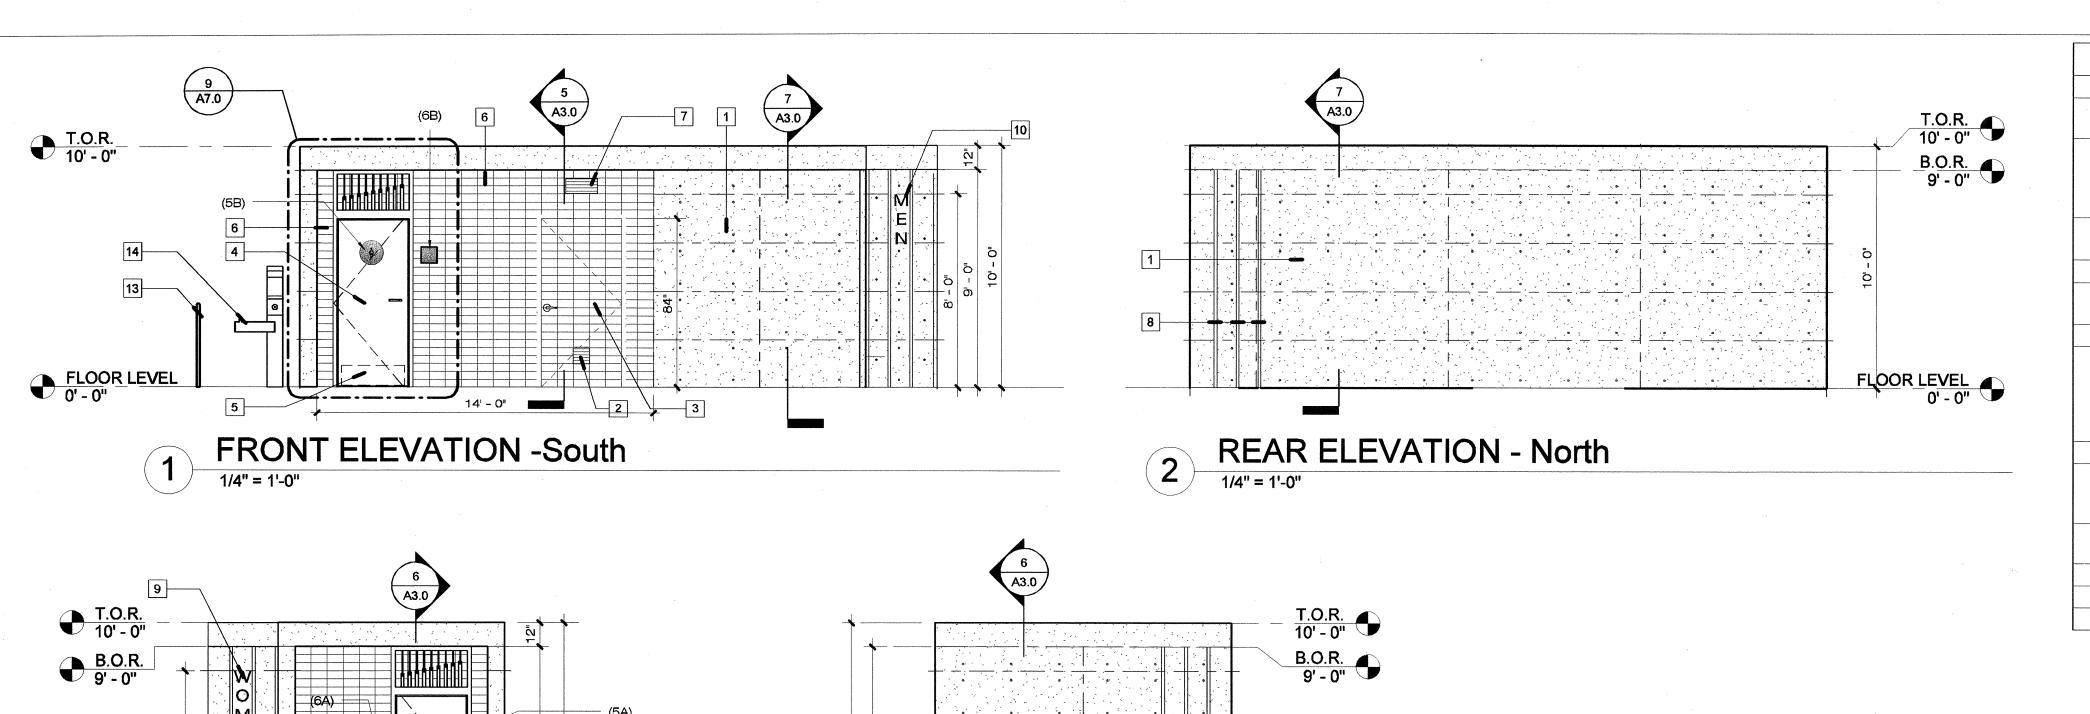1/2" = 1'-0" 3092V-2



SIDE ELEVATION - West

FLOOR LEVEL

1/4" = 1'-0"

SIDE ELEVATION - East

ELEVATIONS NOTES

- 1 CONC. WALL CAST IN PLACE FINISH TYP. SEE A2.1 FOR CONCRETE FORM & PATTERN DETAILS
- 2 8x8 MTL. LOUVER SEAL ALL AROUND, PAINT TO MATCH TILE COLOR, TYP. CONTRACTOR TO CONFIRM THAT THE DOOR OPENING FOR LOUVER MATCH THE DIMENSION OF 4x8 TILE. SEE 4/A7.0 FOR DIMENSIONS (TYP. FOR ALL LOUVERS)
- 3 CUSTOM EXTERIOR MTL. DOOR, TILE CLADED TO MATCH ADJACENT WALL. SEE SHEET A7.0 FOR DETAILS
- 4 MTL. DOOR
- 5 STAINLESS STL. KICKPLATE TYP. (ON INTERIOR PUSH SIDE ONLY)

THAT CONCRETE OPPENING FOR LOUVER MATCH THE

- 6 4x8 TILE TYP. PT-2 (CONTRAST): 5570/ CAMEL 16x8 MTL. LOUVER, S.M.D. SEAL ALL AROUND, PAINT TO MATCH 4x8 TILE COLOR, TYP. CONTRACTOR TO CONFIRM
- ALL LOUVERS) 8 CONC. WALL 1 1/2" SLITS, SEE SHEET A8.0 FOR DETAILS. WOMEN'S ID SIGN. CAST IN CONC. TEXT TYPE SHALLBE 6" HIGHT, HELVETICA UPPER LETTER CASE FONT, RECESSED 1

DIMENSION OF 4x8 TILE. SEE A2.1 FOR DIMENSIONS (TYP. FOR

- 1/2" TYP. 10 MEN'S ID SIGN. CAST. IN CONC. TEXT TYPE SHALLBE 6" HIGHT HELVETICA UPPER LETTER CASE FONT, RECESSED 1 1/2" TYP.
- 12 PADLOCK BOX. SEE 3/A7.0 13 DRINKING FOUNTAIN MTL GUARDRAIL
- 14 DRINKING FOUNTAIN/ WATER BOTTLE FILLER COMBO. SLD.

BUILDING DESIGN & CONSTRUCTION



DEPARTMENT OF PUBLIC WORKS

CITY AND COUNTY OF SAN FRANCISCO

Fuad S. Sweiss - City Engineer

Architecture • Construction Tara D. Lamont - Acting Deputy Division Manager Suite 4100 Fax (415)557-4701 (415)557-4700 30 Van Ness Avenue

San Francisco, CA 94102-6028

Project

2008 PARK BOND RESTROOM REPLACEMENT PROJECT **CONTEMPORARY DESIGN**

DUPONT TENNIS COURTS RESTROOMS 340 31st Ave, San Francisco, CA 94121 Block No.1403 - Lot No. 007

Consultant

BID SET Date Revisions No.

Section Head Proj. Mgr. Proj. Arch.

T. LEUNG T. LEUNG SEP 2012

Drawing Title

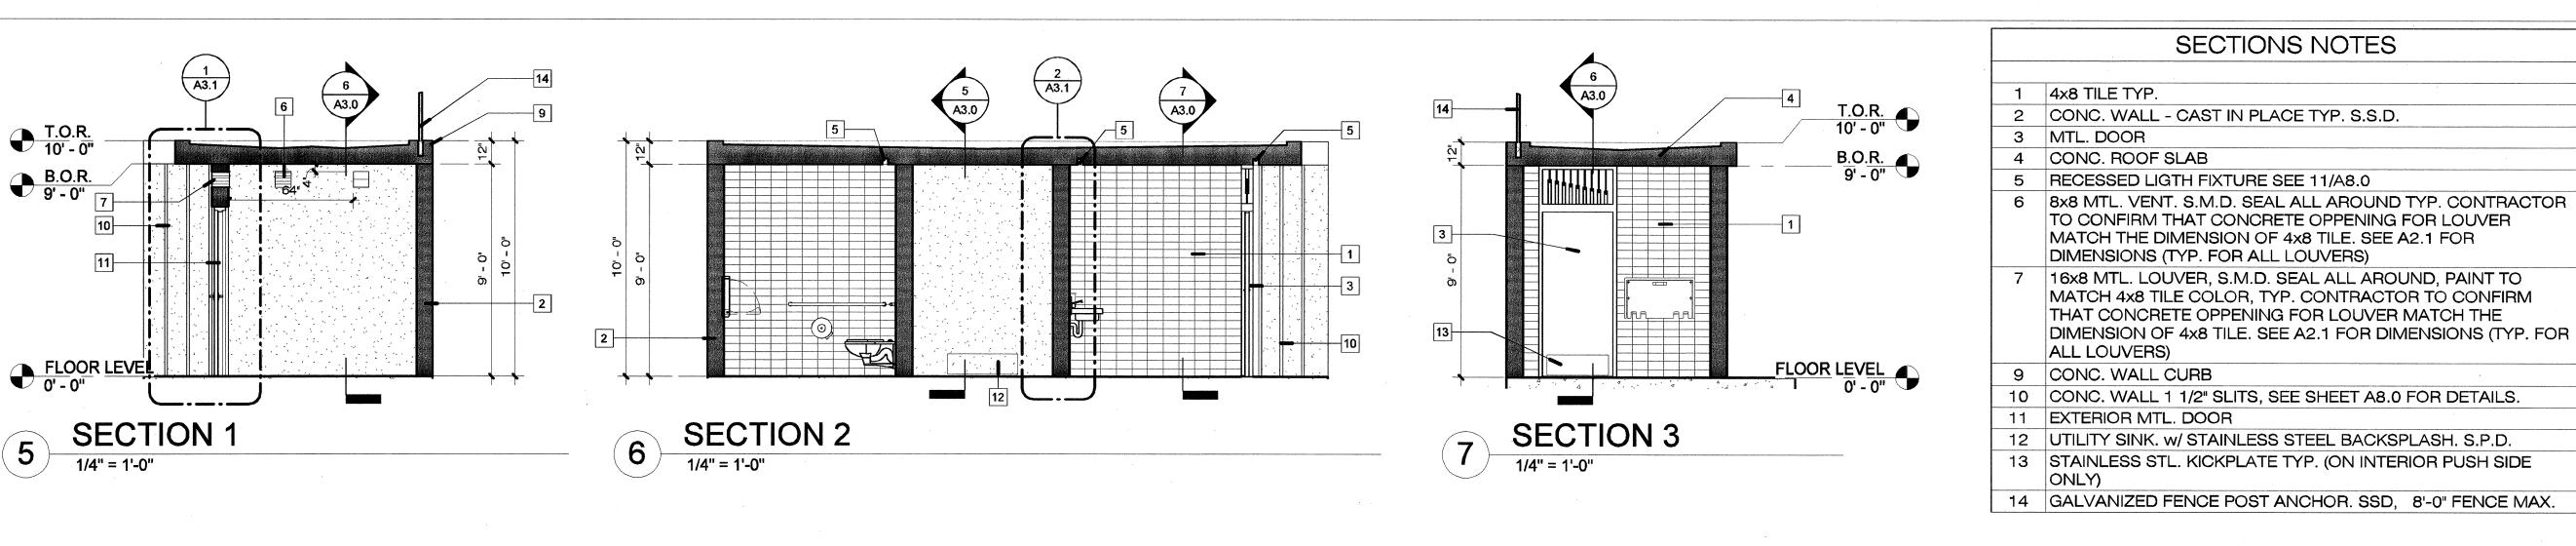
Phase

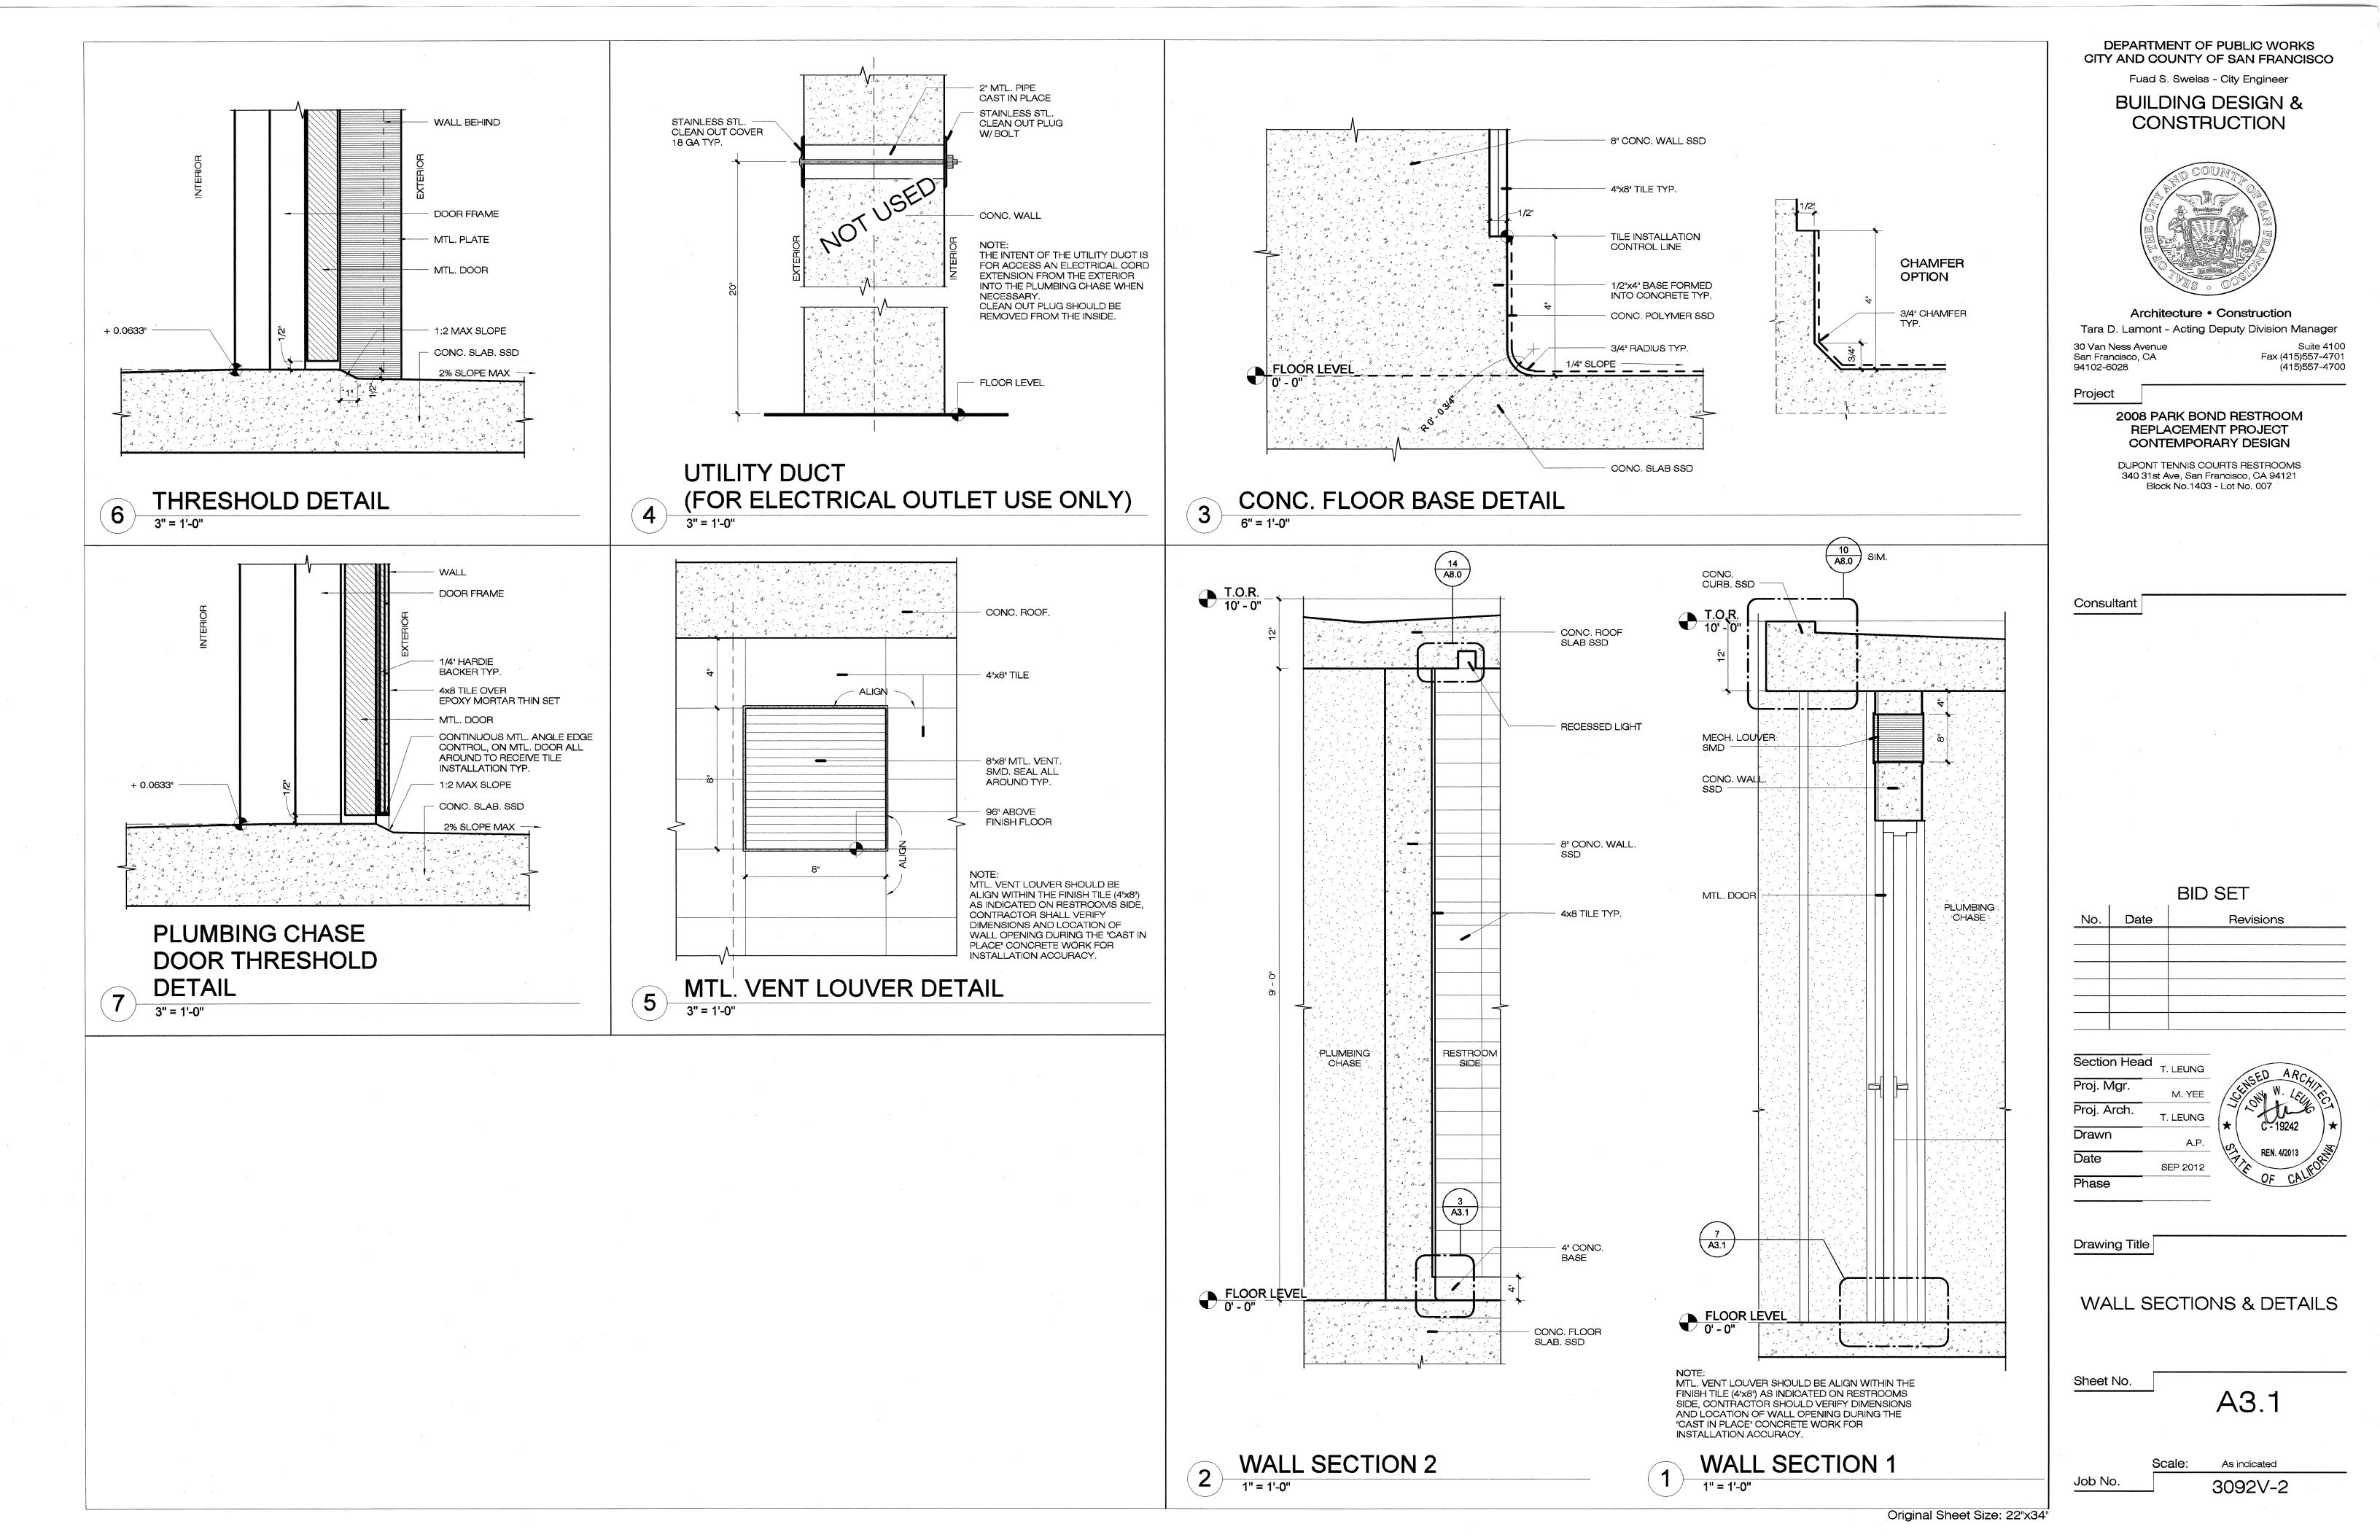
ELEVATIONS & SECTIONS

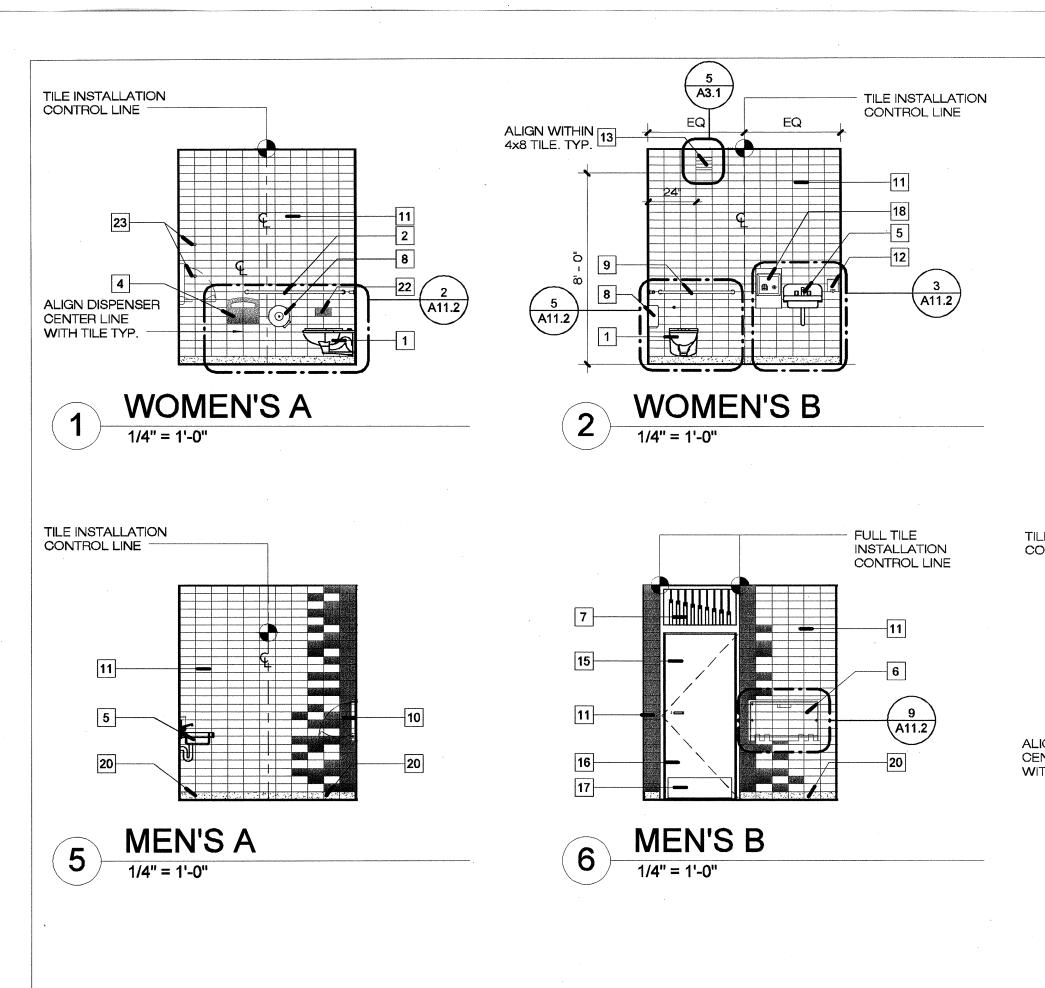
Sheet No.

A3.0

1/4" = 1'-0" Job No. 3092V-2








PLUMBING CHASE 1

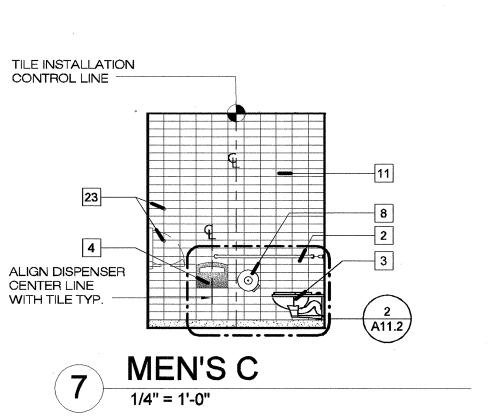3/8" = 1'-0"




PLUMBING CHASE 3

WOMEN'S C


FULL TILE INSTALLATION

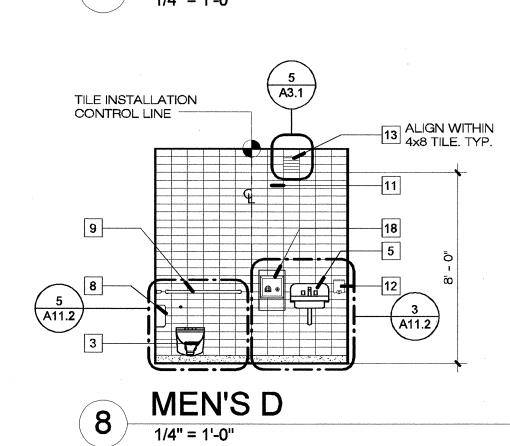CONTROL LINE



TILE INSTALLATION

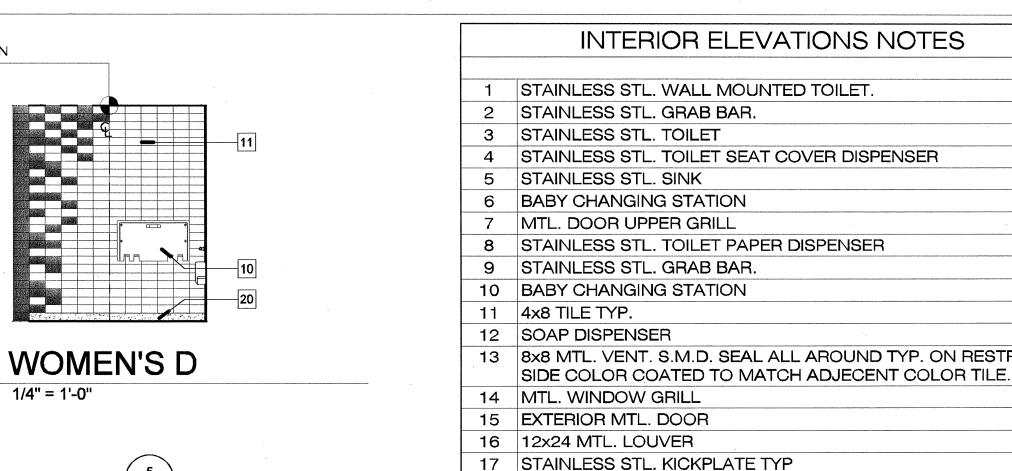CONTROL LINE



18 ELECT. HANDRYER (O.F.C.I.)

23 COAT HOOK, ADA @ NON ADA.

20 CONC. FLOOR BASE TYP.

19 UTILITY SINK. w/ STAINLESS STEEL BACKSPLASH. S.PD

22 STAINLESS STL. SANITARY NAPKIN DISPENSER

21 24x8 MTL. LOUVER, S.M.D. SEAL ALL AROUND, PAINT TO MATCH

CONCRETE OPPENING FOR LOUVER MATCH THE DIMENSION OF

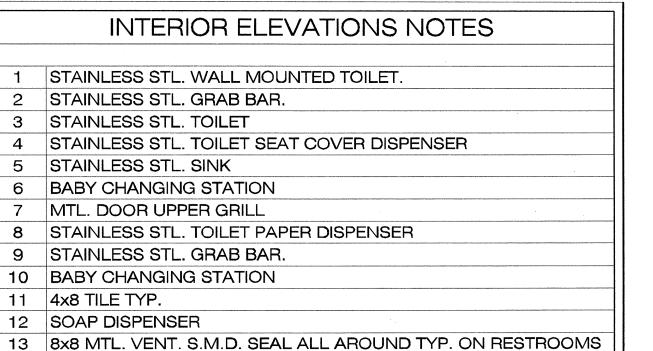
TILE LEGEND: TILE COLOR SELECTION IS DETERMINED BY SITE, FOLLOW

5500/BRANCO

PT-2 (CONTRAST): 5514/ AZUL ATLAS

4x8 TILE. SEE A2.1 FOR DIMENSIONS (TYP. FOR ALL LOUVERS)

4x8 TILE COLOR, TYP. CONTRACTOR TO CONFIRM THAT



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2008 PARK BOND RESTROOM REPLACEMENT PROJECT **CONTEMPORARY DESIGN**

340 31st Ave, San Francisco, CA 94121 Block No.1403 - Lot No. 007

Consultant

BID SET No. Revisions

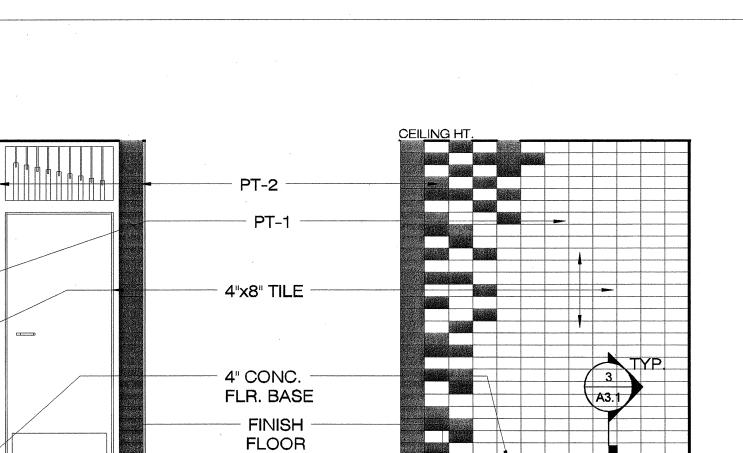
Section Head Proj. Mgr. Proj. Arch. T. LEUNG

Drawing Title

Sheet No.


A4.0

As indicated 3092V-2



WOMEN'S - INTERIOR TILE PATHERN

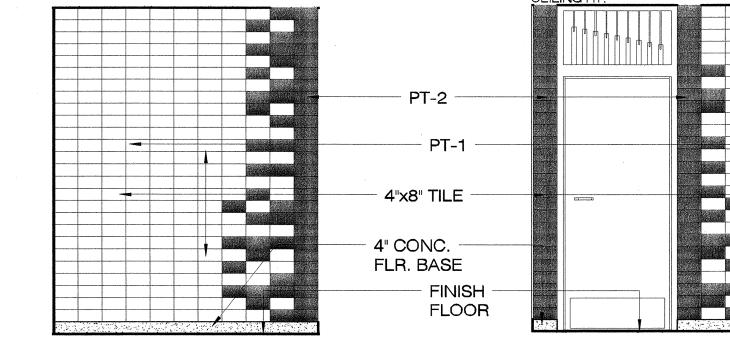PLUMBING CHASE 2



MEN'S - INTERIOR TILE PATHERN

SCHEDULE BELOW

(PT= PORCELAIN TILE)

PT-1 (BASE):

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DEPARTMENT OF PUBLIC WORKS

CITY AND COUNTY OF SAN FRANCISCO

Fuad S. Sweiss - City Engineer

BUILDING DESIGN &

CONSTRUCTION

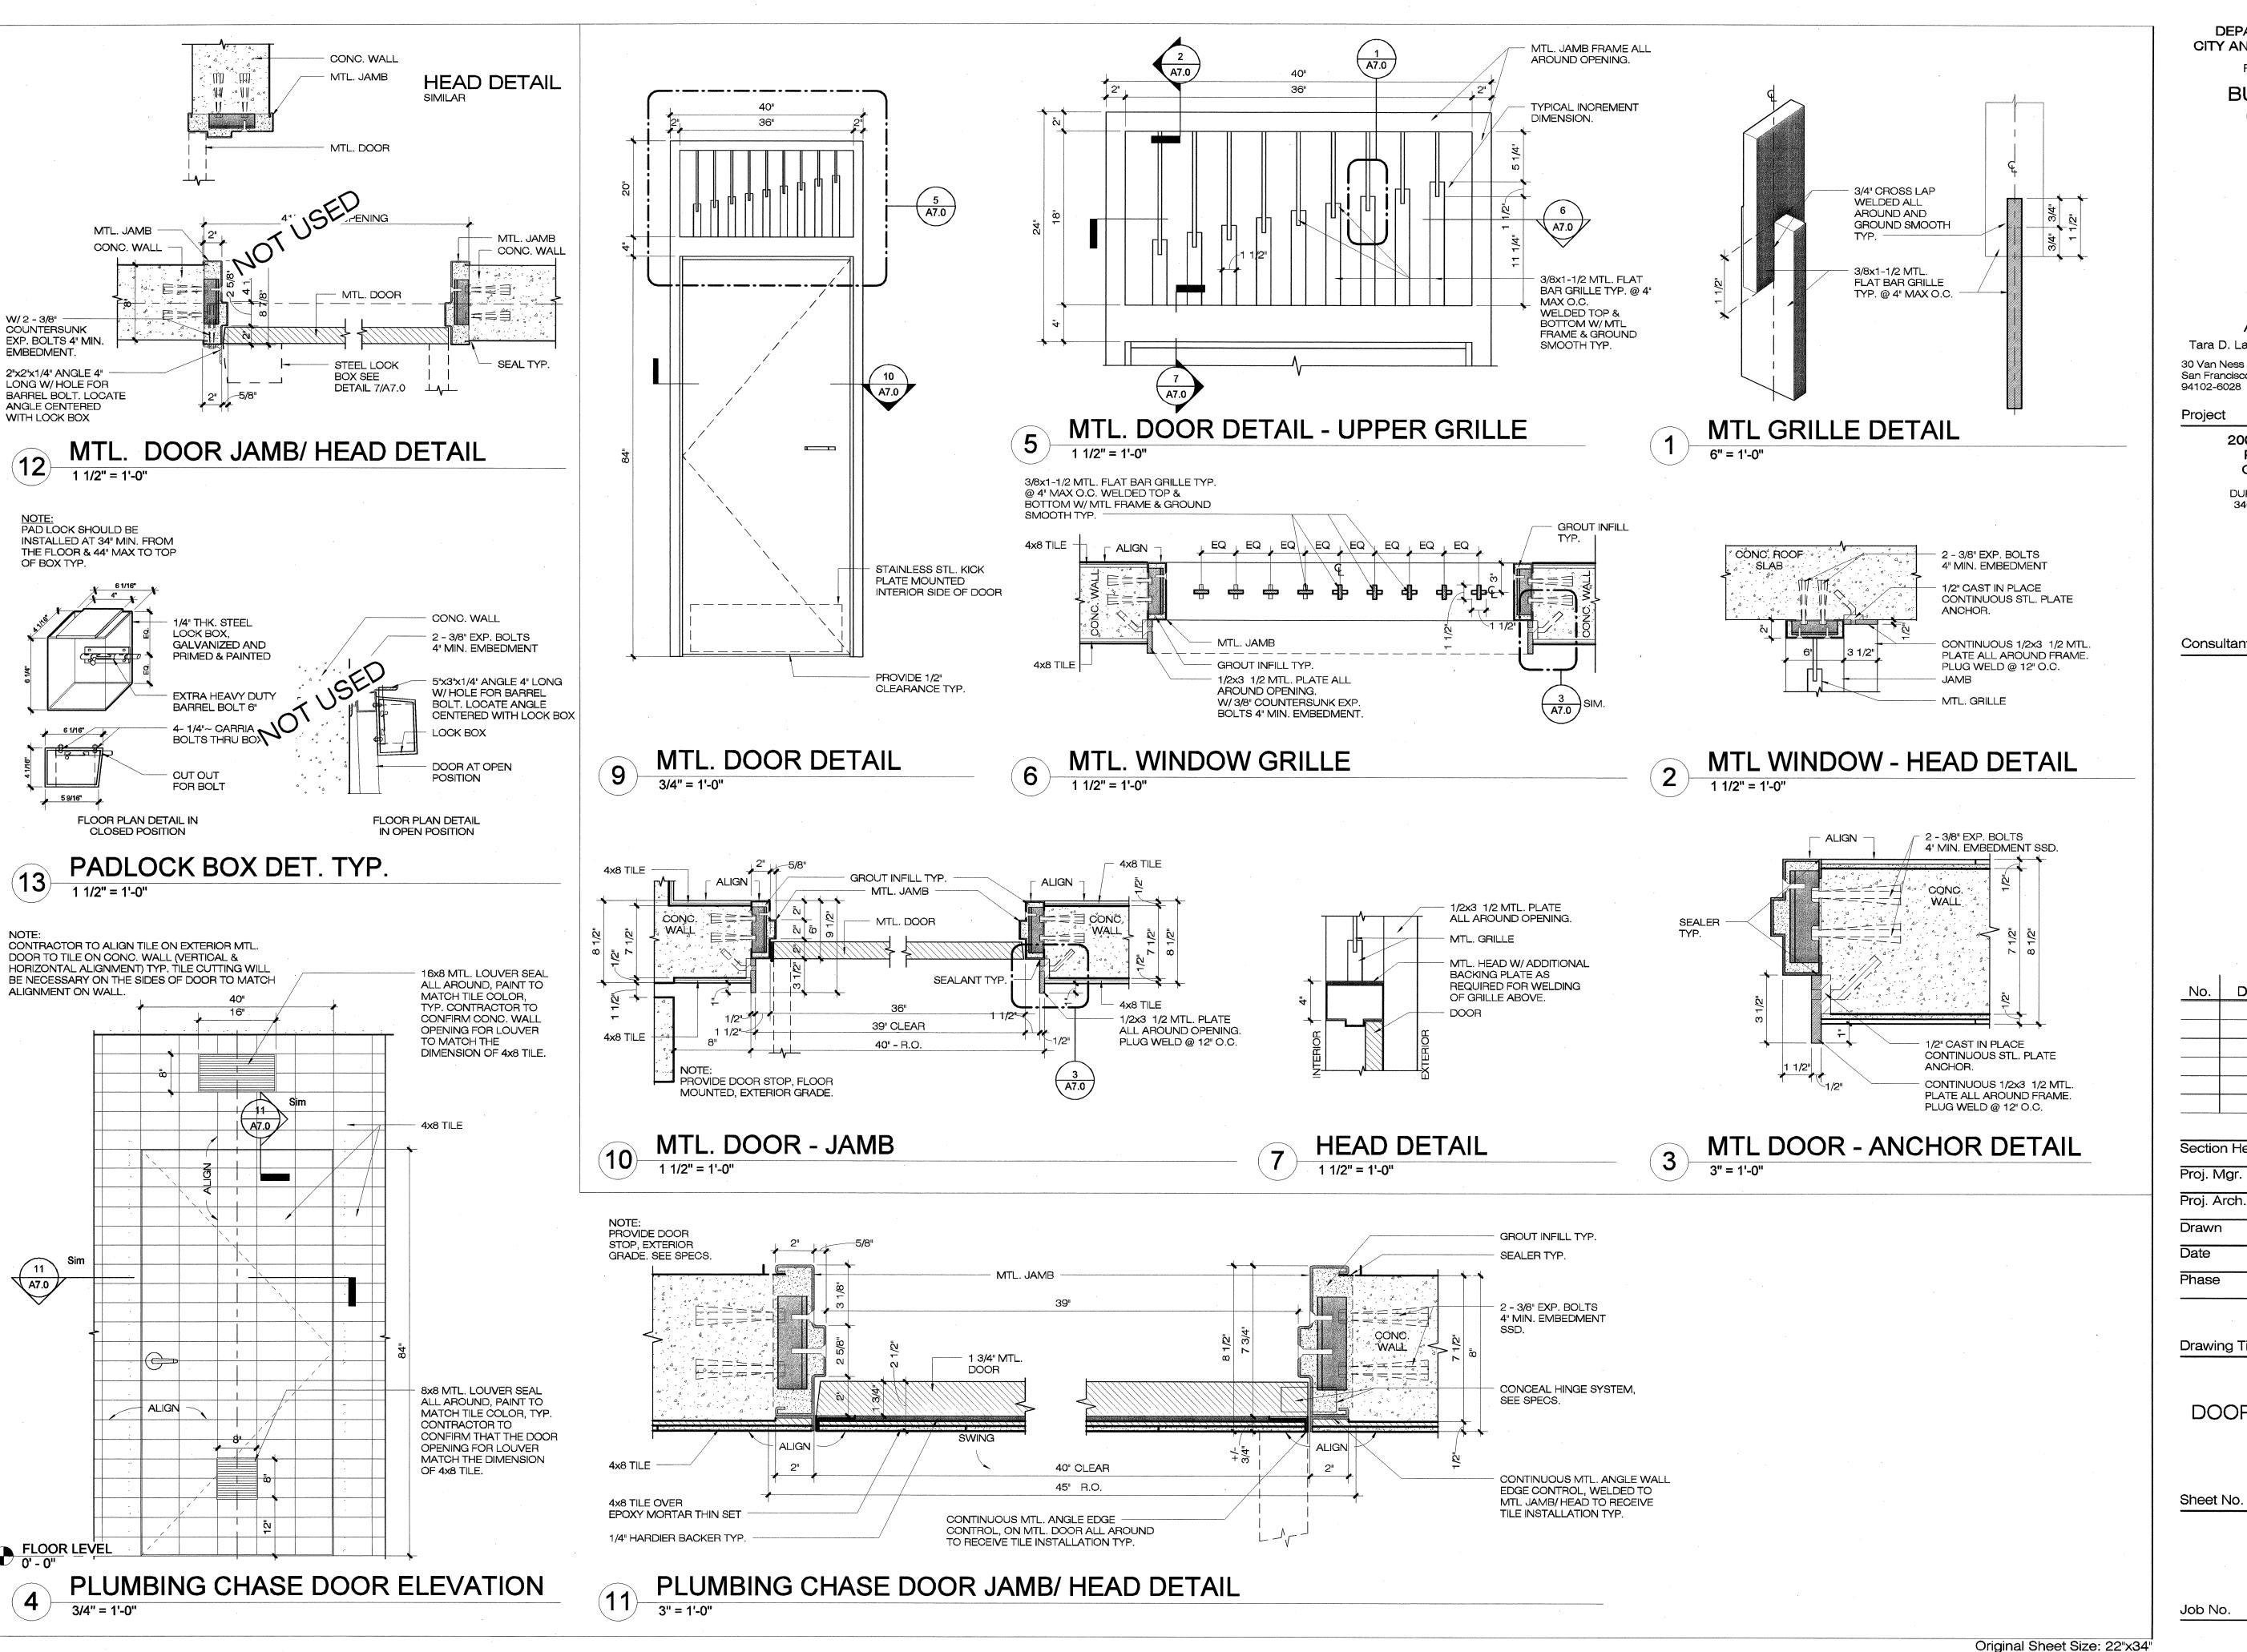
Project

DUPONT TENNIS COURTS RESTROOMS

Drawn

INTERIOR ELEVATIONS

Job No.



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BUILDING DESIGN & CONSTRUCTION



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Project

2008 PARK BOND RESTROOM REPLACEMENT PROJECT CONTEMPORARY DESIGN

(415)557-4700

DUPONT TENNIS COURTS RESTROOMS 340 31st Ave, San Francisco, CA 94121 Block No.1403 - Lot No. 007

Consultant

BID SET Date Revisions No.

Section Head T. LEUNG Proj. Mgr. Proj. Arch. Drawn

T. LEUNG SEP 2012 Phase

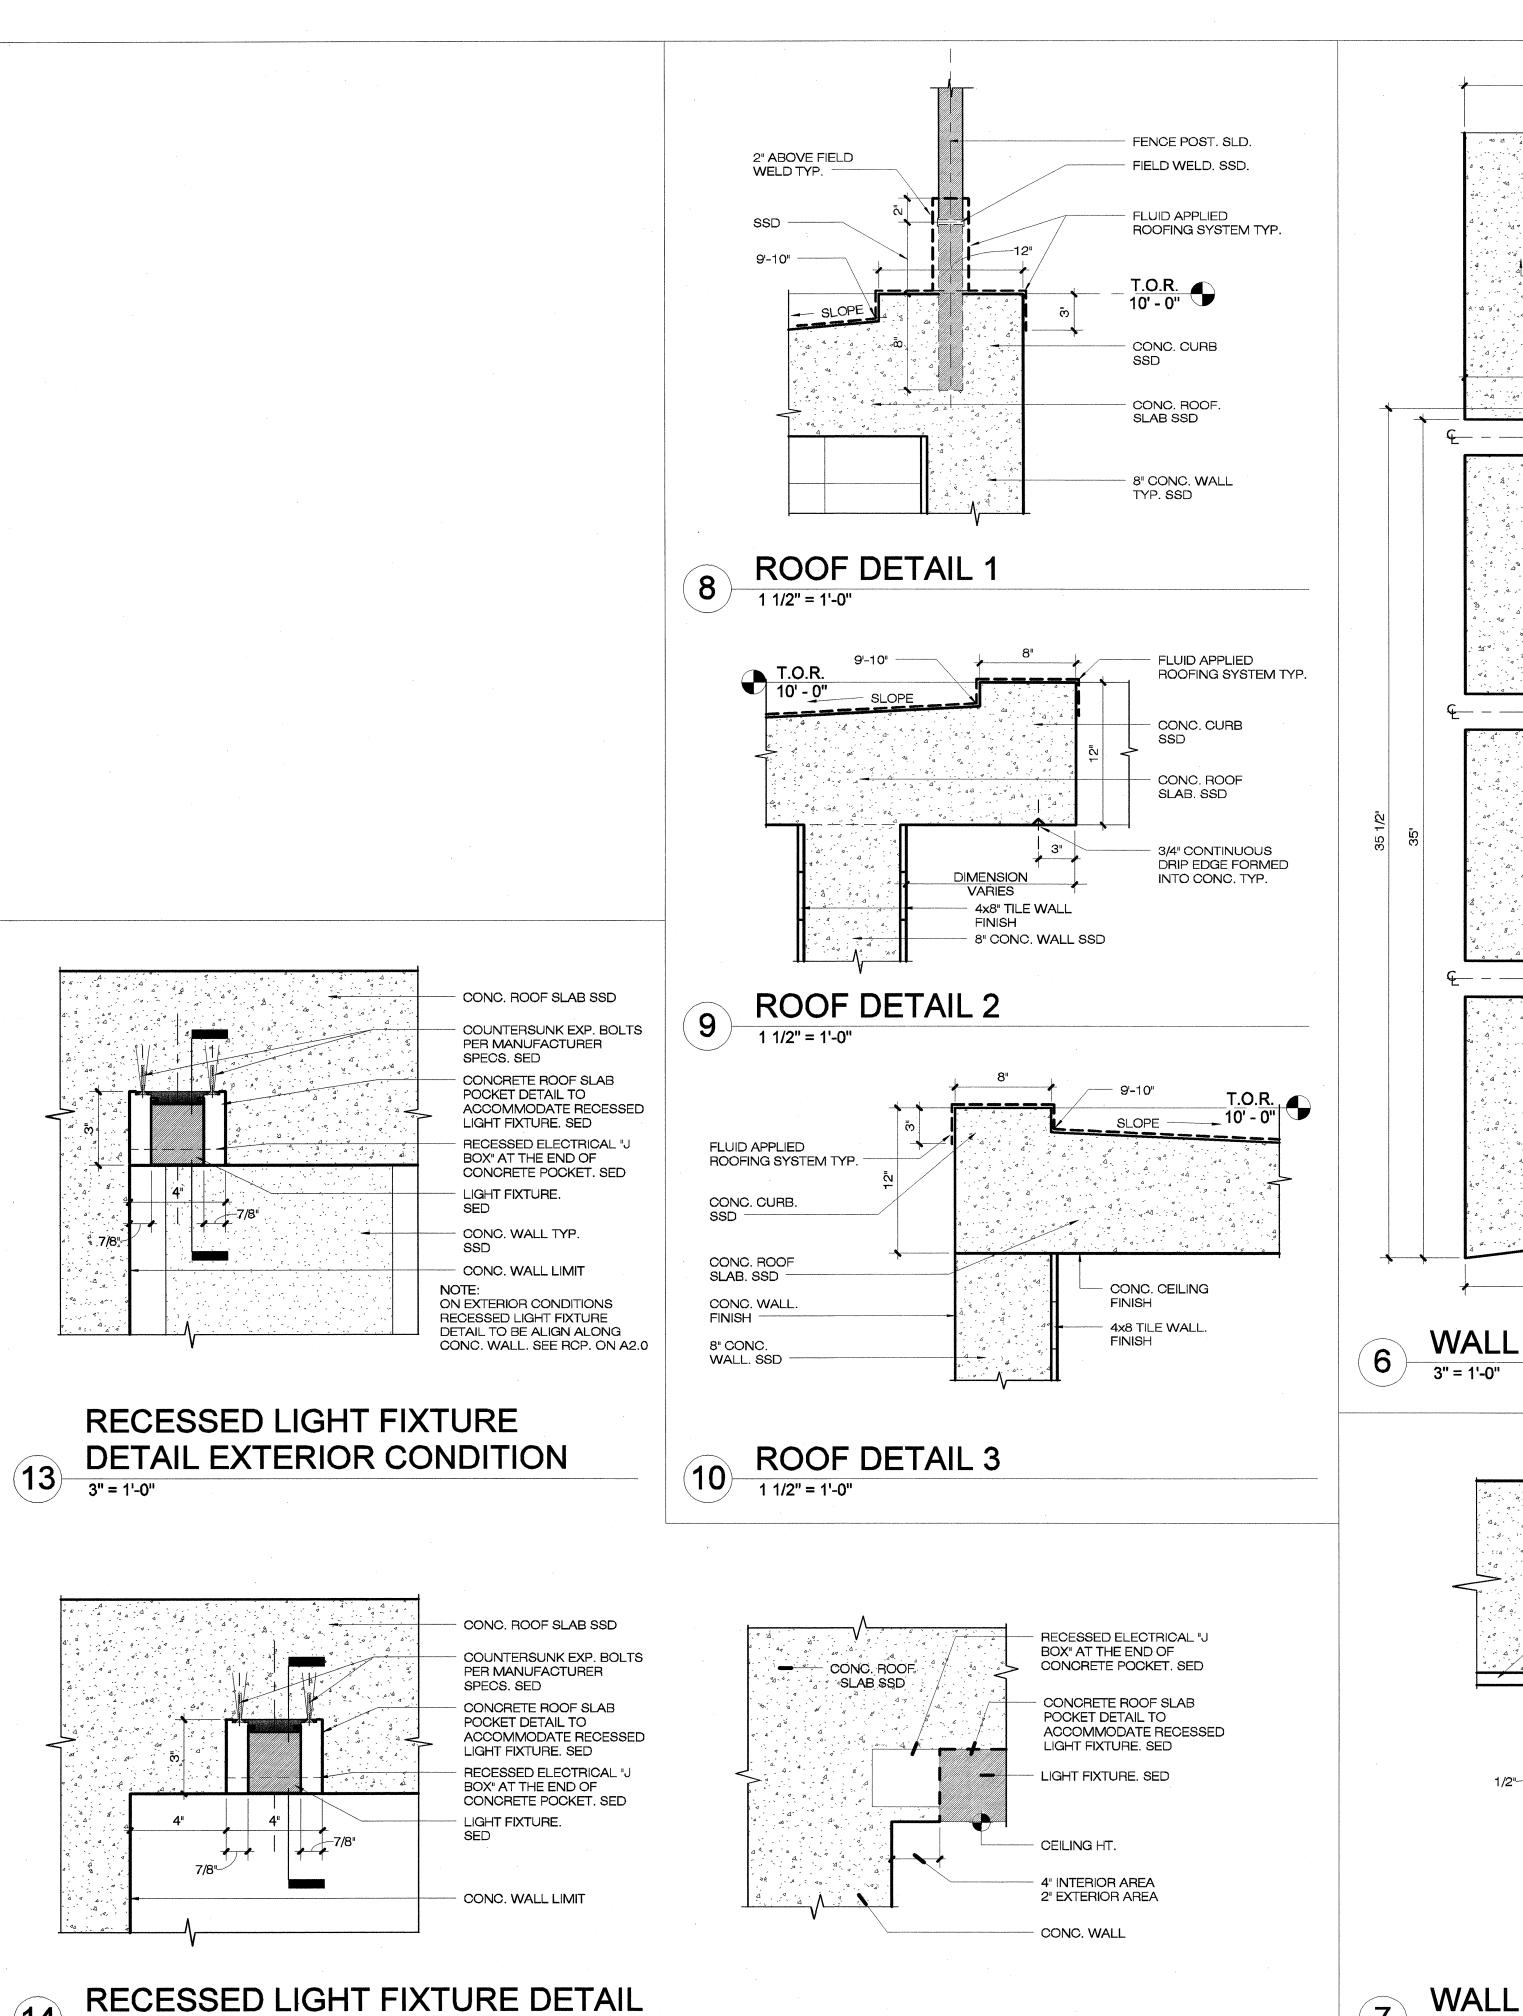
Drawing Title

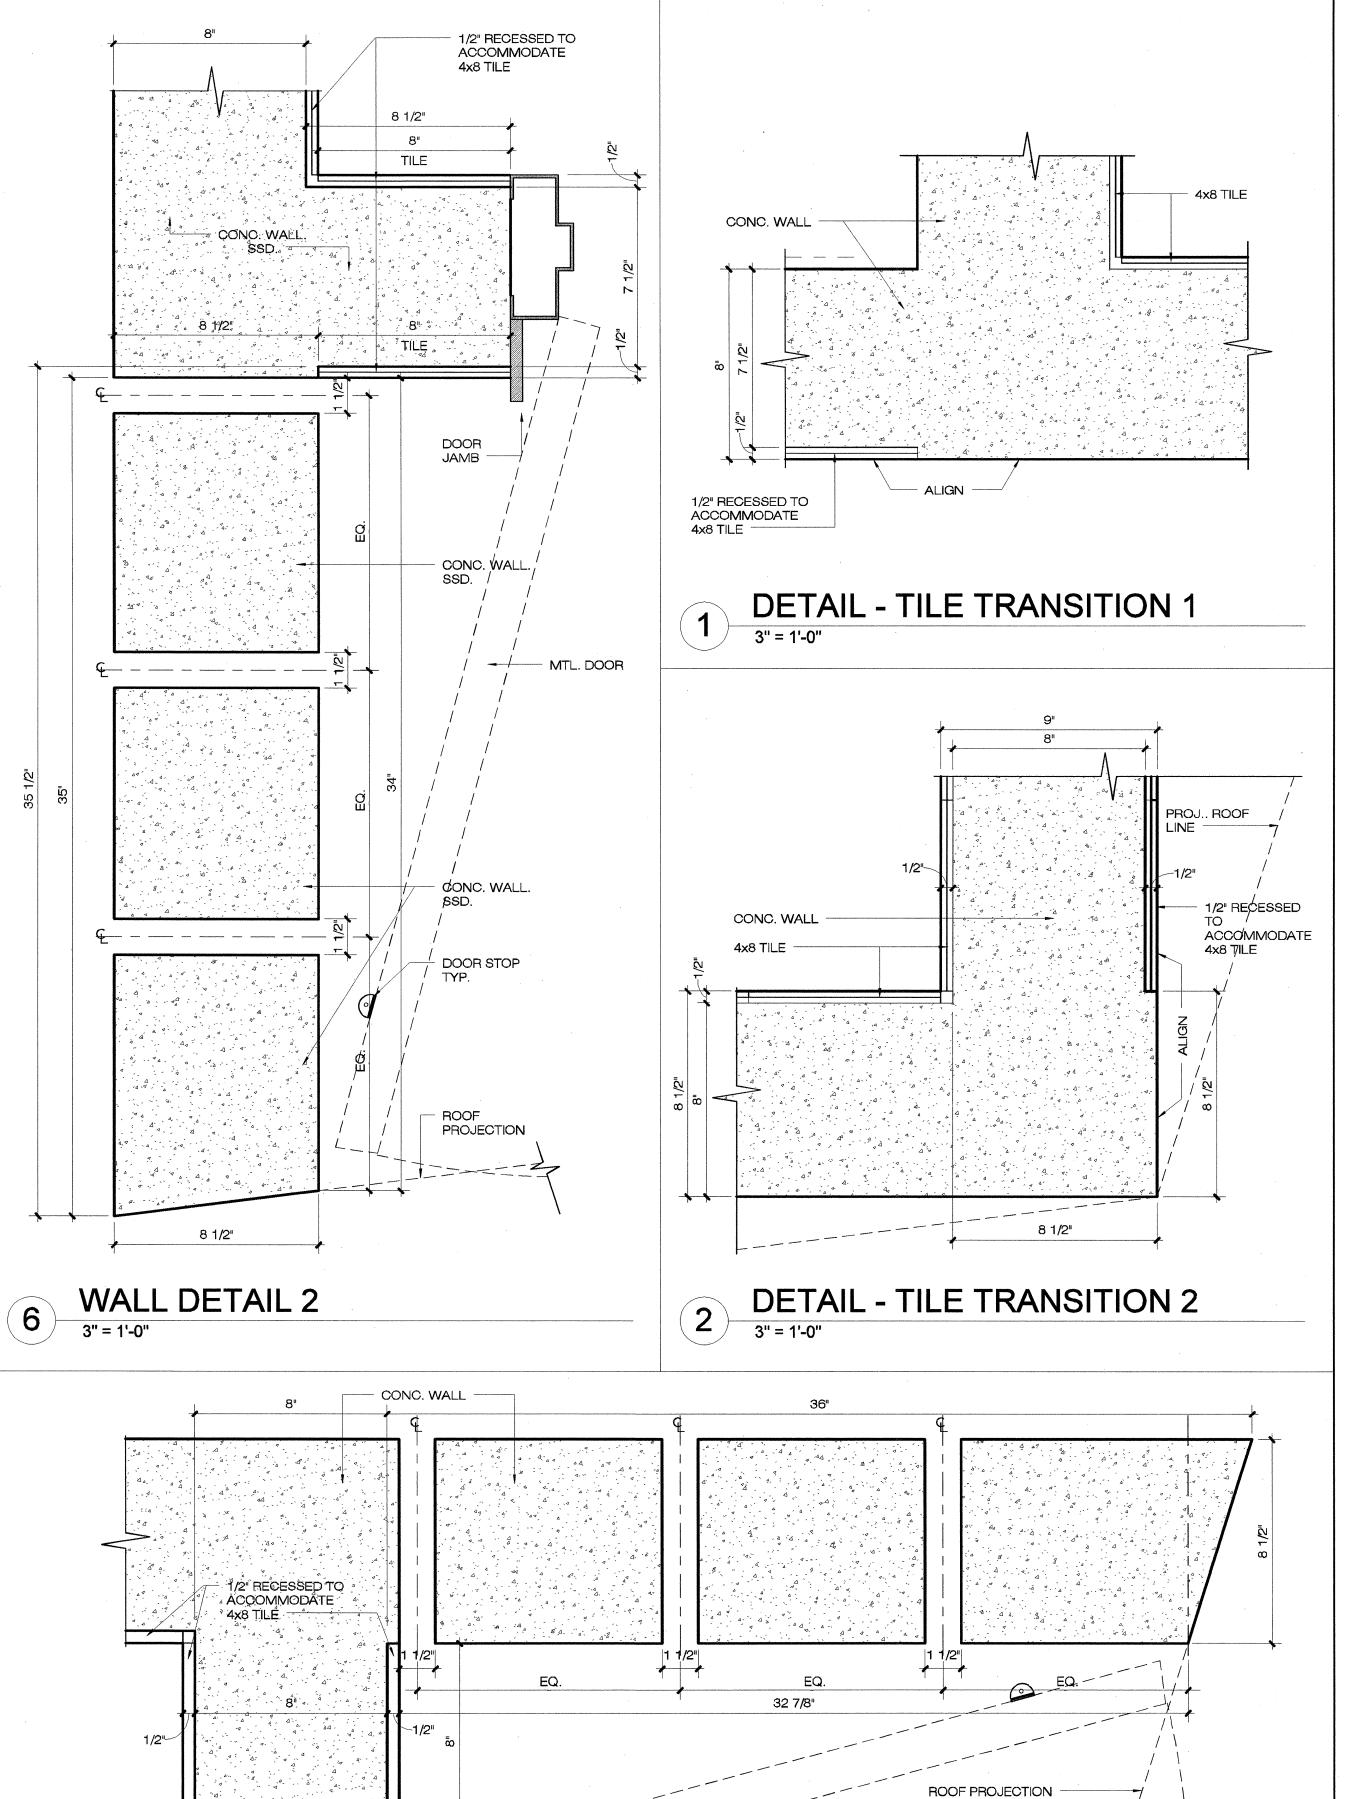
DOOR & WINDOW DETAILS

Sheet No.

A7.0

As indicated Job No. 3092V-2





DEPARTMENT OF PUBLIC WORKS CITY AND COUNTY OF SAN FRANCISCO

Fuad S. Sweiss - City Engineer

BUILDING DESIGN & CONSTRUCTION



Architecture • Construction Tara D. Lamont - Acting Deputy Division Manager Suite 4100 30 Van Ness Avenue

94102-6028 Project

San Francisco, CA

2008 PARK BOND RESTROOM REPLACEMENT PROJECT **CONTEMPORARY DESIGN**

Fax (415)557-4701

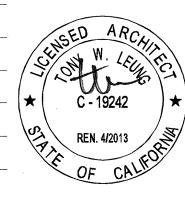
(415)557-4700

DUPONT TENNIS COURTS RESTROOMS 340 31st Ave, San Francisco, CA 94121 Block No.1403 - Lot No. 007

Consultant

BID SET Date Revisions No.

Section Head Proj. Arch. T. LEUNG Drawn SEP 2012 Phase



Drawing Title

EXTERIOR DETAILS

Sheet No. A8.0

As indicated Job No. 3092V-2

Original Sheet Size: 22"x34"

- DOOR STOP TYP.

WALL DETAIL 1

MTL. DOOR

ACCESSIBILITY COMPLIANCE LETTER

DBI ACCESSIBILITY CHECKLIST

DEPARTMENT OF PUBLIC WORKS

Office of the Disability Access Coordinator 30 Van Ness Avenue, 5th floor San Francisco, CA 94102-6020 (415) 557-4685

City	Pro	oje	cts
\$1400 CA \$15 NESS	Arbert Care La	Cardia Cardon Card	of an incident on the in-

CITY PROJECTS (All City owned or sponsored projects must complete the items listed below.)

The owner of this project is the City and County of San Francisco and is responsibly charged by

DEPARTMENT OF RECREATION AND PARKS_ (Department / Agency)

MARVIN YEE

Project Manager

Kevin Jensen, Disability Access Coordinator

DISABILITY ACCESS QUALITY ASSURANCE REVIEW

PROJECT: DUPPONT TENNIS COURTS RESTROOMS REPLACEMENT **PROJECT**

CLIENT DEPARTMENT: DEPARTMENT OF RECREATION AND PARKS

-NOVEMBER 2011 (0/11/2012 (CUL)

THIS MEMO IS TO CONFIRM THAT I HAVE REVIEWED THE CONSTRUCTION DOCUMENTS AND THE APPLICABLE FEDERAL AND STATE REQUIREMENTS FOR ACCESSIBILITY FOR THE ABOVE NOTED PROJECT.

Sincerely.

Disability Access Coordinator Department of Public Works

415,554,6799 TTY

MOD@sfgov.org

dachecklist2007(v2.2)

D.A. CHECKLIST (p. 1 of 2):

The address of the project is: DUPPONT TENNIS COURTS RESTROOMS

For ALL tenant improvement projects in commercial use spaces, this checklist is required to be reproduced on the plan set and

- 1. The proposed use of the project is PUBLIC RESTROOMS (e.g. Retail, Office, Restaurant, etc.)
- 2. Describe the area of remodel, including which floor: One New Story Building
- 3. The construction cost of this project excluding disabled access upgrades is \$ 200,000.00 (check one) [X]more than / D less than the Accessibility Threshold amount of \$ 132,536.28 based on the "2010 ENR Construction Cost Index" (The cost index & threshold are updated annually).
- 4. Is this a City project and/or does it receive public funding? Check one: ☑ Yes / ☐ No Note: If Yes, then see Step 3 on the Instructions page for additional forms required.

Conditions below must be fully documented by accompanying drawings

5. Read A through G below carefully and check the most applicable box (one box only):

- A: All existing conditions serving the area of remodel fully comply with access requirements. No further upgrades are required. **B:** All existing conditions serving the area of remodel that do <u>not</u> fully comply with access requirements <u>will be</u> fully upgraded
- □ C: Proposed project (check one) □ is less than the threshold / ⊠ is over the threshold & falls under CBC 1134B.2.1 Ex. 2; Partial upgrades, including Equivalent Facilitation will be provided up to 20% of the project value as itemized on Form C. Priority of upgrades are to be considered in the order listed on p. 2 of the D.A. Checklist. Fill out Hardship request form(s) for non-fully complying items, including for Equivalent Facilitation items. Checking box C means there are still noncomplying items serving the area of remodel.
- D: Access features will either fully comply or be provided with Code defined Equivalent Facilitation. Submit an Unreasonable Hardship Request (UHR) for the Equivalent Facilitation items.
- ☐ E: Hardship appeal to be filed with Access Appeals Commission (AAC). Note: Plan check of items not under AAC consideration will continue while resolution of AAC decision is sought.
- ☐ F: Consisting only of Barrier Removal, Notice of Accessibility Violation (NOV) Compliance or Exempted Work; Fill out Form
- ☐ G: Minor revision to previously approved permit drawings only. (Note: This shall <u>NOT</u> be used for new or additional work) Description of revision: Provide previous approved permit application here:

dachecklist2007(v2.2)

D.A. CHECKLIST (p. 2 of 2):

	upgrades below are listed priority based on CBC 1134B.2.1 Ex1	Existing Fully Complying	Upgrade to Full Compliance	Upgrade /	Equivalent Facilitation/ Hardship	Hardship	None existing & not req'd by Code	Access Appeals Commis- sion	Barrier Removal/ NOV	Location of detail(s)-include detail no. & drawing sheet (<u>do not leave</u> <u>this part blank!</u>). Also clarification comments can be written here.
servii Note: prima	accessible entrance ng the area of remodel. : This should be a ary entrance. Add'l ade may be required if it		Ø			О				L1.1
TOTAL TRANSPORT	ccessible route to the a of remodel	enter a de la companya de la company			การมักเมื่อง และก่าง เคยเกลม และสามารถ การค้าปก็	an ilina adalah dari dari dari dari dari dari dari dari	haini ani ani ani ani ani ani ani ani ani	aminginosama adang merengan ini manang	·	
2a. pat	h of travel	П		Д	П	П	. Ц	П	E	L1.1
2b. ram				П		О		П		L1.1
2c. elev	vator					0	×	П		
2d. stai	irs (if no elevator)	П		D	E	<u>a</u>	Ø	O	E	
2f. othe).	D		O		П	Ø	G	G	
restro	ast one accessible com for each sex ng the area of remodel.									A2.0
4. Acce phon	essible public pay e.	G		I		П	X	L	L	
	essible drinking ains (hi-low).	I		E			B		I	L-5.3
6. Signa	age.		Ø				Ē			A11.1
7. Visua	al Alarm.	L	l u			П	⊠	D	П	
8.	Parking					П	☒	D	E	
Others:	path from parking area						Ø		П	
and the second s	Shower					D	Ø	П		in variable etaikkeete teeteete oore oo
	ON STREET PASSANGER LOADING ZONE & CURB RAMP					E				L-1.1/1.0

Check all applicable boxes and specify where on the drawings the details are shown:

If details are provided from a set of City approved reference drawings, provide its permit application number here:

dachecklist2007(v2.2)

DEPARTMENT OF PUBLIC WORKS CITY AND COUNTY OF SAN FRANCISCO Fuad S. Sweiss - City Engineer

> **BUILDING DESIGN &** CONSTRUCTION



Architecture • Construction Tara D. Lamont - Acting Deputy Division Manager

30 Van Ness Avenue

Suite 4100 Fax (415)557-4701 San Francisco, CA (415)557-4700

94102-6028

Project

2008 PARK BOND RESTROOM REPLACEMENT PROJECT **CONTEMPORARY DESIGN**

DUPONT TENNIS COURTS RESTROOMS 336 31st Ave, San Francisco, CA 94121 Block No.1403 - Lot No. 007

Consultant

BID SET

No.	Date	Revisions

Section Head

Proj. Arch.

Drawing Title


ACCESSIBILITY INFORMATION

Sheet No.

A11.0

12" = 1'-0" Job No. 3092V-2

Original	Sheet	Size:	22

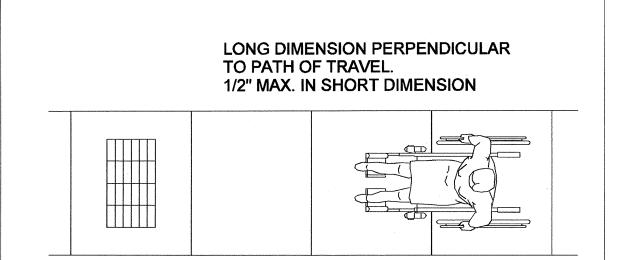


GRATES SHOULD NOT BE LOCATED IN THE PATH OF TRAVEL WHENEVER POSSIBLE.

ACCESSIBLE GRATING

@ PATH OF TRAVEL

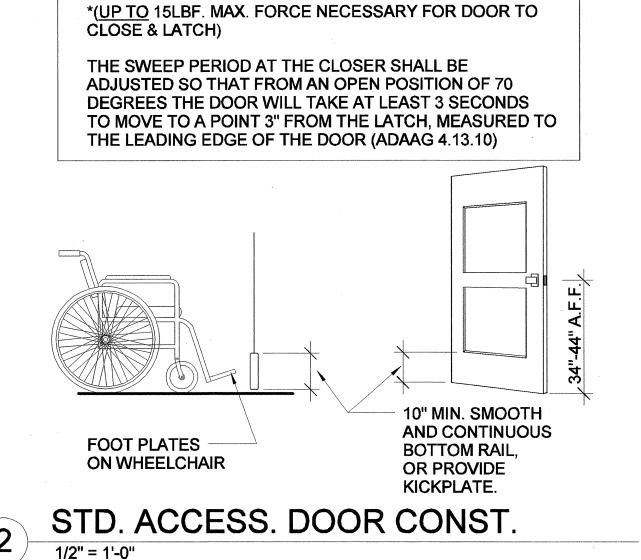1/2" = 1'-0"



8" TYP.

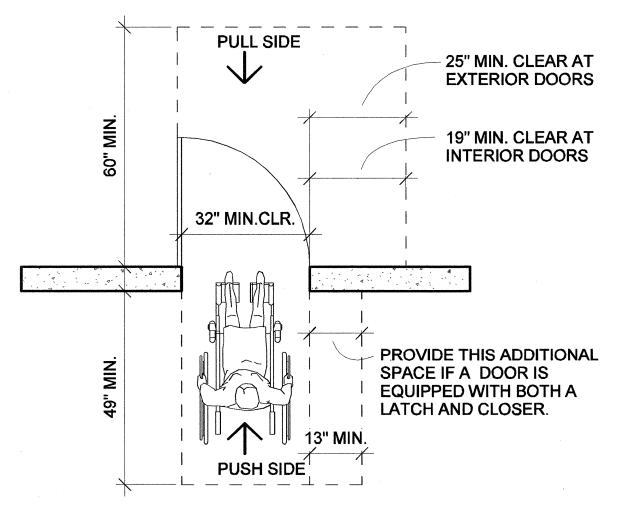
5.0 LBS.

5.0 LBS.

15.0 LBS.

..INTERIOR

..EXTERIOR



ACCESSIBLE DOOR APPROACH

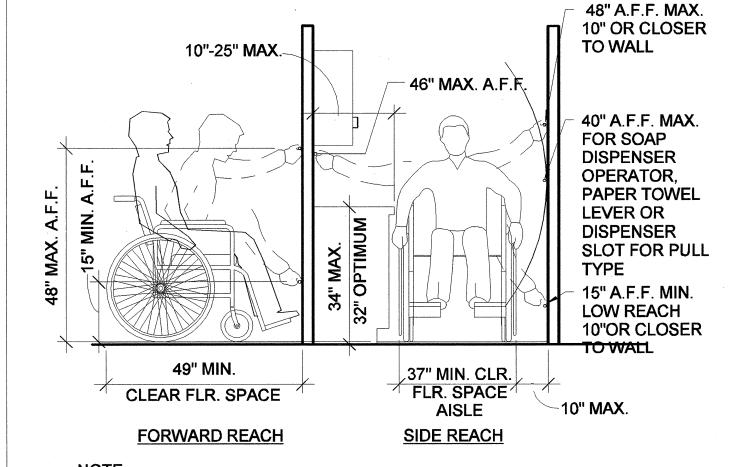
FAMILY RESTROOM

OR UNISEX

TYPE C

DOOR JAMB STRIKE SIDE

WOMEN



USE THE INFORMATION DEPICTED ABOVE WHEN INSTALLING LOCKERS, DIAPER CHANGING STATION AND OTHER ELEMENTS REQUIRED TO BE ACCESSIBLE, BUT NOT COVERED IN OTHER DETAILS.

ACCESSIBLE REACH RANGES

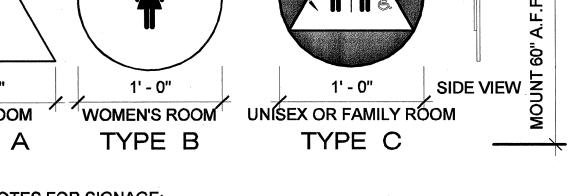
3/4" = 1'-0"

_1/4" THK. WHITE BACKGROUND 1/4" THK. @ UNISEX BLACK BACKGROUND 1' - 0" SIDE VIEW Z UNÍSEX OR FAMILY ROOM **MEN'S ROOM** WOMEN'S ROOM TYPE C TYPE A TYPE B

GENERAL NOTES FOR SIGNAGE:

SIGN MATERIAL SHALL BE 1/4" THICK, ALUMINUM. SEE SPECS.

- SIGNS SHALL HAVE WHITE LETTERS AND FIGURES ON CONTRASTING BACKGROUND, FINISHES TO BE MATTE, NON-GLARE.
- 3. ALL INTERIOR SURFACE MOUNTED SIGNS SHALL BE ADHERED W/NON-STAINING BACKGROUND, FINISHES TO BE MATTE, EGGSHELL, NON-GLARE.
- 4. DOOR MOUNTED SIGN AND SYMBOLS SHALL BE 70% CONTRASTING COLOR FOR EACH ITEM. SIGN SHALL BE 70% CONTRASTING COLOR WITH ADJACENT SURFACE AND WITH SYMBOL.
- 5. SEE SPECIFICATIONS FOR SIGN COLOR AND ADDITIONAL INFORMATION.



GENERAL NOTES FOR SIGNAGE:

TYPE A

BRAILLE, TO MATCH

TEXT ABOVE, TYP.

SIGN MATERIAL SHALL BE 1/4" THICK ALUMINUM AND FINISHES WITH SQUARE EDGES. SEE SPECS.

BACKGROUND, TYP.

1/4" RADIUS, TYP.

- 2. TEXT COPY SHALL BE OPTIMA NOVA CONDENSED UPPERCASE LETTERS, 3/4" HIGH, TYPE RAISED 1/32" MIN, CENTERED TEXT. (SEE DOOR SCHEDULE FOR ROOM LOCATION & NAME) TYP.
- ALL INTERIOR SURFACE MOUNTED SIGNS SHALL BE ADHERED W/NON-STAINING ADHESIVE W/ NO MECHANICAL FASTENERS

3

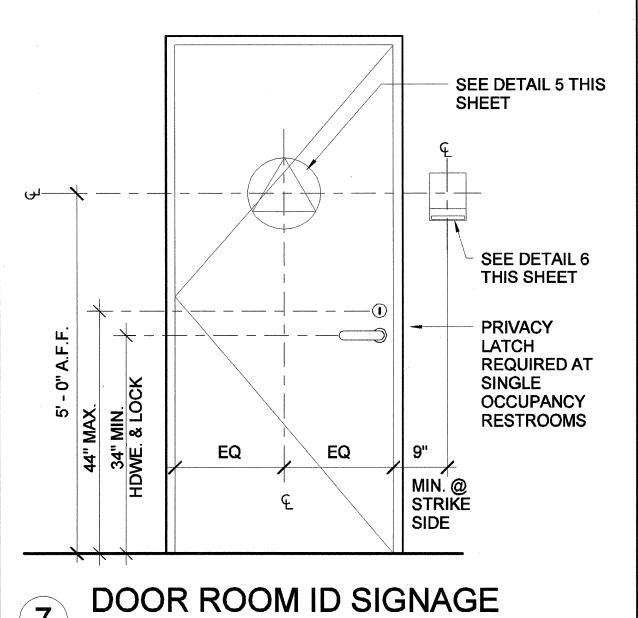
- 4. BRAILLE TRANSLATION OF WRITTEN TEXT TO BE CONTRACTED GRADE 2 BRAILLE RAISED 1/32" IN ACCORDANCE WITH SFBC SECTION 117B.5
- 5. SYMBOL & TEXT COLOR SHALL BE 70% MIN. CONTRASTING W/ SIGN BACKGROUND COLOR AND SIGN SHALL BE 70% CONTRASTING COLOR WITH ADJACENT SURFACE.

3"

TYPE B

- 6. PICTOGRAMS TO BE RAISED 1/32" HIGH, TYP.
- 7. SEE SPECIFICATIONS FOR SIGN COLOR AND ADDITIONAL INFORMATION

ACCESSIBLE STRIKE SIDE SIGNAGE 3" = 1'-0"



DEPARTMENT OF PUBLIC WORKS CITY AND COUNTY OF SAN FRANCISCO Fuad S. Sweiss - City Engineer **BUILDING DESIGN &**

CONSTRUCTION



Architecture • Construction Tara D. Lamont - Acting Deputy Division Manager Suite 4100

30 Van Ness Avenue San Francisco, CA 94102-6028

Fax (415)557-4701 (415)557-4700

Project

2008 PARK BOND RESTROOM REPLACEMENT PROJECT **CONTEMPORARY DESIGN**

DUPONT TENNIS COURTS RESTROOMS 340 31st Ave, San Francisco, CA 94121 Block No.1403 - Lot No. 007

Consultant

BID SET Date No. Revisions

Section Head T. LEUNG Proj. Mgr. Proj. Arch. Drawn A.P/J.G. SEP 2012

Drawing Title

Phase

ACCESSIBILITY DETAILS

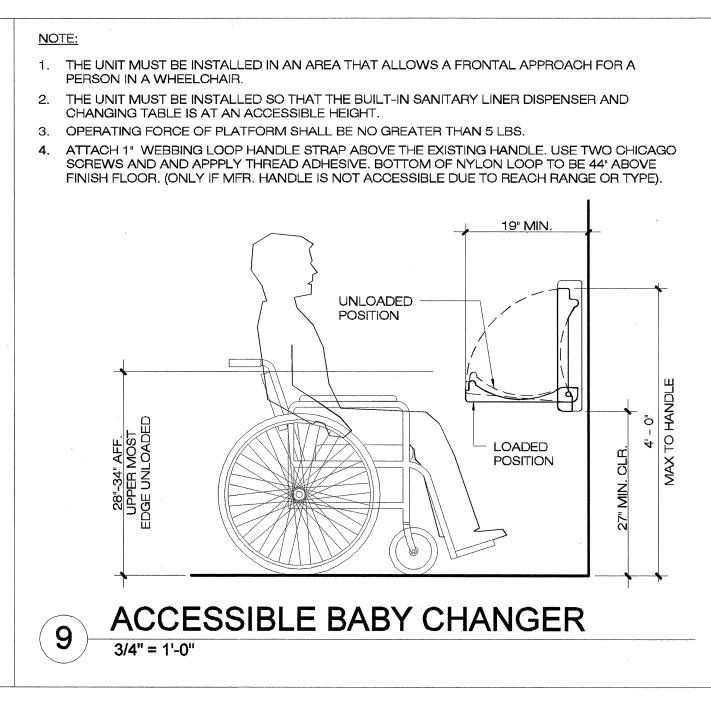
Sheet No.

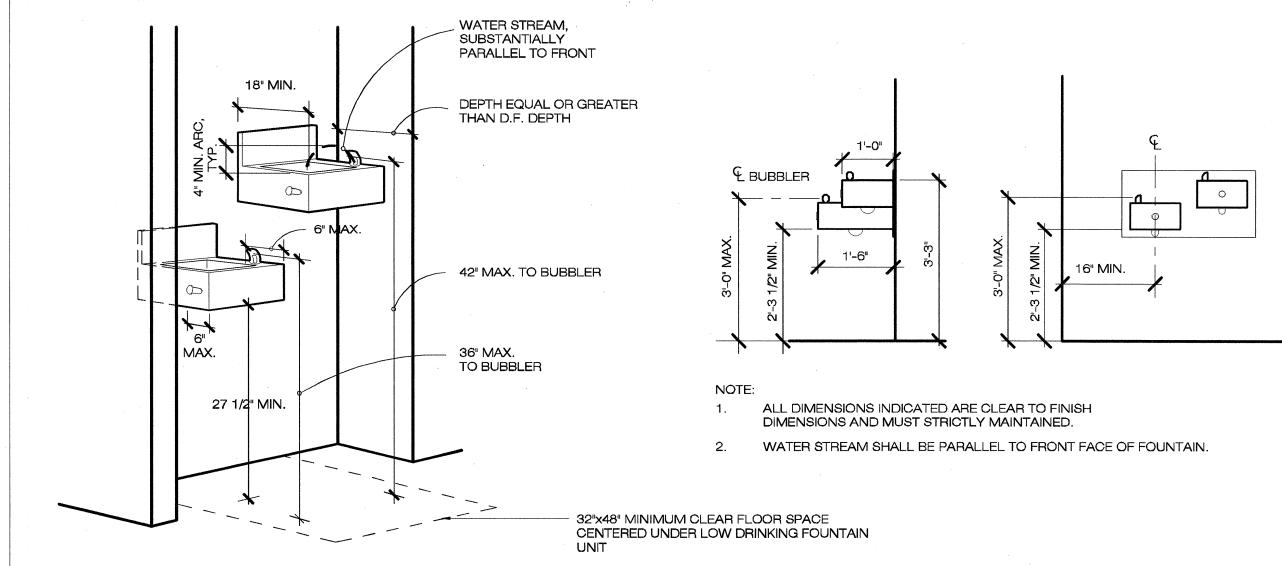
A11.1

Scale: As indicated Job No. 3092V-2


ACCESSIBLE DOOR SIGNAGE 1 1/2" = 1'-0"


Original Sheet Size: 22"x34"






8

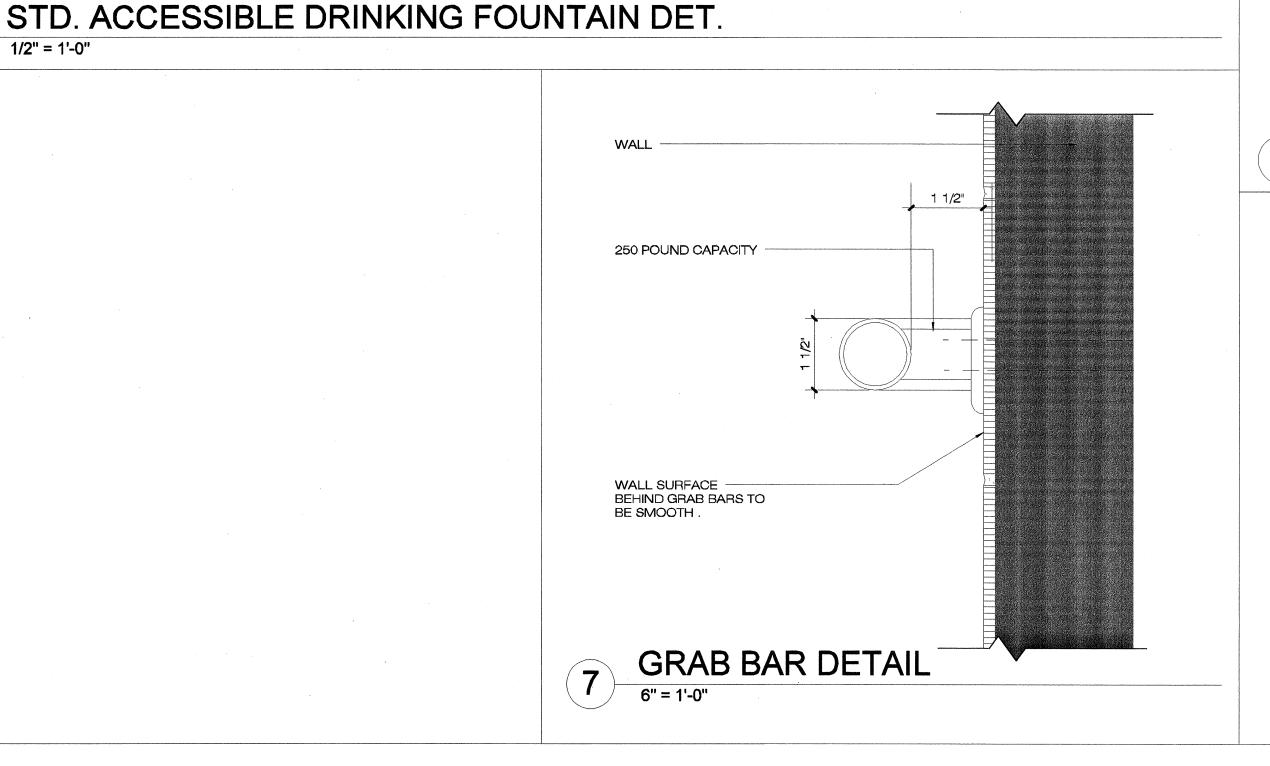

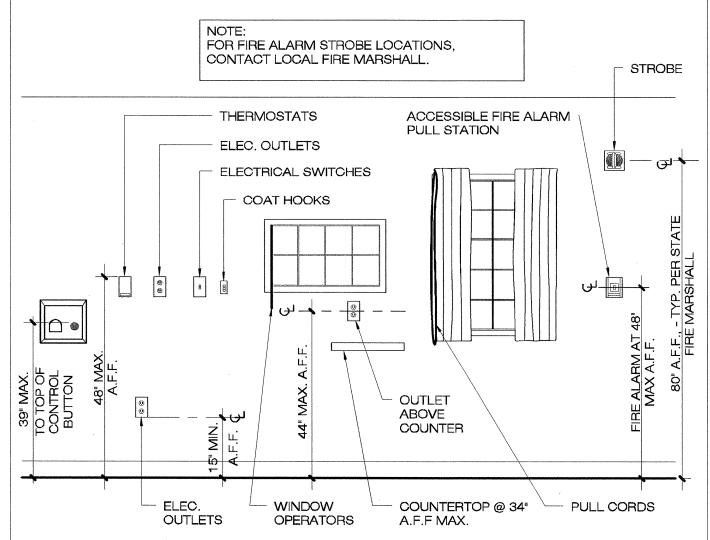

ACCESS. MOUNTING **HEIGHTS FOR** CONTROLS AND **OUTLETS**

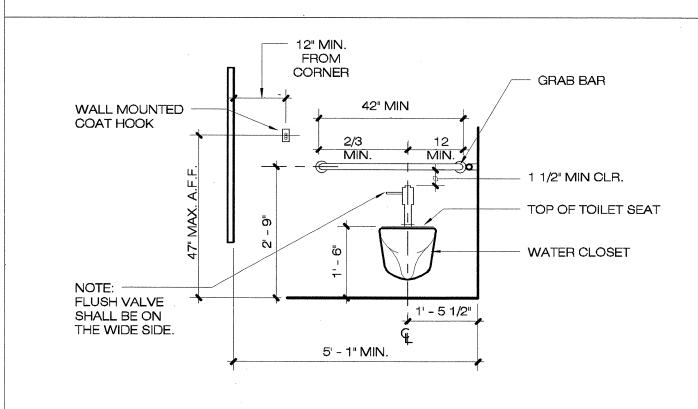
6



CONTROLS, OPERATING MECHANISMS, AND DOOR HARDWARE SHALL COMPLY WITH ADA 4:27.4 PG. 52 AND SFBC. NOTE: ALL DIMENSIONS INDICATED ARE CLEAR, FINISH TO CENTER LINES OF PLUMBING FIXTURES OR ACCESSORIES DIMENSIONS AND MUST BE

STD. ACCESS. TOILET STALL DET. (FRONT ELEV.)

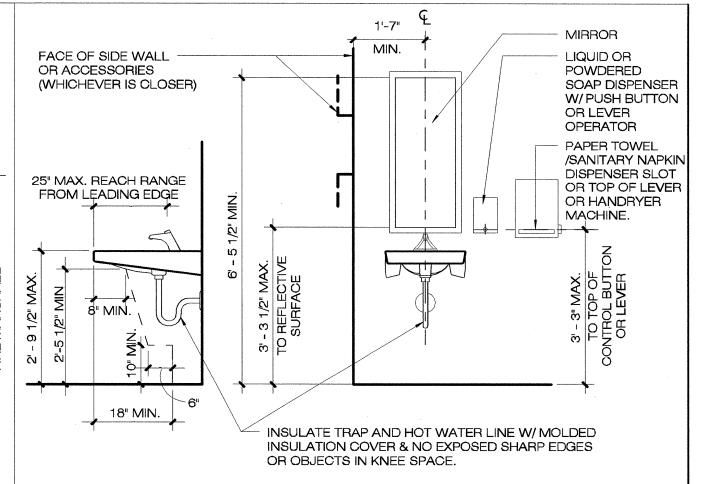1/2" = 1'-0"




ALL DIMENSIONS INDICATED ARE CLEAR, FINISH TO CENTER LINES OF PLUMBING FIXTURES OR ACCESSORIES DIMENSIONS AND MUST BE STRICTLY MAINTAINED FOR ALL SINK/COUNTER

SURFACE MOUNTED

CONTROL - NO GREATER THAN 5 LBS OPERATING FORCE.

STD. ACCESSIBLE SINK DET 3

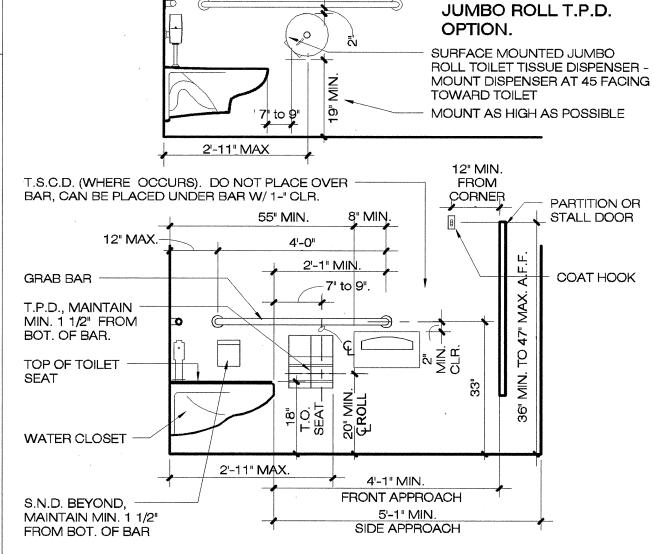
FINISH FACE OF WALL



1. ALL DIMENSIONS INDICATED ARE CLEAR, FINISH TO CENTER LINES OF PLUMBING FIXTURES OR ACCESSORIES DIMENSIONS AND MUST BE STRICTLY MAINTAINED 2. DISPENSER/DISPOSAL UNITS TO PROJECT NO MORE THAN 4" FROM FINISHED FACE OF 3. WATER CLOSET SHALL COMPLY WITH SFBC. GRAB BAR SHALL COMPLY WITH SFBC

STD. ACCESS. TOILET STALL DET. (SIDE ELEV.)

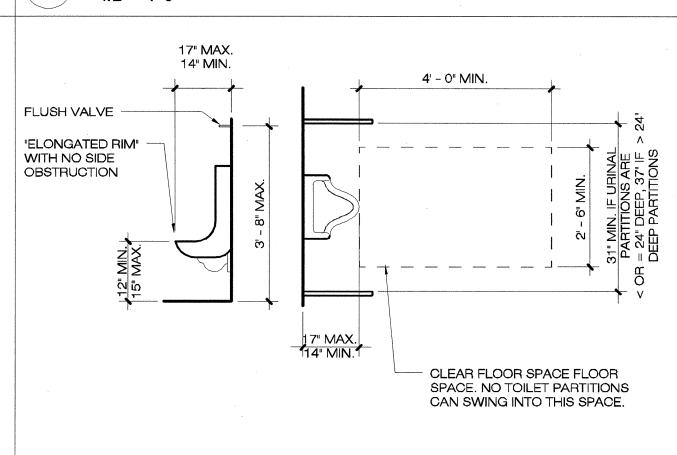2



STD. ACCESSIBLE URINAL DET.

DEPARTMENT OF PUBLIC WORKS CITY AND COUNTY OF SAN FRANCISCO

Fuad S. Sweiss - City Engineer

BUILDING DESIGN & CONSTRUCTION



Architecture • Construction Tara D. Lamont - Acting Deputy Division Manager

Fax (415)557-4701

(415)557-4700

San Francisco, CA 94102-6028

Project

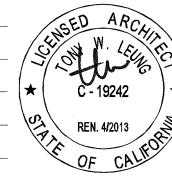
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