900 INNES PARK DEVELOPMENT

CONSTRUCTION DOCUMENTS JULY 01, 2021

SOURCING EVENT ID 0000005616

FUNDING SOURCE: 2020 HEALTH AND SAFETY BOND, PUBLIC & PRIVATE GRANTS

OWNER:

CITY AND COUNTY OF SAN FRANCISCO RECREATION AND PARKS DEPARTMENT 49 SOUTH VAN NESS AVENUE, SUITE 1220 SAN FRANCISCO, CA 94103 PHONE: 628.652.6644

PROJECT DESIGN TEAM:

GUSTAFSON GUTHRIE NICHOL, 206.903.6802

CEQA/EIR: 2014-002541ENV

GENERAL PLAN REFERRAL: 2014-002541GPR-02

ARTICLE 22A/MAHER: SMED 935

ELECTRONIC PLAN REVIEW NOTES:

- SITEWORK BELOW MHW (EL. 5.75) AND ALL IN WATER MARINE STRUCTURES (PIERS, DOCKS, GANGWAYS) TO BE REVIEWED BY THE PORT OF SAN FRANCISCO.
- ALL BUILDINGS, MEP AND SITE UTILITIES TO BE REVIEWED BY SFDBI.
- ADA REVIEW FOR SITE AND BUILDINGS IS BEING PERFORMED BY SFDPW
- SEE ARCH SHEET A001.1 FOR PROJECT SUMMARY, GENERAL NOTES AND APPLICABLE CODES.







SUMMARY OF WORK

CONSTRUCTION OF A NEW PUBLIC PARK ON THE SHORE OF INDIA BASIN IN SAN FRANCISCO, CALIFORNIA. WORK INCLUDES BUT NOT LIMITED TO THE FOLLOWING: PAVING, SITE WALLS, IRRIGATION, PLANTING, SEATING ELEMENTS, SITE FURNISHINGS, STAIRS AND RAILS, UTILITIES, LIGHTING, PERGOLA STRUCTURES, WAYFINDING AND SIGNAGE, MARINE PIERS, DOCKS AND GANGWAYS, RENOVATION OF HISTORIC SHIPWRIGHT'S COTTAGE, NEW FOOD PAVILION BUILDING, NEW SHOP BUILDING, AND NEW MAINTENANCE BUILDING.

BIDDER'S REQUIREMENTS

- IN ACCORDANCE WITH THE PROVISIONS OF THE CALIFORNIA PUBLIC CONTRACT CODE, SECTION 3300, A BID SUBMITTED TO A PUBLIC AGENCY BY A CONTRACTOR WHO IS NOT LICENSED IN ACCORDANCE WITH CHAPTER 9 OF THE BUSINESS & PROFESSIONS CODE SHALL BE CONSIDERED NON-RESPONSIVE AND SHALL BE REJECTED BY THE PUBLIC AGENCY.
- 2. AT THE TIME OF THE BID OPENING, THE CONTRACTOR SHALL POSSES A CLASS 'A' GENERAL ENGINEERING CONTRACTOR LICENSE.

PROJECT SITE AND EXISTING CONDTIONS

- FOR SITE EXISTING CONDITIONS, SEE SHEET G106.1, EXISTING CONDITIONS PLAN. PLAN PROVIDED BY REMEDIATION DESIGN ENGINEER.
- FOR SITE SURVEY, SEE SHEETS G010.1 THROUGH G015.1.
- 3. FOR SITE LIMIT-OF-WORK PLAN, SEE SHEET G101.1.

PARCEL MAP AND PROPERTY INFORMATION

1. FOR PARCEL AND PROPERTY INFORMATION SEE SHEET G102.1, STREET VACATION AND PARCEL MAP.

FOR OFFICIAL USE:

900 INNES PARK DEVELOPMENT

49 SOUTH VAN NESS AVENUE, SUITE 1220 SAN FRANCISCO, CA 94103 PH. 415-831-2700

101 MONTGOMERY STREET SAN FRANCISCO, CA 94104 PH. 415-495-4014



PRIME CONSULTANT / LANDSCAPE ARCHITECT **GUSTAFSON GUTHRIE NICHOL** PH. 206-903-6802

CIVIL ENGINEER

SHERWOOD DESIGN ENGINEERS PH. 415-348-9650

JENSEN ARCHITECTS PH. 415-348-9650

ECOLOGICAL RESTORATION

RANA CREEK PH. 831-659-3820

STRUCTURAL ENGINEER JON BRODY STRUCTURAL ENGINEERS

PH. 415-296-9494 MOFFATT AND NICHOL

PH. 925-944-5411 LIGHTING

NITEO CALIFORNIA PH. 415-666-2232

INTERFACE ENGINEERING

PH. 415-489-7240 **GEOTECHNICAL ENGINEER**

AGS, INC

PH. 415-957-9240

SECURITY CONSULTANT ZBETA CONSULTING PH. 415-259-0422

FOR OFFICIAL USE

KEY PLAN



RE	VISIONS:	
NO.	DATE	DESCRIPTION

ISSUANCE

BID SET

GGN PROJECT #

9/24/2021

COVER SHEET

G000.1

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SECURITY CONSULTANT
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PH. 415-259-0422

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SHEET INDEX

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ABBREVIATIONS 900 INNES **BID SET** 900 INNES PARK DEVELOPMENT BID SEI JULY 1, 2021 PARK DEVELOPMENT ANGLE LAVATORY POUNDS LINEAR CITY AND COUNTY OF SAN FRANCISCO ACOUSTICAL LOCKER RECREATION AND PARKS DEPARTMENT AREA DRAIN LOCATION 30 VAN NESS AVENUE **ADJUSTABLE** LIGHTING PROJECT SUMMARY **GENERAL NOTES DRAWING INDEX** SAN FRANCISCO, CA 94102 ABOVE FINISH FLOOR **MACHINE** PH. 415-831-2700 **AGGREGRATE** MAGNETIC MATERIAL ALUMINUM ARCH DRAWING INDEX & LEGENDS **DESCRIPTION:** ALTERNATI MAXIMUM CONTRACTOR TO VERIFY CONDITIONS AND DIMENSIONS AT THE SITE. BRING ANY INCONSISTENCIES TO THE ATTENTION OF THE ARCH DRAWING INDEX CONTINUED 101 MONTGOMERY STREET MEDIUM DENSITY FIBERBOARD APPROXIMAT This project consists of the Phase I SUITE 900 ARCHITECT BEFORE PROCEEDING WITH WORK ARCH. ARCHITEC¹ MEDIUM DENSITY OVERLAY (BOARD) PLUMBING FIXTURE KEY PLAN expansion of India Basin Shoreline Park SAN FRANCISCO, CA 94104 ARCH'L **ARCHITECTURA** MECH. **MECHANICAL** GREEN BLDG. SUBMITTAL FORM GS6 PH. 415-495-4014 MEMB. into adjacent properties known collectively ASPHAL MEMBRANE DO NOT SCALE DRAWINGS. WRITTEN DIMENSIONS SHALL GOVERN. DETAILS SHALL GOVERN OVER PLANS AND ELEVATIONS. LARGE **BATHROOM** MOMENT FRAM as the 900 Innes site as part of the overall TITLE 24 CERTIFICATE OF COMPLIANCE SCALE DRAWINGS SHALL GOVERN OVER SMALL SCALE DRAWINGS. CONTRACTOR SHALL NOTIFY ARCHITECT OF ANY CONFLICTS IN **MANUFACTUREI** waterfront parks. Scope of architectural PRIME CONSULTANT / LANDSCAPE ARCHITECT TITLE 24 CERTIFICATE OF COMPLIANCE WRITING PRIOR TO COMMENCEMENT OF WORK **BEDROOM** MANHOLE **GUSTAFSON GUTHRIE NICHOL** work includes a pergola and four buildings **BETWEEN** MINIMUM TITLE 24 CERTIFICATE OF COMPLIANCE PH. 206-903-6802 MISC. BITUMINOU MISCELLANEOU the rehabilitation and reuse of a historic ALL DIMENSIONS ARE TO FACE OF FINISH UNLESS OTHERWISE NOTED. ACCESSIBILITY DETAILS - TYP. CIVIL ENGINEER BLOCKING MEASURING POIN landmark residential building, new MTD. MOUNTED SHERWOOD DESIGN ENGINEERS ACCESSIBILITY DETAILS - TYP. construction of a restaurant with public PH. 415-348-9650 BOARD COORDINATE EXACT LOCATION OF ALL ELECTRICAL FIXTURES AND OUTLETS WITH ARCHITECT IN THE FIELD. ACCESSIBILITY DETAILS - TYP. BOTTOM MUL. restrooms, a multipurpose community BTM. MULLION ARCHITECT **BOTTOM O** center, and a maintenance office and JENSEN ARCHITECTS TYP. CEILING & LIGHTING DETAILS 5. INSTALL ALL MATERIALS, EQUIPMENT AND FIXTURES IN CONFORMANCE WITH THE REQUIREMENTS AND RECOMMENDATIONS OF THE BLDG. **BUILDING** NORTH PH. 415-348-9650 storage building. Site work includes new MANUFACTURER. ARCHITECTURAL PLOT PLAN **BUILT UP** NATURAL **ECOLOGICAL RESTORATION** piers, a dock, accessible paths, ramps, **CABINE** NOT IN CONTRAC EXISTING STREETSCAPE PHOTOS RANA CREEK CATCH BASIN NUMBER stairs, furniture, lighting and signage. PH. 831-659-3820 6. PROVIDE ALL NECESSARY BLOCKING, BACKING, AND FRAMING FOR LIGHT FIXTURES, ELECTRICAL UNITS, PLUMBING FIXTURES, HEATING EGRESS / ACCESSIBLE POT / FIRE RATING PLAN CHANNEL NOMINAL EQUIPMENT, CASEWORK AND ALL OTHER ITEMS REQUIRING SUPPORT. STRUCTURAL ENGINEER CEILING HEIGH NOT TO SCAL SHIPWRIGHT'S COTTAGE - BUILDING SITE PLAN Phase II work under later separate permit JON BRODY STRUCTURAL ENGINEERS CONTROL JOINT ON CENTER OCC(UP). OCCUPANT(S) / OCCUPANCY PH. 415-296-9494 CENTERLINE includes renovation of the existing India SHIPWRIGHT'S COTTAGE - EXISTING / DEMO PLANS 7. $\,$ CONTRACTOR IS RESPONSIBLE FOR LOCATING AND PROTECTING ALL EXISTING ON-SITE UTILITIES DURING WORK. CLG.... CLKG. CLO. C.O. CLR. COL. CEILING **OUTSIDE DIAMETER** Basin Shoreline Park. **COASTAL ENGINEER** SHIPWRIGHT'S COTTAGE - PROPOSED PLANS CAULKING MOFFATT AND NICHOL OPER. 8. ANY QUESTIONS REGARDING THE INTENT RELATED TO THE LAYOUT OF THE NEW WORK SHALL BE BROUGHT TO THE ATTENTION OF THE **CLOSET OPERABLE** SHIPWRIGHT'S COTTAGE - PROPOSED ROOF PLAN PH. 925-944-5411 OPNG. CLEAN OUT **OPENING** ARCHITECT PRIOR TO PROCEEDING WITH ANY WORK. LIGHTING SHIPWRIGHT'S COTTAGE - SLAB PLANS CLEAR **OPPOSITE** NITEO CALIFORNIA OPP.HD. COLUMN OPPOSITE HAND SHIPWRIGHT'S COTTAGE - FINISH PLANS PH. 415-666-2232 9. SEE STRUCTURAL SHEETS FOR SPECIAL INSPECTIONS AND STRUCTURAL OBSERVATIONS COMP. COMPOSITE OVERHEAD **PLANNING DATA:** SHIPWRIGHT'S COTTAGE - RCPS CONC. CONCRETE MEP & IT **PAVING** CONN. PROJECT ADDRESS INTERFACE ENGINEERING CONNECTION PERFORATED 900 INNES AVE. SHIPWRIGHT'S COTTAGE - EXT. ELEVATIONS 10. CONTRACTOR SHALL PROTECT PROPERTY AND ADJACENT PROPERTIES AS REQUIRED AND SHALL PROVIDE AND MAINTAIN TEMPORARY CONSTR. CONSTRUCTION PERPENDICULAR PH. 415-489-7240 SAN FRANCISCO CA 94124 BARRICADES, CLOSURE WALLS, ETC. AS REQUIRED TO PROTECT THE PUBLIC AS REQUIRED DURING THE PERIOD OF CONSTRUCTION. SHIPWRIGHT'S COTTAGE - SECTIONS CONT. CONTINUOUS **GEOTECHNICAL ENGINEER** BLOCK AND LOT 4646/003, 4646/020, 4646/001 DAMAGE TO MATERIALS, FINISHES, STRUCTURES, AND EQUIPMENT SHALL BE REPAIRED OR REPLACED. CONTRACTOR SHALL C.M.U. CONCRETE MASONRY UNIT PROPERTY LINE SHIPWRIGHT'S COTTAGE - SECTIONS AGS, INC CASEWORK PLASTIC LAMINAT ZONING DISTRICT COORDINATE TEMPORARY BARRICADES WITH ARCHITECT AND/OR OWNER PRIOR TO COMMENCEMENT OF WORK. PH. 415-957-9240 SHIPWRIGHTS COTTAGE - WALL SECTIONS CERAMIC TILI BULK & HEIGHT DISTRICT OS SECURITY CONSULTANT CENTER PLYWD. PLYWOOD SHIPWRIGHTS COTTAGE - INTERIOR ELEVATIONS 11. THE CONTRACTOR SHALL BE RESPONSIBLE FOR ENGINEERING AND BUILDING OF SHORING OR TEMPORARY RETAINING STRUCTURES AS ZBETA CONSULTING CTSK. COUNTERSIN PLANNING DISTRICT SOUTH BAYSHORE PH. 415-259-0422 PROP. COLD WATER PROPERTY REQUIRED IN THE PERFORMANCE OF THE WORK. SUCH SHORING SHALL BE CONSTRUCTED SUCH AS TO GUARANTEE THE STRUCTURAL SHIPWRIGHT'S COTTAGE - ENLARGED PLANS DOUBLE PAINT(ED) INTEGRITY OF NEW CONSTRUCTION AND EXISITNG CONDITIONS. SHIPWRIGHT'S COTTAGE - ENLARGED EL PLANNING QUADRANT SOUTHEAST FOR OFFICIAL USE DEPARTMENT PRESSURE TREATE EGRESS / ACCESSIBLE POT / FIRE RATING PLAN PARKING LANDMARK STATUS LANDMARK #250 12. THE CONTRACTOR SHALL MAINTAIN A CURRENT AND COMPLETE SET OF CONSTRUCTION DOCUMENTS ON THE JOB SITE DURING ALL DRINKING FOUNTAIN POLYVINYL CHLORIDE LOT AREA 1.873 SF (003) FOOD PAVILION - BUILDING SITE PLAN DIAMETER **QUARRY TILE** PHASES OF CONSTRUCTION AND PROVIDE ALL SUBCONTRACTORS WITH CURRENT CONSTRUCTION DOCUMENTS AS REQUIRED. PER CITY DIAMETER QUANTITY FOOD PAVILION - PROPOSED UPPER PLAN REQUIREMENTS, ONE ORIGINAL STAMPED APPROVED SET OF PLANS AND JOB CARD SHALL ALSO BE MAINTAINED BY THE CONTRACTOR **DIMENSION** QUALITY **OVERALL SITE DATA:** ON SITE. FOOD PAVILION - PROPOSED LOWER PLAN DISP. DISPENSER SITE AREA 117,800 SF **RADIUS** DOWN FOOD PAVILION - PROPOSED ROOF PLAN DOOR OPENING RESILIENT CHANNE USEABLE OPEN SPACE AREA 94.100 SF 13. ALL ELECTRICAL, MECHANICAL, AND PLUMBING WORK AND MATERIALS SHALL BE IN FULL ACCORDANCE WITH THE LATEST RULES AND FOOD PAVILION - SLAB PLANS DOOR REINFORCED CONCRETE TOTAL (E) BLDG. AREA (CBC) 1.464 SF REGULATIONS OF THE NATIONAL BOARD OF FIRE UNDERWRITERS. THE PROVINCIAL FIRE MARSHALL. THE SAFETY ORDERS OF THE REFLECTED CEILING PLAN DOWNSPOUT FOOD PAVILION - RCPS DIVISION OF INDUSTRIAL SAFETY, AND ANY APPLICABLE STATE OR LOCAL LAWS AND ORDINANCES. NOTHING ON THESE DRAWINGS IS TO TOTAL (N) BLDG. AREA (CBC) 6,267 SF DRAWING(S) DWG(S). ROOF DRAIN FOOD PAVILION - EXT. ELEVATIONS EXISTING REFERNCE BE CONSTRUED TO PERMIT WORK NOT CONFORMING TO THESE CODES. E) GROSS BLDG. AREA 1.637 SF KEY PLAN RGTR. REGISTER FOOD PAVILION - EXT. ELEVATIONS (N) GROSS BLDG. AREA 7.011 SF REINF. EACH REINFORCED 14. CONTRACTOR SHALL CONDUCT FIELD TEST FOR CONFORMANCE WITH CFC SECTION 510 IF RADIO REPEATER NEEDS TO BE INSTALLED FOOD PAVILION - SECTION EXHAUST FAN REQ(D). COMMERCIAL / RETAIL AREA REQUIRED FOR EFFECTIVE FIRE CREW RESPONDER COMMUNICATIONS AT SITE PREMISES. **EXPANSION JOINT** REQMT REQUIREMEN FOOD PAVILION - SECTION OFFICE AREA ELEVATION RESIL. RESILIENT EXTERIOR BIKE PARKING 10 SPACES (CLASS 2) FOOD PAVILION - WALL SECTIONS ELECTRICAL / ELECTRIFIED REVISION / REVISE 15. NO TWO ELECTRICAL POWER OUTLETS SHALL BE DIRECTLY ALIGNED ON A COMMON WALL PER CFC 605. **ELEVATOR** MAX. EXCAVATION DEPTH FOOD PAVILION - WALL SECTIONS EMER. **EMERGENC** ROUGH OPENING TOTAL SOIL DISTURBANCE 6,437 CY 16. PROVIDE SPRINKLER DRAINAGE DISCHARGE TO THE CITY'S SANITARY SEWER SYSTEM, NOT TO STORM DRAINS PER CITY'S RETROACTIVE FOOD PAVILION - INTERIOR ELEVATIONS ENG. **ENGINEER** REDWOOD R.W.L. RAIN WATER LEADER **EQUAL** CLEAN WATER PROGRAM. ALL DRAINS SHALL DISCHARGE TO SEWER OR OPEN PLANTER AREAS ONLY; NOT TO STORM DRAINS PER CITY'S FOOD PAVILION - INTERIOR ELEVATIONS **EQUIPMENT APPLICABLE CODES** RETROACTIVE CLEAN WATER PROGRAM. DRAINS TO SEWER SHALL COMPLY WITH CALIFORNIA PLUMBING CODE. NFPA 13 MAY BE USED EACH SIDE SOLID CORE INNES PERGOLA DRAWINGS SELF-ADHERED **EXPOSED** FOOD PAVILION - ENLARGED PLANS **EXTERIOR** SCHEDULE(D) SEE ELECTRICAL DRAWINGS 2020 SAN FRANCISCO PLANNING CODE W/ ALL FIRE ALARM |FOOD PAVILION - ENLARGED EL 17. OBSERVE FIRE SAFETY DURING DEMOLITION AND CONSTRUCTION WORK AND THE FIRE ALARM SERVICE PROVIDER DURING TEMPORARY FORCED AIR UNI STOREFRONT F.A.U. AMENDMENTS TO PRESENT DATE FOOD PAVILION - ENLARGED EL SHUTDOWNS AND SERVICE RESUMPTION OF SPRINKLER AND FIRE ALARM SYSTEMS. PROVIDE 2A10BC FIRE EXTINGUISHERS WITHIN 75 S.H.A.D. SEE HISTORIC ARCHITECT DRAWINGS FLOOR DRAIN FEET OR ONE FIRE EXTINGUISHER EVERY 1500 SQUARE FEET, WHICHEVER IS MORE DURING DEMOLITION AND CONSTRUCTION WORK. FIRE EXTINGUISHER FOOD PAVILION - ENLARGED EL. SHTG. SHEATHING FIRE EXTINGUISHER CABINET 2019 CALIFORNIA BUILDING CODE W/ SF AMEND. REF.: CCR TITLE 19. CH. 3. 2016 CFC SECTION 906. COMPLY WITH 2016 CFC SECTION 605 TO OBSERVE ELECTRICAL SAFETY. THE OWNER FOOD PAVILION - GUARDRAIL DETAILS FLOOR CLEAN OUT SIMII AR 2019 CALIFORNIA MECH. CODE W/ SF AMEND. PROPERTY MANAGER, AND/OR CONTRACTOR SHALL BE RESPONSIBLE TO EFFECT A PREPLANNED IMPAIRMENT PROGRAM DURING THE SIM OPP. SIMILAR OPPOSITE FINISH FLOOR EGRESS / ACCESSIBLE POT / FIRE RATING PLAN 2019 CALIFORNIA ELECTRICAL CODE W/ SF AMEND. SCHEDULED DEMOLITION AND CONSTRUCTION WORK PER 2016 CFC SECTION 901.7.4 TO ASSURE THE SAFETY OF THE BUILDING No. C21410 SEE LANDSCAPE DRAWINGS SHOP BUILDING - BUILDING SITE PLAN SEE MECHANICAL DRAWINGS FIXTURE OCCUPANTS DURING NEW CONSTRUCTION WORK. 2019 CALIFORNIA PLUMBING CODE W/ SF AMEND. SEE PLUMBING DRAWINGS **FLOOR** SHOP BUILDING - PROPOSED FLOOR PLAN 2019 CALIFORNIA ENERGY CODE SPECIFICATION(S) FLASH. FLASHING SHOP BUILDING - PROPOSED ROOF PLAN FLUOR. FLUORESCEN' 2019 CALIFORNIA FIRE CODE SEE STRUCTURAL DRAWINGS **FOUNDATION** SHOP BUILDING - SLAB PLAN 2019 CALIFORNIA HISTORICAL CODE FACE OF STAINLESS STEEI **REVISIONS:** SHOP BUILDING - RCP FACE OF CONCRETE F.O.F. FACE OF FINISH STANDARD 2020 SAN FRANCISCO HEALTH CODE OTHER CODES: SHOP BUILDING - EXT. ELEVATIONS NO. DATE DESCRIPTION F.O.S. FACE OF STUD STORAGE 2020 CALIFORNIA RETAIL FOOD CODE FPRF. SHOP BUILDING - SECTIONS STRUCTURA FIREPROOF(ING 01 12/18/2020 PERMIT SUBMITTAL SUSPENDED FIRE SPRINKLE 2010 ADA STANDARDS FOR ACCESSIBLE DESIGN SHOP BUILDING - WALL SECTIONS FIRE TREATED FTG. TELEPHONE SHOP BUILDING - INTERIOR ELEVATIONS F.R. TEMPERED FIRE RATED EGRESS / ACCESSIBLE POT / FIRE RATING PLAN FRAME **TONGUE & GROOVE** GAUGE MAINTENANCE BLDG. - BUILDING SITE PLAN **SYMBOLS** GALVANIZED MAINTENANCE BLDG. - PROPOSED FLOOR PLAN **GRAB BAR** GLASS FIBER REINF. CONC. TOP OF MAINTENANCE BLDG. - PROPOSED ROOF PLAN TOP OF SLAB / SHEATHING **GLASS ROOM NAME** MAINTENANCE BUILDING - SLAB PLAN GROUND TELEVISION STRUCTURAL GRID LINE GRADE TOP OF WALL MAINTENANCE BLDG. - RCP **ROOM NUMBER** GALVANIZED SHEET METAL **TYPICAL** ISSUANCE MAINTENANCE BLDG. - EXT. ELEVATIONS GYP RD GYPSUM BOARD UNFINISHED **REVISION NOTE BID SET HOSE BIB** UNLESS OTHERWISE NOTED MAINTENANCE BLDG. - SECTIONS FLOOR FINISH . 14'-7 1/2" 150 SF 🥿 **HOLLOW CORE REVISION BUBBLE** T.O. DECK **BUILDING SECTION DIMENSION POINT** MAINTENANCE BLDG - WALL SECTIONS DRAWN BY CHECKED BY HOT-DIPPED GALVANIZED VINYL COMPOSITION TILE MAINTENANCE BLDG. - INTERIOR ELEVATIONS **JENSEN** HDR. HEADER CEILING TYPE |MAINTENANCE BLDG. - ENLARGED PLANS & EL. HDWD. HARDWOOD **VERTICAL GGN PROJECT #** VERTICAL GRAIN DOUGLAS FIR ASSEMBLY TYPE CALLOUT MAINTENANCE BLDG. - ENLARGED PLANS & EL. 7/01/2021 HOLLOW META **VERIFY IN FIELD BUILDING ELEVATION** CEILING HEIGHT HORIZ. HORIZONTAL HAND RAIL (INDEX CONTINUED ON NEXT SHEET) **ARCH DRAWING INDEX &** DOOR NUMBER WATER CLOSET NORTH ARROW W/ SIMPLIFIED NORTH H.S.S. HOLLOW STRUCT. S **LEGENDS** SOLAR ORIENTATION NORTH ARROW H.W. HOT WATER WASHER / DRYEF INTERIOR ELEVATION INSIDE DIAMETER WINDOW WINDOW NUMBER INSUL. WATER HEATER INSULATION **INTERIOR** WALL MOUNT WHERE OCCURS **JANITOR** WITHOUT WINTER WATERPROOF(ING) KEYNOTE **JOINT** \A1.01∠ WEATHER-RESISTIVE BARRIER JUNCTION BOX

KITCHEN

KNOCKOL

W.F.

WIDE FLANGE

900 INNES PARK

BID SET JULY 1, 2021

DRAWING INDEX CONTINUED

DRA	AWING INDEX CONTINUED	SAN FRANCISCO, PH. 415-831-2700
A701.1	900 INNES RENDERINGS	THE TRUST FOR PU
A721.1	INT. DOOR TYPES & SCHEDULE	101 MONTGOMER SUITE 900
A722.1	EXT. DOOR TYPES & SCHEDULE	SAN FRANCISCO,
A723.1	WINDOW TYPES & SCHEDULE	PH. 415-495-4014
A724.1	WINDOW TYPES & SCHEDULE	
A801.1	WALL TYPES - EXTERIOR	PRIME CONSULTAN GUSTAFSON GUTH
A802.1	WALL TYPES - EXTERIOR	PH. 206-903-6802
A803.1	WALL TYPES - INTERIOR	CIVIL ENGINEER
A811.1	FLOOR & ROOF TYPES	SHERWOOD DESIG PH. 415-348-9650
A812.1	CEILING TYPES	ARCHITECT
A821.1	FOUNDATION & SUBGRADE WP. DETAILS	JENSEN ARCHITEC
A822.1	FOUNDATION & SUBGRADE WP. DETAILS	PH. 415-348-9650 ECOLOGICAL REST
A831.1	ENCLOSURE DETAILS - PLAN	RANA CREEK
A832.1	ENCLOSURE DETAILS - PLAN	PH. 831-659-3820
A833.1	ENCLOSURE DETAILS - PLAN	STRUCTURAL ENG JON BRODY STRUC
A841.1	ENCLOSURE DETAILS - SECTION	PH. 415-296-9494
A842.1	ENCLOSURE DETAILS - SECTION	COASTAL ENGINEE MOFFATT AND NICE
A843.1	ENCLOSURE DETAILS - SECTION	PH. 925-944-5411
A844.1	ENCLOSURE DETAILS - SECTION	LIGHTING
A845.1	ENCLOSURE DETAILS - SECTION	NITEO CALIFORNIA PH. 415-666-2232
A851.1	EXT. DR. & WDW. DETAILS	MEP & IT
A852.1	EXT. DR. & WDW. DETAILS	INTERFACE ENGINI PH. 415-489-7240
A853.1	EXT. DR. & WDW. DETAILS	GEOTECHNICAL EN
A854.1	EXT. DR. & WDW. DETAILS	AGS, INC
A861.1	FLASHING, WP. & MISC. EXT. DETAILS	PH. 415-957-9240
A871.1	ROOF DETAILS - COMP. SHINGLE	SECURITY CONSUL ZBETA CONSULTIN
A872.1	ROOF DETAILS - FLAT ROOF	PH. 415-259-0422
A873.1	ROOF DETAILS - RAINSCREEN PERF ROOF	FOR OFFICIAL USE
A874.1	ROOF DETAILS - STANDING SEAM	
A881.1	INNES EDGE TRELLIS DETAILS	
A882.1	GATE DETAILS	
A901.1	TYP. INTERIOR DOOR DETAILS	
A911.1	INTERIOR DETAILS	
A921.1	INTERIOR DETAILS	
		7

900 INNES PARK DEVELOPMENT

CITY AND COUNTY OF SAN FRANCISCO RECREATION AND PARKS DEPARTMENT 30 VAN NESS AVENUE SAN FRANCISCO, CA 94102




PH. 415-831-2700 THE TRUST FOR PUBLIC LAND 101 MONTGOMERY STREET SUITE 900 SAN FRANCISCO, CA 94104

PH. 415-495-4014



PRIME CONSULTANT / LANDSCAPE ARCHITECT GUSTAFSON GUTHRIE NICHOL PH. 206-903-6802 CIVIL ENGINEER SHERWOOD DESIGN ENGINEERS PH. 415-348-9650 JENSEN ARCHITECTS PH. 415-348-9650 ECOLOGICAL RESTORATION RANA CREEK PH. 831-659-3820 STRUCTURAL ENGINEER JON BRODY STRUCTURAL ENGINEERS PH. 415-296-9494 COASTAL ENGINEER MOFFATT AND NICHOL PH. 925-944-5411 LIGHTING NITEO CALIFORNIA PH. 415-666-2232 INTERFACE ENGINEERING PH. 415-489-7240 GEOTECHNICAL ENGINEER AGS, INC PH. 415-957-9240 SECURITY CONSULTANT ZBETA CONSULTING PH. 415-259-0422

KEY PLAN

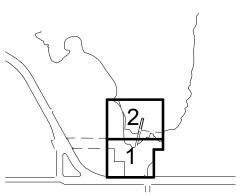



REVISIONS:	


ISSUANCE

BID SET CHECKED BY

DRAWN BY

GGN PROJECT # 7/01/2021

ARCH DRAWING INDEX CONTINUED

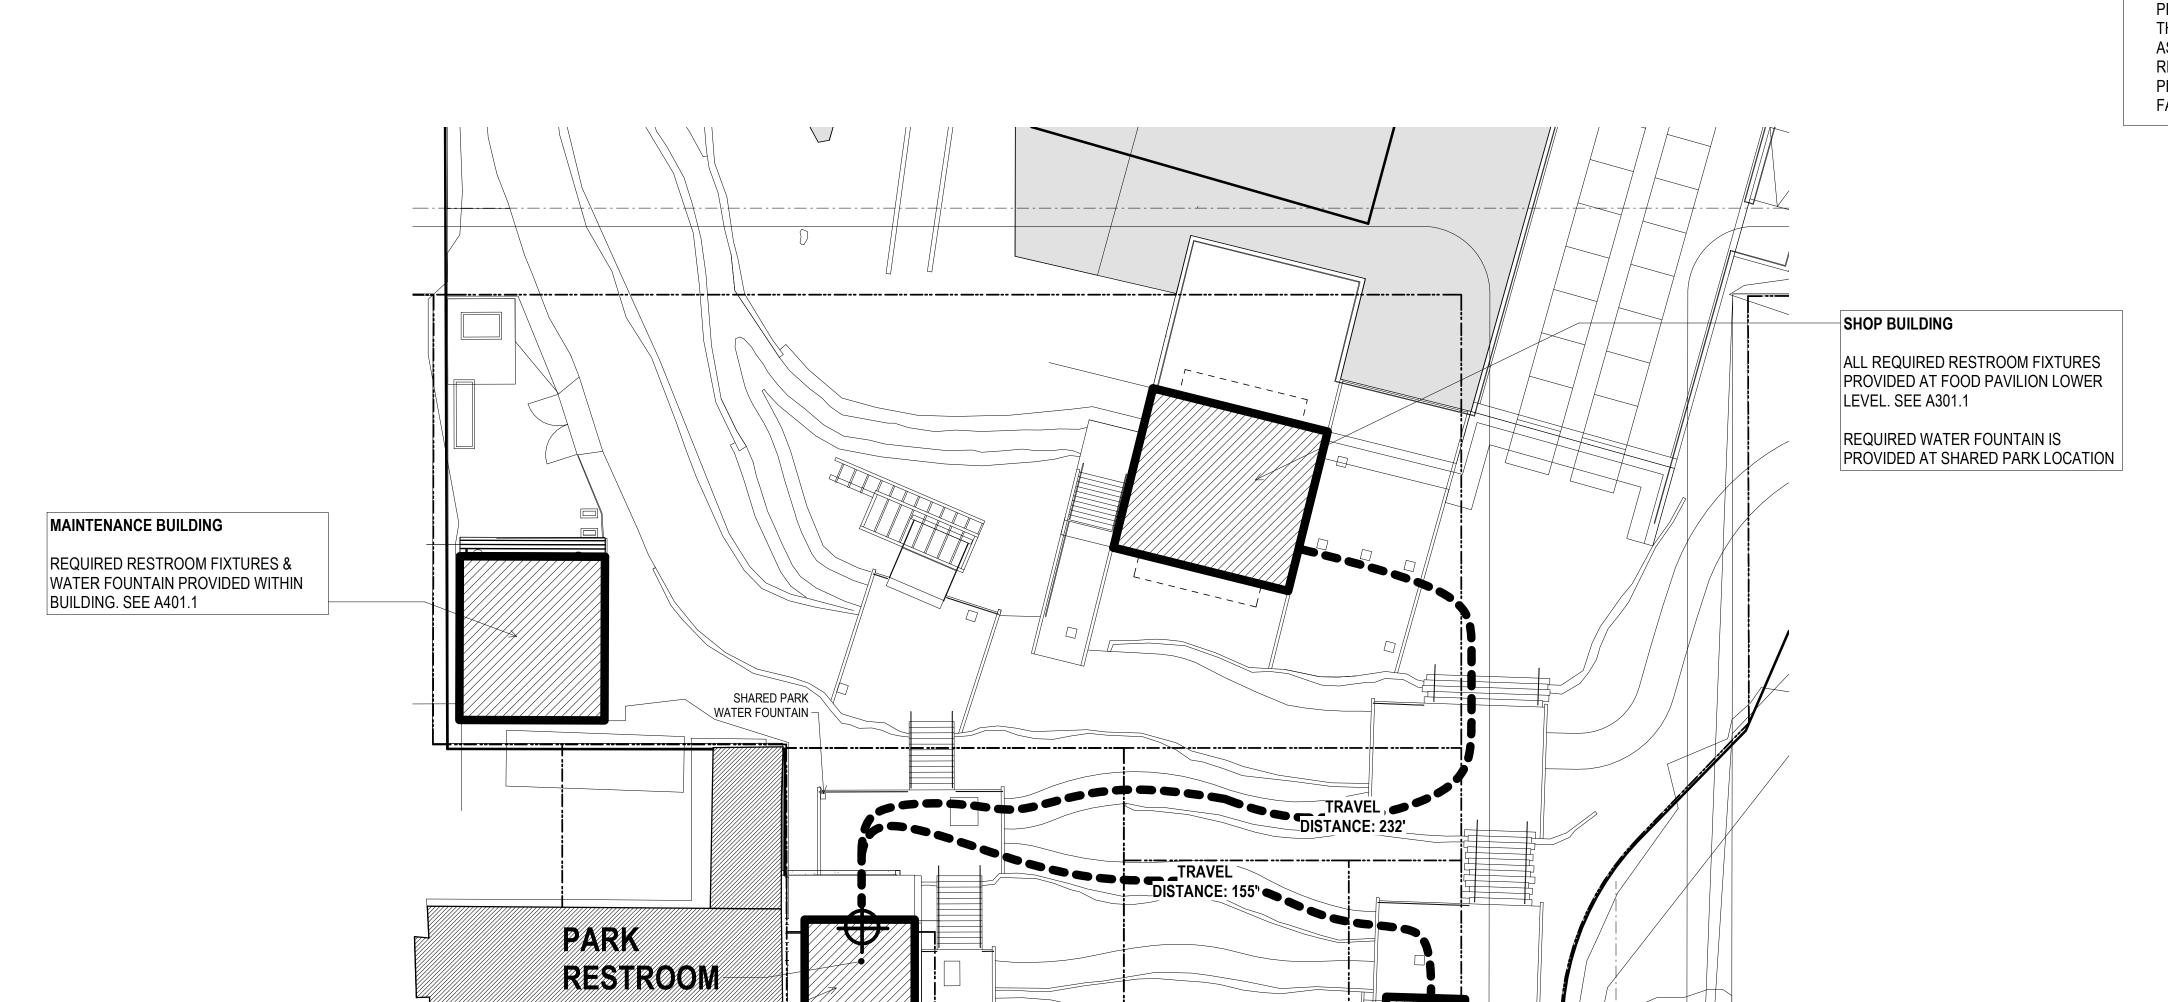

INNES AVE

SHIPWRIGHT'S COTTAGE

REQUIRED RESTROOM FIXTURES

REQUIRED WATER FOUNTAIN IS

PROVIDED WITHIN BUILDING. SEE A101.1

PROVIDED AT SHARED PARK LOCATION

SHEET NOTES:

- SEE SHEET G101.1 FOR SITE-WIDE ACCESSIBILITY
- . PER CBC SECTION 2902.3.2 THE REQUIRED TOILET FACILITIES FOR THE PARK ARE PROVIDED NOT MORE THAN ONE STORY ABOVE OR BELOW EACH SPACE, AND WITHIN 500 FEET OF TRAVEL DISTANCE.
- . FIXTURE COUNTS ARE TABULATED BASED ON COMPLIANCE WITH 2019 CPC TABLE 422.1. ADDITIONAL FIXTURES IN EXCESS OF THOSE REQUIRED ARE PROVIDED AT THE FOOD PAVILION AT THE LOWER LEVEL PUBLIC RESTROOM AS A PUBLIC CONVENIENCE. NOTE THAT RESTROOMS FOR EVENTS WILL BE PROVIDED VIA TEMPORARY PORTABLE FACILITIES.

900 INNES PARK DEVELOPMENT

CITY AND COUNTY OF SAN FRANCISCO RECREATION AND PARKS DEPARTMENT 30 VAN NESS AVENUE



SAN FRANCISCO, CA 94102 PH. 415-831-2700 THE TRUST FOR PUBLIC LAND 101 MONTGOMERY STREET SUITE 900 SAN FRANCISCO, CA 94104

PH. 415-495-4014




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FOR OFFICIAL USE

PH. 415-259-0422

KEY PLAN



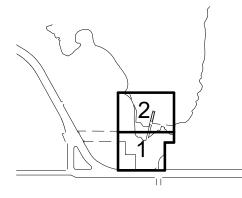

RE	VISIONS:	
10	DATE	DECC

DESCRIPTION NO. DATE 01 12/18/2020 PERMIT SUBMITTAL

ISSUANCE

BID SET CHECKED BY

DRAWN BY

JENSEN

GGN PROJECT #

7/01/2021 1608

PLUMBING FIXTURE KEY

PLAN

FOOD PAVILION LOWER LEVEL

FOOD PAVILION UPPER LEVEL

AT SHARED PARK LOCATION

REQUIRED RESTROOM FIXTURES ARE

PARTIALLY PROVIDED AT THE UPPER LEVEL. REMAINING FIXTURES ARE

PROVIDED AT LOWER LEVEL. SEE A201.1

REQUIRED WATER FOUNTAIN IS PROVIDED

PROVIDES RESTROOM FIXTURES FOR SHOP BUILDING AND FOOD PAVILION.

-TOTAL NET REQUIRED: 3 WC, 3 LAV., 1

-TOTAL PROVIDED: 7 WC, 8 LAV., 1 URINAL

GS6: San Francisco Green Building Submittal Form for Municipal Projects

	RUCTIONS:					MUNICIPAL		REFERENCES	VERIFICATION
2. For 3. Fill	ct one (1) column to the right. each requirement in the column, ind out the project information in the Ver	rification box at the right.	e Reference	CHECK THE ONE COLUMN THAT BEST DESCRIBES YOUR PROJECT	, D	COMMERCIAL	X		900 Innes Avenue
	ch LEED Scorecard on separate, sul ttal must be a minimum of 24" x 36"			*This form includes the requirements of San Francisco Green Building Code and Environment Code Chapter 7. Major Renovations as defined by Environment Code Chapter 7 also include Major Alterations as defined by SFGBC,	CONSTRUCTION & MAJOR RENOVATION*	INTERIORS	PROJECTS		PROJECT NAME 4646/003, 4646/020, 4646/001
	TITLE	SOURCE OF REQUIREMENT	LEED v4	where applicable. DESCRIPTION OF REQUIREMENT	10,000 sq.ft. or greater	10,000 sq.ft. or greater	less than 10,000 sq.ft. or any not meeting LEED MPR's	DRAWING OR SPECIFICATION # (If not applicable, indicate "N/A".)	BLOCK/LOT 900 Innes Avenue
П	Required LEED Certification Level	Environment Code sec.705		Project is required to achieve sustainability certification listed at right.	GOLD (60+) CERTIFIED	GOLD (60+) CERTIFIED, LEED CI	n/r		ADDRESS See A102.1, A202.1, A302.1, A402.1
	LEED Point Adjustment for Retention/Demolition of	SFGBC 5,104		Enter any applicable point adjustments in box at right.			n/r		PRIMARY OCCUPANCY
9	Historic Features/Building LEED Points shown	31.752.014.11							7,011 GSF
i	on Current Scorecard			Enter current expected LEED score in box at right.			n#		BUILDING GROSS FLOOR AREA
	LEED Scorecard Submittals	Environment Code sec. 705		For projects ≥10,000 sq.ft., submit LEED Scorecard to Municipal Green Building Task Force at 100% Concept Design, Schematic Design, Design Development, Construction Documents and As-Built. For projects <10,000 sq.ft., submit LEED Scorecard to Municipal Green Building Task Force at 100% Concept Design and As-Built. LEED Online is acceptable means of submittal.	•	T.			LEED PROJECTS
Ī	LOW-EMITTING MATERIALS	Environment Code sec,706 OR CALGreen 5.504.4.1-6	EQc2	For projects ≥10,000 sq.ft., use products that comply with LEED emissions & content requirements for paints, coatings, adhesives, sealants, flooring, composite wood, ceiling/wall/thermal/acoustic insulation, furniture if part of scope, and exterior applied products if healthcare or school project. For projects <10,000 sq.ft., use products that comply with the emission limit requirements of 5.504.4.1-6 for adhesives, sealants, paints, coatings, carpet systems including cushions and adhesives, resilient	LEED EQc2 (3 pts)	LEED EQc2 (3 pts)	5. 504.4.1-6	- Finish schedules on sheets A120.1, A220.1, A221.1, A320.1, & A420.1	Projects ≥10,000 square feet understand Environment Code Code
	CARPET	Regulation #SFE 207 8-01-PPO		flooring (80% of area), and composite wood products. Carpet must be commercial hard-backed carpet tiles and: 100% solution-dyed Type 6 or 6,6 cationic nylon; Cradle to Cradle Certified Silver; CRI Green Label Plus; hold Environmental Product Declaration & Health Product Declaration or equivalent; and contain <100 ppm antimicrobials & no flame retardants. PFAS, fly-ash, PVC, polyurethane, or synthetic styrene butadiene latex. Tile adhesive must meet CRI Green	en			- See specs. - No carpet in project. See finish	requires all applicable projects ≥10,000 feet to attain LEED Gold certificatio USGBC/GBCI. No Green Building Com Professional of Record is required.
	PVC ELIMINATION	Environment Code sec.509		Label Plus or California Specification 01350. Tile tape adhesive must also be C2CPII Material Health Certificaté (MHC) certified Bronze. Wet adhesives must also be C2CPII MHC Silver and contain <50g/I VO Specify no materials containing PVC.	2			schedules. Sheet nos. above. - None in project. See finish schedules.	
	LEAD ELIMINATION	Environment Code sec.711		Specify no materials containing lead.	10.0		(*)	- None in project. See finish schedules.	PROJECT MANAGER (name)
	TROPICAL HARDWOOD & VIRGIN REDWOOD BAN	Environment Code ch.8		Specify no tropical hardwoods or virgin redwoods.	1 = 1 • 1		•	- None in project. See finish schedules.	
	INDOOR WATER USE REDUCTION	Environment Code sec.706, CALGreen 5.303.3	BD+C/ID+C WEp2/WEp WEc2/WEc	Meet flush/flow requirements for: toilets (1.28gpf); urinals (0.125gpf wall, 0.5gpf floor); showerheads (1.8gpm); lavatories (1.2gpm private, 0.5gpm public/common); kitchen faucets (1.8gpm); wash fountains (1.8gpm); metering faucets (0.2gpc); food waste disposers (1gpm/8gpm). Additionally, for projects ≥10,000 sq.ft., use minimum 30% less potable water as calculated using a baseline with toilets (1.6gpf); urinals (1.0gpf); showerheads (2.5gpm); lavatories (2.2gpm private, 0.5gpm	LEED WEp2, LEED WEc2 (2 pts)	LEED WEp1 LEED WEc1 (4 pts)	5.303.3	- See plumbing drawings.	PROJECT MANAGER (sign & date)
i	NON-POTABLE WATER REUSE	Health Code art.12C	WEc2	public); kitchen faucets (2.2gpm). New buildings ≥40,000 sq.ft. must calculate a water budget. New buildings ≥250,000 sq.ft. must treat and use available rainwater, graywater, and foundation drainage for toilet and urinal flushing and irrigation.	J. 104-11	n/r	n/r		PROJECT MANAGER AGENCY
	WATER-EFFICIENT IRRIGATION			New construction projects with aggregated landscape area ≥500 sq.ft., or existing projects with modified landscape area ≥1,000 sq.ft., shall use low water use plants or climate appropriate plants, restrict turf				- See landscape drawings.	
	WATER METERING	CALGreen 5.303.1	WEc4	areas and comply with Model Water Efficient Landscape Ordinance restrictions by calculated ETAF ≤.45 or by prescriptive compliance for projects with ≤2,500 sq.ft. of landscape area. For area of project, provide submeters for spaces projected to consume >1,000gal/day (or >100gal/day in buildings >50,000 sq.ft.).				- N/A. See plumbing drawings.	NON-LEED PROJECT
	ZERO ONSITE	Environment Code sec 706(d)(7)	17758	Municipal new construction and major renovation projects which apply for building permit on or after January 1, 2020 must be all-electric.	*	nlr	n/r	- All-electric project. See mech. & elec.	Projects <10,000 square feet, receiving a waiver, or not
	OPERATIONAL EMISSIONS	Environment sous see 1 so(a)(1)		Exceptions when necessary are available for: Processes separate from building systems such as vehicle fueling, existing equipment outside project scope, or fossil fuel-based emergency backup generation. For projects ≥10,000 sq.ft., produce a whole-building energy simulation, or follow ASHRAE 50% Advanced Design Guide, or follow Advanced Building Core Performance Guide. Achieve energy use below	7	1/11/		drawings.	meeting LEED MPR's
	ENERGY PERFORMANCE	Environment Code sec.706, CA Energy Code, SFGBC 5.201	EAp2, EAc2	established baseline by 5% for New Construction, 3% for Major Renovations, 2% for Core & Shell, 3% for Commercial Interiors. Commercial Interiors alternate compliance – reduce lighting power density by 5% below ASHRAE 90.1-2010 and install ENERGY STAR equipment for 50% of all eligible ENERGY STAR equipment. In the event a project receives a waiver allowing the use of natural gas in building systems, reduce energy use at least 10% compared to Title 24 2019.	LEED EAp2	LEED EAp2	Comply with Title 24 (2019)	 See mech. and elec. for T24 compliance drawings for each discipline. See A013.1-A015.1 for envelope compliance. 	certification because it is <10,000 feet, does not meet LEED Minimum in Requirements, and/or received a wait Environment Code Chapter 7 from the of Department of Environment. An information
	ENERGY TARGET	Environment Code sec.706	EAc2	Set target for annual energy consumption. Reporting required to Municipal Green Building Task Force. See Environment Regulations for guidance, tools and methods.		n/r	nir		LEED scorecard will be submitted Municipal Green Building Task Force a
	ZERO NET ENERGY FEASIBILITY PV + ENERGY STORAGE	Environment Code sec.706	EAc2	Determine feasibility to achieve Zero Net Energy (≤3 stories). Reporting required to Municipal Green Building Task Force. See Environment Regulations for guidance, tools and methods. Analyze benefits and costs of solar plus battery storage capable of supplying electrical systems essential to serve the community in event of disaster. Reporting required to Municipal Green Building Task Force	•	n/r	n/r		concept design and as-built without required for further LEED documentation or certif
	BENEFIT/COST ANALYSIS	Environment Code sec.706	EAc2, EAc5	See Environment Regulations for guidance, tools and methods.		n/r	n/i		
	BETTER ROOFS	Planning Code sec.149, SFGBC div.5.2	EAc2 or various	New buildings with ≤10 floors must designate 15% of roof Solar Ready, per Title 24 rules. Install photovoltaics or solar hot water systems in this area. With Planning Department approval, projects subject to SFPUC Stormwater Requirements may substitute living roof for solar energy systems.	1	n/r	if new construction ≥2,000 sq,ft.	- See elec. drawings.	PROJECT MANAGER (name)
	RENEWABLE ENERGY	SFGBC 5.201.1.3 Environment Code sec.706		5 New buildings ≥11 floors must acquire renewable onsite energy or achieve 5 points under LEED credit Optimize Energy Performance (EAc2). For projects ≥10,000 sq.ft., comply with LEED Cx requirements – OPR, BOD, systems testing, operations manual, and Enhanced and Monitoring-Based Commissioning.	•	nĪr	nlr		
	COMMISSIONING (Cx)	OR CALGreen 5.410.2-5.410.4.5.1	EAp1, EAc1	For projects <10,000 sq.ft. and all new equipment in alterations & additions, comply with 5.410.2-5.410.4.5.1 – test and adjust all equipment.	LEED EAp1, LEED EAc1 (3+ pts)	LEED EAp1, LEED EAc1 (4+ pts)	5,410.2-5,410.4,5.1	- See mech. drawings.	PROJECT MANAGER (sign & date)
	BICYCLE PARKING	Planning Code sec.155.1-3, CAL Green 5.106.4	LTc6	Provide short- and long-term bike parking equal to 5% of motorized vehicle parking, or meet SF Planning Code sec.155.1-3, whichever is greater.	1 2		5.106.4	- See landscape drawings.	
	DESIGNATED PARKING	CAL Green 5.106.4 CALGreen 5.106.5.2	LTc7	If >10 total stalls added, comply with Table 5.106.5.2 (approx. 8% of total spaces).			5.100.4	- See landscape drawings.	PROJECT MANAGER AGENCY
	WIRING FOR EV CHARGING	SFGBC 5.106.5.3	LTc8	Construct all new off-street parking spaces for passenger vehicles and trucks with dimensions capable of installing EVSE (SFGBC 5.106.5.3). Install service capacity and panelboards sufficient to provide ≥40.4 208 or 240V to EV chargers at 20% of spaces. Install ≥40.4 208 or 240V branch circuits to ≥10% of spaces, terminating close to the proposed EV charger location. Installation of chargers is not required, but Admin Code 4.10-1 requires 100% of paces and leases of light duty vehicles for municipal use to be ZEV. Projects with zero off-street parking exempt. See SFGBC 5.106.5.3 for details.	new construction, or (per SFGBC) major alteration ≥25k sq ft	n/r	if new construction	- N/A, no parking provided in Phase 1.	Green Building Compliance Professional of Record
>	RECYCLING BY OCCUPANTS	Environment Code sec.707	MRp1	Permit applications prior to January 2018: Install electrical systems to provide electricity for EV chargers at 6% of spaces per CalGreen 5.106.5.3. Provide adequate space and equal access for storage, collection and leading of competable, recycloble and landfill materials.	alteration =25k 5g ft	100		See landscape drawings A120.1 A220.1	I have been retained by the project to review all submittal documents an that all approved construction documents.
VER		Environment Code	Z	Provide adequate space and equal access for storage, collection and loading of compostable, recyclable and landfill materials.	The state of the s	- Contract of		- See lanuscape drawings. A120.1, A220.1	and construction fulfill the requirement. San Francisco Green Building Code.
RECC	CONSTRUCTION & DEMOLITION (C&D) DISCARDS MANAGEMENT	sec.706, 708 & ch.14; SF Building Code ch.13B, CalGreen 5.405.1.1	MRp2/MRp MRc5/MRc	100% of mixed debris must be taken by a Registered Transporter to a Registered Facility and be processed for recycling. Divert a minimum of 75% of total C&D debris. See www.sfdbi.org for additional information.	LEED MRp2, LEED MRc5	LEED MRp2, LEED MRc6	75% diversion	- See specifications.	professional opinion that the requi of the San Francisco Green Building will be met. I will notify the Depart Building Inspection if the project will,
	REFRIGERANT MANAGEMENT	CALGreen 5.508.1	EAp4	Use no halons or CFCs in HVAC.		•	•	- See mechanical drawings.	reason, not substantially comply with requirements, if I am no longer the Building Compliance Professional of for the project, or if I am otherwise no
	LIGHT POLLUTION REDUCTION	CA Energy Code, CALGreen 5.106.8	SSc6	Comply with CA Energy Code for Lighting Zones 1-4. Comply with 5.106.8 for Backlight/Uplight/Glare.	if new construction	n/r	if new construction	- See lighting drawings.	responsible for assuring the compliand project with the San Francisco Green
BOR	BIRD-SAFE BUILDINGS	Planning Code sec.139	pilot credit	Glass facades and bird hazards facing and/or near Urban Bird Refuges may need to treat their glass for opacity.	100		1.	- See A723.1 & A724.1. Provided at all windows not concealed by shading device.	Code.
EIGH	TOBACCO SMOKE CONTROL	Health Code art.19F & art.19I, CALGreen 5.504.7	EQp2	Prohibit smoking within 25 feet of building entries, air intakes, and operable windows.	1			See mechanical drawings for intake locations. Smoking is prohibited in the park	See titleblock.
Z	SHADE TREES	CALGreen 5.106.12	SSc5	Plant trees to sufficient to provide shade within 15 years for 20% of landscape and hardscape area, including parking. Exclude shade structures covered by photovoltaics or cool roof materials from total area calculation.		nlr	n/r		LICENSED PROFESSIONAL (sign & date)
NOLN	STORMWATER CONTROL PLAN	Public Works Code art 4.2 sec 147	SSc4	Projects disturbing ≥5,000 sq.ft. in combined or separate sewer areas, or replacing ≥2,500 impervious sq.ft. in separate sewer area, must implement a Stormwater Control Plan meeting SFPUC Stormwater Management Requirements.	if applicable	if applicable	if applicable	- See civil drawings.	AFFIX STAMP BELOW:
PREVE	CONSTRUCTION SITE RUNOFF	Public Works Code art 4.2 sec.146	SSp1	Submit a construction site Erosion and Sedimentation Control Plan to SFPUC for approval.	if project disturbs ≥5,000 sq.ft.	if project disturbs ≥5,000 sq.ft.	if project disturbs ≥5,000 sq.ft.	- See civil drawings.	See titleblock.
	ACOUSTICAL CONTROL	CALGreen 5.507.4.1-3	EQc9	Comply with sound transmission limits (STC-50 exteriors near freeways/airports; STC-45 exteriors if 65db Leq at any time; STC-40 interior walls/floor-ceilings between tenants).	17.4	limited to envelope alterations & additions	•	N/A	
¥.	AIR FILTRATION - CONSTRUCTION	CALGreen 5.504.1-3	I LACOR	Seal permanent HVAC ducts/equipment stored onsite before installation.		• anerations & additions	•	- See mechanical drawings.	
YEL Y	AIR FILTRATION - OPERATIONS	CALGreen 5.504.5.3		Provide MERV-13 filters on HVAC for regularly occupied, actively ventilated spaces.				- See mechanical drawings.	
BON DUAL	ENHANCED IAQ STRATEGIES	Environment Code sec.706	EQc1	Comply with entry, cross-contamination, filtration, natural ventilation, mixed-mode requirements.	LEED EQc1 (1 pt)	LEED EQc1 (1 pt)	n/r		
ENA	CONSTRUCTION IAQ MANAGEMENT PLAN	Environment Code sec.706	EQc3	During construction, meet SMACNA IAQ guidelines; provide MERV-13 filters on all HVAC.	LEED EQc3	LEED EQc3	n/r		
Ш			- A.S. A.	Before occupancy, test air quality for particulates, ozone, CO, and all listed VOCs.	The second section is a	the second production of			

900 INNES PARK DEVELOPMENT

CITY AND COUNTY OF SAN FRANCISCO RECREATION AND PARKS DEPARTMENT 30 VAN NESS AVENUE SAN FRANCISCO, CA 94102



PH. 415-831-2700 THE TRUST FOR PUBLIC LAND 101 MONTGOMERY STREET SUITE 900 SAN FRANCISCO, CA 94104 PH. 415-495-4014



PRIME CONSULTANT / LANDSCAPE ARCHITECT GUSTAFSON GUTHRIE NICHOL PH. 206-903-6802 CIVIL ENGINEER SHERWOOD DESIGN ENGINEERS PH. 415-348-9650 JENSEN ARCHITECTS PH. 415-348-9650 ECOLOGICAL RESTORATION RANA CREEK PH. 831-659-3820 STRUCTURAL ENGINEER JON BRODY STRUCTURAL ENGINEERS PH. 415-296-9494 COASTAL ENGINEER MOFFATT AND NICHOL PH. 925-944-5411 LIGHTING NITEO CALIFORNIA PH. 415-666-2232 INTERFACE ENGINEERING PH. 415-489-7240 GEOTECHNICAL ENGINEER AGS, INC PH. 415-957-9240 SECURITY CONSULTANT ZBETA CONSULTING PH. 415-259-0422

FOR OFFICIAL USE

KEY PLAN



RE	VISIONS:	
NO.	DATE	DESCRIPTION
01	12/18/2020	PERMIT SUBMITTAL
ISSUA	ANCE	

BID SET

7/01/2021

GREEN BLDG. SUBMITTAL FORM GS6

		ncisco,CA, 94124				الا	ate Prepare	Mi		2020-12	
GENERAL INFO	RMATION										
1 Project Location	14.3/4.10.44.11		San Francisco		05	# of Stories (H	labitable Al	oove Grade)		1	
2 Zipcode			94124			Total Conditio	2 10 2 0 11 11	A STATE OF THE STA		745	
3 Climate Zone		7	3	*		Total Uncondi				2,764	
If one occupar	pes Within Project (se ncy constitutes ≥ 80% ope may be designed • \$100.0(f).	of the conditione	d floor area, t		08		cludes unco		d space(s) >	-5,000ft² under a roof w	th
All Nonresident certified for use Occupancy: A / OOTNOTE: Enclo	ial, including Relocata in one climate zone B / E / F / H / M / S / sed spaces > 5,000 ft	U ² directly under ro	of with ceiling	use in all clim Occupancy: E height > 15ft in	ate zo	ite zones 2 thro	ough 15 ar		the minimu	Hotel/Motel Guest Rook Occupancy: R-1 Im daylighting requireme	
fined in <u>§140.3(c</u> ,	. Compliance with §	<u>140.3(c)</u> is docume	ented in Table	L. This is the on	ly pres	scriptive requir	rement whi	ch applies to uncor	iditioned sp	paces.	
PROJECT SCOP	E										7
					appli	cation and are	e demonstr	ating compliance u	sing the pre	escriptive paths outlined	n
40.3, and §141.0	a)1 and §141.0(b)1 a			ns.		T					
	My project co	nsists of (check all	I that apply)					Compone	0.00		
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This document is used to demonstrate compliance with mandatory requirements in $\underline{5110.8(g)}$ and $\underline{5120.7(b)}$ for newly constructed buildings, and $\underline{5141.0(b)1}$ for alterations,

related to roof, wall and floor assemblies. It is also used to demonstrate compliance with prescriptive requirements in §140.3 for newly constructed buildings, and §141.0 for

CALIFORNIA ENERGY COMMISSION

NRCC-ENV-E

STATE OF CALIFORNIA

NRCC-ENV-E (Created 11/19)

CERTIFICATE OF COMPLIANCE

Envelope Component Approach

Envelope Co NRCC-ENV-E (Created	mponent Appi	oach							CALIFORNIA	ENERGY COMM	MISSION (
CERTIFICATE OF C	THE STREET STREET										NRCC-ENV-
	900 Innes Avenue Pa	A TOTAL CONTRACTOR OF THE PARTY					eport Page:				Page 3 of 1
Project Address:	900 Innes Ave, San F	rancisco,CA, 9412	24			D	ate Prepared:				2020-12-1
Table Continued								Reset	Add	Pow P	Remove Last
07	08	09	10		11	12	13	14	15		16
Tag / Plan Detail ID	How Design U-facto was determined	Roof Type & Frame Material	Frame Spacin	ng & Depth	Cavity Insulation per Design	Continuous Insulation per Design	Thermal Performance Unit	Required Thermal Performance ²	U-factor pe	er Design	Net Area ³ (ft²)
R3 Food Pavilion	Approved Software	Rafter-Metal	2X10 at 1	16 O.C	R- 30	R- 23	U-factor	0.034	per JA per Software Othe	0.028	
with other roof ty If "R-value" is so Roof area minus	any individual assem upes. The area-weigh hown in cell 13 as the s any fenestration/sk	ted compliance o Thermal Perform	ption is not avai	ilable for alt	terations den	nonstrating c	ompliance wit	th R-values in <u>T</u>		may not be	combined
Metal Building Ro	oof Assemblies	□ ICa	Iculate Area-We	eighted Ave	erage U-facto	r for Metal B	uilding Roof ¹				
02		03	04	cigited Ave	ruge o rueto	i ioi ivictui b	05				06
Tag / Plan Det	ail ID Name /	Description	Status	Excepti	on to Roof In	sulation Req	uirements in	141.0(b)2Biii (Alts. Only)	Occupa	ncy Type
Maintenance	Roof Mainten	ance Bld roof	New •							Nonresio Relocata	
								Reset	Add	Row F	Remove Last
07	08		09		10	11	12	13	14		15
Tag / Plan Detail ID	How Design U-facto was determined	Insu	lation System	ı	Cavity nsulation per Design	Continuous Insulation per Design	Thermal Performance Unit	Required Thermal Performance ²	U-factor pe	er Design	Net Area ³ (ft²)
Maintenance Roc	Approved Software		Rockwool		R- 30	R- 10	U-factor	0.041	per JA per Software Othe	0.04	
TATE OF CALIFORNIA	Efficiency Standards - 2	1	Compliance: http	o://www.ene	ergy.ca.gov/titl	e24/2019stan	dards			N	lovember 2019
NRCC-ENV-E (Created	11/19)	24-03-							CALIFORNI	A ENERGY COM	
TANK THE RESERVE THE THE PARTY OF THE	900 Innes Avenue F	ark Phase I					Report Page:				NRCC-EN\ Page 4 of
	900 Innes Ave, San	- Marine Marine	24				Date Prepared	d:			2020-12-
07	08		09		10	111	12	13	1 1	4	15
Tag / Plan Detail ID	How Design U-facto was determined	r Inst	ulation System		Cavity Insulation pe Design	Continuou	s Thermal Performanc	Required te Thermal Performance	U-factor p	oer Design	Net Area (ft²)
with other roof t If "R-value" is s Roof area minu	any individual assen ypes. The area-weig hown in cell 12 as th s any fenestration/si	hted compliance of e Thermal Perform cylight area.	option is not ava	ailable for a	lterations de	monstrating	compliance w	ith R-values in	Table 141.0-C.		e combined
	FING MATERIAL (C s: Complete this tab		compliance wit	th prescript	ive roof mate	erial requires	nents in 6140	3(a)14 for naw	construction	or additions	or 6141 0/h
for alterations.	s. complete this tub	e to demonstrate	compliance wit	т ргезспри	rve rooj male	. iui i equileli	тента ні <u>у140.</u>	Jujin Joi new	construction C	additions,	OI 3141,U[U]
01	02		03	0	4	0.	5	00	6		07
Tag / Plan Detail ID	Name / Descripti	on / Location	Status	D-10, 10, 100	псу Туре	Roof	Slope	Roof M	24.00	10000	nce Method
R3 Food Pavilion	ParoPro liqui	d Roofing	New -	Nonresid Relocatab	ential/	≤ 2:12 (I	Low)	Fluid-Applied	Membrane 🕶	Solar Reflec	ctance Index RI)

Nonresidential/ Relocatable 1 CZ

≤ 2:12 (Low)

08

Required Minimum

Material Performance

Reflectance

Emittance

Reflectance

Emittance

¹FOOTNOTE: If Solar Reflectance (Initial) is indicated in column 07, enter the Initial Reflectance here and the form will convert it to a "Calculated Aged Solar Reflectance" when

Paint Coating

CA Building Energy Efficiency Standards - 2019 Nonresidential Compliance: http://www.energy.ca.gov/title24/2019standards

determining compliance.

H. WALL ASSEMBLY SCHEDULE

900 INNES PARK DEVELOPMENT

CITY AND COUNTY OF SAN FRANCISCO RECREATION AND PARKS DEPARTMENT 30 VAN NESS AVENUE SAN FRANCISCO, CA 94102

PH. 415-495-4014

PH. 415-831-2700





PRIME CONSULTANT / LANDSCAPE ARCHITECT GUSTAFSON GUTHRIE NICHOL PH. 206-903-6802 CIVIL ENGINEER SHERWOOD DESIGN ENGINEERS PH. 415-348-9650 ARCHITECT JENSEN ARCHITECTS PH. 415-348-9650 ECOLOGICAL RESTORATION RANA CREEK PH. 831-659-3820 STRUCTURAL ENGINEER JON BRODY STRUCTURAL ENGINEERS PH. 415-296-9494 COASTAL ENGINEER MOFFATT AND NICHOL PH. 925-944-5411 LIGHTING NITEO CALIFORNIA PH. 415-666-2232 MEP & IT INTERFACE ENGINEERING PH. 415-489-7240 GEOTECHNICAL ENGINEER AGS, INC PH. 415-957-9240 SECURITY CONSULTANT ZBETA CONSULTING PH. 415-259-0422

FOR OFFICIAL USE

NRCC-ENV-E Page 4 of 1 2020-12-16

Solar Reflectance Index

10

U-factor of Assembly

November 2019

Reset Add Row Remove Last

(SRI)

09

Designed Material

Performance

Reflectance¹

Emittance

Reflectance¹

KEY PLAN



<u>NO.</u>	DATE	DESCRIPTION
01	12/18/2020	PERMIT SUBMITTAL

7/01/2021 TITLE 24 CERTIFICATE OF

BID SET

JENSEN

DRAWN BY

DATE

COMPLIANCE

CHECKED BY

GGN PROJECT #

STATE OF CALIFORNIA **Envelope Component Approach** NRCC-ENV-E (Created 11/19) CALIFORNIA ENERGY COMMISSION CERTIFICATE OF COMPLIANCE NRCC-ENV-E Project Name: 900 Innes Avenue Park Phase I Report Page: Page 7 of 10 Project Address: 900 Innes Ave, San Francisco, CA, 94124 2020-12-16 Date Prepared:

K. FENESTRATION AND GLAZED DOOR SCHEDULE

CALIFORNIA ENERGY COMMISSION

Report Page:

Table Instructions: Complete this table to demonstrate compliance with prescriptive wall assembly requirements in §140.3(a)2 and §140.3(a)3 for new construction or additions,

Date Prepared:

NRCC-ENV-E

Page 5 of 1

2020-12-16

Table Instructions: Complete this table to demonstrate compliance with prescriptive fenestration requirements in §140.3(a)5 for new construction or additions, or §141.0(b)2A for alterations. Exterior doors that are more than one-half glass in area are considered Glazed Doors and should be documented on this table with fenestration.

01 Indicate fenestration types included in the project: Vertical (alteration) Vertical (new) Skylights Glazed Doors (new only) FOOTNOTE: Fenestration types indicated above as "(new only)" do not have Title 24, Part 6 requirements for alterations. New construction and additions do have requirements and should be clicked above and compliance demonstrated within this table.

	01	02		0	3	04	05
Elevation Ite	em Tag/ Description	Orientation (Azim	uth)¹	Gross Exterio	Contract of the contract of	Display Perimeter Length ² (ft)	Vertical Fenestration Area per Design ³ (ft ²)
Food Pa	avilion -Kitchen	West	•	47	72	0	65
Foo	od Pavilion	East	-	47	72	0	24
Foo	od Pavilion	South	•	79	90	0	20
Mainte	enance -Office	East	•	9	8	0	22.5
Mainter	ance-Break Rm	South	-	43	30	0	117
	-			Re	set	Add Elevation	Remove Last
06	Maximum Allowed Fenestration (ft²)- A		904.	8	07	Total Vertical Fenestration (ft²) per Design- All Orientations	248.5
08	Maximum Allowed Fenestration (ft²)-W		188.	8	09	Total Vertical Fenestration (ft ²)	65

¹ FOOTNOTE: Orientation between 226 deg and 315 deg are considered "West Facing". A diagram has been provided in the Nonresidential Compliance Manual for visual

² Do not include demising walls per §140.3(a)5.

³ Includes glazed door fenestration area.

Vertical Fenes	tical Fenestration- U-factor, Solar Heat Gain Coefficient (RSHGC/SHGC), Visible Transmittance (VT)	
01		Calculate Area-Weighted Average U-factor for Vertical Fenestration ¹
02		Calculate Area-Weighted Average SHGC for Vertical Fenestration ¹
03		Calculate Area-Weighted Average VT for Vertical Fenestration ¹

Table Continued

CA Building Energy Efficiency Standards - 2019 Nonresidential Compliance: http://www.energy.ca.gov/title24/2019standards

STATE OF CALIFORNIA Envelope Component Approach		
NRCC-ENV-E (Created 11/19)	CA	LIFORNIA ENERGY COMMISSION
CERTIFICATE OF COMPLIANCE	7 < 5	NRCC-ENV-E
Project Name: 900 Innes Avenue Park Phase I	Report Page:	Page 8 of 10
Project Address: 900 Innes Ave, San Francisco, CA, 94124	Date Prepared:	2020-12-16

04	05	06	07	08		09	10	11	12	13
Tag/Plan Detail ID	Fenestration Type	Occupancy & Status	(R)SHGC Compliance Method	VT Compliance Method		alculation Method for rformance Values per Design ²	Product Performance Unit	Required Product Performance	Product Performance per Design	Area (ft²)
		Nonresidential/		- 11 1100		NFRC Certified	U-factor (max)	0.36	0.29	
Kitchen	Fixed Window 🔻	Relocatable 1 CZ:	Table 140.3-B/C/D	Table 140.3- B/C/D		Overhang used for	(R)SHGC(max)	0.25	0.17	67
		New		D/C/D -	IV	RSHGC	VT(min)	0.42	0.65	
	O see blo	Nonresidential/		T-11- 110 7		NFRC Certified	U-factor (max)	0.46	0.35	
Kitchen	Operable Window	Relocatable 1 CZ:	Table 140.3-B/C/D	Table 140.3- B/C/D	V	Overhang used for	(R)SHGC(max)	0.22	0.15	42
	Willdow	New		B/C/D -	Į.v	RSHGC	VT(min)	0.32	65	
	Lance and Table	Nonresidential/	I party of the second	T 11 110 2		NFRC Certified	U-factor (max)	0.36	0.29	
Main Bld	Fixed Window 🕶	Relocatable 1 CZ:	Table 140.3-B/C/D	Table 140.3- B/C/D		Overhang used for	(R)SHGC(max)	0.25	0.25	117
		New	11.00	5/0/5		RSHGC	VT(min)	0.42	0.48	
	Ourselle	Nonresidential/	107.000	T-11- 140 2		NFRC Certified -	U-factor (max)	0.46	0.29	
Main Bld	Operable Window	Relocatable 1 CZ:	Table 140.3-B/C/D	Table 140.3- B/C/D		Overhang used for	(R)SHGC(max)	0.22	0.21	22.5
	Willdow	New		5/5/5		RSHGC	VT(min)	0.32	0.34	

	Overhang Details for RSHGC per §140.3									
	26 27 28 29 30 31 32									
	SHGC of Window	Depth (ft)	Height from Bottom of Sill to Overhang (ft)	Left Extent ³ (ft)	Right Extent ³ (ft)	Orientation	RSHGC			
	0.27	4	7	3.5	4	East/West-facing	0.169425			
Kitchen	0.27	4	7	3.5	4	South-facing	0.14985			
						Poset	Add Daw			

¹ FOOTNOTE: If any individual fenestration product is non-compliant, products may show compliance using an area-weighted calculation. Chromogenic glazing is not included in area-weighted calculations. Area-weighted calculations shown in separate area-weighted table below.

² The NA6 Default Calculation can only be used for buildings with less than 200 ft² of site built glazing. If the project has greater than 200 ft², the only options for determining fenestration values are NFRC Certification or the Default Tables in §110.6. ³ Overhangs must extend past the left and right window the same distance as the depth of the overhang or greater to show an affect on the RSHGC. If an overhang does not

meet this requirement, the affect of the overhang will be ignored.

⁴ Projecting includes casement and awning windows.

DATE

November 2019

900 INNES PARK DEVELOPMENT

CITY AND COUNTY OF SAN FRANCISCO RECREATION AND PARKS DEPARTMENT 30 VAN NESS AVENUE SAN FRANCISCO, CA 94102

PH. 415-831-2700 THE TRUST FOR PUBLIC LAND

101 MONTGOMERY STREET

SAN FRANCISCO, CA 94104

SUITE 900

PH. 415-495-4014



PRIME CONSULTANT / LANDSCAPE ARCHITECT GUSTAFSON GUTHRIE NICHOL PH. 206-903-6802 CIVIL ENGINEER SHERWOOD DESIGN ENGINEERS PH. 415-348-9650 ARCHITECT JENSEN ARCHITECTS PH. 415-348-9650 ECOLOGICAL RESTORATION RANA CREEK PH. 831-659-3820 STRUCTURAL ENGINEER JON BRODY STRUCTURAL ENGINEERS PH. 415-296-9494 COASTAL ENGINEER MOFFATT AND NICHOL PH. 925-944-5411 LIGHTING NITEO CALIFORNIA PH. 415-666-2232 MEP & IT INTERFACE ENGINEERING PH. 415-489-7240 GEOTECHNICAL ENGINEER AGS, INC PH. 415-957-9240 SECURITY CONSULTANT ZBETA CONSULTING

FOR OFFICIAL USE

PH. 415-259-0422

KEY PLAN



RE	VISIONS:	
NO.	DATE	DESCRIPTION
01	12/18/2020	PERMIT SUBMITTAL
ISSU	ANCE	
		BID SET
DRAV	VN BY	CHECKED BY

TITLE 24 CERTIFICATE OF COMPLIANCE

JENSEN

7/01/2021

GGN PROJECT #

STATE OF CALIFORNIA

NRCC-ENV-E (Created 11/19)

CERTIFICATE OF COMPLIANCE

Envelope Component Approach

Project Name: 900 Innes Avenue Park Phase I

Project Address: 900 Innes Ave, San Francisco, CA, 94124

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roject Nan		nnes Avenue Park Phase I	Report Page:		Page 9 of 1
	30747-8	nnes Ave, San Francisco,CA, 94124	Date Prepared:		2020-12-1
. DAYLIGI	IT IN LAR	GE ENCLOSED SPACES			
his Section	Does Not	Apply			
M. DECLA	RATION O	REQUIRED CERTIFICATES OF INSTALLATION			6
n explanat ttp://www	ion to be a venergy.ca				ine at
YES	NO		Form/Title	Pass	Fail
•	0	NRCI-ENV-01-E - Must be submitted for all buildings.			
N. DECLAR	ATION OF	REQUIRED CERTIFICATES OF ACCEPTANCE			
Tabla Insta	ion to be a	dded to Table D Exceptional Conditions. These documents gov/2015publications/CEC-400-2015-033/appendices/for	previous tables of this document. If any selection needs to be changed, for must be provided to the building inspector during construction and can be ms/NRCA/. Individuals who perform the field testing and verification works documentation are not required to be licensed professionals. However, to purpose the licensed as specified in Standards Section 10, 103(a).	pe found onli k, and provid the person w	ine at de the tho signs th
n explanat http://www nformation	required for	ce document to certify compliance with the acceptance re	quirements shall be licensed as specified in Standards Section <u>10-105[a]4</u>		
n explanat http://www nformation ertificate o	required for of Acceptan	마이트 마이트 아니는 아니는 아이를 가지고 하래하는 것이다면 되었습니다. 아이는 이 특성 모든 이번에 가득하고 아이를 다 아이를 다 아니다.		Field In	spector
n explanat ttp://www formation	required for	마이트 마이트 아니는 아니는 아이를 가지고 하래하는 것이다면 되었습니다. 아이는 이 특성 모든 이번에 가득하고 아이를 다 아이를 다 아니다.	Form/Title	Field In	spector Fail
n explanat ttp://www nformation ertificate o	required for of Acceptan	마이트 마이트 아니는 아니는 아이를 가지고 하래하는 어린 아이를 되었습니다. 아이는 이 특성 사람이에서, 친탁 아이를 하다 아이를 다 아이를 다 다 했다.	Form/Title		

CA Building Energy Efficiency Standards - 2019 Nonresidential Compliance: http://www.energy.ca.gov/title24/2019standards

STATE OF CALIFORNIA **Envelope Component Approach** CALIFORNIA ENERGY COMMISSION NRCC-ENV-E (Created 11/19) CERTIFICATE OF COMPLIANCE NRCC-ENV-E Project Name: 900 Innes Avenue Park Phase I Report Page: Page 10 of 10 Project Address: 900 Innes Ave, San Francisco, CA, 94124 Date Prepared: 2020-12-16

1. I certify that this Certificate of	Compliance documentation is accurate and	complete.		
Documentation Author Name:	Inna Dolottseva	Documentation Author Sign	ature: Inna Dolottseva	Digitally signed by Inna Dolottseva Date: 2020.12.16.11:55:49-08'00'
Company:	Interface Engineering	Signature Date:	2020-12-1	6
Address:	135 Main St, suite 400	CEA/ HERS Certification Iden	tification (if applicable):	
City/State/Zip:	San Francisco, CA, 94105	Phone:	415.489.3242	

I certify the following under penalty of perjury, under the laws of the State of California:

1. The information provided on this Certificate of Compliance is true and correct.

2. I am eligible under Division 3 of the Business and Professions Code to accept responsibility for the building design or system design identified on this Certificate of Compliance (responsible designer) 3. The energy features and performance specifications, materials, components, and manufactured devices for the building design or system design identified on this

Certificate of Compliance conform to the requirements of Title 24, Part 1 and Part 6 of the California Code of Regulations. 4. The building design features or system design features identified on this Certificate of Compliance are consistent with the information provided on other applicable

compliance documents, worksheets, calculations, plans and specifications submitted to the enforcement agency for approval with this building permit application. . I will ensure that a completed signed copy of this Certificate of Compliance shall be made available with the building permit(s) issued for the building, and made available to the enforcement agency for all applicable inspections. I understand that a completed signed copy of this Certificate of Compliance is required to be included with the documentation the builder provides to the building owner at occupancy.

Responsible Designer Name:	Emily Gosack	Responsible Designer Sig	nature: Emily Gosack	Digitally signed by Emily Gosack Date: 2020.12.16 14:29:50 -08 00
Company:	Jensen Architects	Date Signed:	December 18	3, 2020
Address:	833 Market St. Floor 7	License:	C 33435	
City/State/Zip: San Francisco, CA 94103		Phone: 415-348-9650 x 41		(41

900 INNES PARK DEVELOPMENT

CITY AND COUNTY OF SAN FRANCISCO RECREATION AND PARKS DEPARTMENT 30 VAN NESS AVENUE SAN FRANCISCO, CA 94102 PH. 415-831-2700


THE TRUST FOR PUBLIC LAND 101 MONTGOMERY STREET SUITE 900 SAN FRANCISCO, CA 94104 PH. 415-495-4014

PRIME CONSULTANT / LANDSCAPE ARCHITECT GUSTAFSON GUTHRIE NICHOL PH. 206-903-6802 CIVIL ENGINEER SHERWOOD DESIGN ENGINEERS PH. 415-348-9650 ARCHITECT JENSEN ARCHITECTS PH. 415-348-9650 ECOLOGICAL RESTORATION RANA CREEK PH. 831-659-3820 STRUCTURAL ENGINEER JON BRODY STRUCTURAL ENGINEERS PH. 415-296-9494 COASTAL ENGINEER MOFFATT AND NICHOL PH. 925-944-5411 LIGHTING NITEO CALIFORNIA PH. 415-666-2232 MEP & IT INTERFACE ENGINEERING PH. 415-489-7240 GEOTECHNICAL ENGINEER AGS, INC PH. 415-957-9240 SECURITY CONSULTANT ZBETA CONSULTING

FOR OFFICIAL USE

PH. 415-259-0422

KEY PLAN

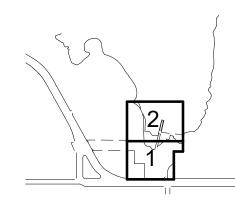




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	JEN	SEN	
DATE			GGN PROJECT #
	7/01/	2021	1608


TITLE 24 CERTIFICATE OF COMPLIANCE

NOTE: FOR OTHER PLAN CLEARANCE DIM. SEE RELEVANT ENLARGED PLANS

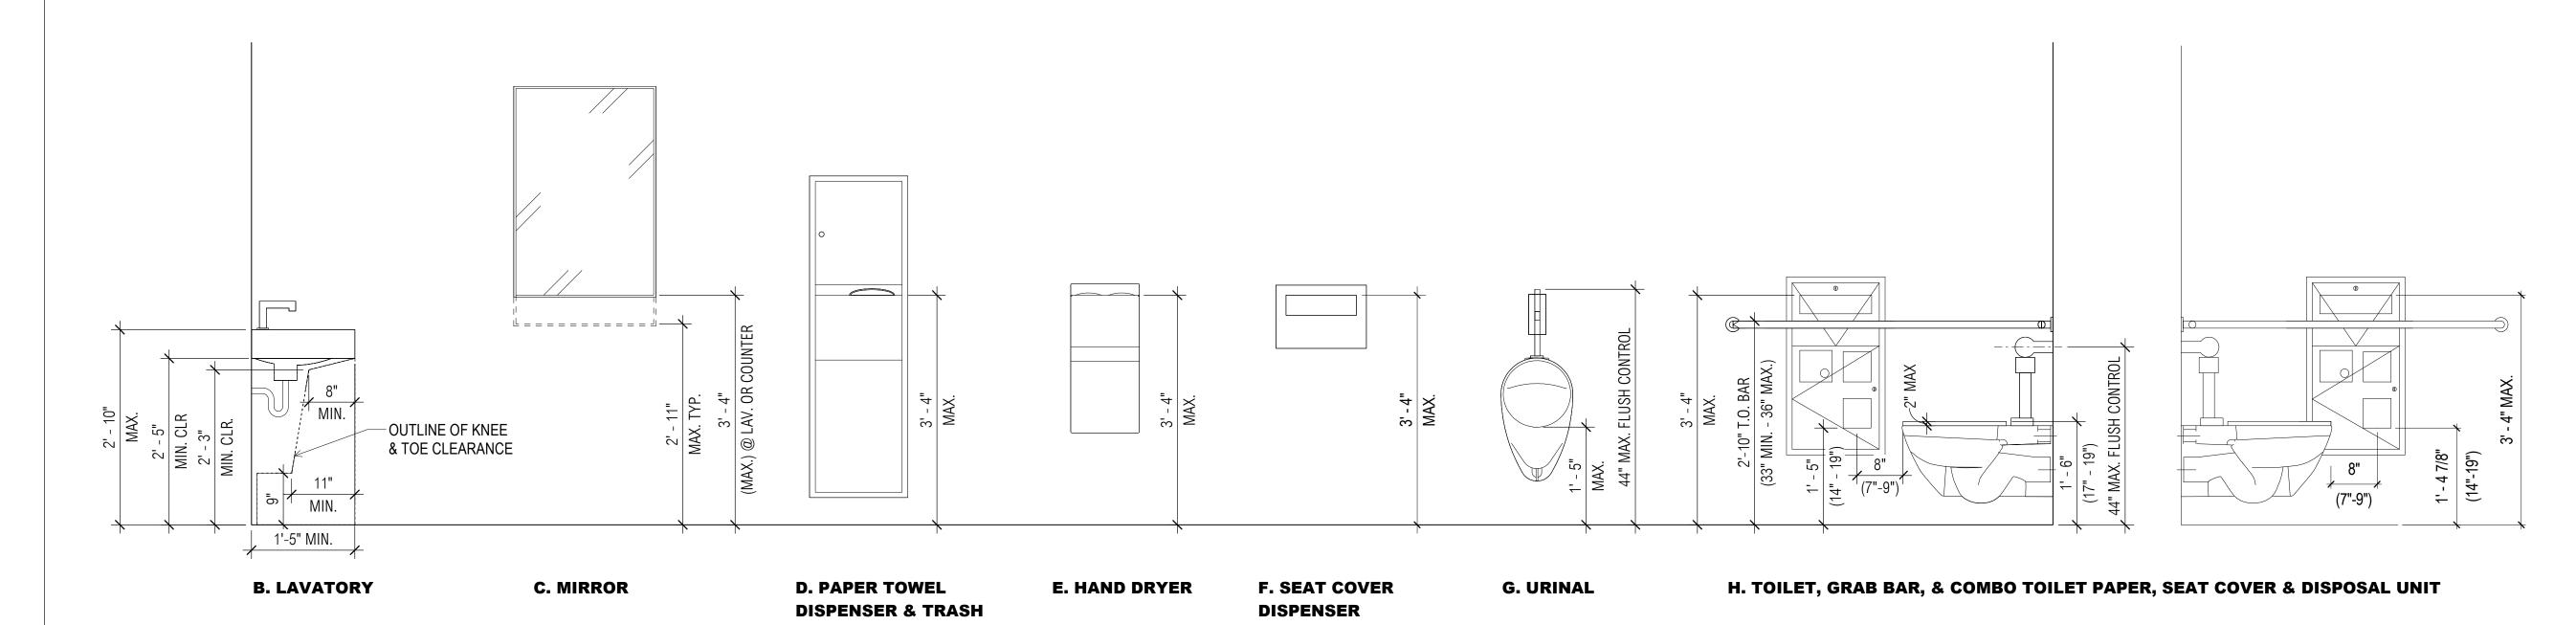

TYP. ACCESSIBLE RESTROOM COMPONENT HEIGHTS

3/4" = 1'-0"

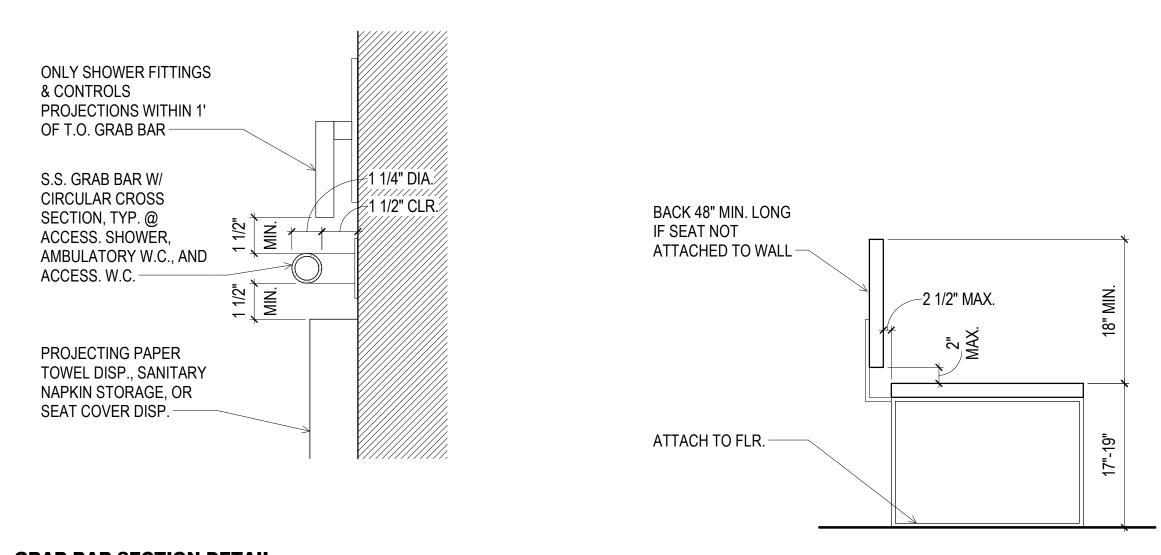

GRAB BAR SECTION DETAIL





900 INNES PARK DEVELOPMENT

CITY AND COUNTY OF SAN FRANCISCO RECREATION AND PARKS DEPARTMENT 30 VAN NESS AVENUE SAN FRANCISCO, CA 94102



THE TRUST FOR PUBLIC LAND 101 MONTGOMERY STREET SUITE 900 SAN FRANCISCO, CA 94104

PH. 415-495-4014



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ZBETA CONSULTING

KEY PLAN




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REVIS	IONS:	
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ISSUANCE	BID	SET
DRAWN BY	JENSEN	CHECKED BY
DATE	7/01/2021	GGN PROJECT #

ACCESSIBILITY DETAILS -

A021.1

1608

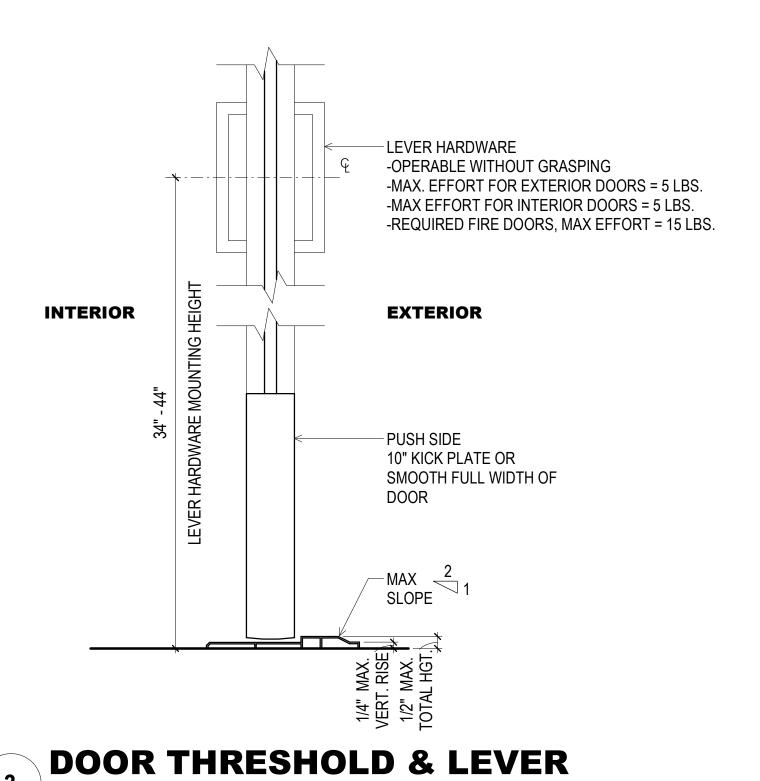


NOTES:

1. INTERIOR STAIRS TO BE MARKED BY A STRIP OF CONTRASTING COLOR 2"-4" WIDE PLACED PARALLEL TO AND NOT MORE THAN 1" FROM NOSE OF STEP ON BOTTOM TREAD AND LANDING AT TOP OF STAIR.

2. STAIRWAYS MUST HAVE HANDRAILS EACH SIDE. STAIRWAYS REQUIRED TO BE MORE THAN 88" WIDE TO HAVE INTERMEDIATE HANDRAIL FOR EACH 88" OF WIDTH (SPACED EQUALLY). PROVIDE SECOND SET OF HANDRAILS 24" ABOVE NOSING OF TREAD WHEN CHILDREN ARE PRIMARY USERS.

3. UNDERSIDE OF NOSING SHALL NOT BE ABRUPT. THE RADIUS OF CURVATURE AT LEADING EDGE OF TREAD SHALL BE NO GREATER THAN 1/2". RISERS SHALL BE SLOPED OR UNDERSIDE OF NOSING SHALL HAVE ANGLE NOT LESS THAN 60 DEGREES FROM HORIZONTAL. NOSING SHALL PROJECT NO MORE THAN 1 1/4" FROM TREAD BELOW.

4. HANDRAILS TO HAVE MINIMUM STRUCTURAL STRENGTH TO SUPPORT 250 LBS.

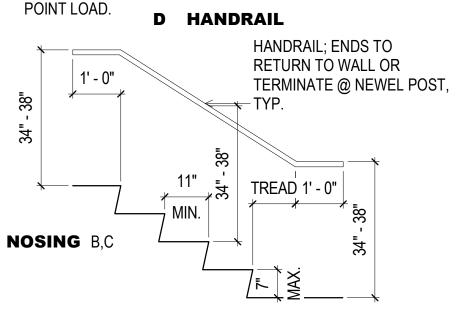


1 1/2" MIN. 1 1/4" - 1 1/2" DIA. H.R. — PROVIDE BLOCKING CAPABLE OF RESISTING CODE-STATED LOADS — D. HANDRAIL **DETAIL** 1 1/4" MAX. C. FLUSH RISER 1 1/4" MAX. **B. ANGLED, ROUNDED** NOSING

A. STAIR SECTION


TYPICAL STAIR & HANDRAIL DETAILS

1/2" = 1'-0"

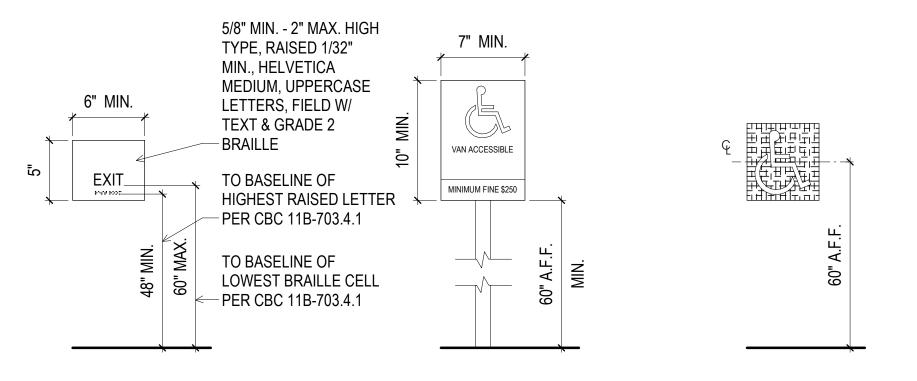


NOTES:

1. RAISED LETTERS AND NUMBERS ON SIGNS SHALL BE 1/32" MIN. ABOVE THEIR BACKGROUND, IN UPPERCASE AND STANDARD SANS SERIF FONT. CHARACTERS SHALL BE SELECTED FROM FONTS WHERE WIDTH OF THE UPPERCASE LETTER "O" IS 60% MIN. AND 110% MAX. OF HEIGHT OF UPPERCASE "T." CHARACTER HEIGHT SHALL BE MEASURED FROM BASELINE OF CHARACTER TO BE 5/8" MIN. AND 2" MAX. BASED ON HEIGHT OF UPPERCASE LETTER "I." CHARACTER STROKE THICKNESS OF UPPERCASE LETTER "I" SHALL BE 15% MAX. OF HEIGHT OF THE CHARACTER. REFERENCE CBC 11B-703.2 FOR COMPLETE RAISED CHARACTER INFORMATION

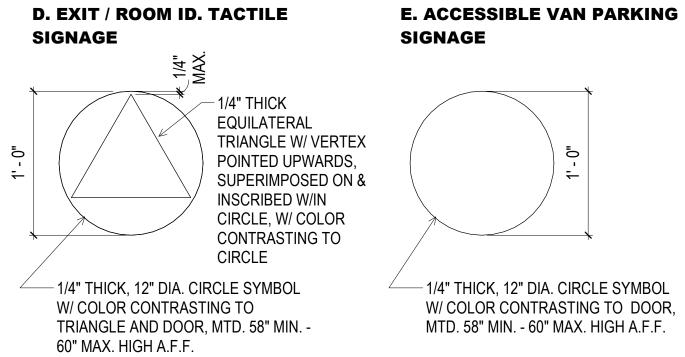


ALL GENDER

- 1/4" THICK, 12" DIA. CIRCLE SYMBOL W/ COLOR CONTRASTING TO DOOR, MTD. 58" MIN. - 60" MAX. HIGH A.F.F.

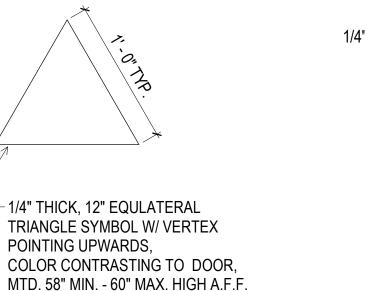

F. ACCESSIBLE

ENTRY SIGN

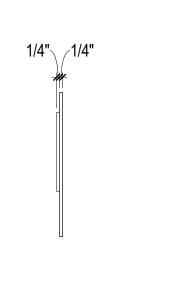

FIELD WITH SYMBOLS 5/8" MIN. - 2" MAX. HIGH TYPE, RAISED 1/32" MIN., HELVETICA MEDIUM, UPPERCASE LETTERS, FIELD W/ TEXT & -GRADE 2 BRAILLE UNISEX TO BASELINE OF HIGHEST RAISED LETTER PER CBC 11B-703.4.1 TO BASELINE OF LOWEST BRAILLE CELL — PER CBC 11B-703.4.1

WOMEN'S MEN'S A. RESTROOM DOOR SIGNAGE

B. RESTROOM DOOR SIGNAGE - SIDE VIEW C. RESTROOM TACTILE SIGN

SIGNAGE DETAILS & MOUNTING HEIGHTS 1 1/2" = 1'-0"

2/ No. C21410 **REVISIONS:** NO. DATE DESCRIPTION PERMIT SUBMITTAL 01 12/18/2020

BID SET

ACCESSIBILITY DETAILS -

JENSEN

7/01/2021

CHECKED BY

GGN PROJECT #

1608

900 INNES

PARK DEVELOPMENT

CITY AND COUNTY OF SAN FRANCISCO RECREATION AND PARKS DEPARTMENT

30 VAN NESS AVENUE SAN FRANCISCO, CA 94102

THE TRUST FOR PUBLIC LAND

101 MONTGOMERY STREET

SAN FRANCISCO, CA 94104

GUSTAFSON GUTHRIE NICHOL

SHERWOOD DESIGN ENGINEERS

PRIME CONSULTANT / LANDSCAPE ARCHITECT

PH. 415-831-2700

PH. 415-495-4014

PH. 206-903-6802

CIVIL ENGINEER

PH. 415-348-9650

PH. 415-348-9650

PH. 831-659-3820

PH. 415-296-9494

PH. 925-944-5411

NITEO CALIFORNIA

INTERFACE ENGINEERING

GEOTECHNICAL ENGINEER

SECURITY CONSULTANT

ZBETA CONSULTING PH. 415-259-0422

PH. 415-666-2232

PH. 415-489-7240

PH. 415-957-9240

FOR OFFICIAL USE

KEY PLAN

ISSUANCE

DRAWN BY

DATE

LIGHTING

MEP & IT

AGS, INC

COASTAL ENGINEER MOFFATT AND NICHOL

RANA CREEK

JENSEN ARCHITECTS

ECOLOGICAL RESTORATION


STRUCTURAL ENGINEER

JON BRODY STRUCTURAL ENGINEERS


ARCHITECT


SUITE 900

3" = 1'-0"

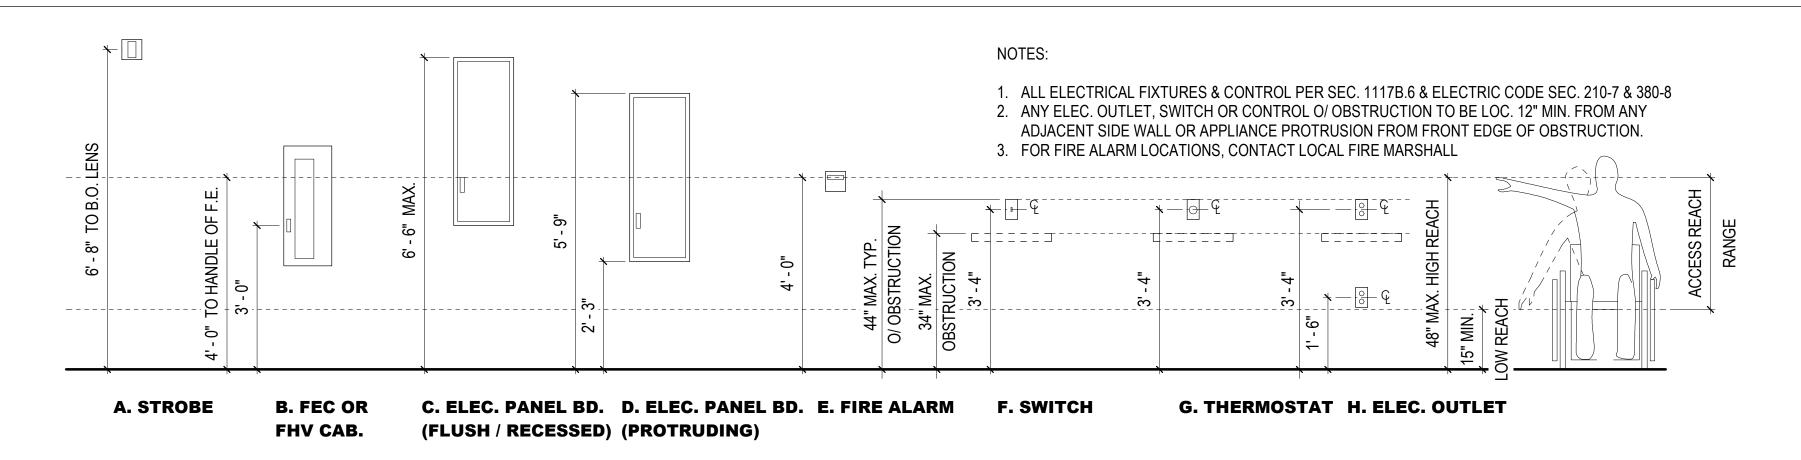


TYP. CONTROL, ALARM, & PANEL INSTALLATION HEIGHTS

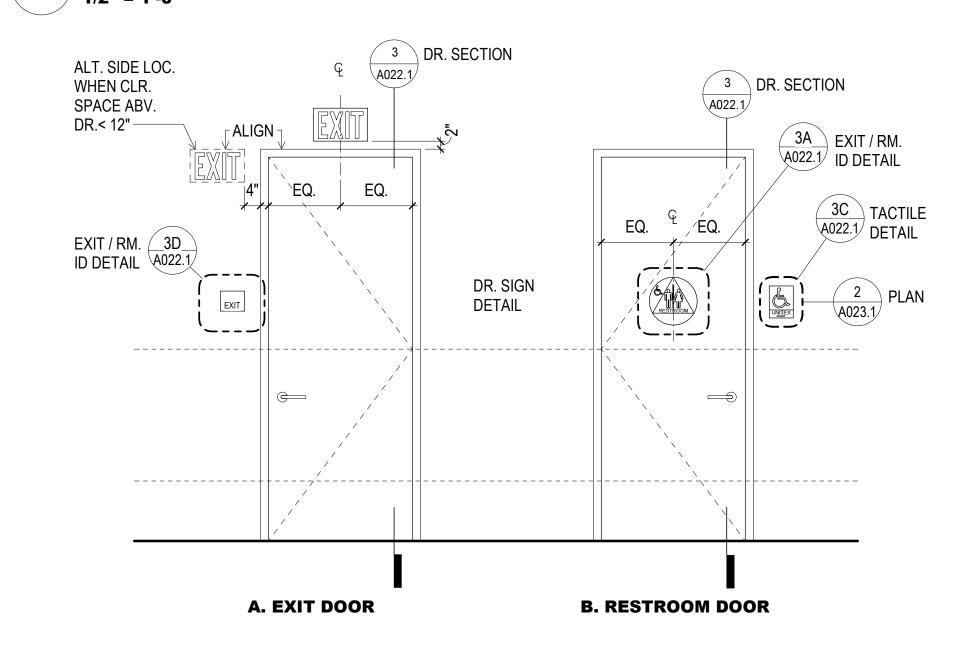

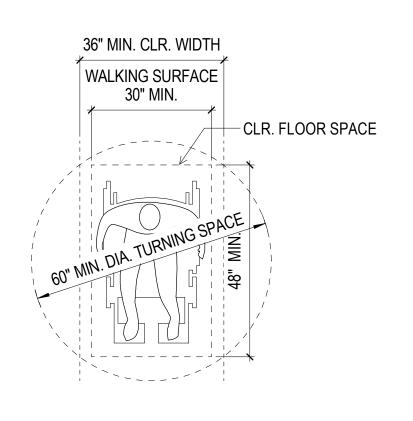



TYPICAL CLEARANCES

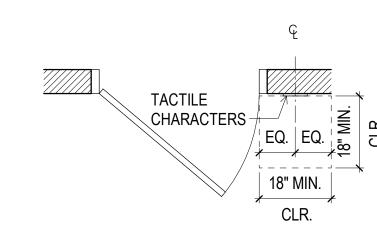



TYPICAL DOOR SIGNAGE ELEVATIONS

18" MIN. (a) INTERIOR EXTRA CLEARANCE 24" MIN. REQ'D. WHEN DR. @ EXTERIOR HAS BOTH A LATCH & CLOSER

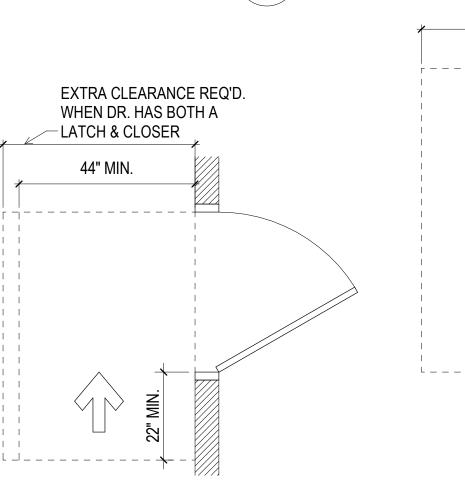

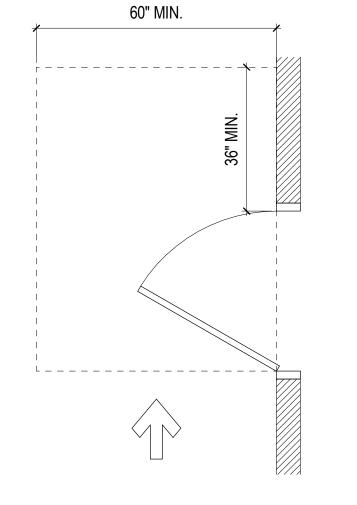

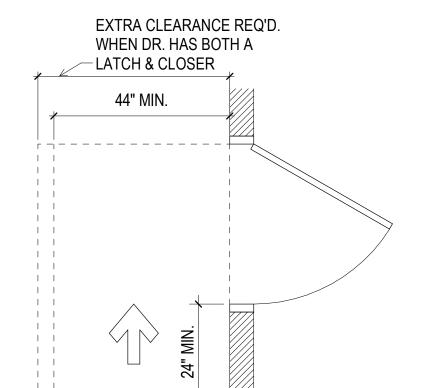

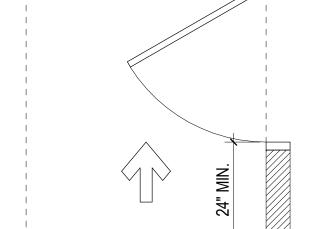

E. LATCH APPROACH - PUSH SIDE

F. LATCH APPROACH **PULL SIDE**

C. HINGE APPROACH - PUSH SIDE

D. HINGE APPROACH - PULL SIDE

1. ARROW INDICATES APPROACH DIRECTION. 2. DASHED LINE INDICATES AREA OF LEVEL AND CLEAR LANDING. 3. DOOR OPENING CLEAR WIDTH IS 32" MIN.

A. FRONT APPROACH - PUSH SIDE


DOOR MANEUVERING CLEARANCES


B. FRONT APPROACH - PULL SIDE

1/2" = 1'-0"

PARK DEVELOPMENT

TACTILE SIGN CLEARANCE

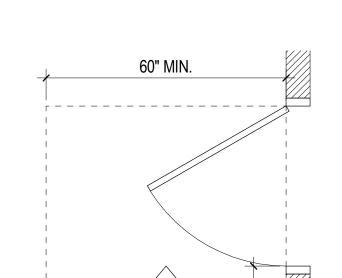

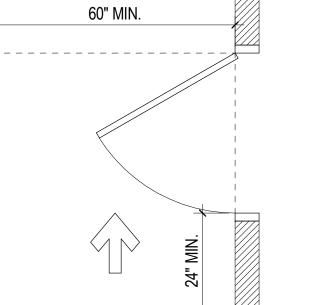

900 INNES

CITY AND COUNTY OF SAN FRANCISCO RECREATION AND PARKS DEPARTMENT 30 VAN NESS AVENUE

SAN FRANCISCO, CA 94102 PH. 415-831-2700 THE TRUST FOR PUBLIC LAND 101 MONTGOMERY STREET SUITE 900

SAN FRANCISCO, CA 94104

PH. 415-495-4014 PRIME CONSULTANT / LANDSCAPE ARCHITECT GUSTAFSON GUTHRIE NICHOL PH. 206-903-6802 CIVIL ENGINEER SHERWOOD DESIGN ENGINEERS PH. 415-348-9650 ARCHITECT JENSEN ARCHITECTS PH. 415-348-9650 ECOLOGICAL RESTORATION RANA CREEK PH. 831-659-3820 STRUCTURAL ENGINEER JON BRODY STRUCTURAL ENGINEERS PH. 415-296-9494 COASTAL ENGINEER MOFFATT AND NICHOL PH. 925-944-5411 LIGHTING NITEO CALIFORNIA PH. 415-666-2232 MEP & IT INTERFACE ENGINEERING PH. 415-489-7240 GEOTECHNICAL ENGINEER AGS, INC PH. 415-957-9240 SECURITY CONSULTANT

PH. 415-259-0422 FOR OFFICIAL USE

ZBETA CONSULTING

KEY PLAN 2





RE	VISIONS:	
NO.	DATE	DESCRIPTION
01	12/18/2020	PERMIT SUBMITTAL

ISSUANCE **BID SET**


DRAWN BY CHECKED BY **JENSEN** DATE

GGN PROJECT # 7/01/2021 1608 ACCESSIBILITY DETAILS -

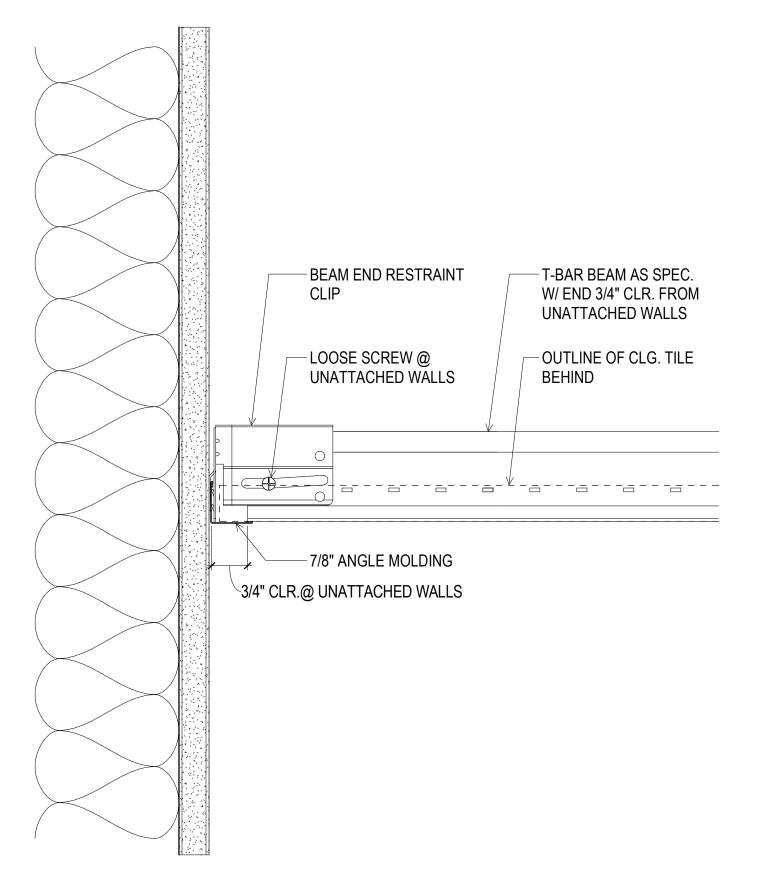

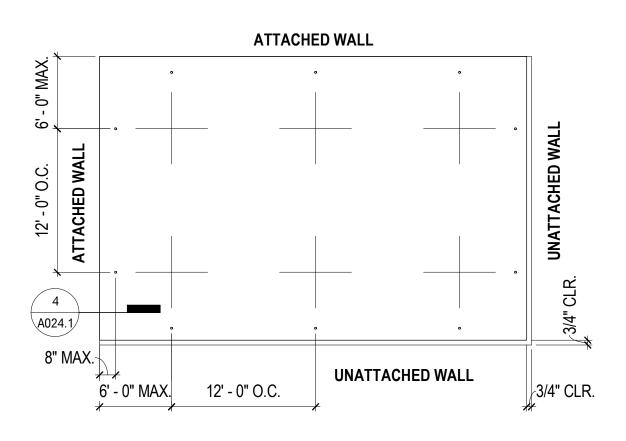

REFLECTED CEILING PLAN

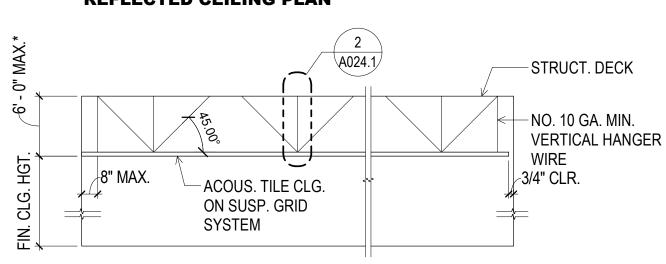



*UNLESS ENTIRE SYS. DESIGNED BY LICENSED ENG. OR ARCH.

SECTION THROUGH ROOM





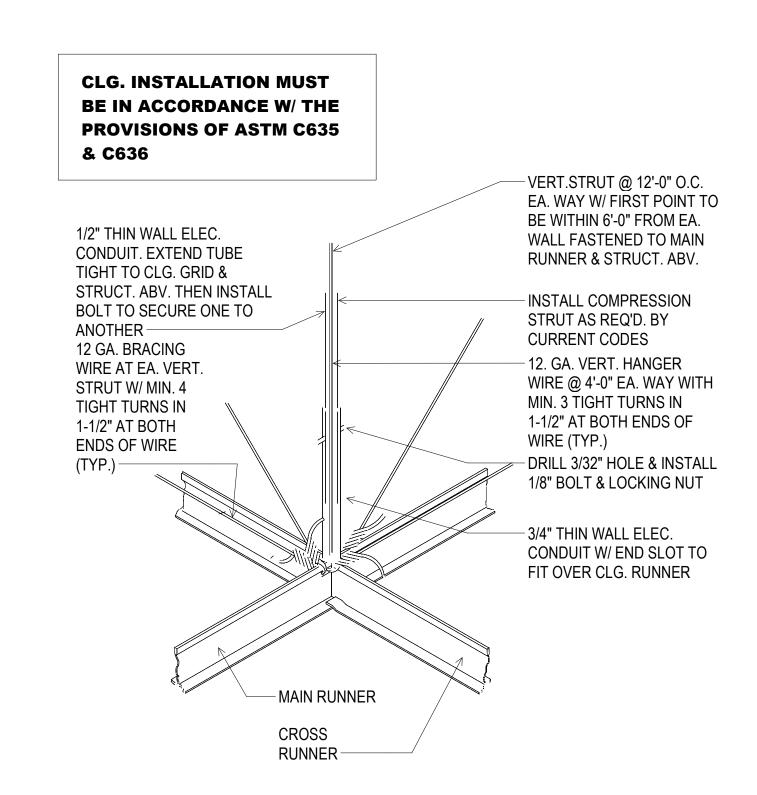

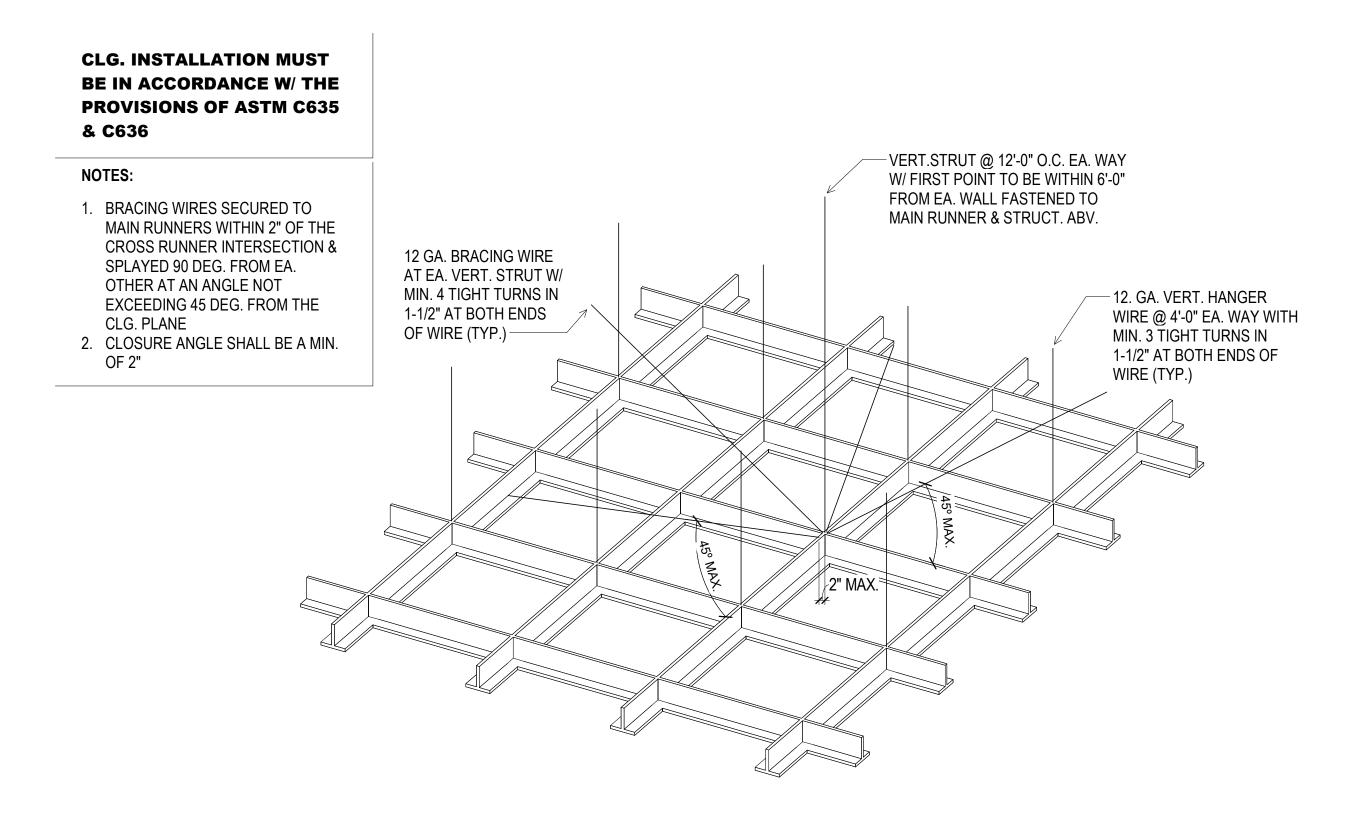

T-BAR SUPPORT DETAIL 3" = 1'-0"

TYP. TBAR AXON 3" = 1'-0"

900 INNES PARK DEVELOPMENT

CITY AND COUNTY OF SAN FRANCISCO RECREATION AND PARKS DEPARTMENT 30 VAN NESS AVENUE SAN FRANCISCO, CA 94102

PH. 415-831-2700 THE TRUST FOR PUBLIC LAND 101 MONTGOMERY STREET

SUITE 900

SAN FRANCISCO, CA 94104

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FOR OFFICIAL USE

PH. 415-259-0422

ZBETA CONSULTING

KEY PLAN 2



RE	VISIONS:	
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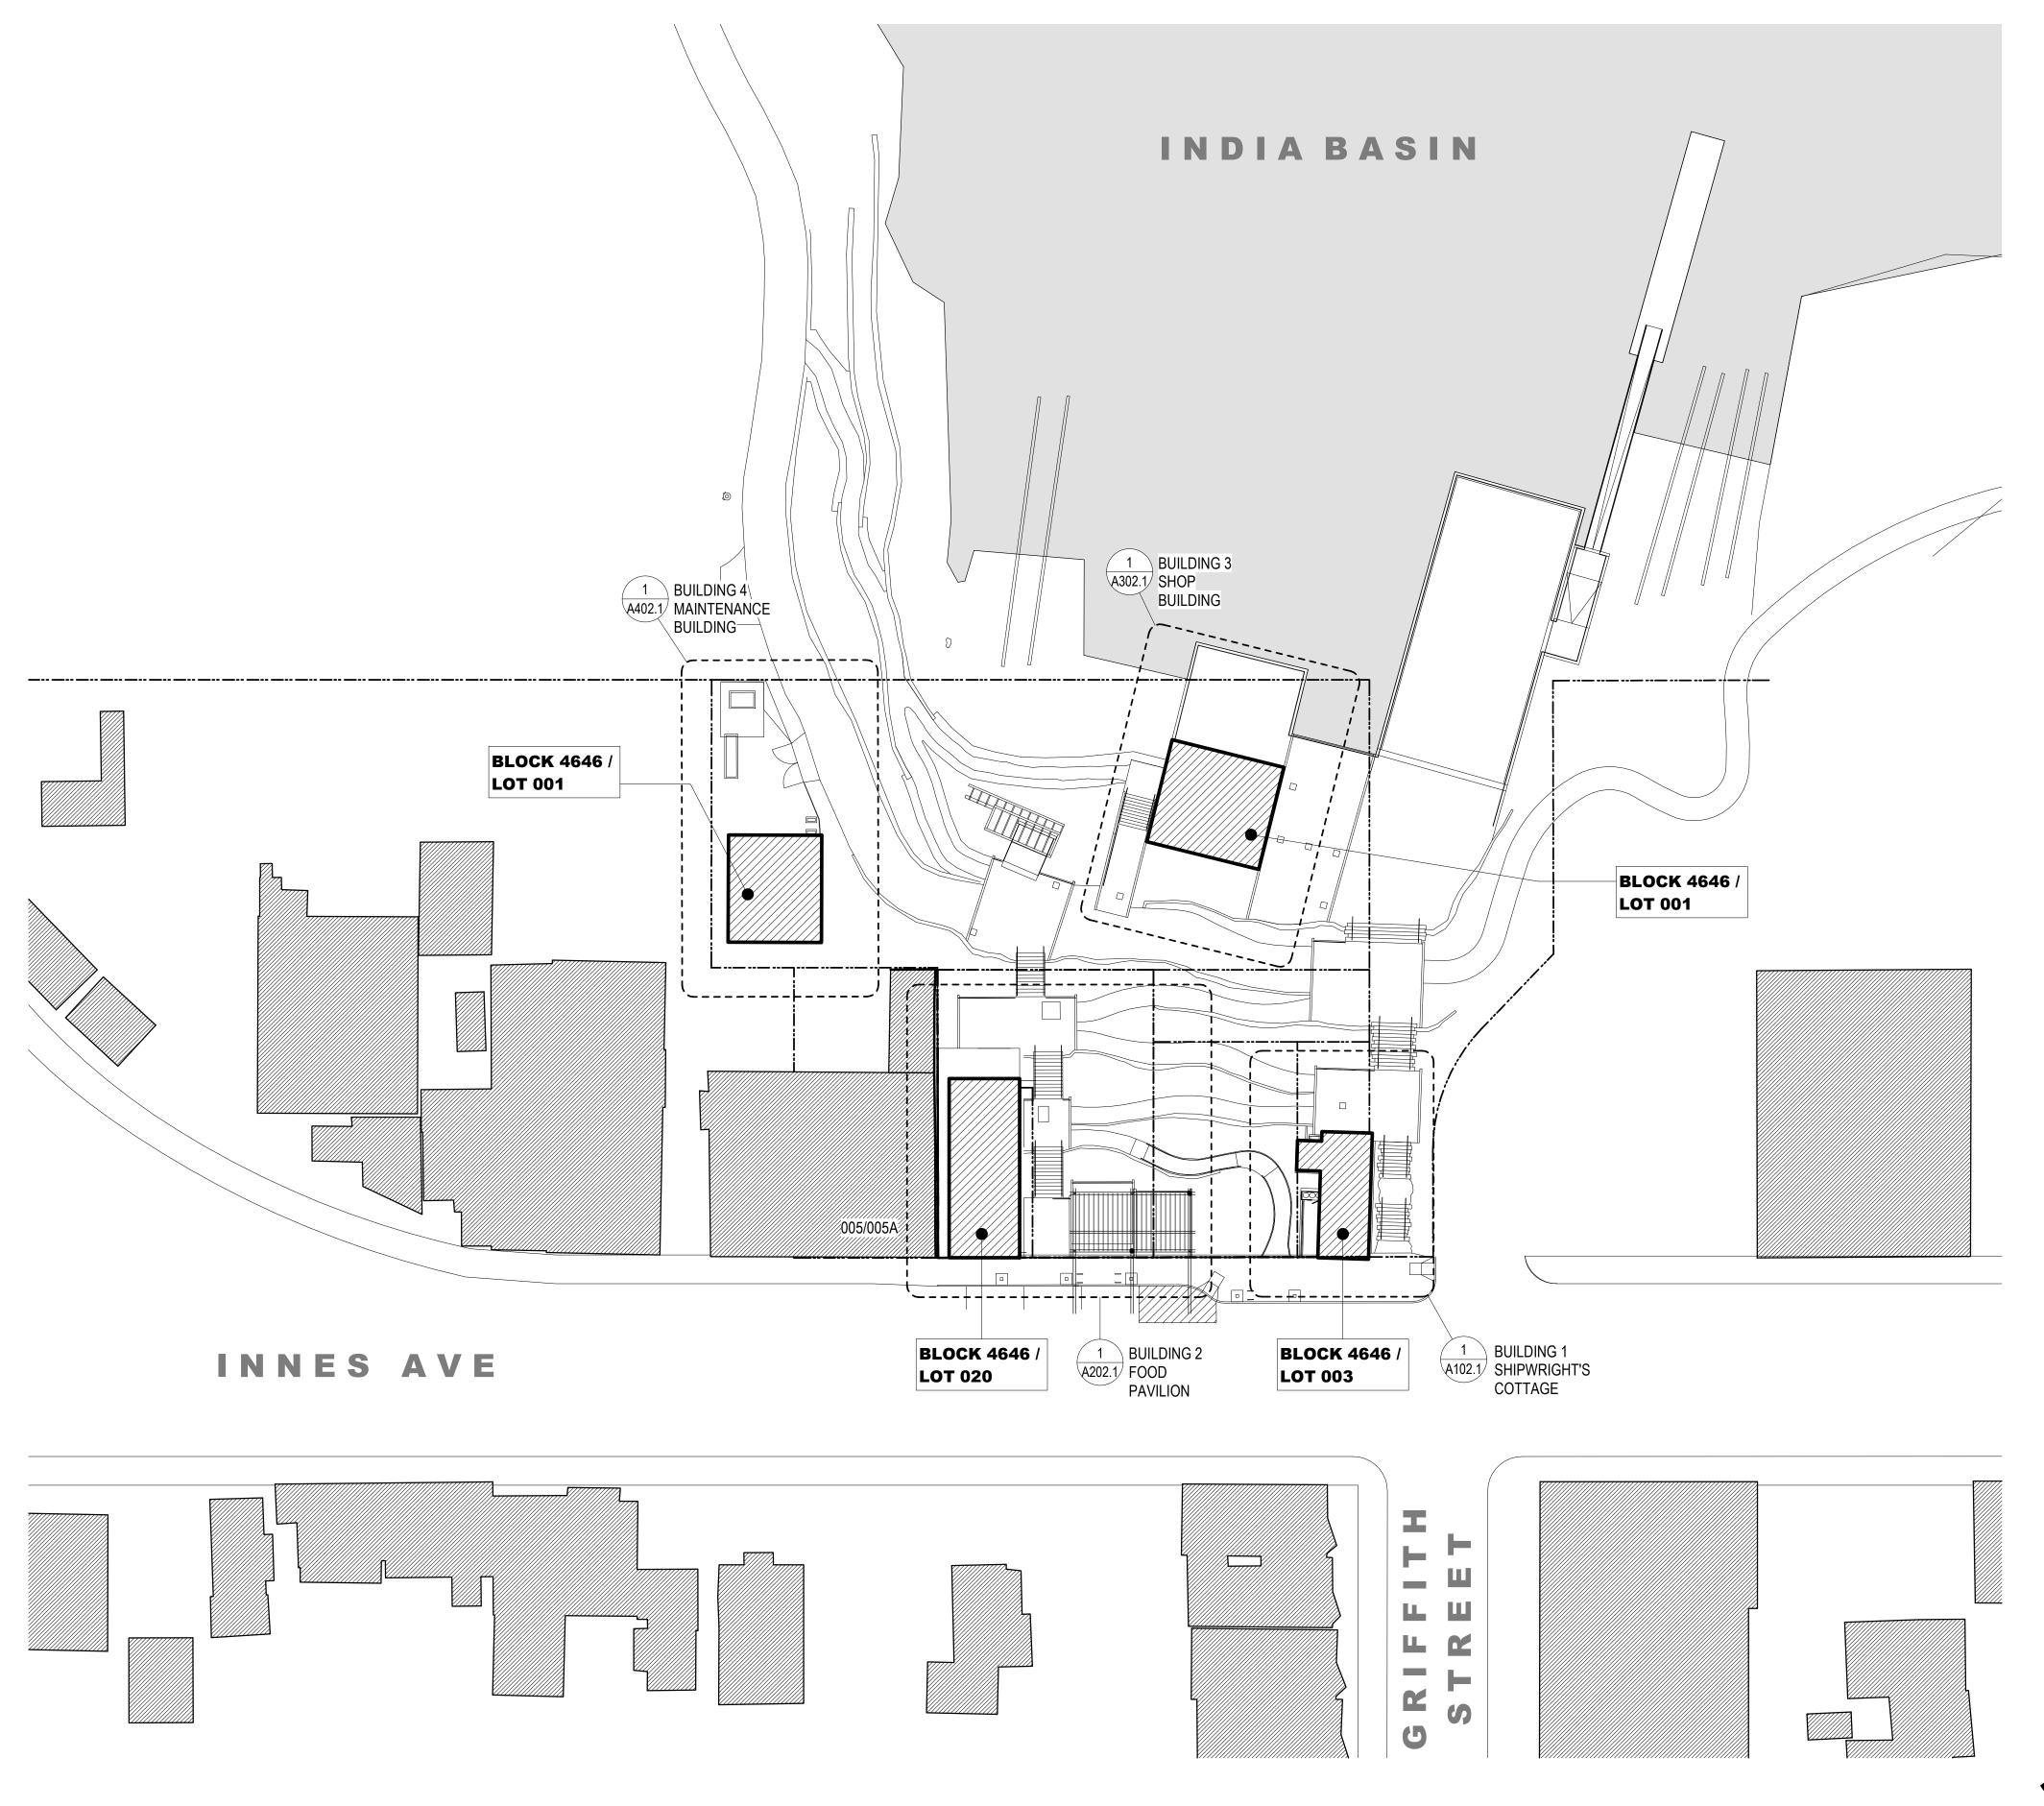
ISSUANCE **BID SET** DRAWN BY CHECKED BY

JENSEN DATE

GGN PROJECT # 7/01/2021 1608

TYP. CEILING & LIGHTING **DETAILS**

A024.1



900 INNES PARK DEVELOPMENT

CITY AND COUNTY OF SAN FRANCISCO RECREATION AND PARKS DEPARTMENT 30 VAN NESS AVENUE SAN FRANCISCO, CA 94102 PH. 415-831-2700


THE TRUST FOR PUBLIC LAND 101 MONTGOMERY STREET SUITE 900 SAN FRANCISCO, CA 94104 PH. 415-495-4014



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KEY PLAN

FOR OFFICIAL USE



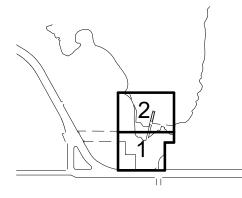

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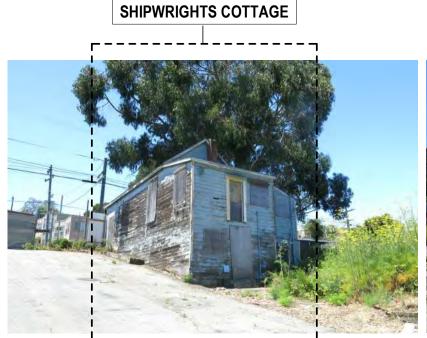
DRAWN BY JENSEN

GGN PROJECT # 7/01/2021

ARCHITECTURAL PLOT PLAN

CHECKED BY

A030.1



L-----







INNES AVE. BACK FACE OF BLDG'S.



INNES AVE. FRONT FACE OF BLDG'S. ACROSS STREET NTS



INNES AVE. FRONT FACE OF SUBJECT BLDG'S.

NTS

900 INNES PARK DEVELOPMENT

CITY AND COUNTY OF SAN FRANCISCO RECREATION AND PARKS DEPARTMENT 30 VAN NESS AVENUE SAN FRANCISCO, CA 94102

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PH. 415-296-9494 COASTAL ENGINEER MOFFATT AND NICHOL PH. 925-944-5411 LIGHTING


NITEO CALIFORNIA PH. 415-666-2232 MEP & IT INTERFACE ENGINEERING PH. 415-489-7240 GEOTECHNICAL ENGINEER AGS, INC PH. 415-957-9240

SECURITY CONSULTANT ZBETA CONSULTING

PH. 415-259-0422

FOR OFFICIAL USE

KEY PLAN

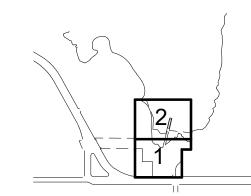



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NO. DATE DESCRIPTION 01 12/18/2020 PERMIT SUBMITTAL

ISSUANCE

BID SET

DRAWN BY

GGN PROJECT # 7/01/2021

CHECKED BY


EXISTING STREETSCAPE

A031.1


PHOTOS

SHEET NOTES:

- 1. REFERENCE 2019 CBC SECTION 302 FOR OCCUPANCY DESCRIPTIONS.
- 2. REFERENCE 2019 CBC TABLE 1004.5 FOR MAX. FLOOR AREA ALLOWANCES PER OCCUPANT.
- 3. REFERENCE 2019 CBC SECTION 1005 FOR MINIMUM EGRESS AND WIDTH REQUIREMENTS.
- 4. REFERENCE 2019 CBC TABLE 1006.2.1 FOR MINIMUM NUMBER OF EXITS FOR OCC. LOAD.
- 5. REFERENCE 2019 CBC TABLE 1017.2 FOR MAX. EXIT ACCESS TRAVEL DISTANCE WITH AUTOMATIC SPRINKLER SYSTEM. (A & E <250, B <300, S-2 & U <400)
- 6. REFERENCE 2019 CPC TABLE 422-1 FOR PLUMBING FIXTURE REQUIREMENTS.
- 7. PER 2019 CPC TABLE 422-1, NOTE 4, "FOR EACH URINAL ADDED IN EXCESS OF THE MINIMUM REQUIRED, ONE WATER CLOSET SHALL BE PERMITTED TO BE DEDUCTED. THE NUMBER OF WATER CLOSETS SHALL NOT BE REDUCED TO LESS THAN TWO-THIRDS OF THE MINIMUM REQUIREMENT."

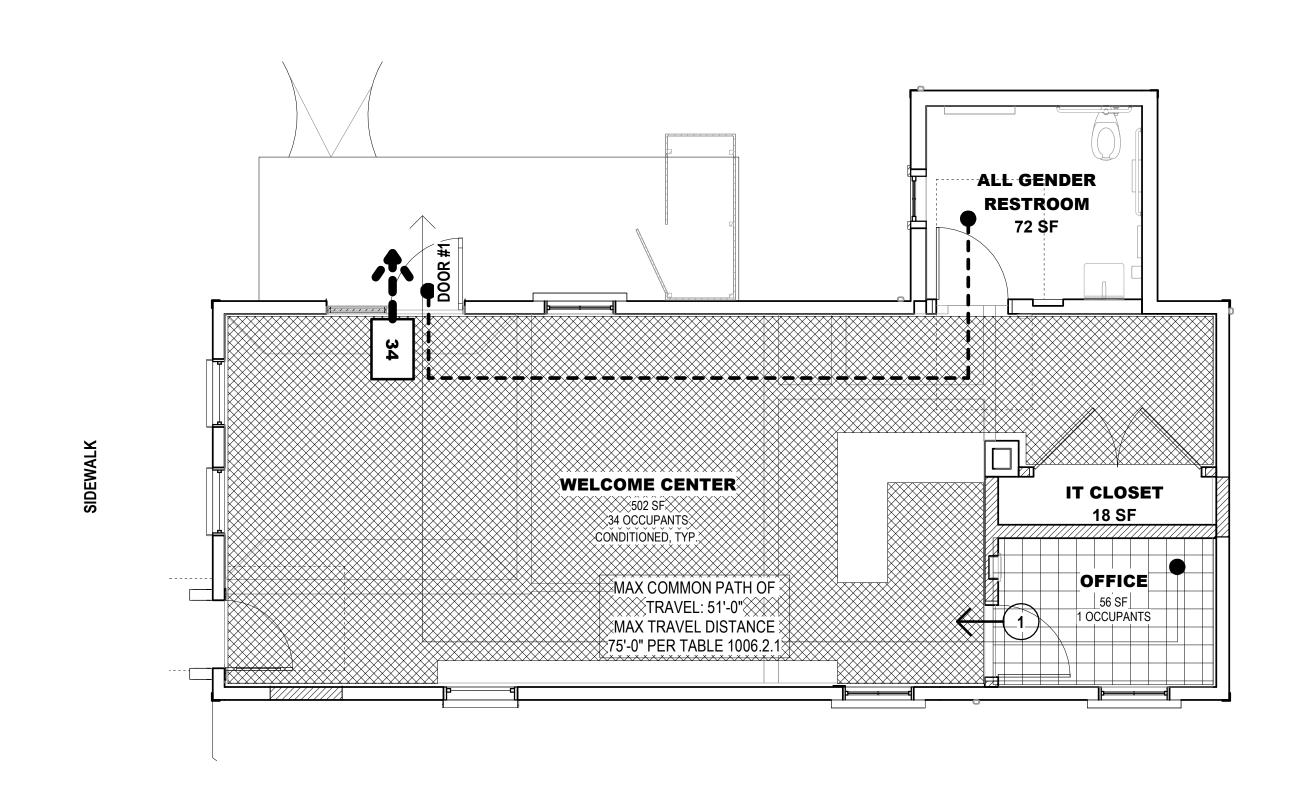

STREET LEVEL EGRESS PLAN 1/4" = 1'-0"

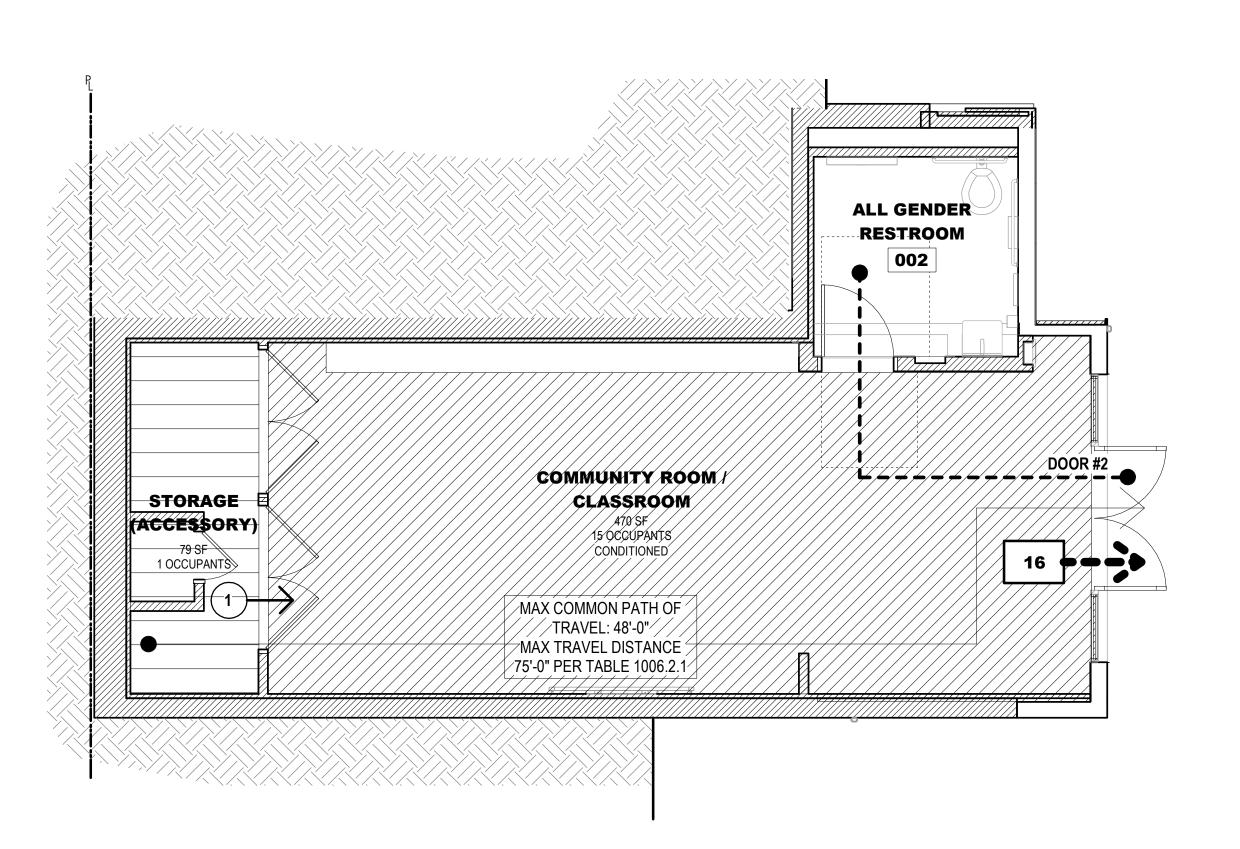

BOATYARD LEVEL EGRESS PLAN

OCCUPANT LOAD - SHIPWRIGHT'S COTTAGE

ROOM / AREA	FUNCTION OF SPACE	OCCUPIED AREA (SF)	LOAD FACTOR	OCC. BY AREA	EXI [*]
STREET LEVEL - SC					
WELCOME CENTER	ASSEMBLY, UNCONCENTRATED	502	1:15 NET	33.5	1
OFFICE	BUSINESS	56	1:150 GROSS	0.4	1
		STREET LEVE	OCCUPANT LO	DAD: 343	
BOATYARD LEVEL - S	SC				
STORAGE (ACCESSORY)	WAREHOUSE	79	1:300 GROSS	0.3	1
COMMUNITY ROOM / CLASSROOM	ASSEMBLY, EXHIBIT	470	1:30 NET	15.7	1

BOATYARD LEVEL OCCUPANT LOAD: 16) TOTAL OCCUPANT LOAD: 503

PLUMBING FIXTURE SUMMARY

PLUMBING FIXTURE OCCUPANT COUNT SHIPWRIGHTS COTTAGE

ROOM / AREA	OCCUP. GROUP	OCCUPIED AREA (SF)	LOAD FACTOR	OCCUPANT LOAD
STREET LEVEL - SC				
WELCOME CENTER	A2 - EXHIBIT	502	1:30 SF	16.73
OFFICE	B - OFFICE / PUBLIC	56	1:200 SF	0.28
BOATYARD LEVEL - SC				
COMMUNITY ROOM / CLASSROOM	A2 - CONFERENCE ROOM	470	1:30 SF	15.67
STORAGE (ACCESSORY)	H - HAZMAT FAB / STORAGE	79	1:5000 SF	0.02
		PLU	IMBING OCCUPANT L	OAD: 34


REQUIRED RESTROOM FIXTURE COUNT

# OF OCCUPANTS	# OF	# OF FIXTURES		
33 TOTAL OCCUPANTS / 2 = 17	REQUIRED	PROVIDED (ALL GENDER)		
17 MEN	1 W.C. / 1 URINAL	2 W.C. / 1 URINAL		
17 IVIEIN	1 LAVATORIES	2 LAVATORIES		
17 WOMEN	1 W.C.	NA		
17 VVOIVIEN	1 LAVATORIES	NA		
	1 WATER FOUNTAIN	1 WATER FOUNTAIN		

EXITING REQUIREMENTS

	EXIT COMPONENT	OCC. LOAD CAPACITY	ACTUAL OCC. LOAD	LOAD FACTOR	MIN. WIDTH	WIDTH PROVIDED
	DOOR #1	180	34	0.2	34"	36"
	DOOR #2	320	27	0.2	34"	64"

EGRESS LEGEND

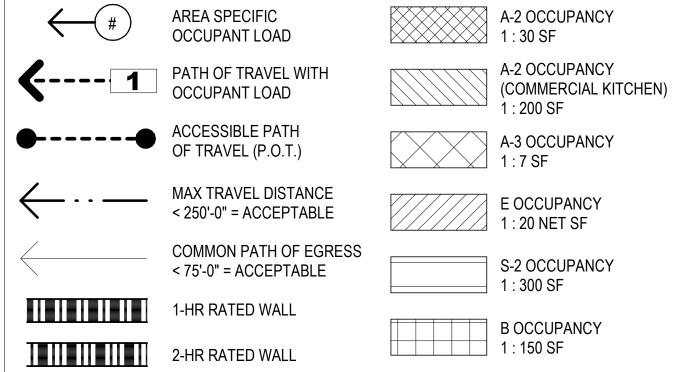

900 INNES PARK DEVELOPMENT

CITY AND COUNTY OF SAN FRANCISCO RECREATION AND PARKS DEPARTMENT 30 VAN NESS AVENUE SAN FRANCISCO, CA 94102

PH. 415-831-2700 THE TRUST FOR PUBLIC LAND 101 MONTGOMERY STREET SUITE 900 SAN FRANCISCO, CA 94104

PH. 415-495-4014

PRIME CONSULTANT / LANDSCAPE ARCHITECT GUSTAFSON GUTHRIE NICHOL PH. 206-903-6802

CIVIL ENGINEER SHERWOOD DESIGN ENGINEERS PH. 415-348-9650

ARCHITECT JENSEN ARCHITECTS PH. 415-348-9650 ECOLOGICAL RESTORATION RANA CREEK

PH. 831-659-3820 STRUCTURAL ENGINEER JON BRODY STRUCTURAL ENGINEERS PH. 415-296-9494 COASTAL ENGINEER MOFFATT AND NICHOL


PH. 925-944-5411 LIGHTING NITEO CALIFORNIA PH. 415-666-2232 MEP & IT

INTERFACE ENGINEERING PH. 415-489-7240 GEOTECHNICAL ENGINEER AGS, INC

PH. 415-957-9240 SECURITY CONSULTANT ZBETA CONSULTING PH. 415-259-0422

FOR OFFICIAL USE

KEY PLAN

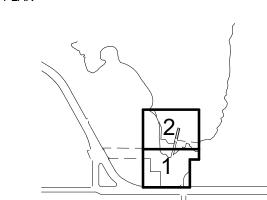



REVISIONS:

NO. DATE DESCRIPTION 01 12/18/2020 PERMIT SUBMITTAL

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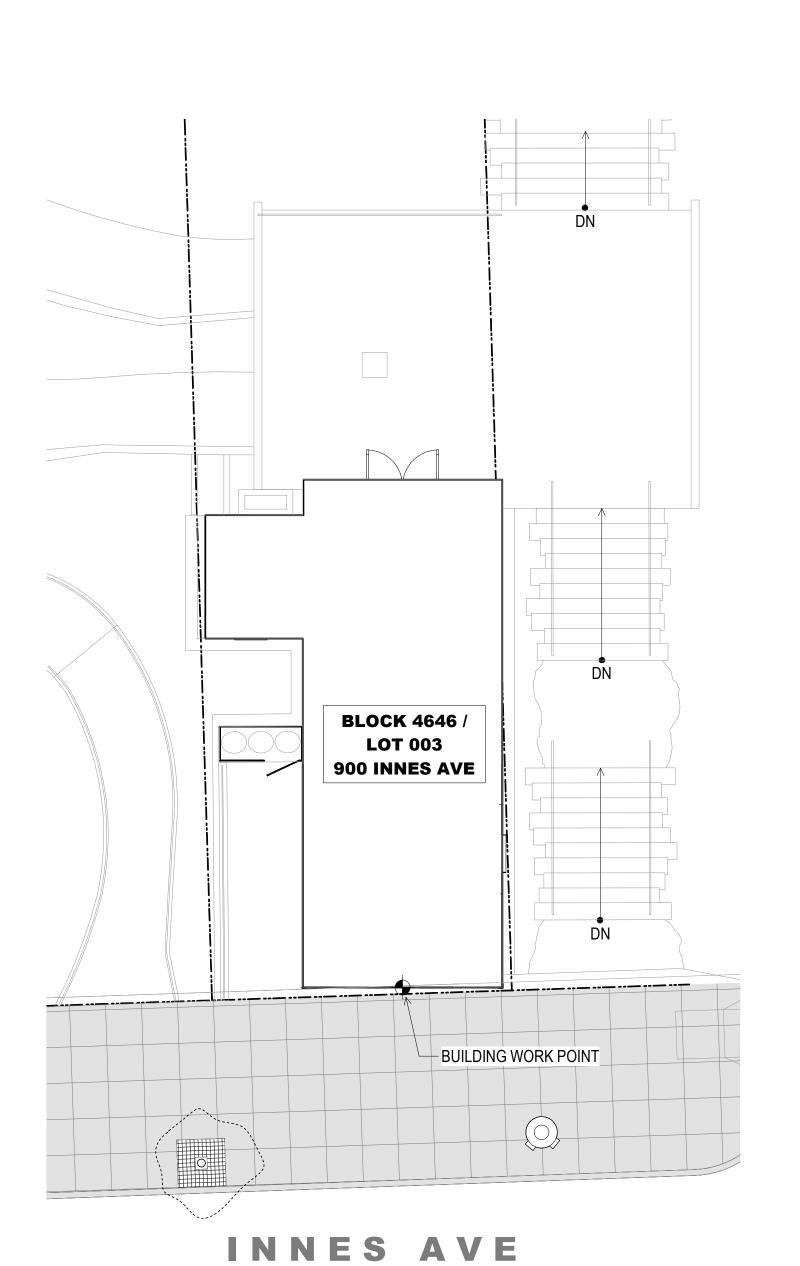
GGN PROJECT # 7/01/2021

EGRESS / ACCESSIBLE

POT / FIRE RATING PLAN

A101.1

1/4" = 1'-0"



SITE PLAN - SHIPWRIGHT'S COTTAGE

1/8" = 1'-0"

BUILDING 1: SHIPWRIGHT'S COTTAGE

BUILDING INFORMATION:	EXISTING	PROPOSED	REQ. / ALLOW.
CONSTRUCTION TYPE	TYPE V-B	TYPE V-B	-
STORIES OF OCCUPANCY	1	1	2
BASEMENTS	1	1	-
BUILDING HEIGHT	18' - 4 1/4"	18' - 4 1/4"	60' - 0"
OCCUPANCY GROUP	R-3	B / A-3	-
FIRE SPRINKLERS	NO	YES	NONE REQ.
GROSS FLOOR AREA:	EXISTING	PROPOSED	REQ. / ALLOW.
STREET (UPPER) LEVEL	748 SQFT.	713 SQFT.	45,000
BOATYARD (LOWER) LEVEL	716 SQFT.	659 SQFT.	45,000

SHEET NOTES:

 LANDSCAPING AND SITE SHOWN FOR REF. ONLY - SEE CIVIL, LANDSCAPE, OR COASTAL ENGINEERING DRAWINGS FOR DETAILS.

TOTAL BUILDING AREA: 1,464 SQFT. 1,372 SQFT.

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THE TRUST FOR PUBLIC LAND 101 MONTGOMERY STREET SUITE 900 SAN FRANCISCO, CA 94104 PH. 415-495-4014

PH. 415-831-2700



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PH. 415-666-2232

PH. 415-957-9240


INTERFACE ENGINEERING PH. 415-489-7240

GEOTECHNICAL ENGINEER AGS, INC

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MEP & IT

KEY PLAN



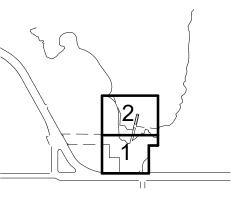

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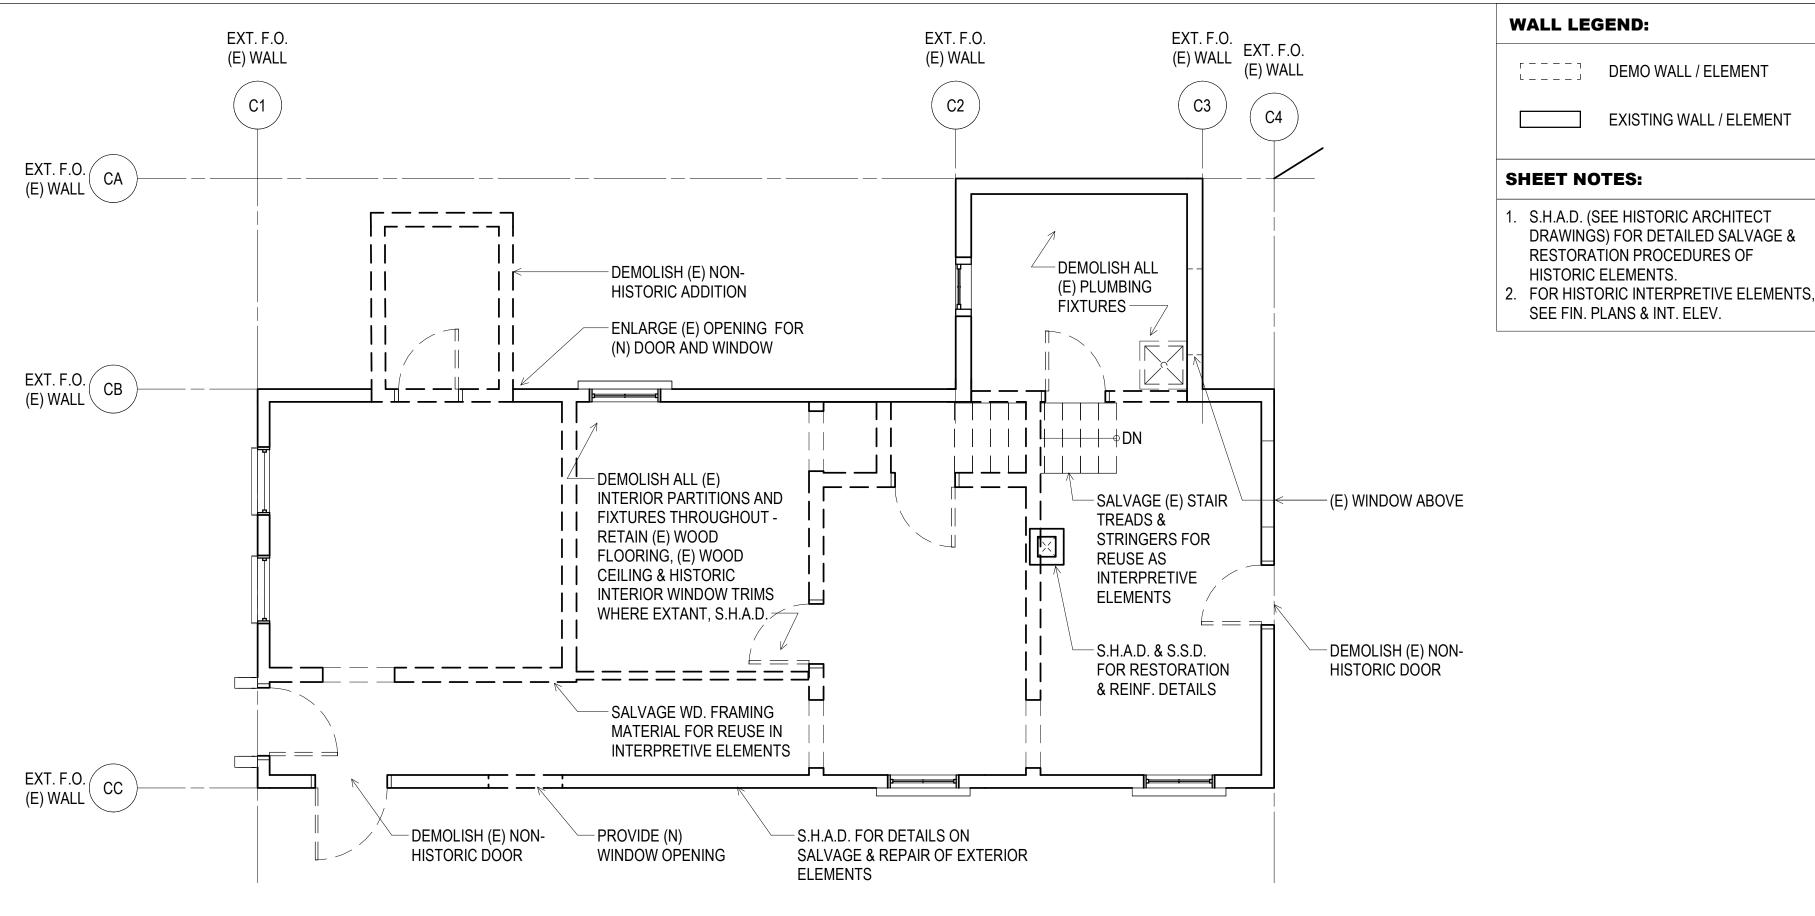
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JENSEN

DATE
7/01/2021


GGN PROJECT # 1608

SHIPWRIGHT'S COTTAGE -BUILDING SITE PLAN

A102.1



EXISTING / DEMO FIRST FLOOR PLAN 1/4" = 1'-0"

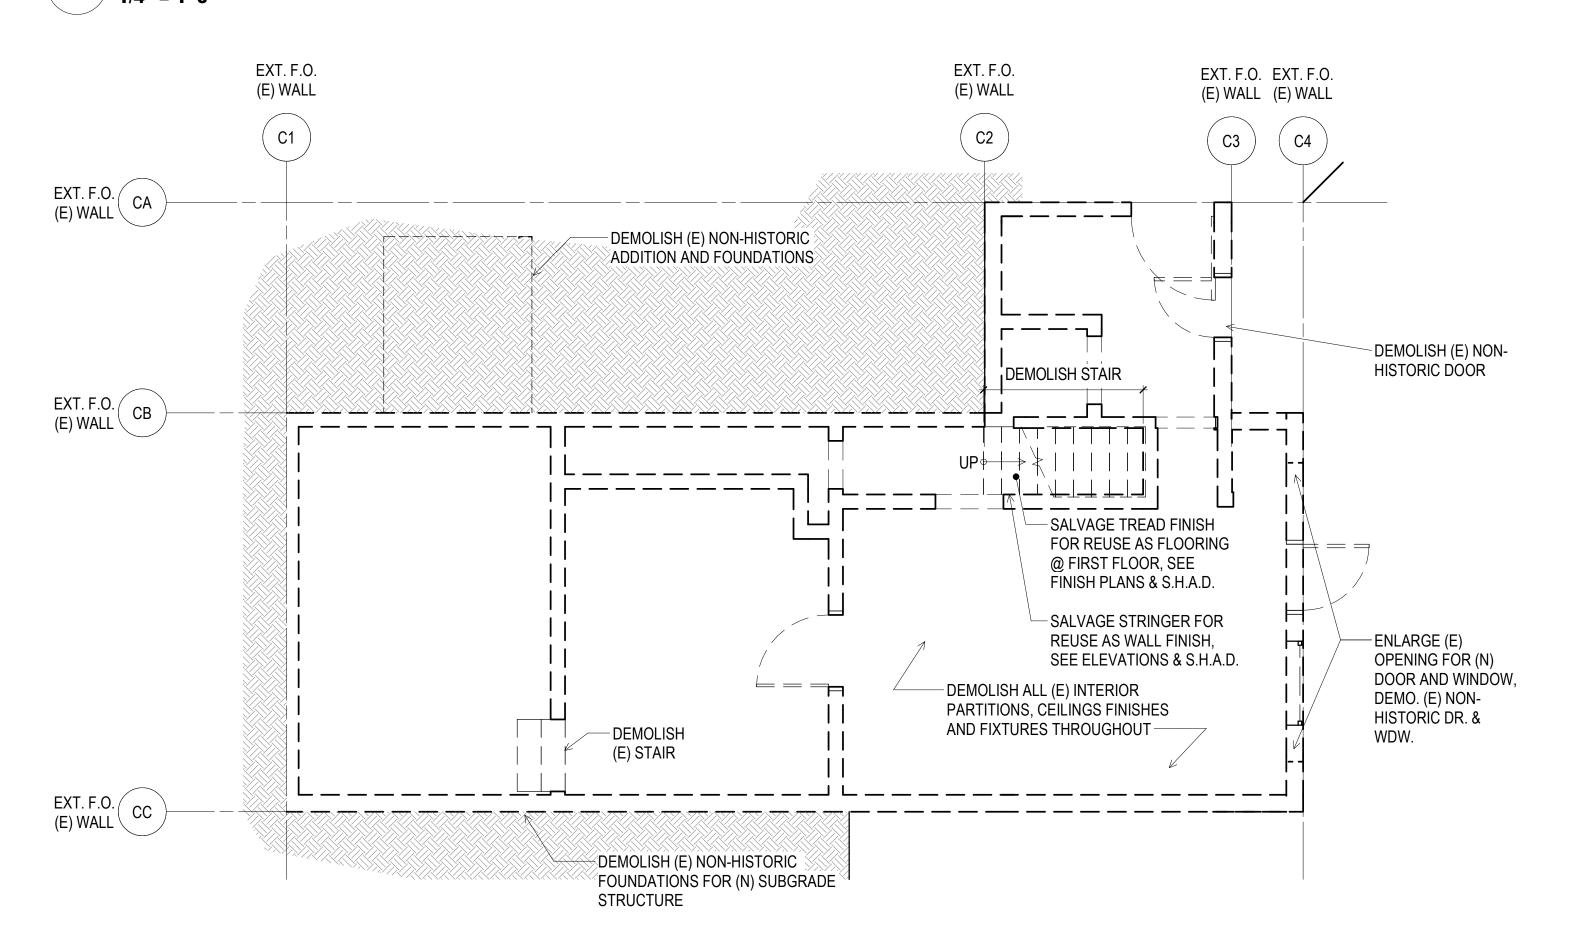

EXISTING / DEMO BASEMENT PLAN 1/4" = 1'-0"



900 INNES PARK DEVELOPMENT

CITY AND COUNTY OF SAN FRANCISCO RECREATION AND PARKS DEPARTMENT 30 VAN NESS AVENUE

DEMO WALL / ELEMENT

EXISTING WALL / ELEMENT

SAN FRANCISCO, CA 94102 PH. 415-831-2700

THE TRUST FOR PUBLIC LAND 101 MONTGOMERY STREET SUITE 900 SAN FRANCISCO, CA 94104 PH. 415-495-4014



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KEY PLAN 2



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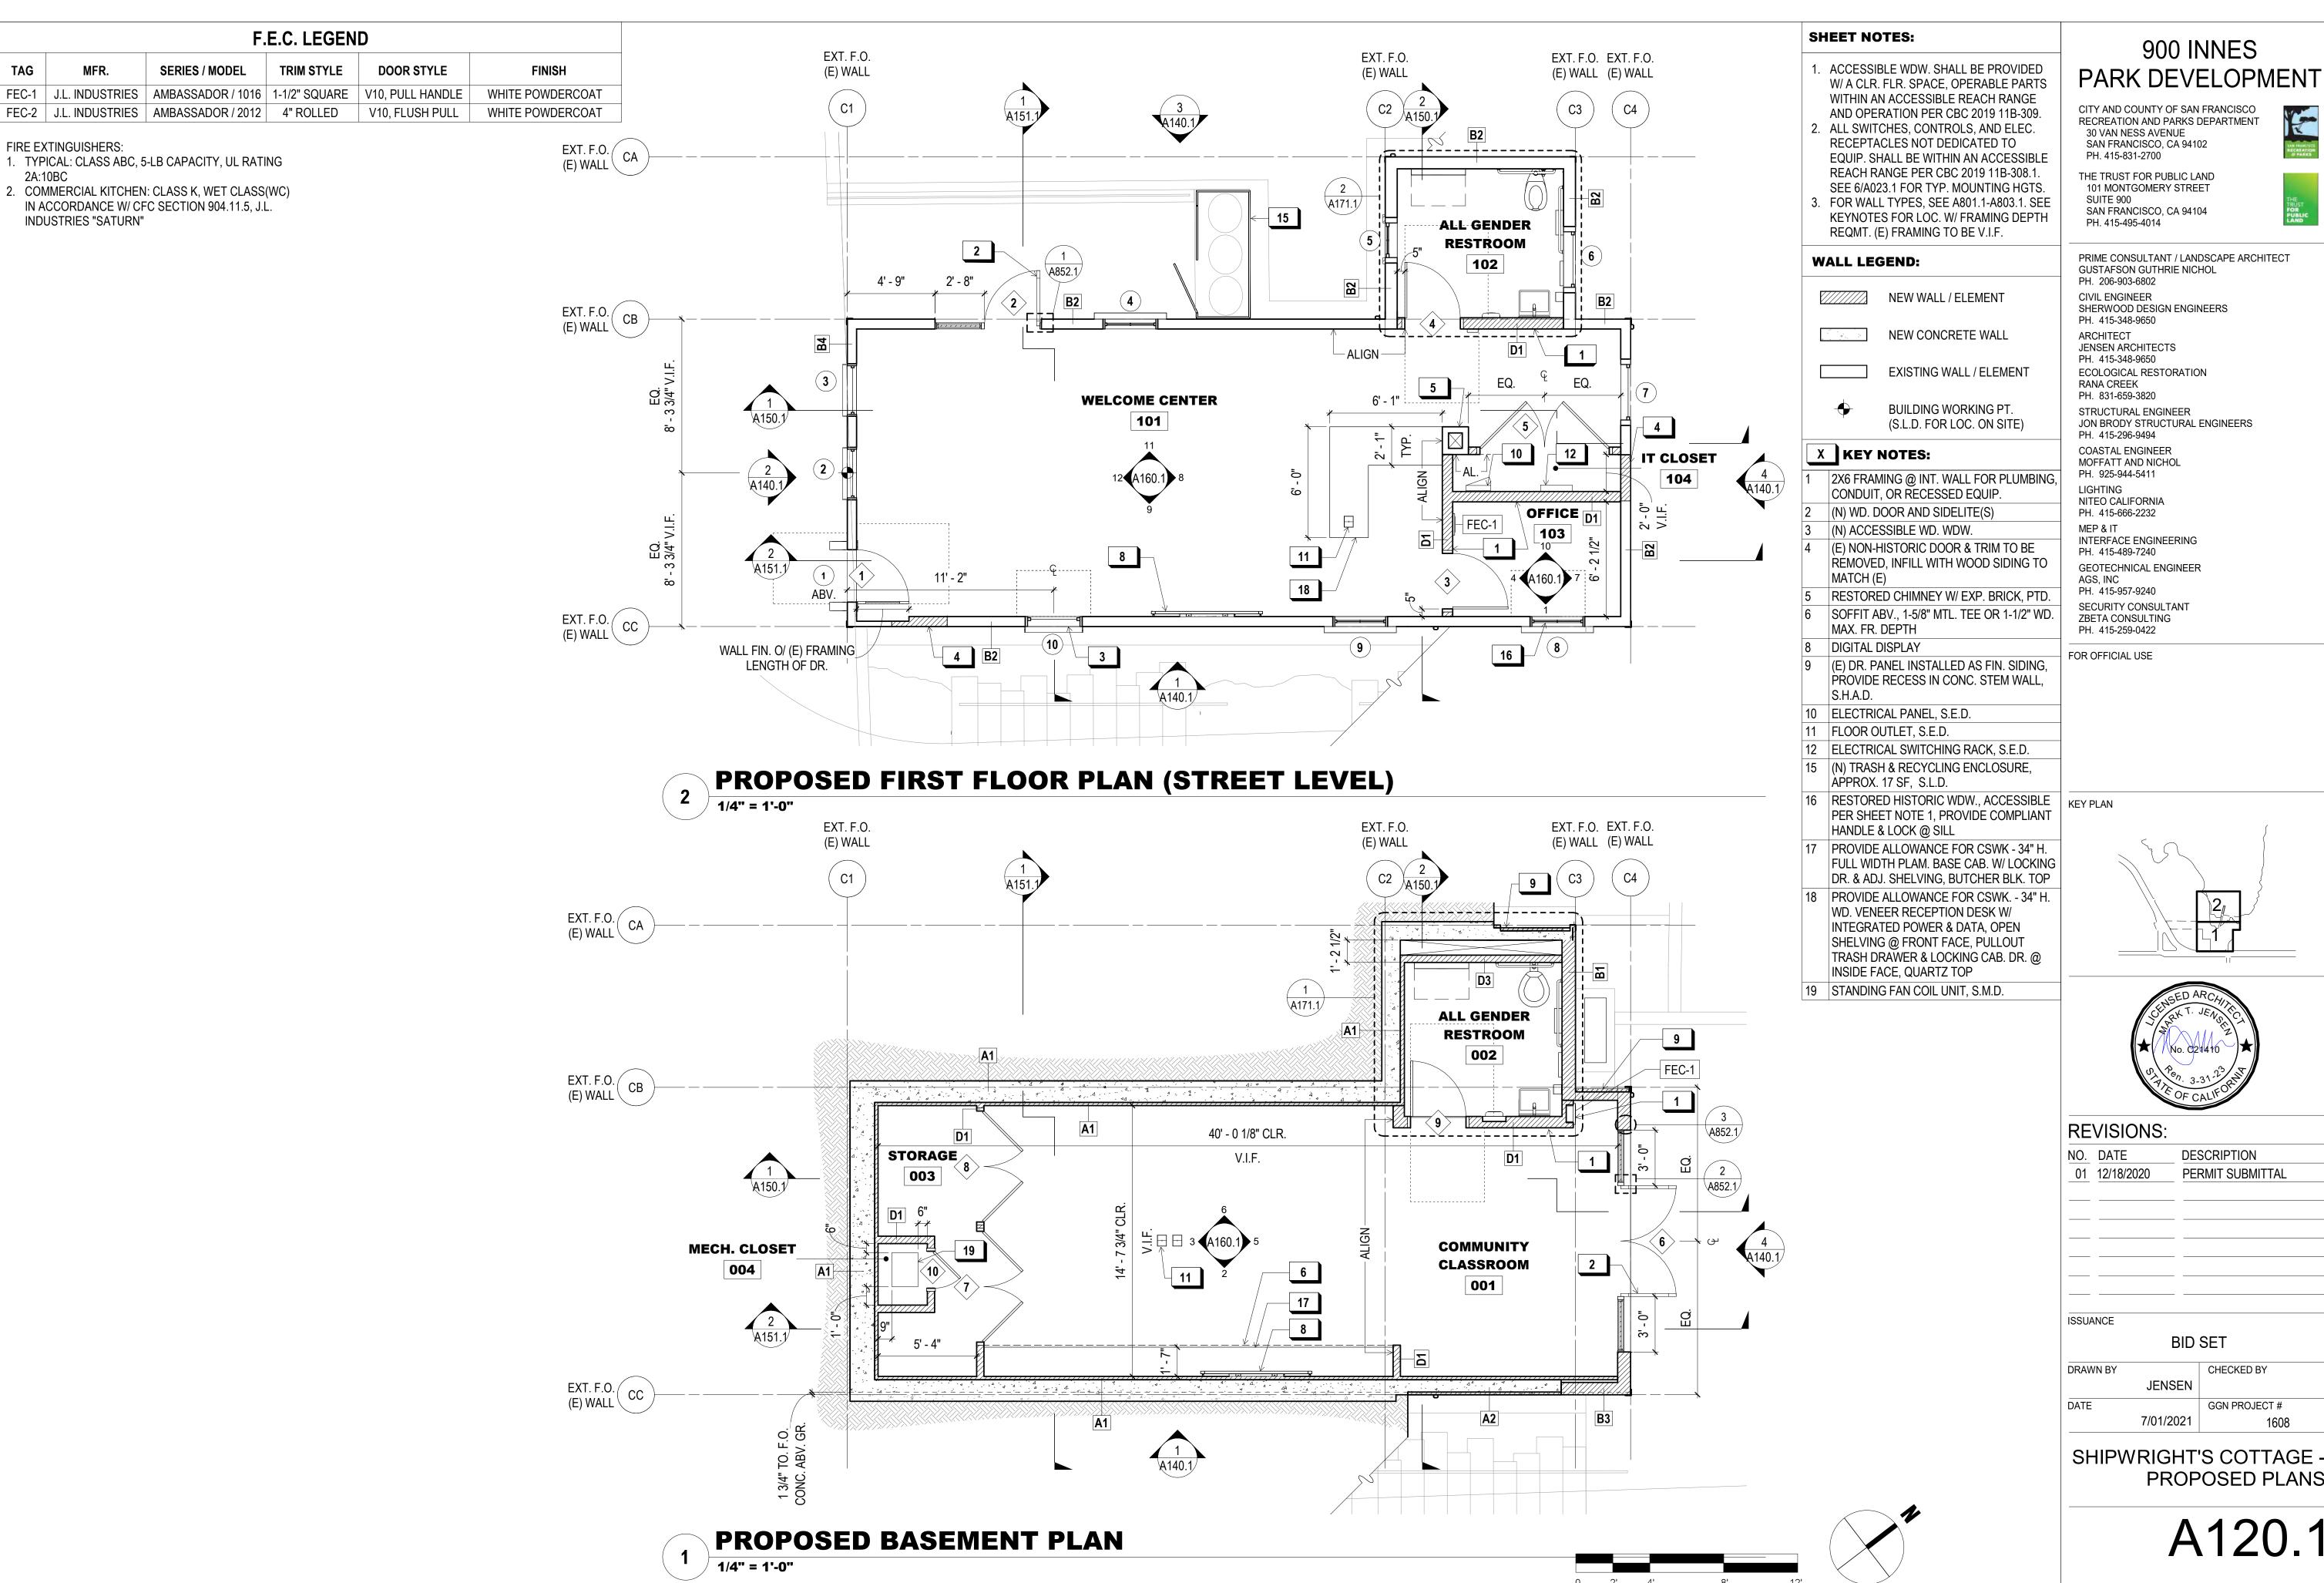
7/01/2021 SHIPWRIGHT'S COTTAGE -

EXISTING / DEMO PLANS

A110.1

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GGN PROJECT #



900 INNES PARK DEVELOPMENT

CITY AND COUNTY OF SAN FRANCISCO RECREATION AND PARKS DEPARTMENT

30 VAN NESS AVENUE SAN FRANCISCO, CA 94102 PH. 415-831-2700

THE TRUST FOR PUBLIC LAND 101 MONTGOMERY STREET SUITE 900 SAN FRANCISCO, CA 94104 PH. 415-495-4014



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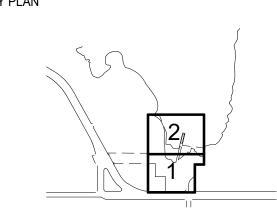
PH. 415-666-2232 MEP & IT

SHERWOOD DESIGN ENGINEERS PH. 415-348-9650 ARCHITECT JENSEN ARCHITECTS PH. 415-348-9650 ECOLOGICAL RESTORATION RANA CREEK PH. 831-659-3820 STRUCTURAL ENGINEER JON BRODY STRUCTURAL ENGINEERS PH. 415-296-9494 COASTAL ENGINEER MOFFATT AND NICHOL PH. 925-944-5411 LIGHTING NITEO CALIFORNIA INTERFACE ENGINEERING PH. 415-489-7240 **GEOTECHNICAL ENGINEER** AGS, INC PH. 415-957-9240

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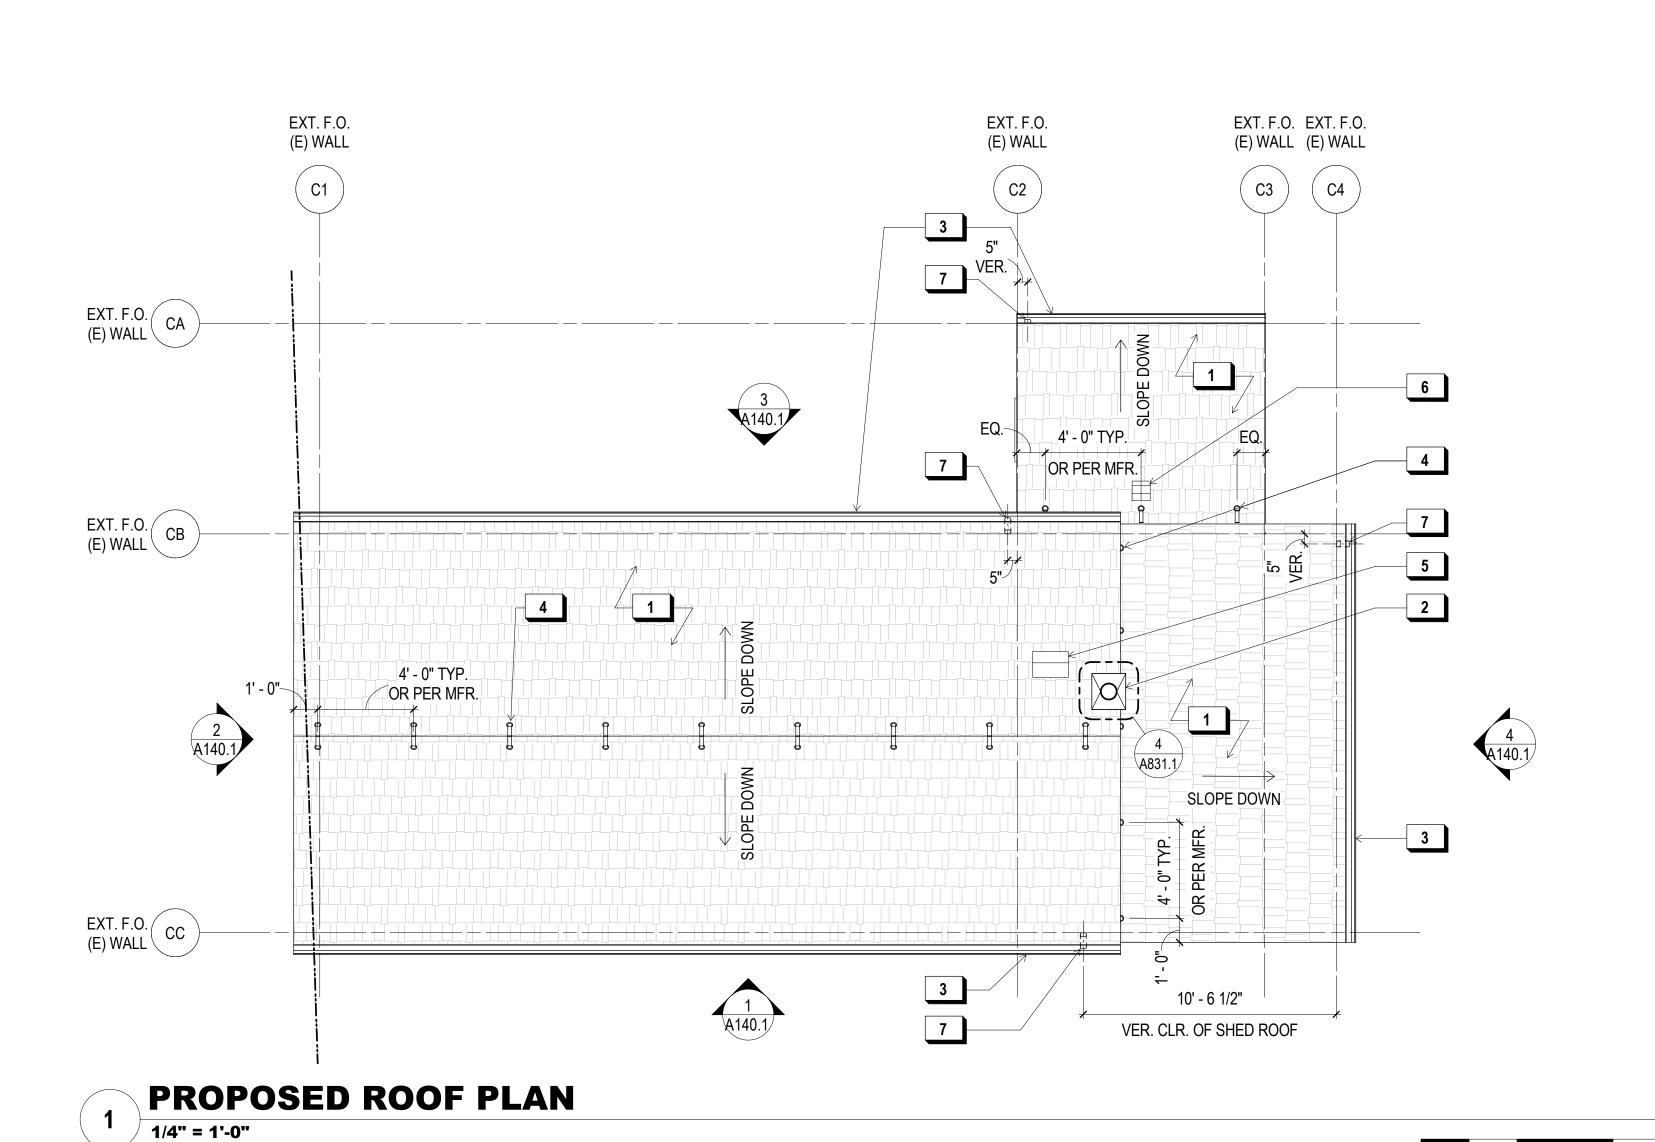
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GGN PROJECT # 7/01/2021

PROPOSED PLANS

CHECKED BY

A120.1



X KEY NOTES:

- (N) COMP. SHINGLE ROOF TO REPLACE (E),
- NONFUNCTIONAL, RESTORED HISTORIC CHIMNEY, S.H.A.D. & S.S.D.
- (N) STAINLESS STEEL GUTTER, PTD., TYP.
 (N) OSHA-COMPLIANT D-RING ANCHOR
- FOR FALL ARREST SYSTEM, TYP.
- OUTSIDE AIR INTAKE FOR FAN COIL, S.M.D.

 EXHAUST VENT FOR RESTROOM E.F.,
 S.M.D.
- (N) S.S. PLAIN 2"X3" SQUARE DS. BELOW, PTD. LOC. TIGHT TO CORNER BD. W.O.

900 INNES PARK DEVELOPMENT

CITY AND COUNTY OF SAN FRANCISCO RECREATION AND PARKS DEPARTMENT 30 VAN NESS AVENUE



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SUITE 900
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PH. 415-495-4014


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KEY PLAN





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DATE


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7/01/2021 1608

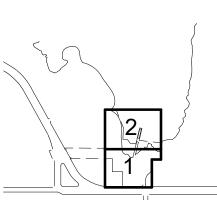SHIPWRIGHT'S COTTAGE - PROPOSED ROOF PLAN

A121.1



900 INNES STRUCTURAL CONC. SLAB PARK DEVELOPMENT W/ 3" TOPPING TYP. U.O.N.

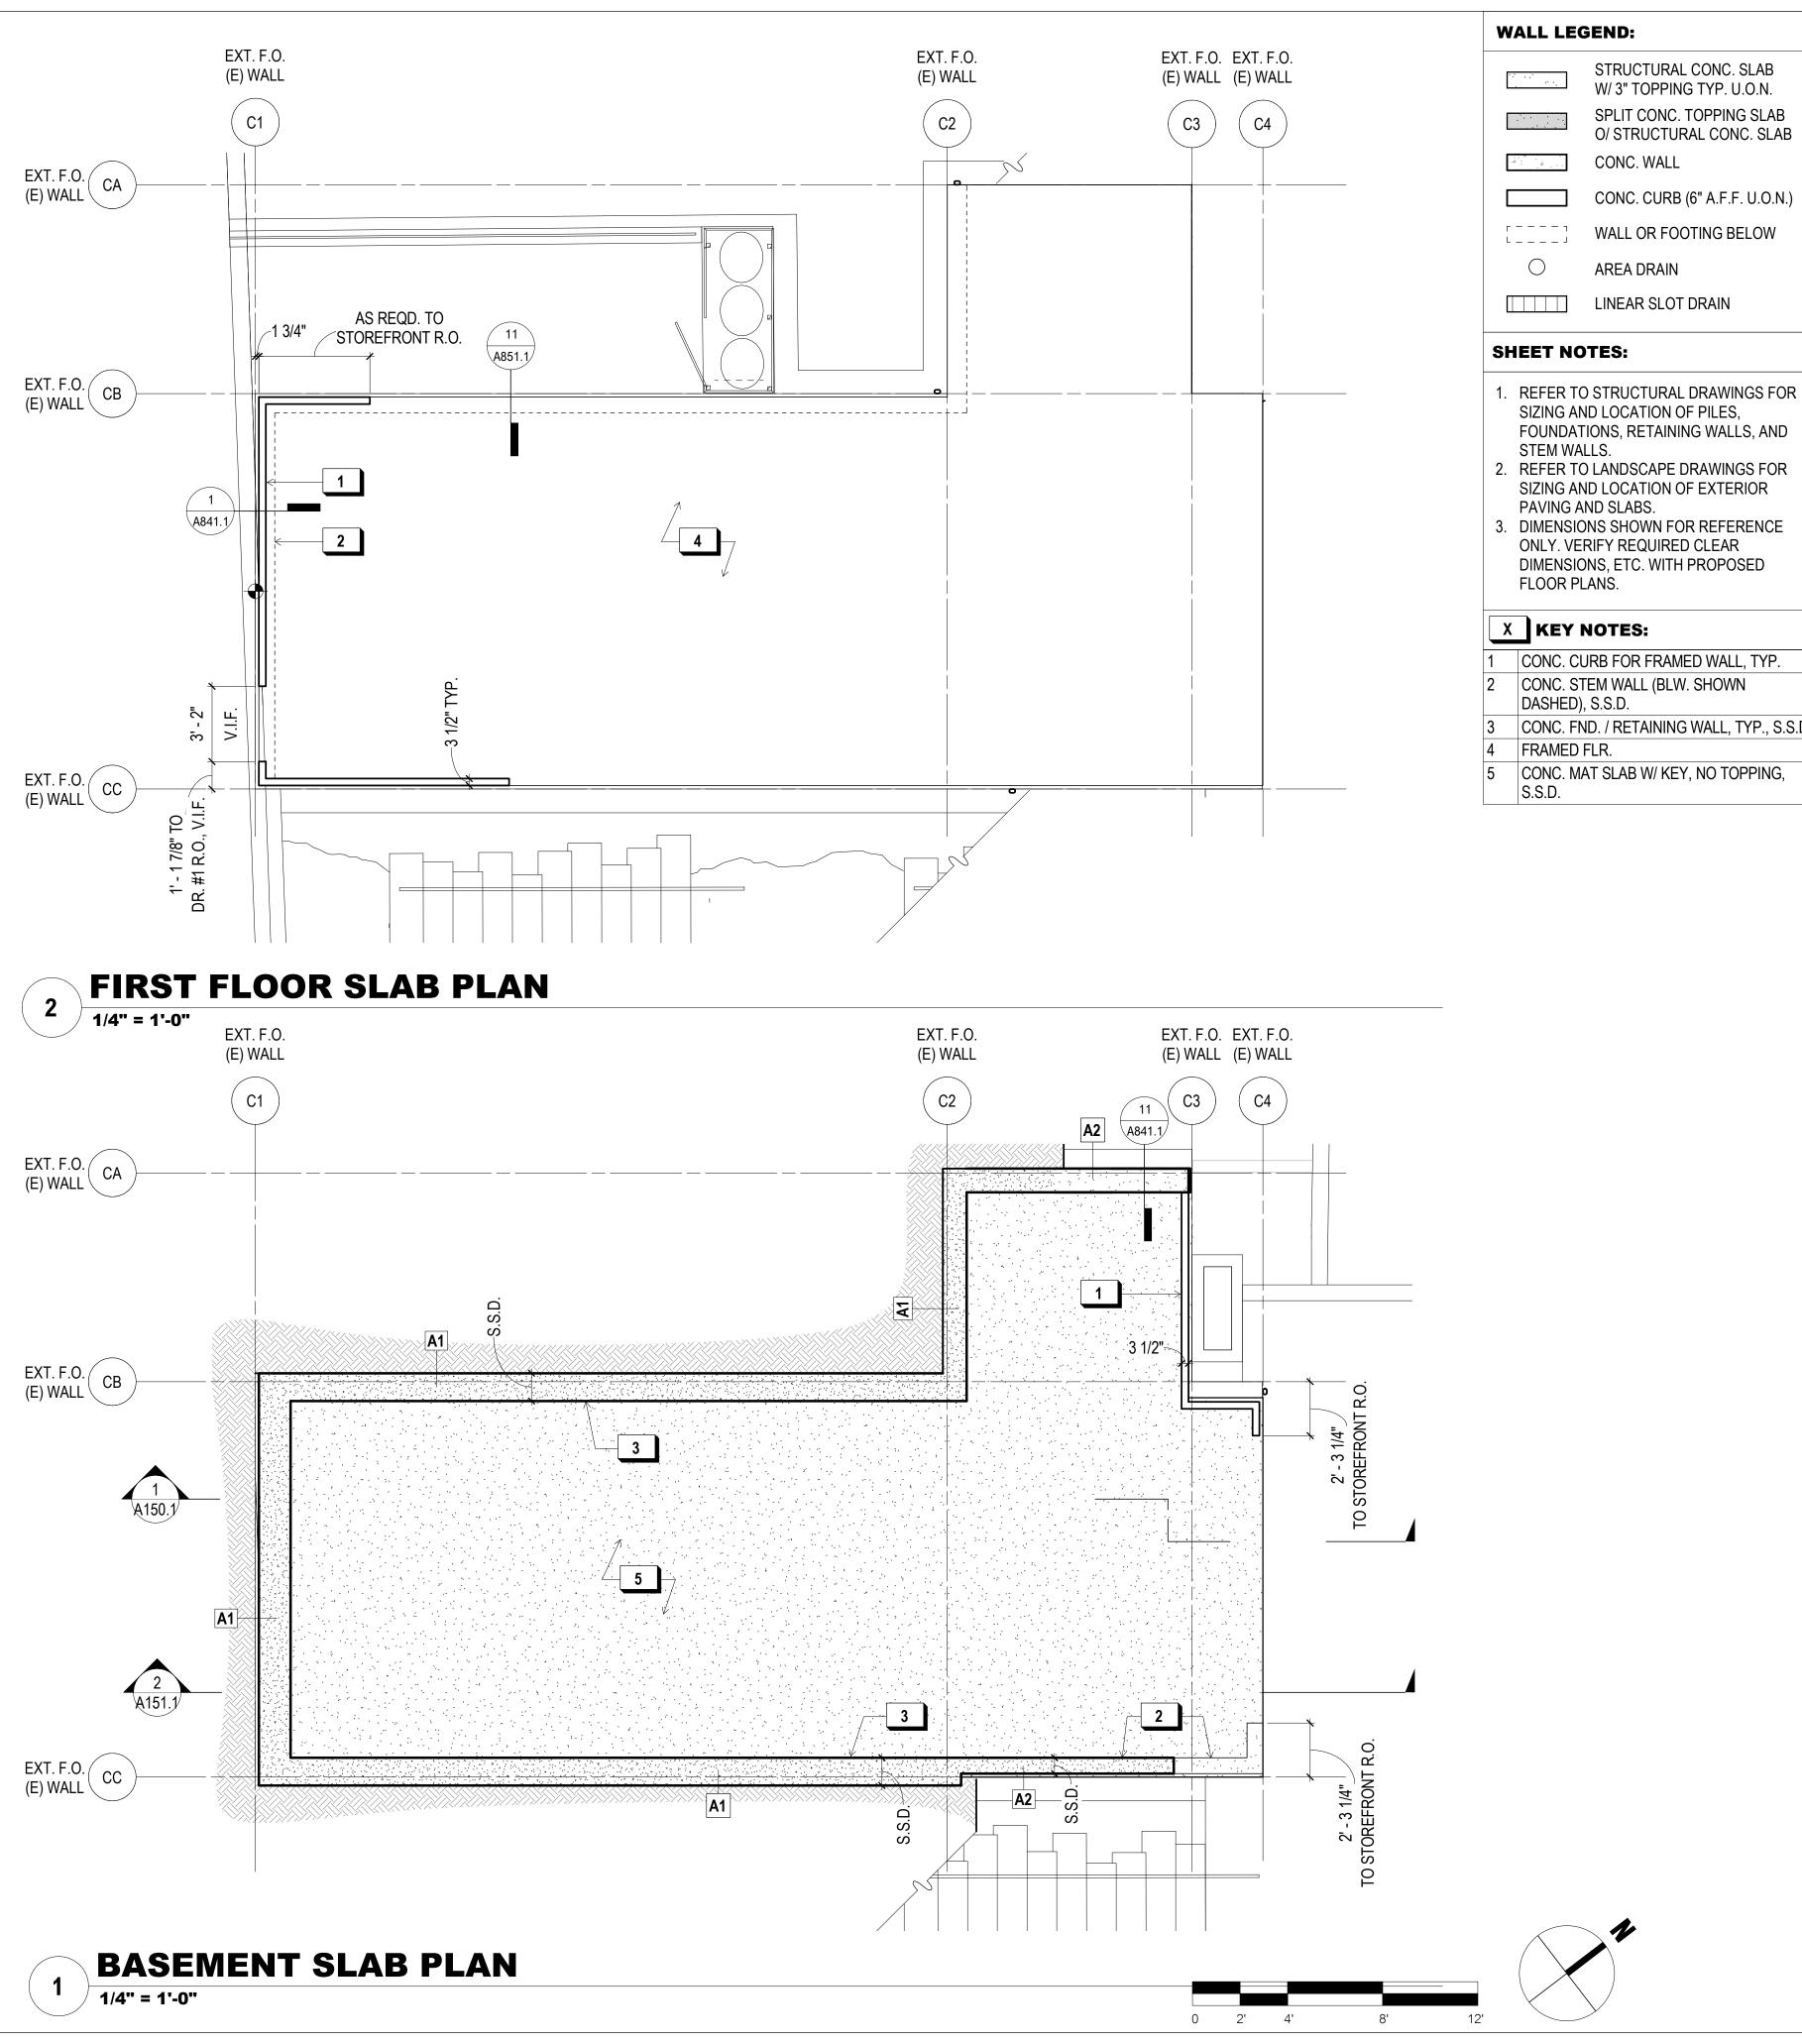SPLIT CONC. TOPPING SLAB O/ STRUCTURAL CONC. SLAB

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THE TRUST FOR PUBLIC LAND 101 MONTGOMERY STREET SUITE 900 SAN FRANCISCO, CA 94104 PH. 415-495-4014



PRIME CONSULTANT / LANDSCAPE ARCHITECT GUSTAFSON GUTHRIE NICHOL

CIVIL ENGINEER SHERWOOD DESIGN ENGINEERS PH. 415-348-9650

ECOLOGICAL RESTORATION 2. REFER TO LANDSCAPE DRAWINGS FOR RANA CREEK SIZING AND LOCATION OF EXTERIOR PAVING AND SLABS.

DIMENSIONS SHOWN FOR REFERENCE ONLY. VERIFY REQUIRED CLEAR DIMENSIONS, ETC. WITH PROPOSED FLOOR PLANS.

CONC. WALL

AREA DRAIN

CONC. CURB (6" A.F.F. U.O.N.)

WALL OR FOOTING BELOW

LINEAR SLOT DRAIN

X KEY NOTES:

CONC. CURB FOR FRAMED WALL, TYP. CONC. STEM WALL (BLW. SHOWN

DASHED), S.S.D. CONC. FND. / RETAINING WALL, TYP., S.S.D.

FRAMED FLR.

PH. 206-903-6802

ARCHITECT JENSEN ARCHITECTS PH. 415-348-9650

PH. 831-659-3820 STRUCTURAL ENGINEER JON BRODY STRUCTURAL ENGINEERS PH. 415-296-9494

COASTAL ENGINEER MOFFATT AND NICHOL PH. 925-944-5411 LIGHTING NITEO CALIFORNIA


PH. 415-666-2232 MEP & IT INTERFACE ENGINEERING PH. 415-489-7240 GEOTECHNICAL ENGINEER

AGS, INC PH. 415-957-9240 SECURITY CONSULTANT ZBETA CONSULTING

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KEY PLAN



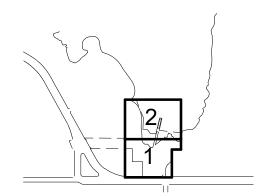

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SHIPWRIGHT'S COTTAGE -SLAB PLANS


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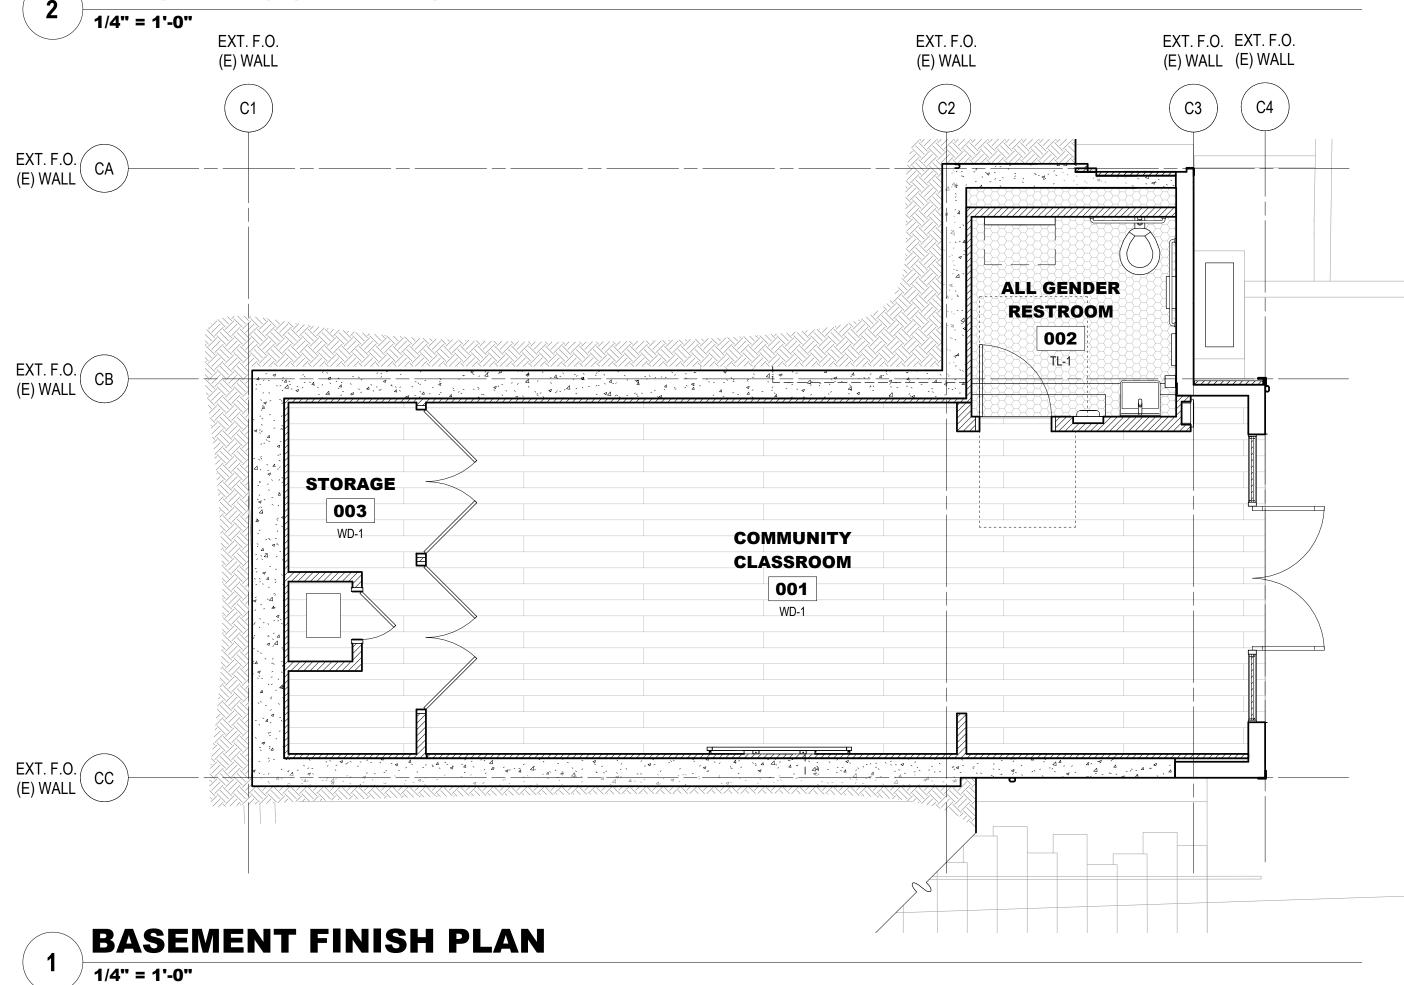
ROOM FINISH SCHEDULE						
ROOM		FINISH				
NO.	ROOM	FLOOR	BASE	WALL	CEILING	REMARKS
001	COMMUNITY CLASSROOM	WD-1	WB-1	WP-1 / PT-1	PT-1	
002	ALL GENDER RESTROOM	TL-1	TL-2	TL-2	PT-1	
003	STORAGE	WD-1	WB-1	PT-1	PT-1	
004	MECH. CLOSET	WD-1				
101	WELCOME CENTER	WD-2	WB-1	PT-1	WC-1	PT. TO MATCH PT-1
102	ALL GENDER RESTROOM	TL-1	TB-1	TL-2	PT-1	
103	OFFICE	WD-2	WB-1	PT-1	ACT-1	
104	IT CLOSET	WD-2	WB-1	PT-1	PT-1	

FIN	NISH	LE	GEN	1[
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	I IIIIOII EEGEIIO						
FINISH	DECODIDATION	MANUEACTURER	DDODUCT	6175	SPECIES /	FINICII	
CODE	DESCRIPTION	MANUFACTURER	PRODUCT	SIZE	COLOR	FINISH	
PT-1	PTD. GYP. BD.	BENJAMIN MOORE	AURA	NA	SUPER WHITE	MATTE	
TB-1	COVER BASE - METAL	SCHLUTER	DILEX-AHK	8 MM	NA	SATIN	
TL-1	PORCELAIN TILE	DALTILE	KEYSTONES	AS SHOWN	COLOR TBD	NA	
TL-2	CERAMIC TILE	DALTILE	COLOR WHEEL	AS SHOWN	COLOR TBD	NA	
WB-1	WOOD BASE	NA	NA	4"	PAINT GRADE	PTD.	
WB-2	WOOD BASE	SAROYAN	NA	4"	PRE-FINISHED	PTD.	
WC-1	WOOD CEILING	SALVAGED	NA	VARIES	VARIES	PER SPEC	
WD-1	WOOD FLOOR	SAROYAN	TREE SMART	8" PLANK	WHITE OAK	PRE-FINISHED	
WD-2	WOOD FLOOR	SAROYAN	TREE SMART	8" PLANK	WHITE OAK	BONA TRAFFIC	
						HD	
WP-1	ACOUSTIC PANELS	KIREI	ECOPANEL	AS SHOWN	COLOR TBD	NA	



FIRST FLOOR FINISH FLAN

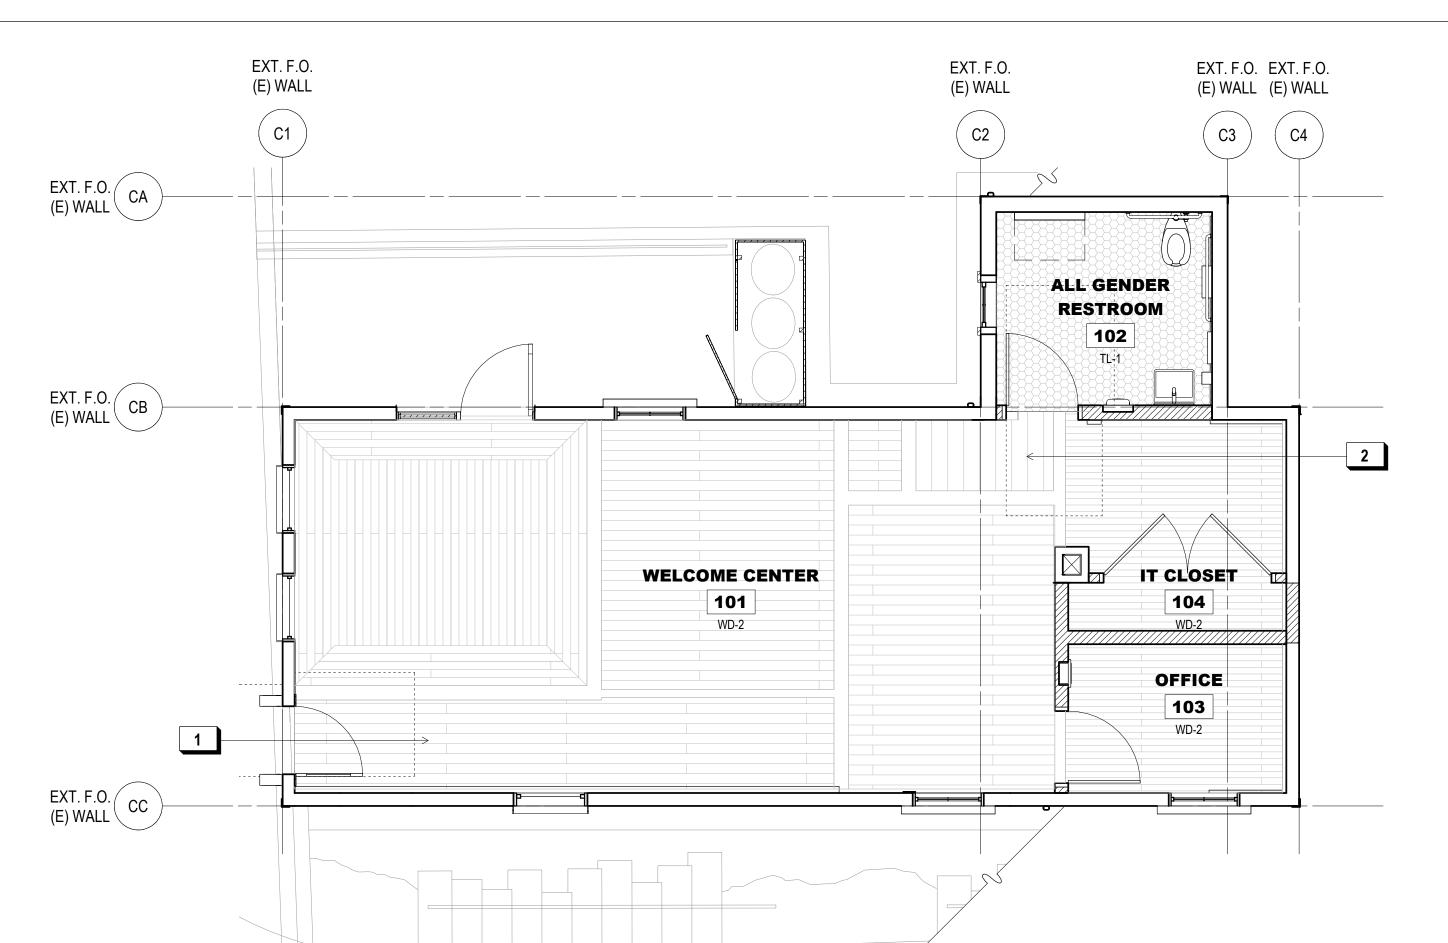


X KEY NOTES:

1 SALVAGE AND RESTORE HISTORIC WOOD FLOORING FOR REINSTALLATION, S.H.A.D. AND SPECIFICATIONS FOR DETAILS

2 INTERPRETIVE FLOORING DETAIL @
HISTORIC STAIR. SALVAGE EXTANT TREAD
MATERIAL AND MILL TO MATCH HISTORIC
FLOORING THICKNESS. INSTALL FLOORING
@ HISTORIC INTERIOR STAIR LOCATION,
CLEAR SEAL

900 INNES PARK DEVELOPMENT

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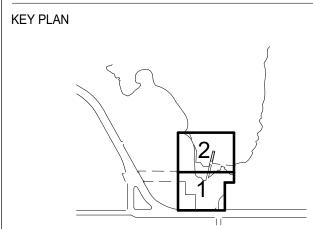
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THE TRUST FOR PUBLIC LAND
101 MONTGOMERY STREET
SUITE 900
SAN FRANCISCO, CA 94104

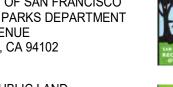

PH. 415-495-4014 PRIME CONSULTANT / LANDSCAPE ARCHITECT GUSTAFSON GUTHRIE NICHOL PH. 206-903-6802 CIVIL ENGINEER SHERWOOD DESIGN ENGINEERS PH. 415-348-9650 ARCHITECT JENSEN ARCHITECTS PH. 415-348-9650 ECOLOGICAL RESTORATION RANA CREEK PH. 831-659-3820 STRUCTURAL ENGINEER JON BRODY STRUCTURAL ENGINEERS PH. 415-296-9494 COASTAL ENGINEER MOFFATT AND NICHOL PH. 925-944-5411 LIGHTING NITEO CALIFORNIA PH. 415-666-2232 MEP & IT INTERFACE ENGINEERING PH. 415-489-7240 GEOTECHNICAL ENGINEER AGS, INC PH. 415-957-9240 SECURITY CONSULTANT ZBETA CONSULTING PH. 415-259-0422

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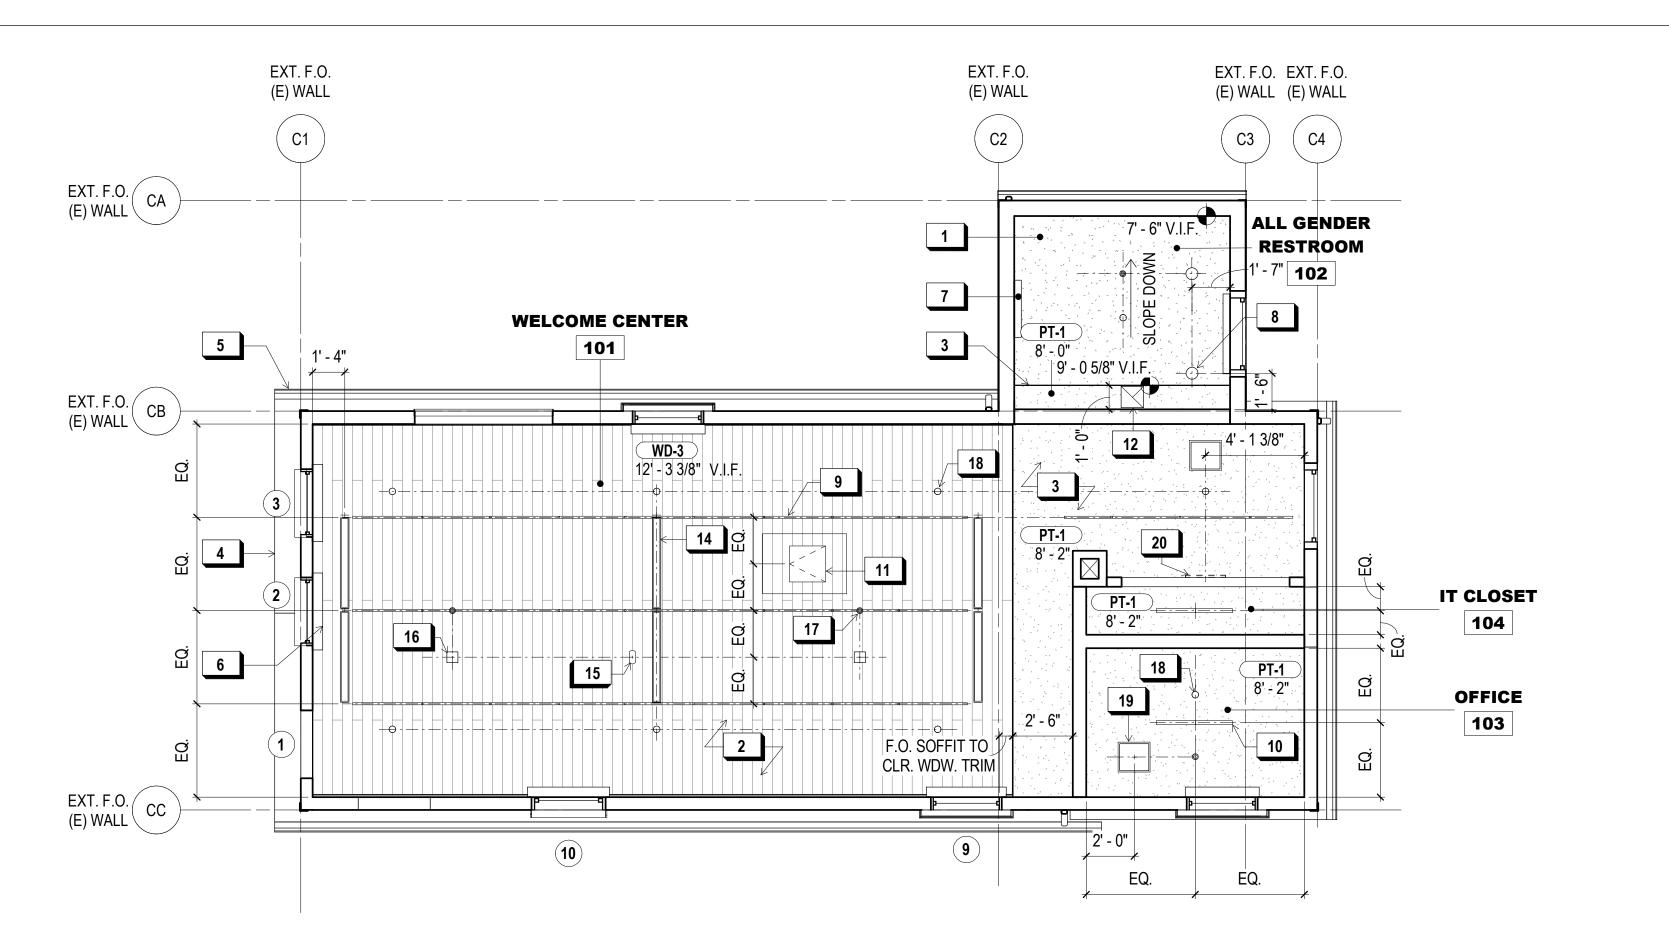
SHIPWRIGHT'S COTTAGE - FINISH PLANS


JENSEN

7/01/2021

A123.1

GGN PROJECT #



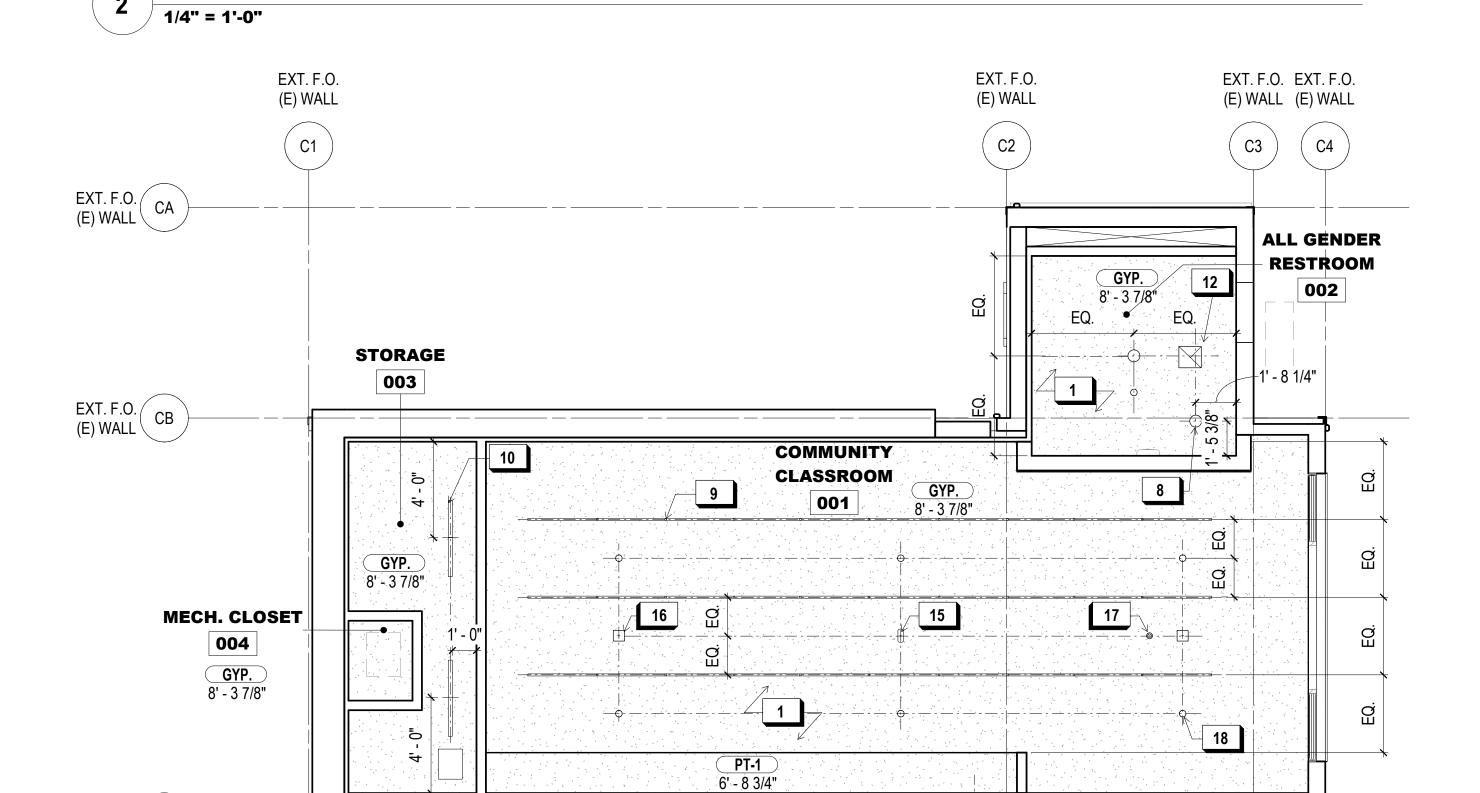

13 - G

BASEMENT REFLECTED CEILING PLAN 1/4" = 1'-0"

EXT. F.O. (CC (E) WALL

FIRST FLOOR REFLECTED CEILING PLAN



- SEE LIGHTING DESIGNER DRAWINGS AND ELECTRICAL DRAWINGS FOR LIGHTING LAYOUT
- 2. DESIGN BUILD FIRE SUPPRESSION SYSTEMS TO BE COORDINATED WITH ARCHITECT AND LIGHTING CONSULTANT

X KEY NOTES:

- FIN. DIRECTLY ATTACHED TO ROOF OR
- (E) WD. FIN. O/ (N) SHTG., S.H.A.D.
- GYP. BD. SOFFIT, TYP.
- ROOF BEYOND
- S.S. GUTTER, PTD., TYP. SURFACE MOUNTED ROLLER SHADE,
- EXP. SURFACE MTD. MANUAL SHADE


MANUAL, TYP. AT ALL WINDOWS

- ROLL, TYP. OF 2.
- TRIMLESS WET DOWNLIGHT
- GALLERY TRACK LIGHTING 10 BOH LINEAR LIGHT
- 11 FCU ACCESS PANEL
- 12 RESTROOM EXHAUST VENT, S.M.D.
- 13 OUTSIDE AIR INTAKE BEYOND, S.M.D. 14 SUPPLY AIR LINEAR DIFFUSER, S.M.D.
- 15 CEILING MOUNTED WIRELESS ACCESS POINT, S.E.D.
- 16 CEILING MOUNTED OCCUPANCY SENSOR S.E.D.
- 17 | CEILING MOUNTED MOTION DETECTOR,
- 18 | CONCEALED SPRINKLER HEAD, TYP.
- ABV.

900 INNES

PARK DEVELOPMENT

CITY AND COUNTY OF SAN FRANCISCO RECREATION AND PARKS DEPARTMENT 30 VAN NESS AVENUE

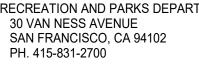

THE TRUST FOR PUBLIC LAND 101 MONTGOMERY STREET SUITE 900 SAN FRANCISCO, CA 94104 PH. 415-495-4014

PRIME CONSULTANT / LANDSCAPE ARCHITECT

STRUCTURAL ENGINEER JON BRODY STRUCTURAL ENGINEERS PH. 415-296-9494

MOFFATT AND NICHOL PH. 925-944-5411 LIGHTING

MEP & IT

- TYP., S.U.D.
- 19 RETURN AIR GRILL 20 SUPPLY AIR LINEAT DIFFUSER, WALL MTD.

GUSTAFSON GUTHRIE NICHOL PH. 206-903-6802 CIVIL ENGINEER SHERWOOD DESIGN ENGINEERS PH. 415-348-9650 ARCHITECT JENSEN ARCHITECTS PH. 415-348-9650 ECOLOGICAL RESTORATION RANA CREEK PH. 831-659-3820 COASTAL ENGINEER NITEO CALIFORNIA PH. 415-666-2232 INTERFACE ENGINEERING PH. 415-489-7240 GEOTECHNICAL ENGINEER

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PH. 415-957-9240

SECURITY CONSULTANT

ZBETA CONSULTING

AGS, INC

KEY PLAN 2/



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PERMIT SUBMITTAL

ISSUANCE


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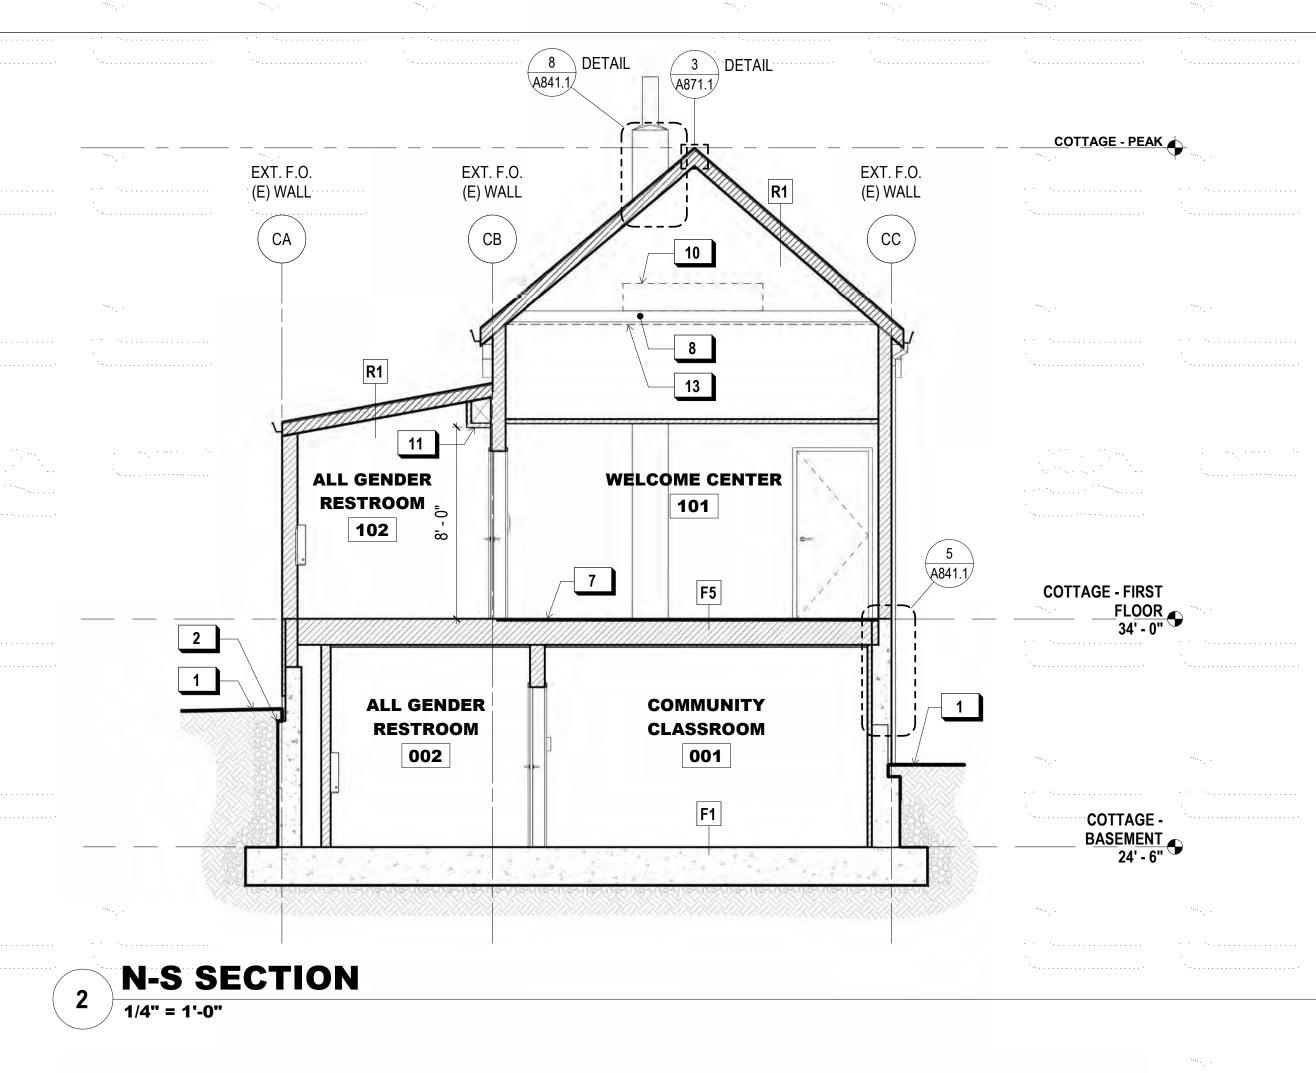
BID SET DRAWN BY CHECKED BY **JENSEN**


GGN PROJECT # 7/01/2021 1608

SHIPWRIGHT'S COTTAGE -**RCPS**

A130.1



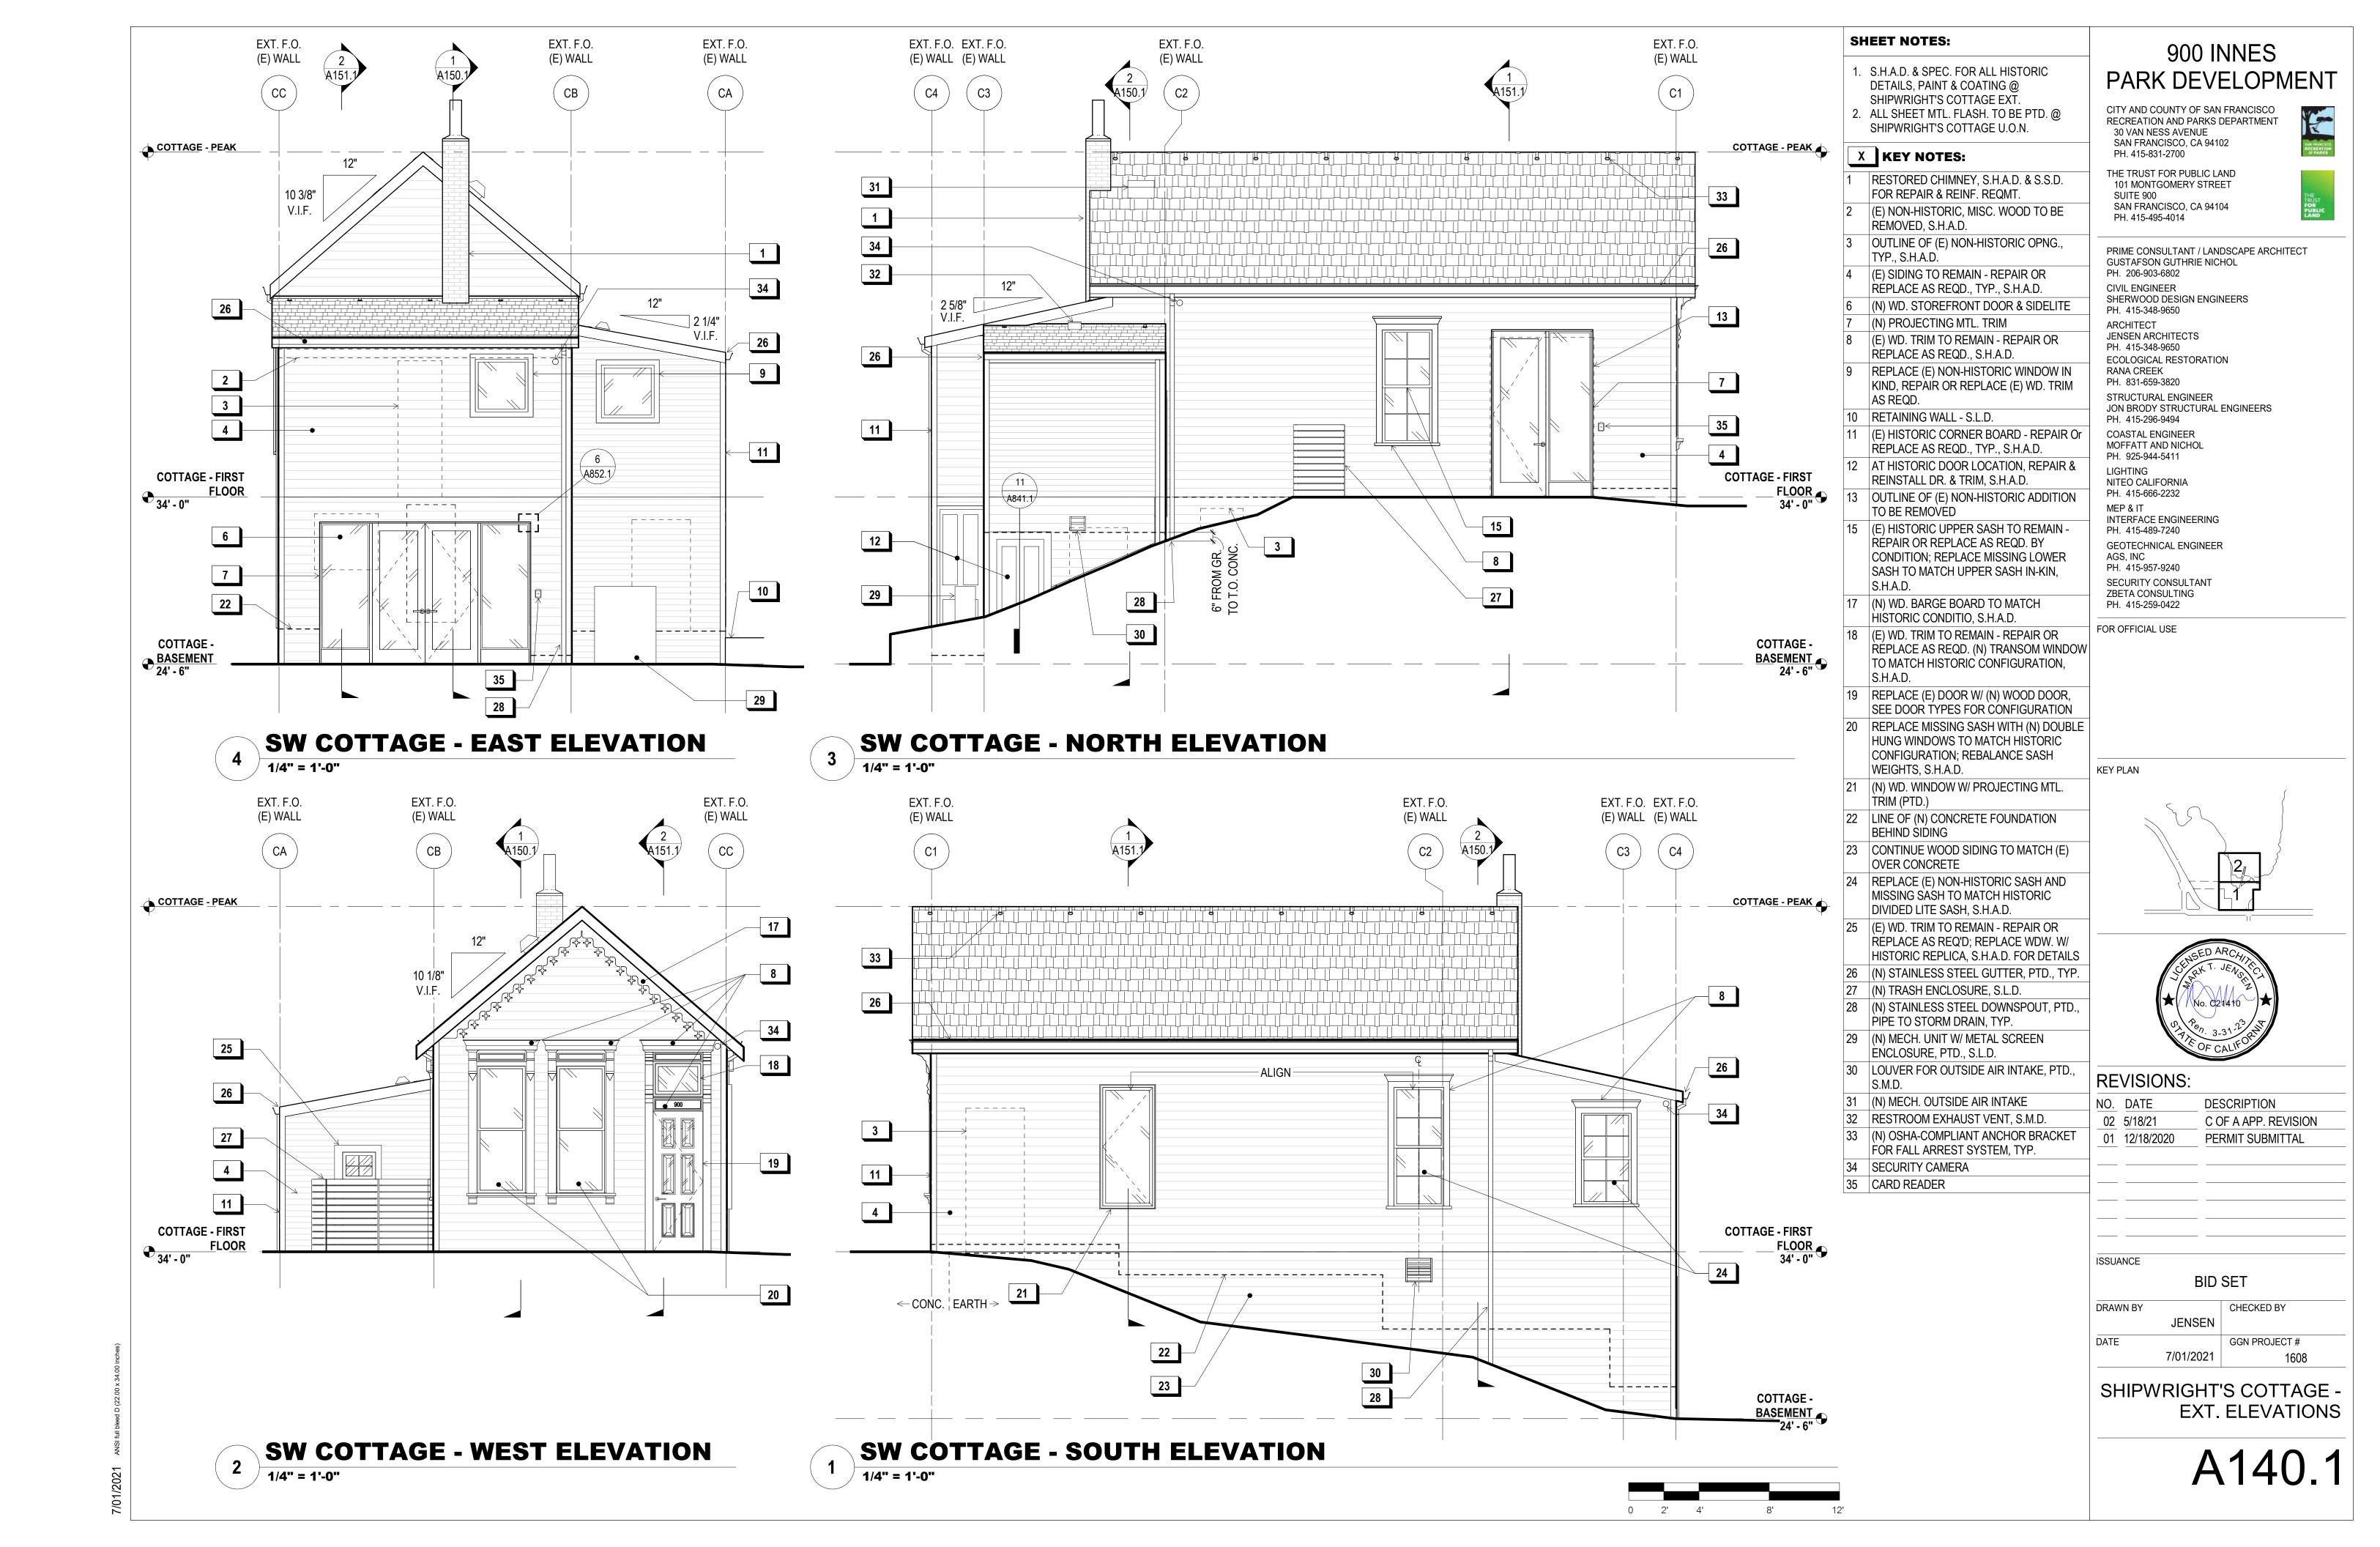

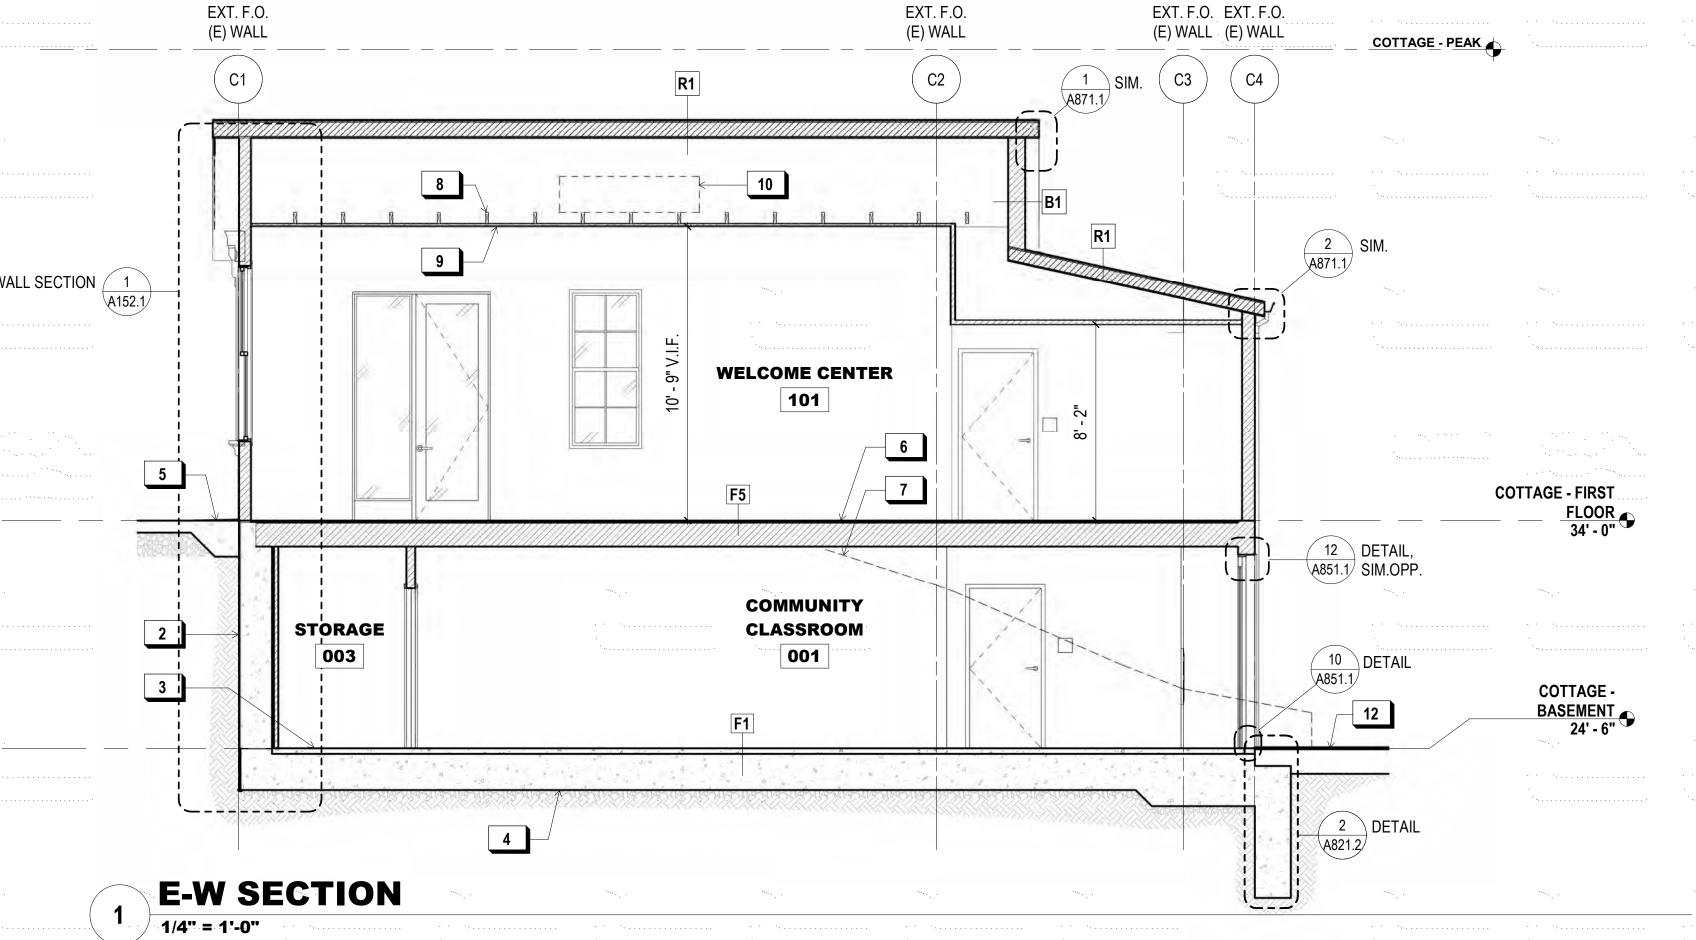

SHEET NOTES: 1. SEE SHEET A811.1 FOR FLOOR AND ROOF ASSEMBLIES. 900 INNES PARK DEVELOPMENT

X KEY NOTES:

PLANTING AREA, S.L.D.

FINISHED FLOOR LEVEL

LINE OF GRADE BEYOND

RAFTER TIE, V.I.F., S.S.D.

1-1/2" WD. MAX. FR. DEPTH

RAFTER TIES

10 FAN COIL UNIT, S.M.D.

12 WD. DECKING, S.L.D.

13 LINE OF WD. CLG. BEHIND

(N) CONC. MAT SLAB, S.S.D.

SIDEWALK, SEE CIVIL DWGS.

(N) CONC. STEM & RETAINING WALL, S.S.D.

REMOVE (E) FLOOR FINISHES, REPAIR (E) FLOOR AND FRAMING AS REQ'D., REFINISH

(E) WD. FIN. INSTALLED O/ (N) SHTG. @

11 SOFFIT FOR E.F., S.M.D. 1-5/8" MTL. TEE OR

ADDTL. EXCAVATION REQ'D FOR (N)

CITY AND COUNTY OF SAN FRANCISCO RECREATION AND PARKS DEPARTMENT 30 VAN NESS AVENUE



PH. 415-831-2700

THE TRUST FOR PUBLIC LAND
101 MONTGOMERY STREET
SUITE 900
SAN FRANCISCO, CA 94104

PH. 415-495-4014

SAN FRANCISCO, CA 94102



PRIME CONSULTANT / LANDSCAPE ARCHITECT GUSTAFSON GUTHRIE NICHOL PH. 206-903-6802 CIVIL ENGINEER

SHERWOOD DESIGN ENGINEERS
PH. 415-348-9650

ARCHITECT
JENSEN ARCHITECTS

PH. 415-348-9650 ECOLOGICAL RESTORATION RANA CREEK PH. 831-659-3820 STRUCTURAL ENGINEER


JON BRODY STRUCTURAL ENGINEERS
PH. 415-296-9494
COASTAL ENGINEER
MOFFATT AND NICHOL


PH. 925-944-5411
LIGHTING
NITEO CALIFORNIA
PH. 415-666-2232
MEP & IT
INTERFACE ENGINEERING

PH. 415-489-7240
GEOTECHNICAL ENGINEER
AGS, INC
PH. 415-957-9240
SECURITY CONSULTANT
ZBETA CONSULTING
PH. 415-259-0422

FOR OFFICIAL USE

KEY PLAN

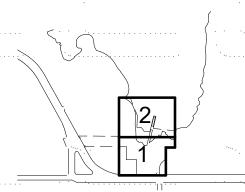

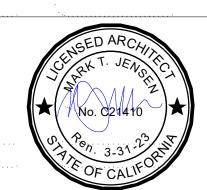

REVISIONS:

NO. DATE DESCRIPTION
O1 12/18/2020 PERMIT SUBMITTAL

ISSUANCE

BID SET

DRAWN BY


JENSEN

GGN PROJECT # 7/01/2021 1608

CHECKED BY

SHIPWRIGHT'S COTTAGE -SECTIONS

A150.1

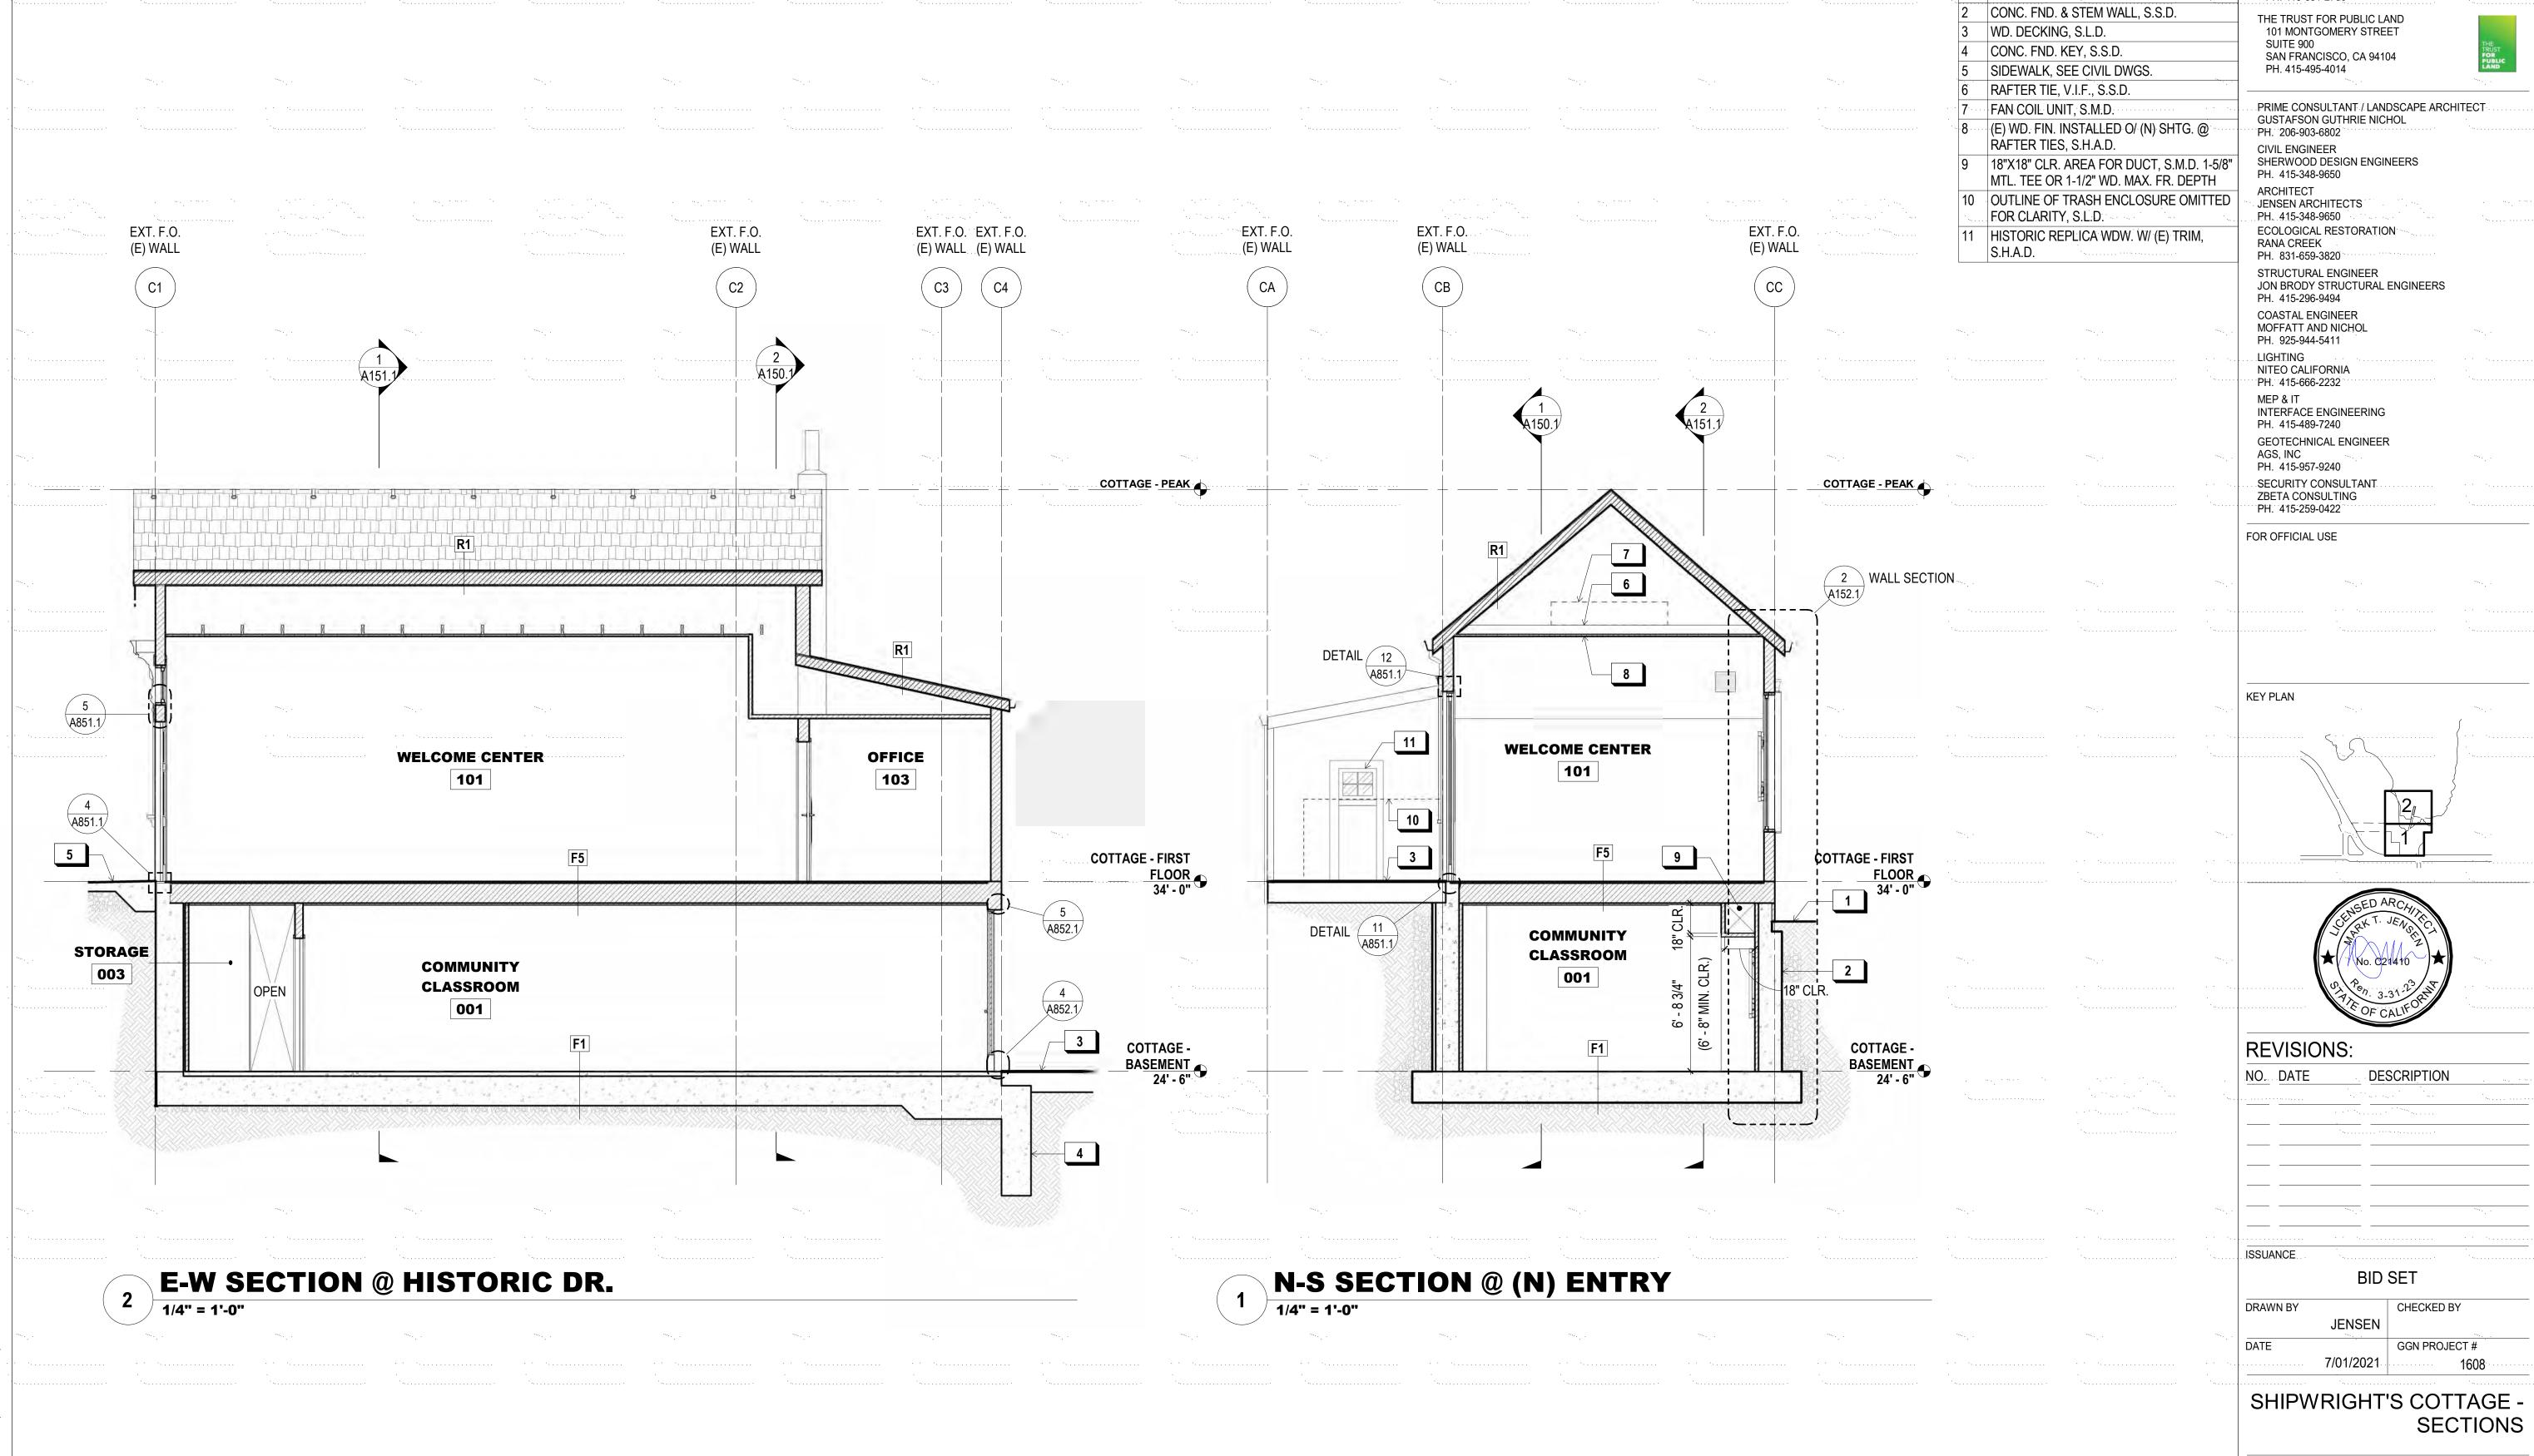

900 INNES PARK DEVELOPMENT

CITY AND COUNTY OF SAN FRANCISCO

SHEET NOTES:

ASSEMBLIES.

X KEY NOTES:

PLANTING STRIP, S.L.D.


1. SEE SHEET A811.1 FOR FLOOR AND ROOF

RECREATION AND PARKS DEPARTMENT 30 VAN NESS AVENUE SAN FRANCISCO, CA 94102


PH. 415-831-2700



A151.1

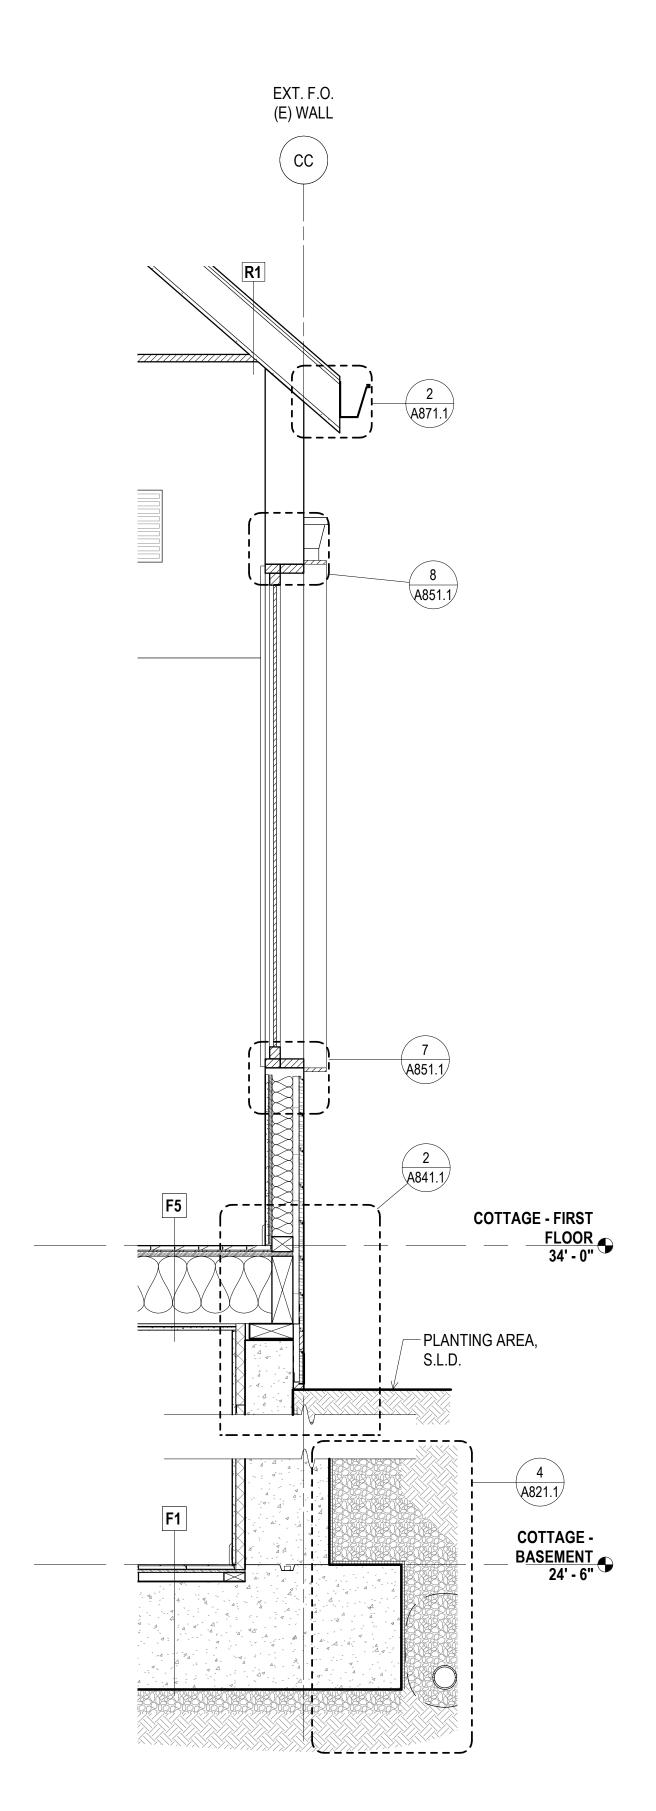



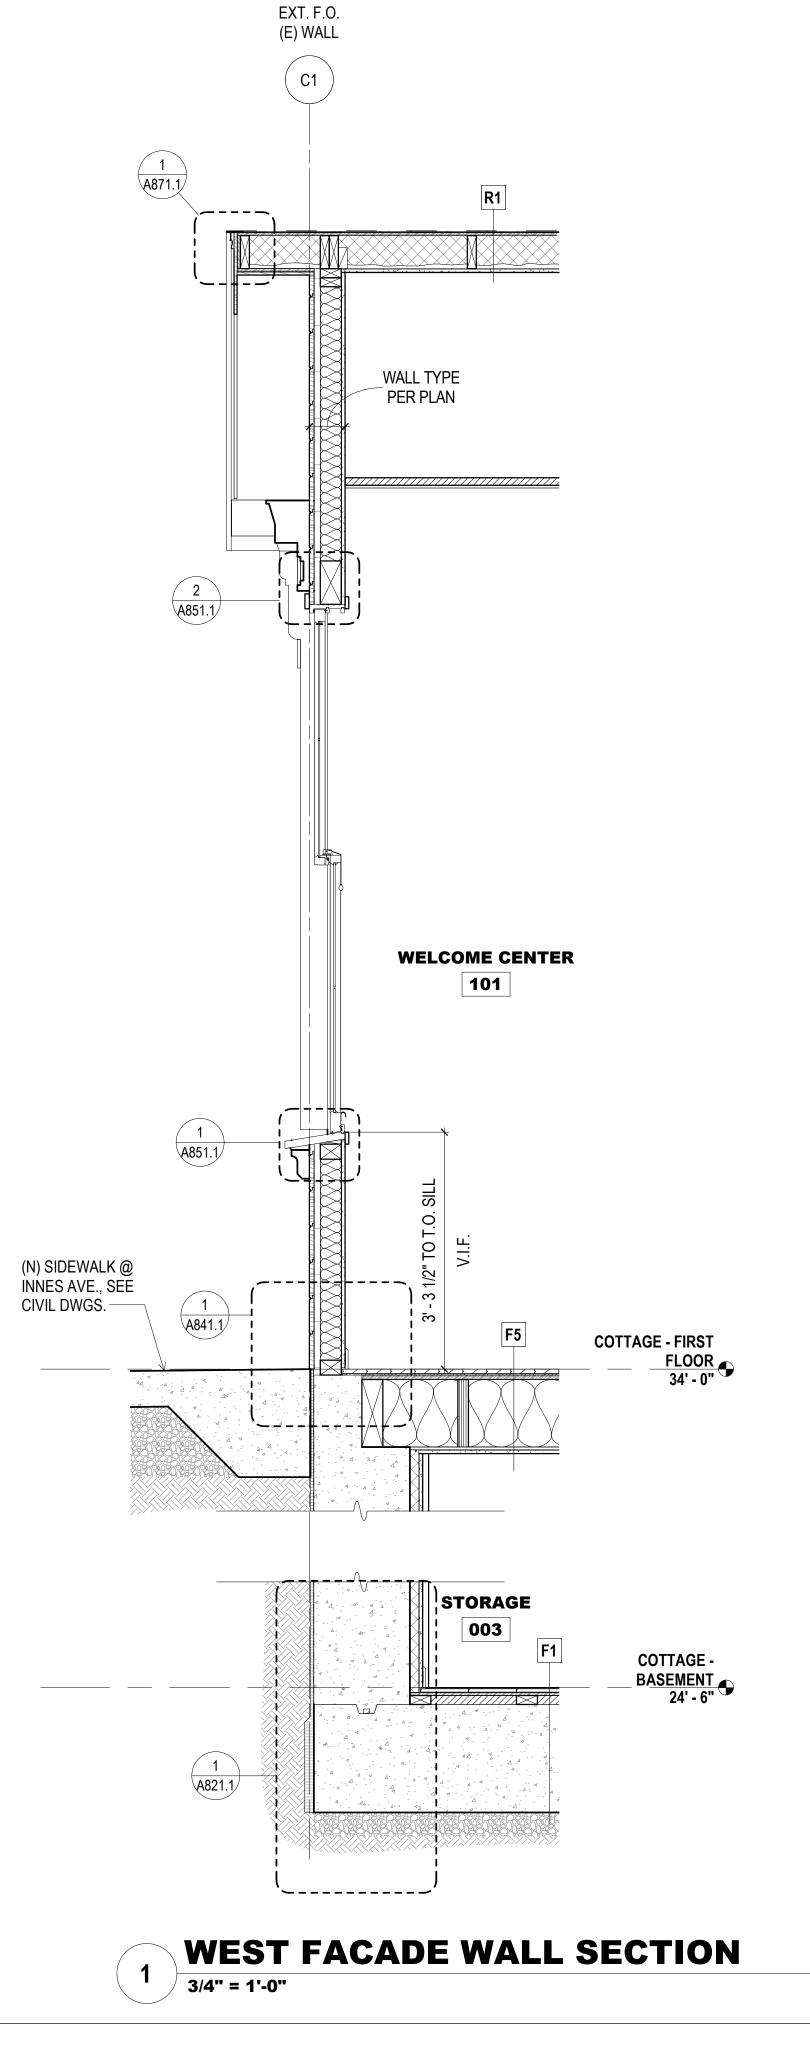

900 INNES PARK DEVELOPMENT

CITY AND COUNTY OF SAN FRANCISCO RECREATION AND PARKS DEPARTMENT 30 VAN NESS AVENUE SAN FRANCISCO, CA 94102


30 VAN NESS AVENUE SAN FRANCISCO, CA 94102 PH. 415-831-2700 THE TRUST FOR PUBLIC LAND

THE TRUST FOR PUBLIC LAND 101 MONTGOMERY STREET SUITE 900 SAN FRANCISCO, CA 94104 PH. 415-495-4014



PRIME CONSULTANT / LANDSCAPE ARCHITECT GUSTAFSON GUTHRIE NICHOL PH. 206-903-6802 CIVIL ENGINEER SHERWOOD DESIGN ENGINEERS PH. 415-348-9650 ARCHITECT JENSEN ARCHITECTS PH. 415-348-9650 ECOLOGICAL RESTORATION RANA CREEK PH. 831-659-3820 STRUCTURAL ENGINEER JON BRODY STRUCTURAL ENGINEERS PH. 415-296-9494 COASTAL ENGINEER MOFFATT AND NICHOL PH. 925-944-5411 LIGHTING NITEO CALIFORNIA PH. 415-666-2232 MEP & IT INTERFACE ENGINEERING PH. 415-489-7240 GEOTECHNICAL ENGINEER AGS, INC PH. 415-957-9240 SECURITY CONSULTANT ZBETA CONSULTING PH. 415-259-0422

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NO. DATE	DESCRIPTION
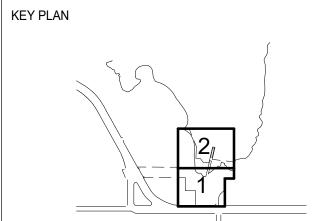
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DATE

7/01/2021


CHECKED BY

GGN PROJECT #

1608

SHIPWRIGHTS COTTAGE - WALL SECTIONS


A152.1

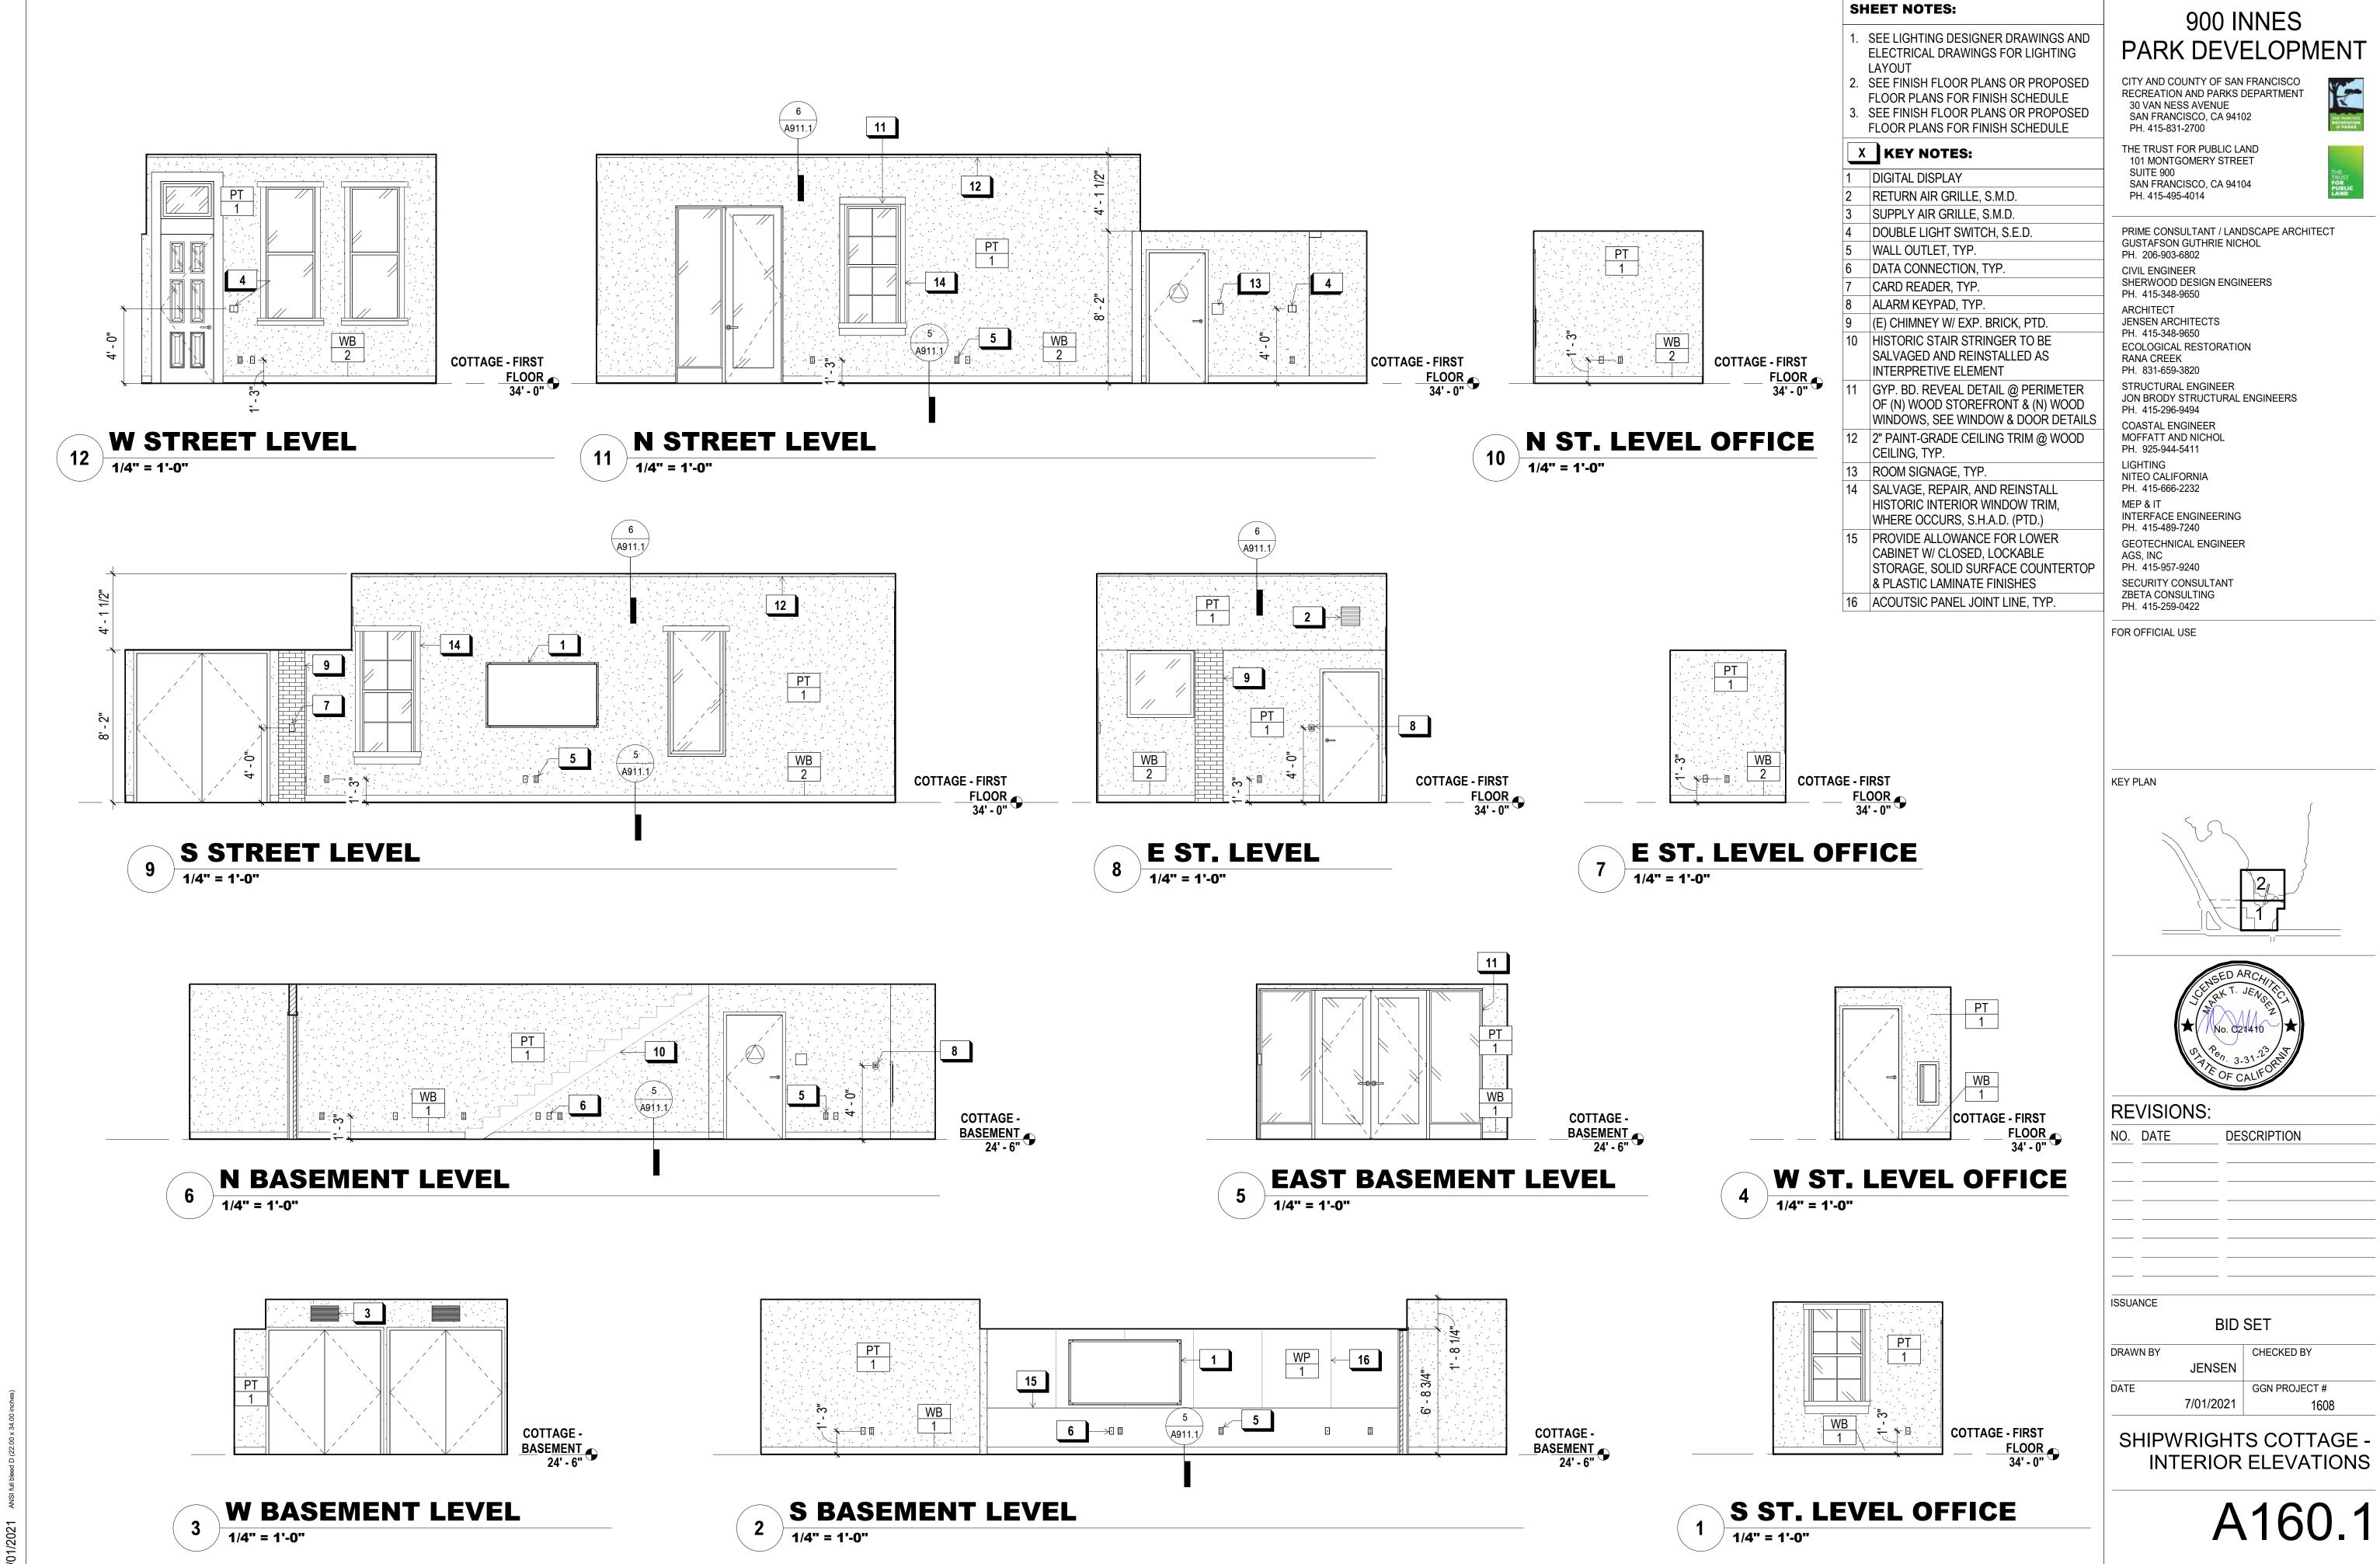

PLUMBING FIXTURE / ACCESSORIES LEGEND						
TAG MANUFACTURER MODEL DESCRIPTION						
LAV-1	AMERICAN STANDARD	DECORUM 9134001EC	WALL HUNG SINK			
LAV-2	AMERICAN STANDARD	WHEELCHAIR USERS 9141	WALL HUNG SINK			
LAV-3	AMERICAN STANDARD	OVALYN 0495	UNDERCOUNTER SINK			
WC-1	AMERICAN STANDARD	AFWALL MILLENNIUM FLOWISE ELONGATED FLUSHOMETER	WALL HUNG TOILET			
WC-2	AMERICAN STANDARD	MADERA FLOWISE FLUSHOMETER	FLOOR MOUNTED TOILET			
SP-1	GEORGIA PACIFIC	GP MANUAL 53053	MANUAL SOAP DISPENSER			
TA-1	XLERATOR	XL - BW - VOLTAGE	RECESSED HAND DRYER			
TA-2	THINAIR	TA-SB	WALL MOUNTED HAND DRYER			
SK-1	AMERICAN STANDARD	LAKEWELL SERVICE SINK - 7692	SERVICE MOP LINK			
SF-1	CHICAGO FAUCETS	807-E12-665PAB	SINGLE-INLET METERING FAUCET			
SF-2	CHICAGO FAUCETS	1100-GNAE35-369AB	MANUAL SINK FAUCET			

CT-1	KOALA KARE	KB112-01RE	RECESSED MTD. CHANGING TABLE
CT-2	KOALA KARE	KB110-SSWM	WALL MTD. CHANGING TABLE
GB-1	BOBRICK	B-6806	STAINLESS STL. GRAB BARS
TP-1	BOBRICK	B-2840	TOILET PAPER HOLDER
TD-1	BOBRICK	B-221	TOILET SEAT COVER DISPENSER

*	9	9' - 0" V.I.F.	- ∤
	2' - 3" [©]	5' - 0" MIN. CLR.	
ALL GENDER RESTROOM 102	V. A172.1 S. S. 1'-	WC-2 WIN. CI.P. 6. WIN. CI.P.	GB-1 TP-1 TALL TALL TALL TALL TALL TALL TALL TAL
		4' - 0" N	

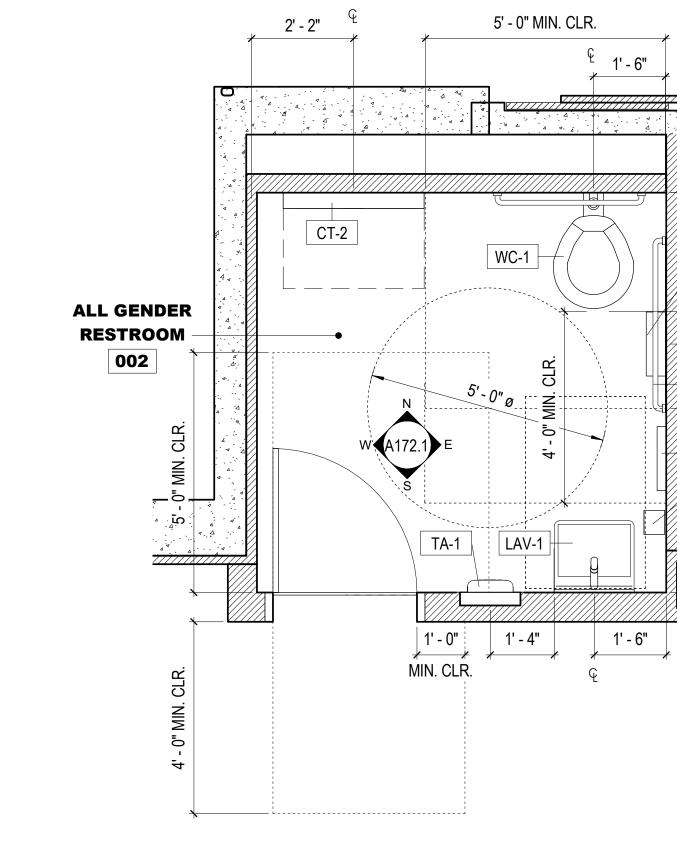

ALL GENDER RESTROOM 102 ENLARGED PLAN 1/2" = 1'-0"

ALL GENDER RESTROOM 107 ENLARGED PLAN 1/2" = 1'-0"

GB-1 -1

TSC-1

SHEET NOTES:

- 1. SEE DETAIL 1/A032.1 FOR TYP.
 ACCESSIBLE DOOR THRESHOLD AND
 LEVER REQUIREMENTS
- 2. SEE DETAIL 1/A033.1 FOR TYP.
 ACCESSIBLE DOOR CLEARANCE
- REQUIREMENTS

 3. SEE 3A AND 3B/A032.1 FOR TYP.
- RESTROOM DR. SIGNAGE DETAILS
 4. PROVIDE SHT. MTL. PL. O/ BLK. IN WALL
 BEHIND GRAB BARS & WALL-MTD. FIXT.,
 TYP. @ RESTROOMS
- 5. SEE FINISH FLOOR PLANS OR PROPOSED FLOOR PLANS FOR FINISH SCHEDULE

900 INNES PARK DEVELOPMENT

CITY AND COUNTY OF SAN FRANCISCO RECREATION AND PARKS DEPARTMENT 30 VAN NESS AVENUE SAN FRANCISCO, CA 94102



PH. 415-831-2700

THE TRUST FOR PUBLIC LAND
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SUITE 900
SAN FRANCISCO, CA 94104
PH. 415-495-4014



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FOR OFFICIAL USE

PH. 415-259-0422

KEY PLAN



RE	VISIONS:	
NO.	DATE	DESCRIPTION
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ISSUANCE

BID SET

DRAWN BY

JENSEN

SEN GGN PROJECT

TATE TOTAL GGN PROJECT # 1608

SHIPWRIGHT'S COTTAGE -

A171.1

ENLARGED PLANS

SHEET NOTES:


- SEE DETAIL 1/A032.1 FOR TYP. ACCESSIBLE DOOR THRESHOLD AND LEVER REQUIREMENTS
- 2. SEE DETAIL 1/A033.1 FOR TYP. ACCESSIBLE DOOR CLEARANCE
- REQUIREMENTS 3. SEE 3A AND 3B/A032.1 FOR TYP. RESTROOM DR. SIGNAGE DETAILS
- . PROVIDE SHT. MTL. PL. O/ BLK. IN WALL BEHIND GRAB BARS & WALL-MTD. FIXT., TYP. @ RESTROOMS
- 5. SEE FINISH FLOOR PLANS OR PROPOSED FLOOR PLANS FOR FINISH SCHEDULE


X KEY NOTES:


- OCCUPANCY SENSOR LIGHT SWITCH,
- CEILING SOFFIT

STAINLESS STEEL MIRROR S.S. COVE BASE TILE TRIM, TYP.


WALL OUTLET

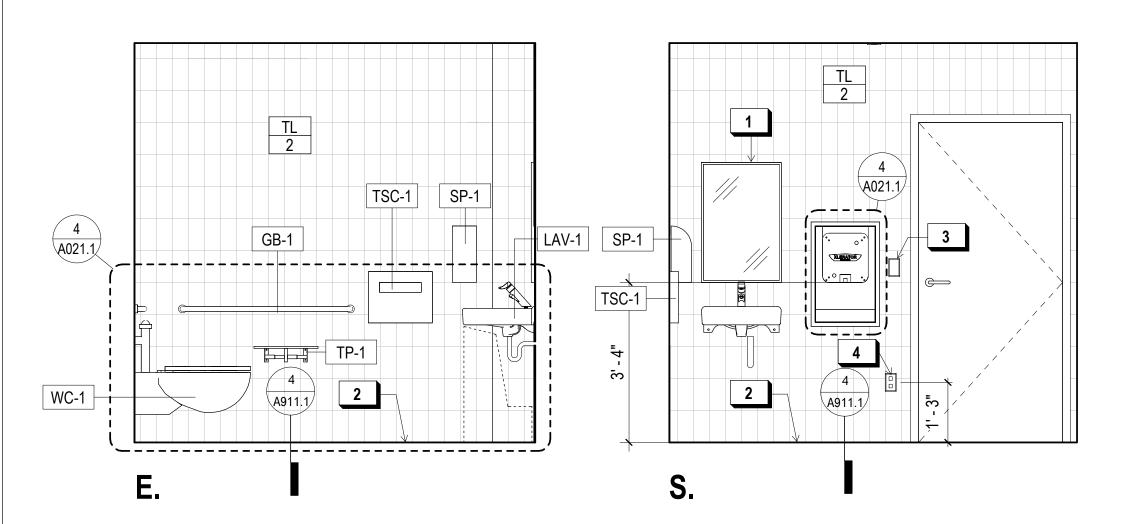


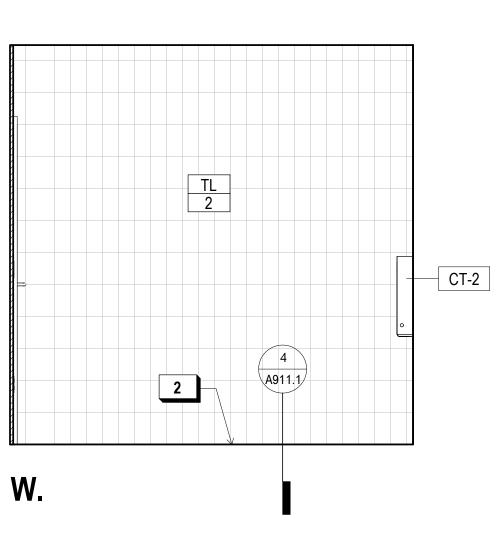


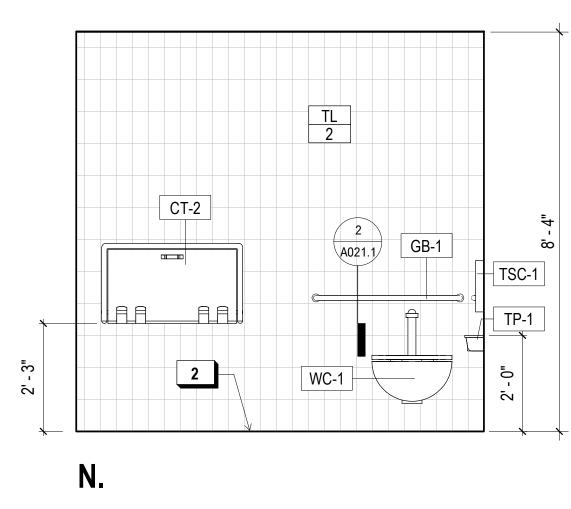


2 ALL GENDER RESTROOM 002 ENLARGED ELEVATIONS

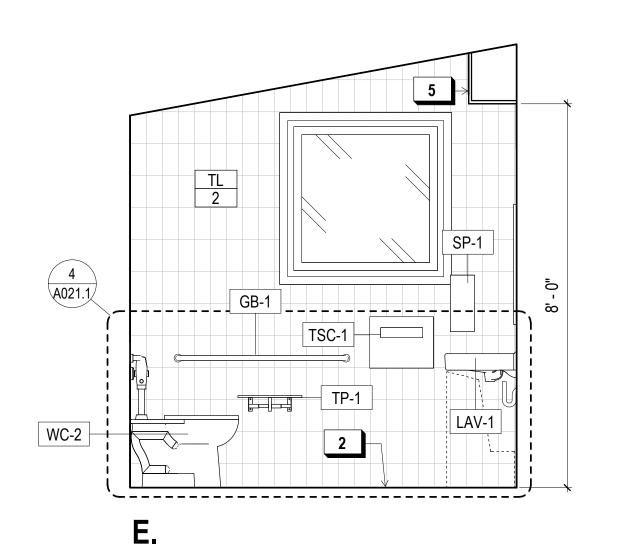

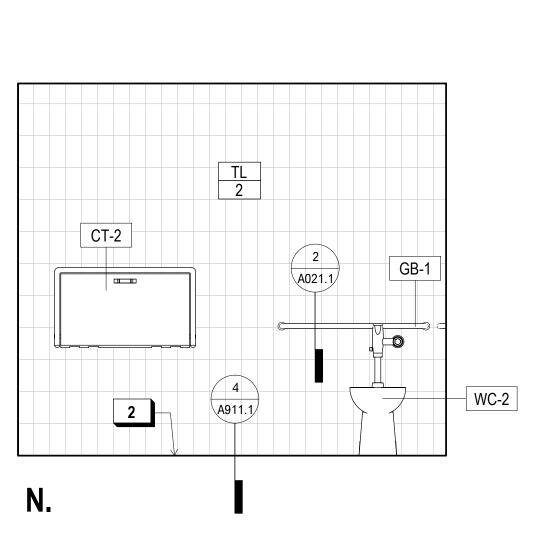

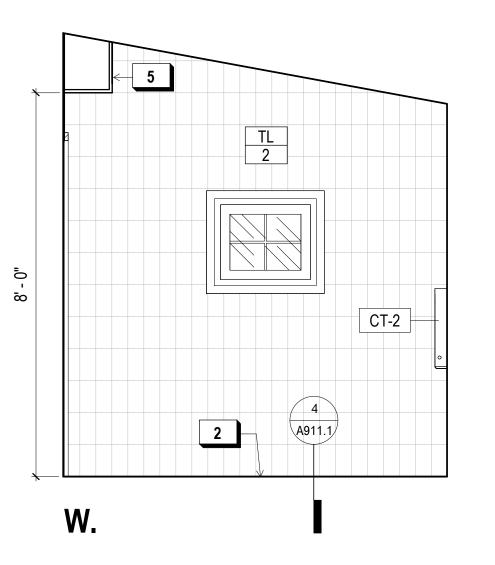

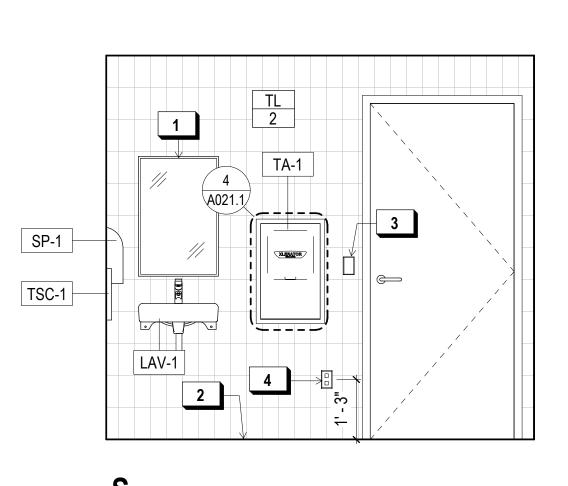

ALL GENDER RESTROOM 102 ENLARGED ELEVATIONS

1/2" = 1'-0"

900 INNES PARK DEVELOPMENT

CITY AND COUNTY OF SAN FRANCISCO RECREATION AND PARKS DEPARTMENT 30 VAN NESS AVENUE SAN FRANCISCO, CA 94102



PH. 415-831-2700 THE TRUST FOR PUBLIC LAND 101 MONTGOMERY STREET SUITE 900 SAN FRANCISCO, CA 94104 PH. 415-495-4014



PRIME CONSULTANT / LANDSCAPE ARCHITECT GUSTAFSON GUTHRIE NICHOL PH. 206-903-6802 CIVIL ENGINEER SHERWOOD DESIGN ENGINEERS PH. 415-348-9650 ARCHITECT JENSEN ARCHITECTS PH. 415-348-9650 ECOLOGICAL RESTORATION RANA CREEK PH. 831-659-3820 STRUCTURAL ENGINEER JON BRODY STRUCTURAL ENGINEERS PH. 415-296-9494 COASTAL ENGINEER MOFFATT AND NICHOL PH. 925-944-5411 LIGHTING NITEO CALIFORNIA PH. 415-666-2232 MEP & IT INTERFACE ENGINEERING PH. 415-489-7240 GEOTECHNICAL ENGINEER AGS, INC PH. 415-957-9240 SECURITY CONSULTANT

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ZBETA CONSULTING PH. 415-259-0422

KEY PLAN 2/



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REVISIONS:	
NO. DATE	ESCRIPTION
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ISSUANCE	
BII	O SET
DRAWN BY JENSEN	CHECKED BY
DATE	GGN PROJECT #


SHIPWRIGHT'S COTTAGE -ENLARGED EL.

7/01/2021


A172.1

SHEET NOTES:

- 1. REFERENCE 2019 CBC SECTION 302 FOR OCCUPANCY DESCRIPTIONS.
- 2. REFERENCE 2019 CBC TABLE 1004.5 FOR MAX. FLOOR AREA ALLOWANCES PER OCCUPANT.
- 3. REFERENCE 2019 CBC SECTION 1005 FOR MINIMUM EGRESS AND WIDTH REQUIREMENTS.
- 4. REFERENCE 2019 CBC TABLE 1006.2.1 FOR MINIMUM NUMBER OF EXITS FOR OCC. LOAD.
- 5. REFERENCE 2019 CBC TABLE 1017.2 FOR MAX. EXIT ACCESS TRAVEL DISTANCE WITH AUTOMATIC SPRINKLER SYSTEM. (A & E <250. B <300. S-2 & U <400)
- 6. REFERENCE 2019 CPC TABLE 422-1 FOR PLUMBING FIXTURE REQUIREMENTS.
- 7. PER 2019 CPC TABLE 422-1, NOTE 4, "FOR EACH URINAL ADDED IN EXCESS OF THE MINIMUM REQUIRED, ONE WATER CLOSET SHALL BE PERMITTED TO BE DEDUCTED. THE NUMBER OF WATER CLOSETS SHALL NOT BE REDUCED TO LESS THAN TWO-THIRDS OF THE MINIMUM REQUIREMENT."

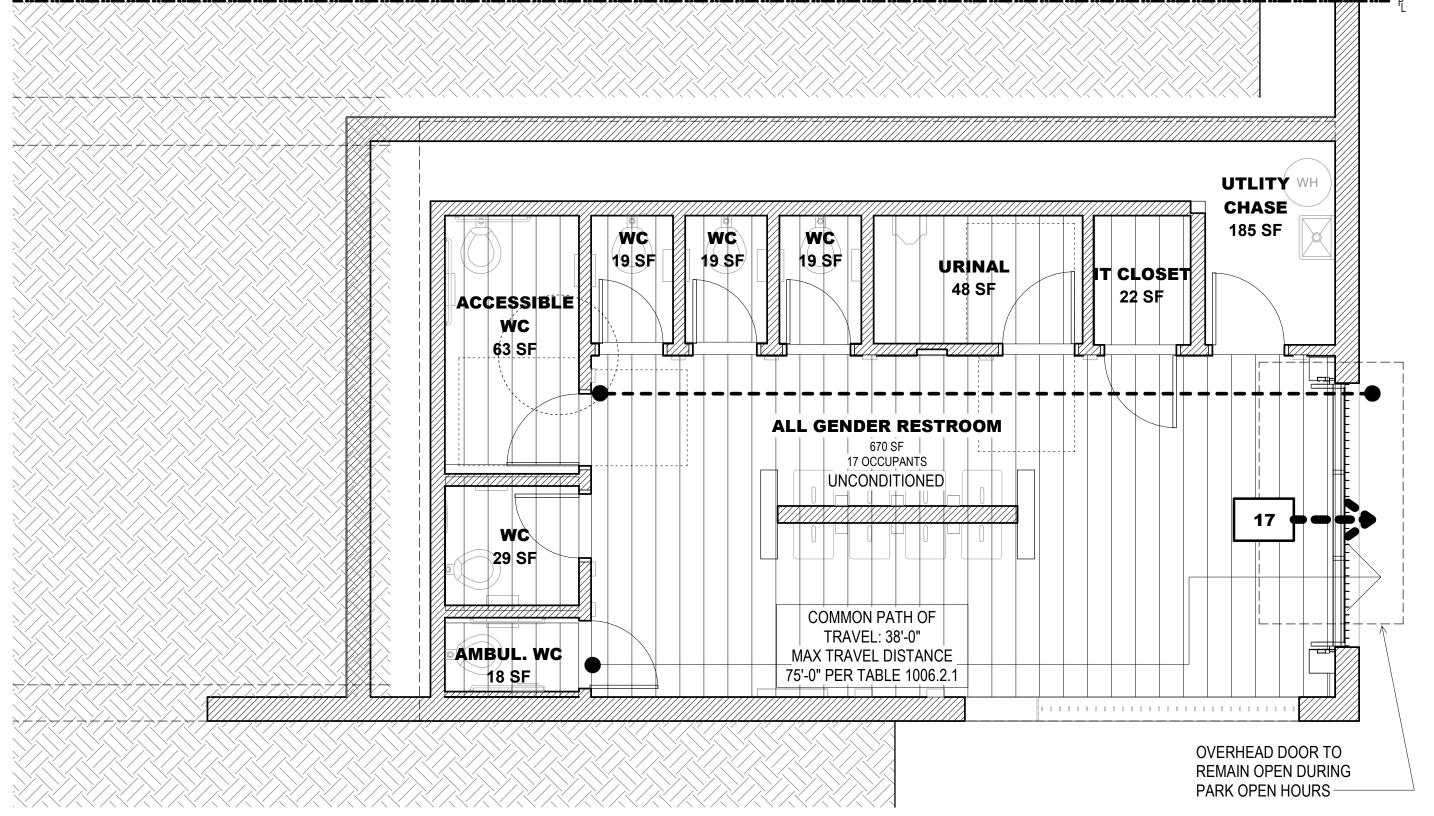

BOATYARD LEVEL EGRESS PLAN

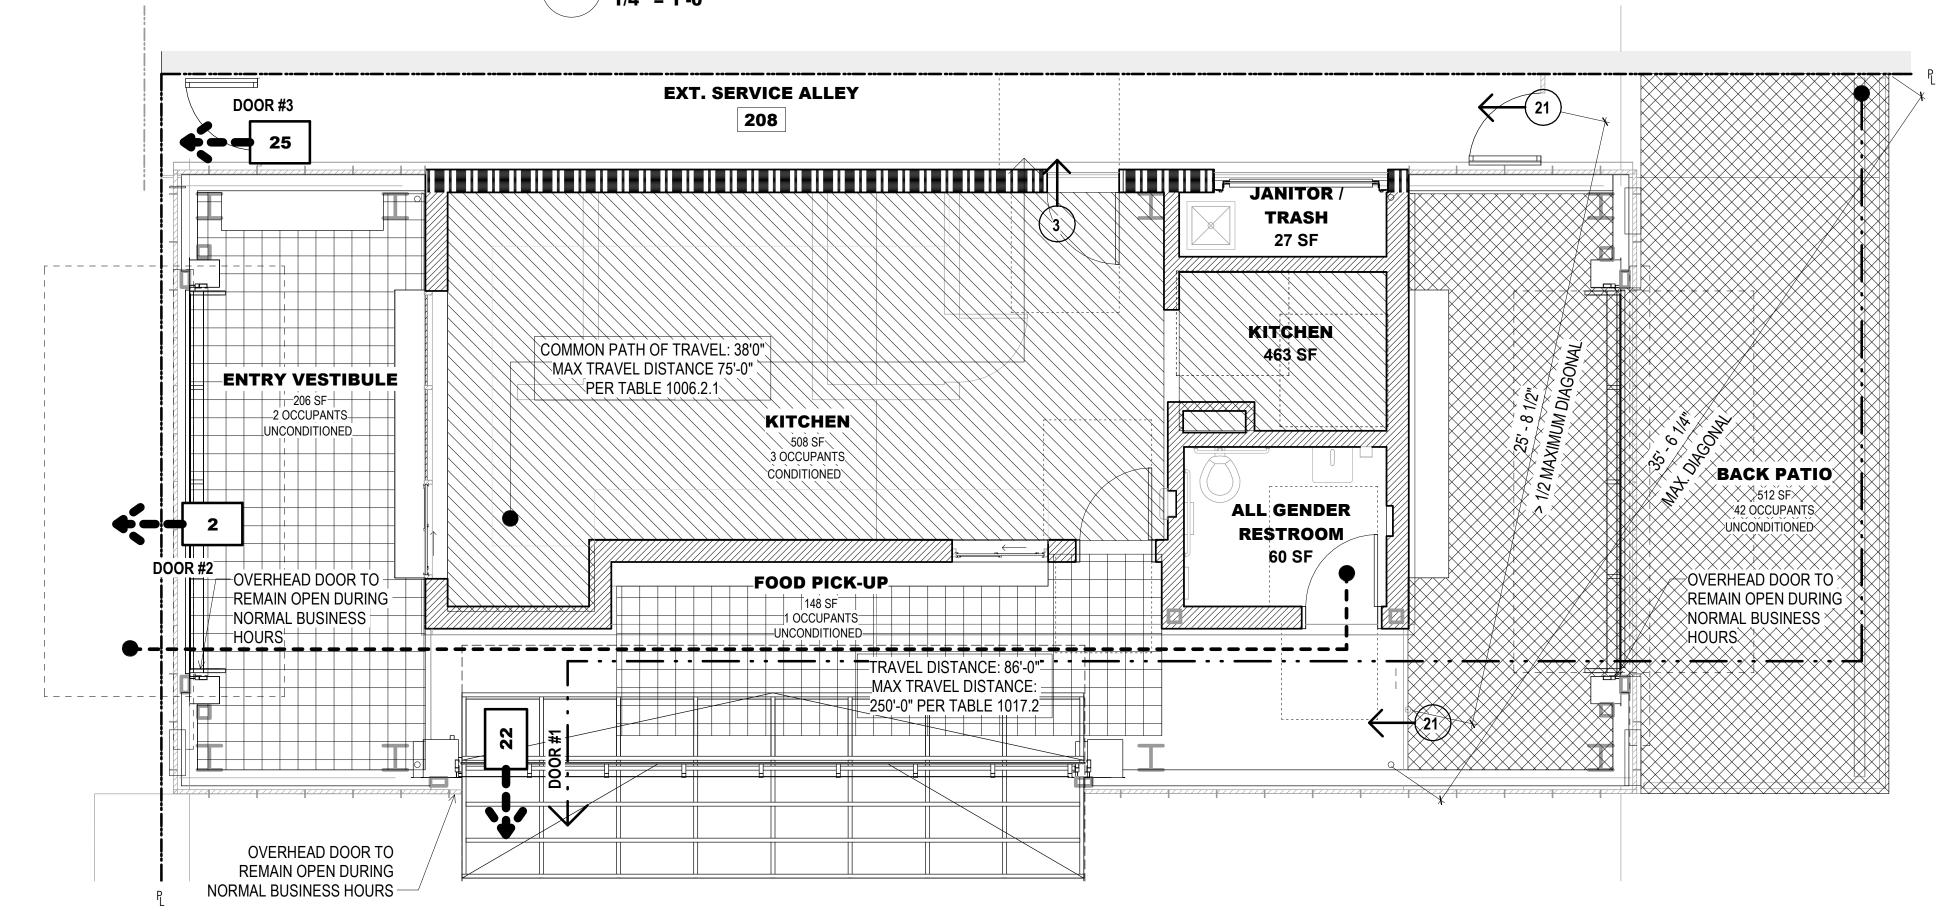

OCCUPANT LOAD - FOOD PAVILION

AREA

(SQ FT)

AREA

BACK PATIO

BOATYARD LEVEL - FP							
ALL GENDER RESTROOM	670	ACCESSORY STORAGE & MECH	0*	0.0	17*	17.0	
*OCCUPANT COUNT BASED ON ACCOUNT PER CBC SECTION 1004.5 STREET LEVEL FP		ם שלוות	RD LEVEL	OCCUPA	NT LOAD	: 17.0	
KITCHEN	508	COMMERCIAL KITCHEN	1:200 GROSS	2.5	0	2.5	
FOOD PICK-UP	148	BUSINESS	1:150 GROSS	1.0	0	1.0	
					1		-

FUNCTION OF

SPACE

UNCONCENTRATED STREET LEVEL OCCUPANT LOAD: 47.0 TOTAL OCCUPANT LOAD: 64.0

1:15 NET | 34.1 | 8 | 42.1

FACTOR AREA LOAD TOTAL REQ.

PLUMBING FIXTURE SUMMARY

PLUMBING FIXTURE OCCUPANT COUNT FOOD PAVILION

512 ASSEMBLY,

	OCCUPIED	OCCUPANCY		NUMBER OF
AREA	AREA (SF)	GROUP	LOAD FACTOR	OCCUPANTS
ALL GENDER RESTROOM	670	(EXCLUDED)	0 SF	
BACK PATIO	512	A2 - RESTAURANT	1:30 SF	18
ENTRY VESTIBULE	206	B - OFFICE / PUBLIC	1:200 SF	2
FOOD PICK-UP	148	B - OFFICE / PUBLIC	1:200 SF	1
KITCHEN	508	A2 - RESTAURANT	1:30 SF	17
	L		1	

PLUMBING OCCUPANT LOAD: 38


REQUIRED RESTROOM FIXTURE COUNT

# OF OCCUPANTS	# OF FIXTURES					
47 TOTAL OCCUPANTS / 2 = 24	REQUIRED	PROVIDED (ALL GENDER)				
24 MEN	1 W.C. / 1 URINAL	7 W.C. / 1 URINAL				
	1 LAVATORIES 8 LAVATORIES	8 LAVATORIES				
24 WOMEN	2 W.C.	NA				
	1 LAVATORIES	NA				
	1 WATER FOUNTAIN	1 WATER FOUNTAIN*				

EXITING REQUIREMENTS

EXIT COMPONENT	OCC. LOAD CAPACITY	ACTUAL OCC. LOAD	LOAD FACTOR	MIN. WIDTH	WIDTH PROVIDED
DOOR #1	480	22	0.2	34"	96"
DOOR #2	1080	2	0.2	34"	216"
DOOR #3	180	25	0.2	34"	34"

EGRESS LEGEND

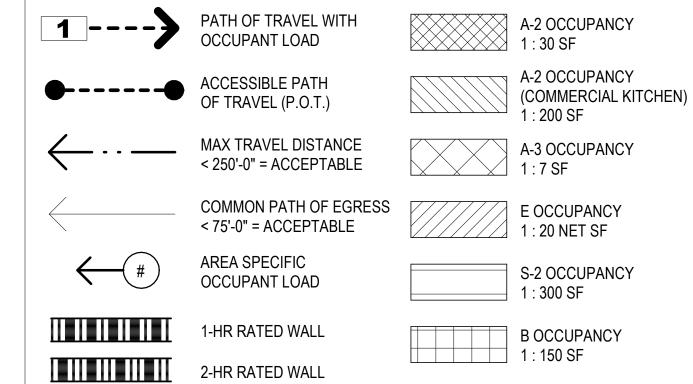

900 INNES PARK DEVELOPMENT LOAD BY ADD'L. OCC. EXITS

CITY AND COUNTY OF SAN FRANCISCO RECREATION AND PARKS DEPARTMENT 30 VAN NESS AVENUE SAN FRANCISCO, CA 94102

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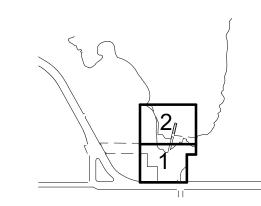
PH. 831-659-3820 STRUCTURAL ENGINEER JON BRODY STRUCTURAL ENGINEERS PH. 415-296-9494 COASTAL ENGINEER MOFFATT AND NICHOL

PH. 925-944-5411 LIGHTING NITEO CALIFORNIA PH. 415-666-2232 MEP & IT INTERFACE ENGINEERING PH. 415-489-7240 **GEOTECHNICAL ENGINEER**

AGS, INC PH. 415-957-9240 SECURITY CONSULTANT ZBETA CONSULTING PH. 415-259-0422

FOR OFFICIAL USE

*SHARED WATER FOUNTAIN. SEE A020.1 FOR LOCATION KEY PLAN





REVISIONS:

NO.	DATE	DESCRIPTION
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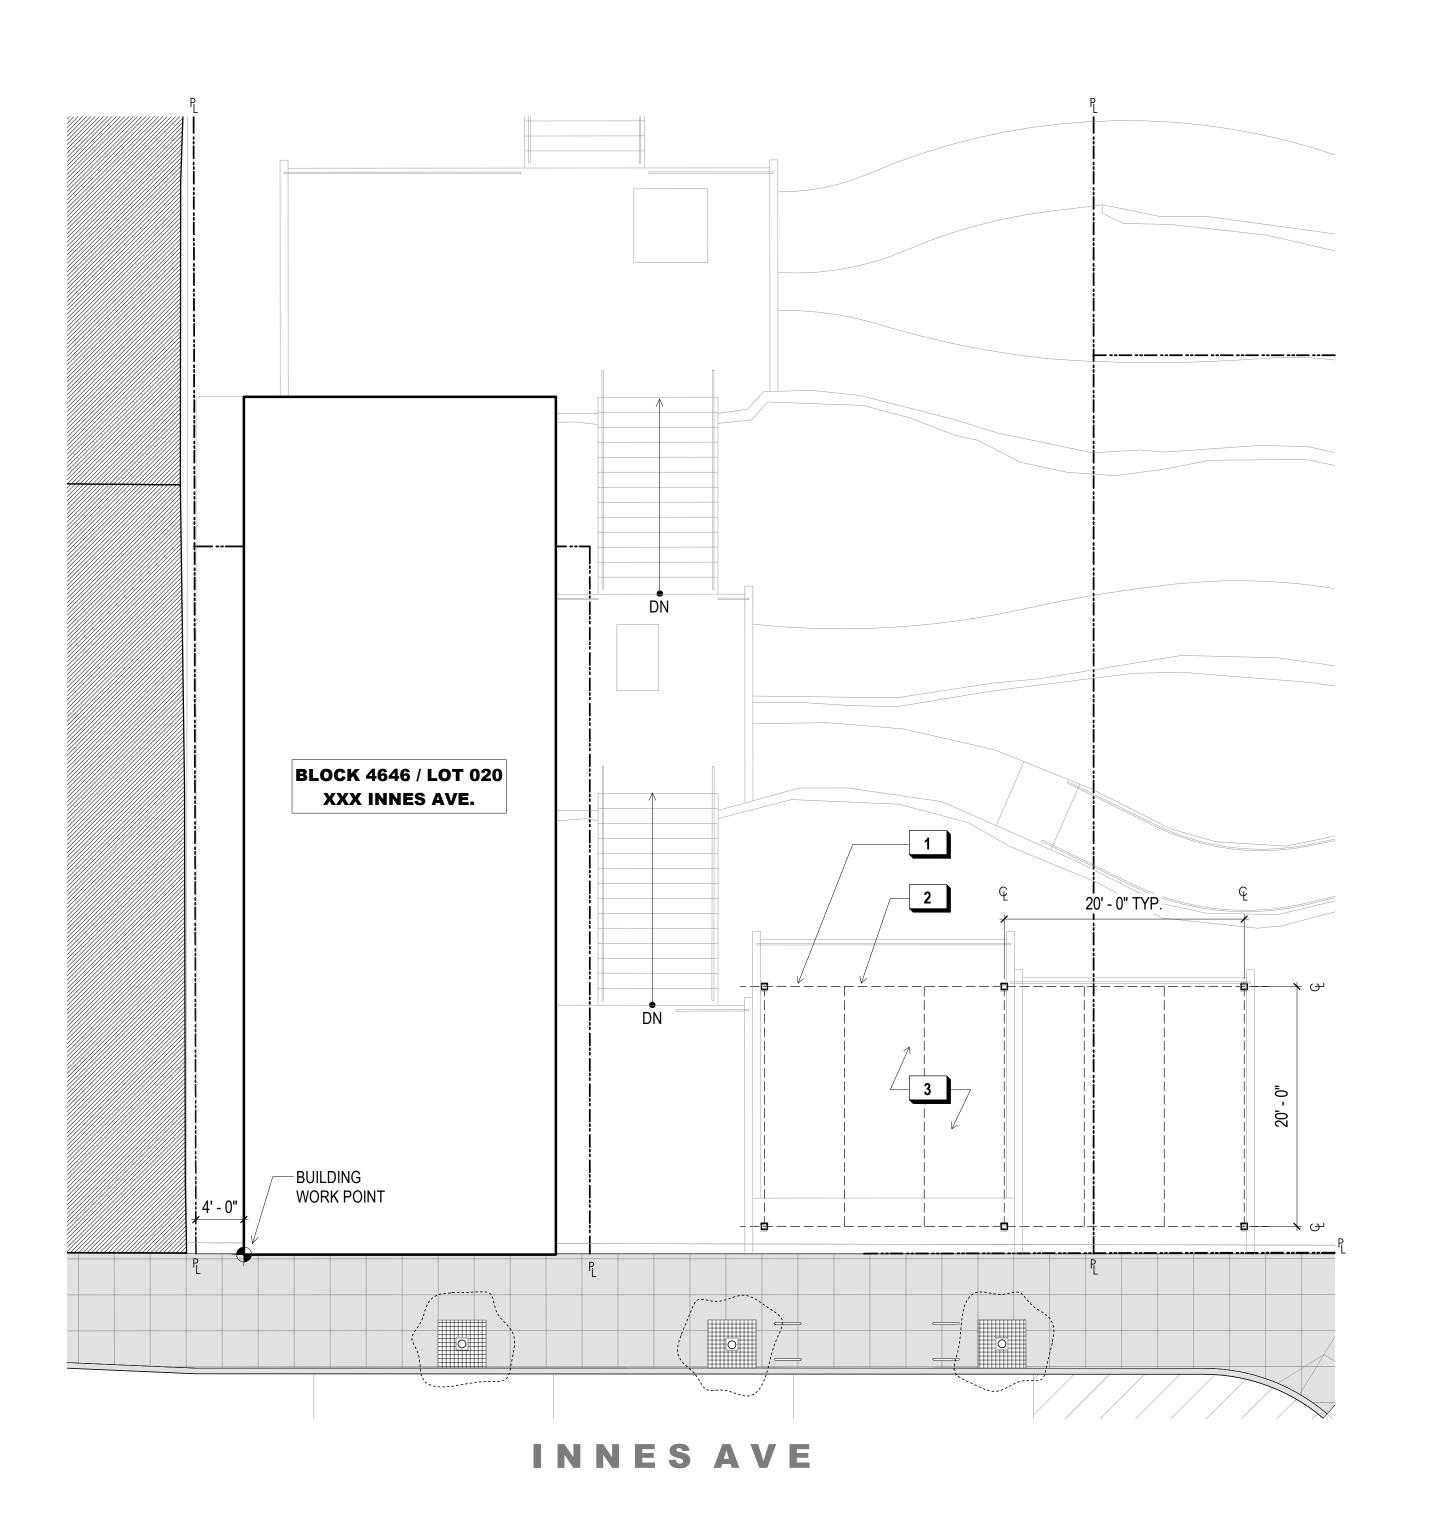
ISSUANCE

DRAWN BY CHECKED BY **JENSEN**

GGN PROJECT # 7/01/2021 EGRESS / ACCESSIBLE

POT / FIRE RATING PLAN

BID SET



SITE PLAN - FOOD PAVILION & INNES TERRACE

1/8" = 1'-0"



BUILDING INFORMATION:	EXISTING	PROPOSED	REQ. / ALLOW.
CONSTRUCTION TYPE	-	TYPE V-B	-
STORIES OF OCCUPANCY	-	2	2
BASEMENTS	-	0	-
BUILDING HEIGHT	-	24' - 0"	60' - 0"
OCCUPANCY GROUP	-	A-2, U	-
FIRE SPRINKLERS	-	YES	NONE REQ.
FIRE SPRINKLERS	-	YES	NONE REQ.

GROSS FLOOR AREA:	EXISTING	PROPOSED	REQ. / ALLOW.
STREET (UPPER) LEVEL	-	1,584 SQFT.	24,000 SQFT.
BOATYARD (LOWER) LEVEL	-	978 SQFT.	24,000 SQFT.
TOTAL BUILDING AREA:	-	2,562 SQFT.	48,000 SQFT.
NET ACCESSORY FLOOR AREA:			
STREET (UPPER) LEVEL PATIO:	-	287 SQFT.	-
STREET (UPPER) LEVEL PLAZA:	-	823 SQFT.	-
	·	·	·

SHEET NOTES:

1. LANDSCAPING AND SITE SHOWN FOR REF. ONLY - SEE CIVIL, LANDSCAPE, OR COASTAL ENGINEERING DRAWINGS FOR DETAILS.

X KEY NOTES:

1	6x6 PTD. HSS TRELLIS COL.
1	6x6 PTD. HSS TRELLIS COL.

- 2 OUTLINE OF WOOD CANOPY ABV.
- 2 OUTLINE OF WOOD CANOPY ABV.
- 3 S.L.D. FOR ALL OTHER SITE INFO. 3 S.L.D. FOR ALL OTHER SITE INFO.

900 INNES PARK DEVELOPMENT

CITY AND COUNTY OF SAN FRANCISCO RECREATION AND PARKS DEPARTMENT 30 VAN NESS AVENUE



THE TRUST FOR PUBLIC LAND 101 MONTGOMERY STREET SUITE 900 SAN FRANCISCO, CA 94104

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CIVIL ENGINEER SHERWOOD DESIGN ENGINEERS PH. 415-348-9650 ARCHITECT JENSEN ARCHITECTS

PH. 415-348-9650 ECOLOGICAL RESTORATION RANA CREEK PH. 831-659-3820

STRUCTURAL ENGINEER JON BRODY STRUCTURAL ENGINEERS PH. 415-296-9494 COASTAL ENGINEER

MOFFATT AND NICHOL PH. 925-944-5411 LIGHTING NITEO CALIFORNIA


PH. 415-666-2232 MEP & IT INTERFACE ENGINEERING PH. 415-489-7240

GEOTECHNICAL ENGINEER AGS, INC PH. 415-957-9240 SECURITY CONSULTANT ZBETA CONSULTING

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KEY PLAN



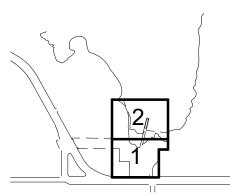

REVISIONS:

NO. DATE DESCRIPTION 01 12/18/2020 PERMIT SUBMITTAL

ISSUANCE

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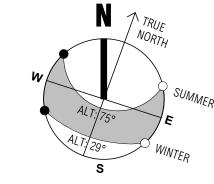
GGN PROJECT # 7/01/2021


BID SET

FOOD PAVILION -**BUILDING SITE PLAN**

CHECKED BY

A202.1



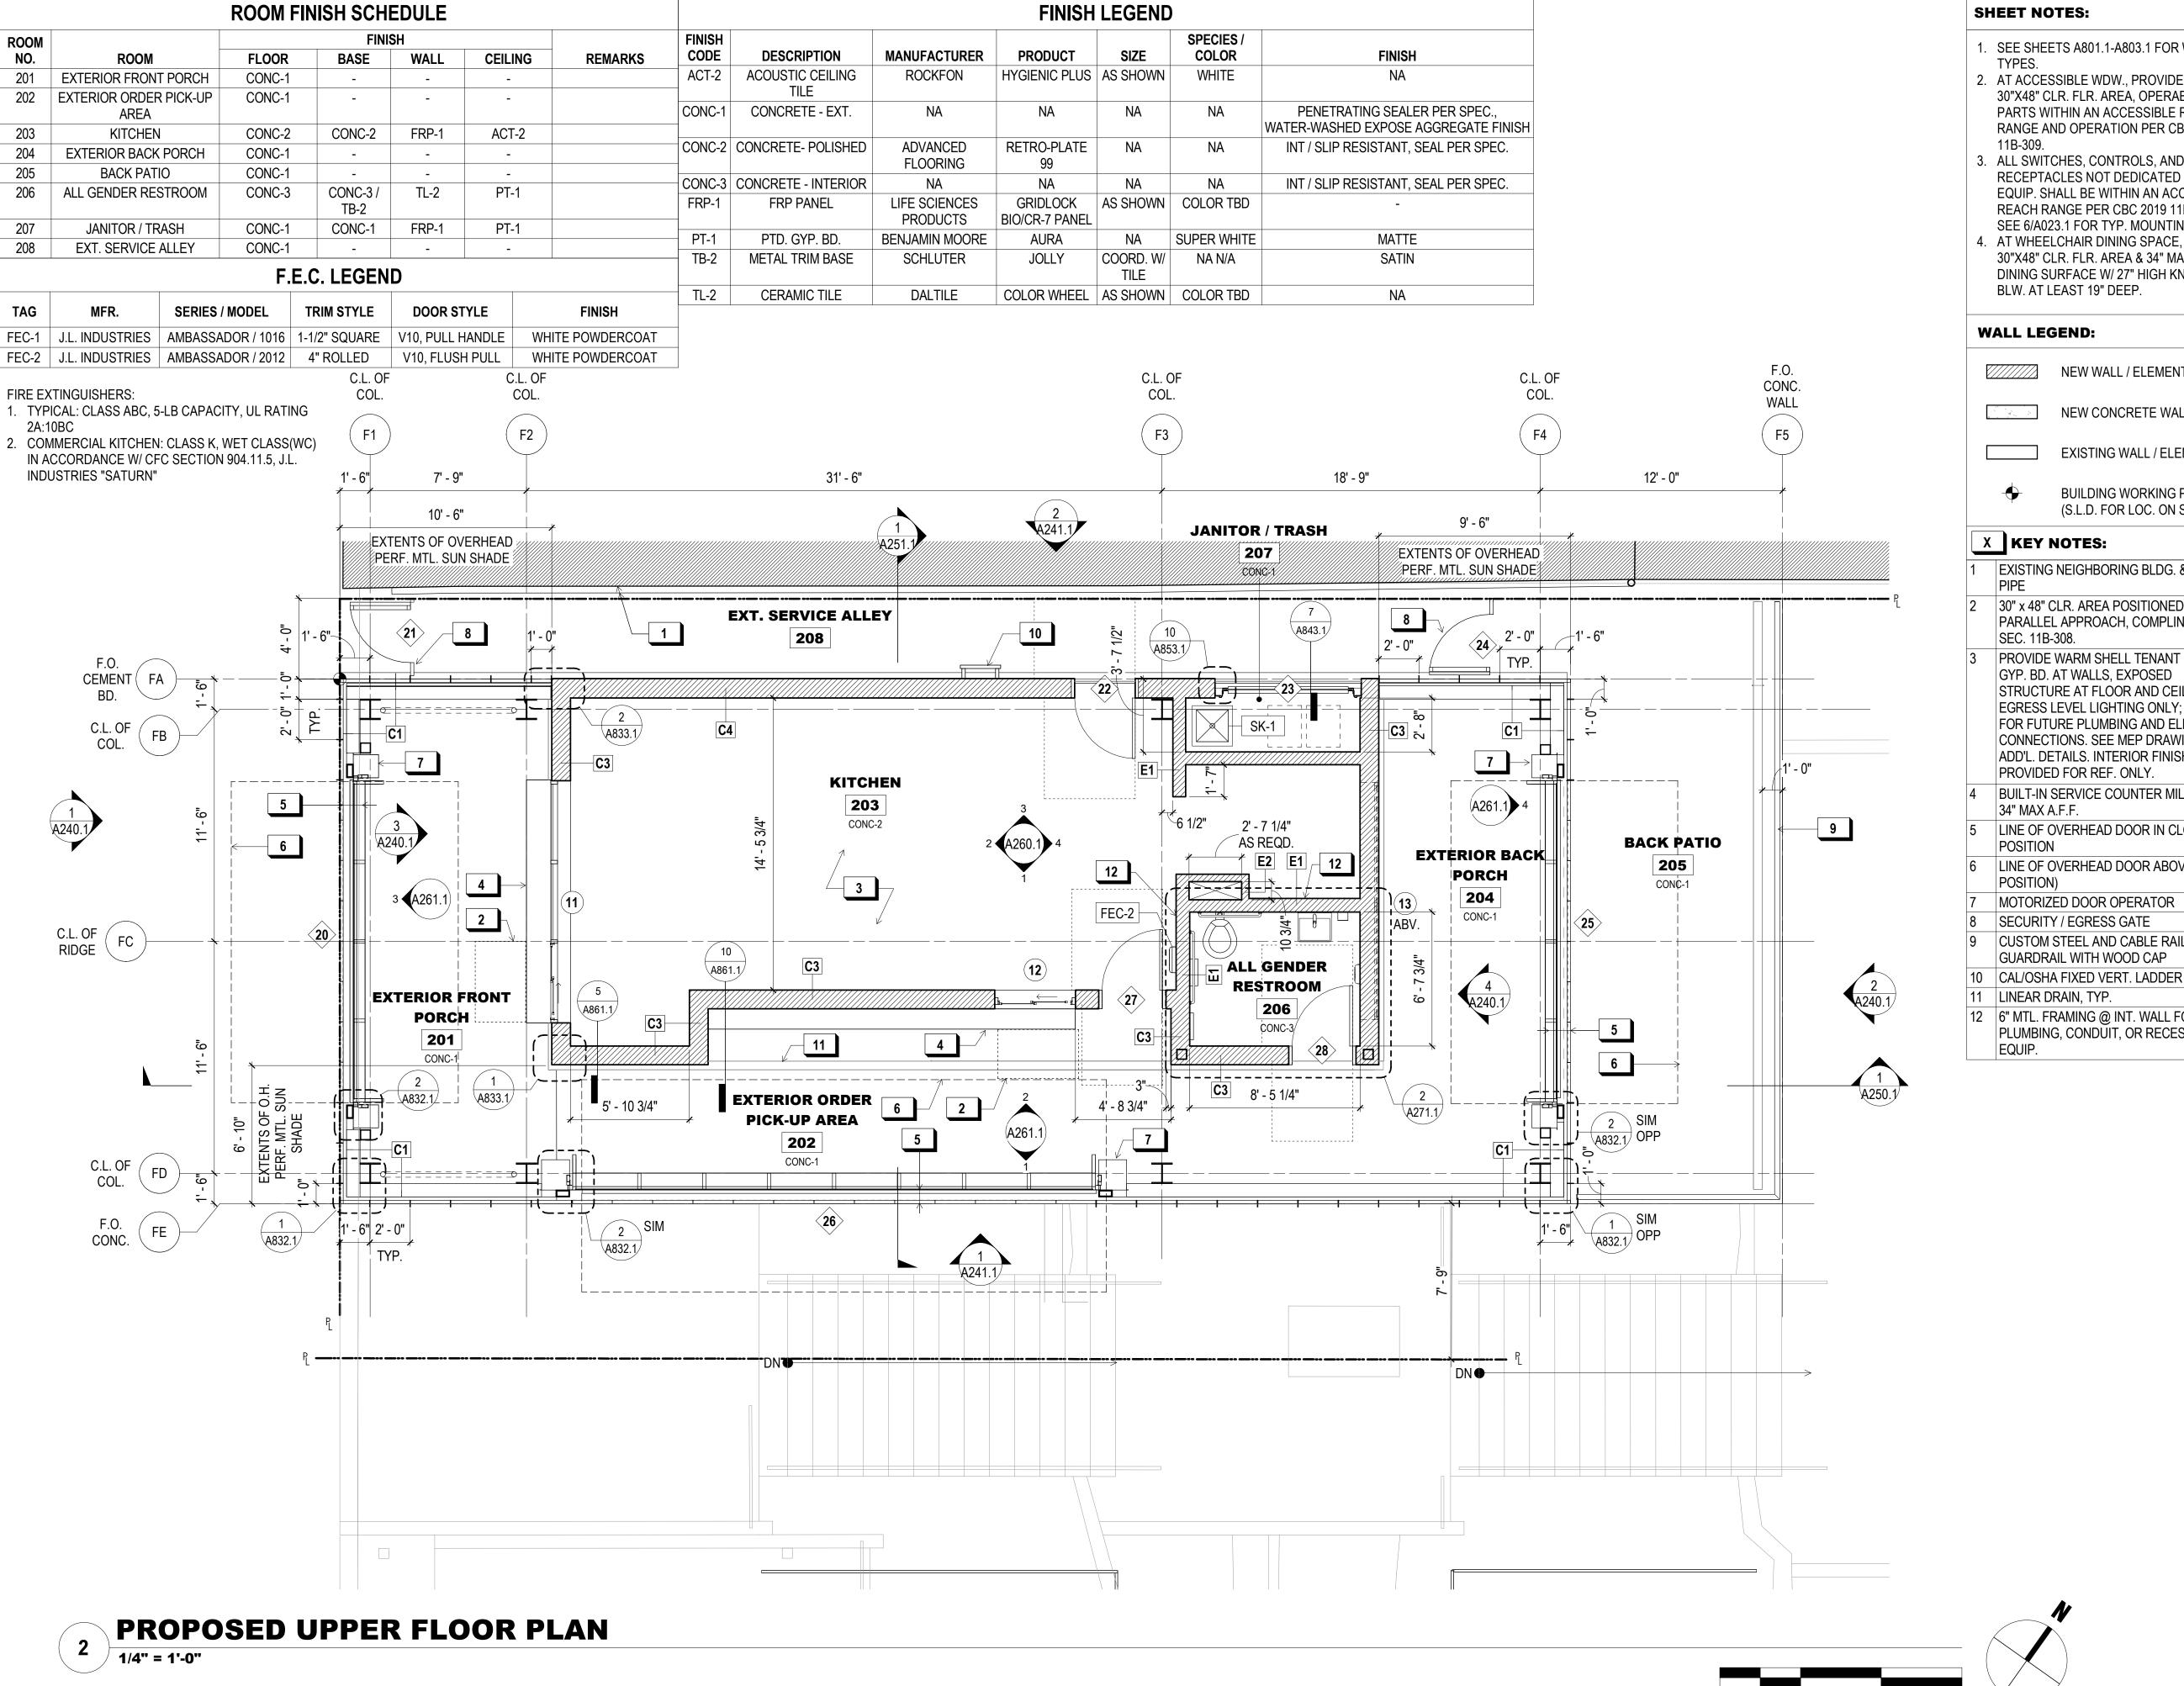

SHEET NOTES:

- 1. SEE SHEETS A801.1-A803.1 FOR WALL
- 2. AT ACCESSIBLE WDW., PROVIDE A 30"X48" CLR. FLR. AREA, OPERABLE PARTS WITHIN AN ACCESSIBLE REACH RANGE AND OPERATION PER CBC 2019 11B-309.
- ALL SWITCHES, CONTROLS, AND ELEC. RECEPTACLES NOT DEDICATED TO EQUIP. SHALL BE WITHIN AN ACCESSIBLE REACH RANGE PER CBC 2019 11B-308.1.
- SEE 6/A023.1 FOR TYP. MOUNTING HGTS. . AT WHEELCHAIR DINING SPACE, PROVIDE 30"X48" CLR. FLR. AREA & 34" MAX. HGT. DINING SURFACE W/ 27" HIGH KNEE CLR. BLW. AT LEAST 19" DEEP.

WALL LEGEND:

NEW WALL / ELEMENT

NEW CONCRETE WALL

BUILDING WORKING PT. (S.L.D. FOR LOC. ON SITE)

EXISTING WALL / ELEMENT

X KEY NOTES:

- EXISTING NEIGHBORING BLDG. & DRAIN
- 30" x 48" CLR. AREA POSITIONED FOR | PARALLEL APPROACH, COMPLING W/ CBC SEC. 11B-308.
- PROVIDE WARM SHELL TENANT SPACE: GYP. BD. AT WALLS, EXPOSED STRUCTURE AT FLOOR AND CEILING; EGRESS LEVEL LIGHTING ONLY; STUB OUT FOR FUTURE PLUMBING AND ELEC. CONNECTIONS. SEE MEP DRAWINGS FOR ADD'L. DETAILS. INTERIOR FINISHES PROVIDED FOR REF. ONLY.
- BUILT-IN SERVICE COUNTER MILLWORK 34" MAX A.F.F.
- LINE OF OVERHEAD DOOR IN CLOSED POSITION
- LINE OF OVERHEAD DOOR ABOVE (OPEN POSITION)
- | MOTORIZED DOOR OPERATOR
- SECURITY / EGRESS GATE
- CUSTOM STEEL AND CABLE RAIL GUARDRAIL WITH WOOD CAP
- 12 6" MTL. FRAMING @ INT. WALL FOR PLUMBING, CONDUIT, OR RECESSED

900 INNES PARK DEVELOPMENT

CITY AND COUNTY OF SAN FRANCISCO RECREATION AND PARKS DEPARTMENT 30 VAN NESS AVENUE

SAN FRANCISCO, CA 94102 PH. 415-831-2700

THE TRUST FOR PUBLIC LAND 101 MONTGOMERY STREET SUITE 900 SAN FRANCISCO, CA 94104 PH. 415-495-4014

PRIME CONSULTANT / LANDSCAPE ARCHITECT GUSTAFSON GUTHRIE NICHOL PH. 206-903-6802 CIVIL ENGINEER SHERWOOD DESIGN ENGINEERS PH. 415-348-9650

ARCHITECT JENSEN ARCHITECTS PH. 415-348-9650 ECOLOGICAL RESTORATION RANA CREEK PH. 831-659-3820

STRUCTURAL ENGINEER JON BRODY STRUCTURAL ENGINEERS PH. 415-296-9494 COASTAL ENGINEER


MOFFATT AND NICHOL PH. 925-944-5411 LIGHTING NITEO CALIFORNIA PH. 415-666-2232

MEP & IT INTERFACE ENGINEERING PH. 415-489-7240 **GEOTECHNICAL ENGINEER**

AGS, INC PH. 415-957-9240 SECURITY CONSULTANT ZBETA CONSULTING PH. 415-259-0422

FOR OFFICIAL USE

KEY PLAN

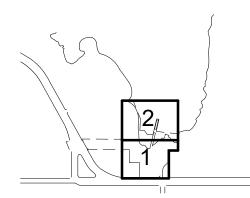



REVISIONS:

NO. DATE **DESCRIPTION** PERMIT SUBMITTAL 01 12/18/2020

ISSUANCE **BID SET**

DRAWN BY

CHECKED BY

JENSEN

GGN PROJECT # 7/01/2021 1608

PROPOSED UPPER PLAN

FOOD PAVILION -

		RO	OM FINISH SC	HEDULE						FINISH L	EGEND		
ROOM			FINISH				FINISH					SPECIES /	
NO.	ROOM	FLOOR	BASE	WALL	CEILING	REMARKS	CODE	DESCRIPTION	MANUFACTURER	PRODUCT	SIZE	COLOR	FINISH
211	UTLITY CHASE	CONC-4	-	-	-	UNFINISHED SPACE	CONC-3	CONCRETE - INTERIOR	NA	NA	NA	NA	INT / SLIP RESISTANT, SEAL PER SPEC.
212	ALL GENDER RESTROOM	CONC-3	CONC-3	TL-2	PT-3	EXPOSED CEILING, PAINTED, TYP.	CONC-4	CONCRETE	NA	NA	NA	NA	BROOM FINISH
212A	IT CLOSET	CONC-4	CONC-4	PT-2	PT-3		PT-2	PTD. GYP. BD.	BENJAMIN MOORE	AURA	NA	SUPER WHITE	SEMI-GLOSS
212B	URINAL	CONC-3	CONC-3 / TB-2	TL-2	PT-3		PT-3	PTD. GYP. BD.	BENJAMIN MOORE	AURA	NA	COLOR TBD	MATTE
212C	WC	CONC-3	CONC-3 / TB-2				TB-2	METAL TRIM BASE	SCHLUTER	JOLLY	COORD. W/	NA N/A	SATIN
212D	WC	CONC-3	CONC-3 / TB-2	TL-2	PT-3						TILE		
212E	WC	CONC-3	CONC-3 / TB-2	TL-2	PT-3		TL-2	CERAMIC TILE	DALTILE	COLOR WHEEL	AS SHOWN	COLOR TBD	NA
212F	ACCESSIBLE WC	CONC-3	CONC-3 / TB-2	TL-2	PT-3								

PT-3

PT-3

TL-2

TL-2

	C.L. CO	L. COL.	31' - 6"	C.L. OF COL. F3	F4	F.O. CONC. WALL F5
O. IENT FA D.				WC WC WC 212E 212D 212C CONC-3 CONC-3	IT CLOSET UTLITY CHASE 212A CONC-4 CONC-4 CONC-4	P_
OF FB		9			A1 F2	A3
OF GE FC			ACCESSIBLE WG		212B	1-13/4
7-1-7-			WC F2 F2 F2 F2 F2 F2 F2 F3 F5 F2 F3 F5	F1 36 36 37 9 9 9 9 9 9 9 9 9 9 9 9 9 9 9 9 9 9	15 5 RESTROOM 212 CONC-3 29	
DF (FD)				F1	11	2 4 1
OF FD			1 A241.1	A1	A3 2'-6	1 72/1.1

SHEET NOTES:

- 1. SEE SHEETS A801.1-A803.1 FOR WALL
- 2. ALL SWITCHES, CONTROLS, AND ELEC. RECEPTACLES NOT DEDICATED TO EQUIP. SHALL BE WITHIN AN ACCESSIBLE REACH RANGE PER CBC 2019 11B-308.1. SEE 6/A023.1 FOR TYP. MOUNTING HGTS.

WALL LEGEND:

NEW WALL / ELEMENT

NEW CONCRETE WALL



BUILDING WORKING PT. (S.L.D. FOR LOC. ON SITE)

EXISTING WALL / ELEMENT

X KEY NOTES:

SEE A-801 & A-803 FOR WALL TYPE LEGEND

- LINE OF OVERHEAD DOOR (OPEN POSITION)
- LINE OF OVERHEAD DOOR IN CLOSED POSITION
- MOP SINK WALL-MTD. SINK @ TILED DIE WALL, TYP.
- CHANGING TABLE, TYP.
- CUSTOM PTD. STL. FLAT BAR SCREEN
- UNEXCAVATED
- LINE OF FOOTING ABOVE
- 10 RECESSED HAND DRYER 11 SURFACE-MTD. HAND DRYER
- 12 AREA DRAIN, TYP.
- 13 ELECTRICAL PANEL, S.E.D.
- 14 | ELECTRICAL SWITCHING RACK, S.E.D.
- 15 6" MTL. FRAMING @ INT. WALL FOR PLUMBING, CONDUIT, OR RECESSED

EQUIP.

900 INNES PARK DEVELOPMENT

CITY AND COUNTY OF SAN FRANCISCO RECREATION AND PARKS DEPARTMENT 30 VAN NESS AVENUE

SAN FRANCISCO, CA 94102 PH. 415-831-2700 THE TRUST FOR PUBLIC LAND

101 MONTGOMERY STREET

SAN FRANCISCO, CA 94104

SUITE 900

ARCHITECT

PH. 415-495-4014

PRIME CONSULTANT / LANDSCAPE ARCHITECT GUSTAFSON GUTHRIE NICHOL PH. 206-903-6802

CIVIL ENGINEER SHERWOOD DESIGN ENGINEERS PH. 415-348-9650

JENSEN ARCHITECTS PH. 415-348-9650 ECOLOGICAL RESTORATION RANA CREEK PH. 831-659-3820

STRUCTURAL ENGINEER JON BRODY STRUCTURAL ENGINEERS PH. 415-296-9494 COASTAL ENGINEER

MOFFATT AND NICHOL PH. 925-944-5411 LIGHTING NITEO CALIFORNIA


PH. 415-666-2232 MEP & IT INTERFACE ENGINEERING PH. 415-489-7240

GEOTECHNICAL ENGINEER AGS, INC

PH. 415-957-9240 SECURITY CONSULTANT ZBETA CONSULTING PH. 415-259-0422

FOR OFFICIAL USE

KEY PLAN

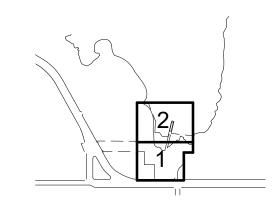



REVISIONS:

NO. DATE DESCRIPTION 01 12/18/2020 PERMIT SUBMITTAL

ISSUANCE

BID SET

DRAWN BY

GGN PROJECT # 7/01/2021

FOOD PAVILION -PROPOSED LOWER PLAN

CHECKED BY

212G

212H

WC


AMBUL. WC


CONC-3

CONC-3

CONC-3 / TB-2

CONC-3 / TB-2

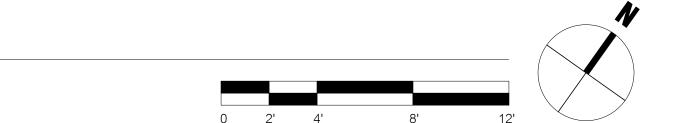

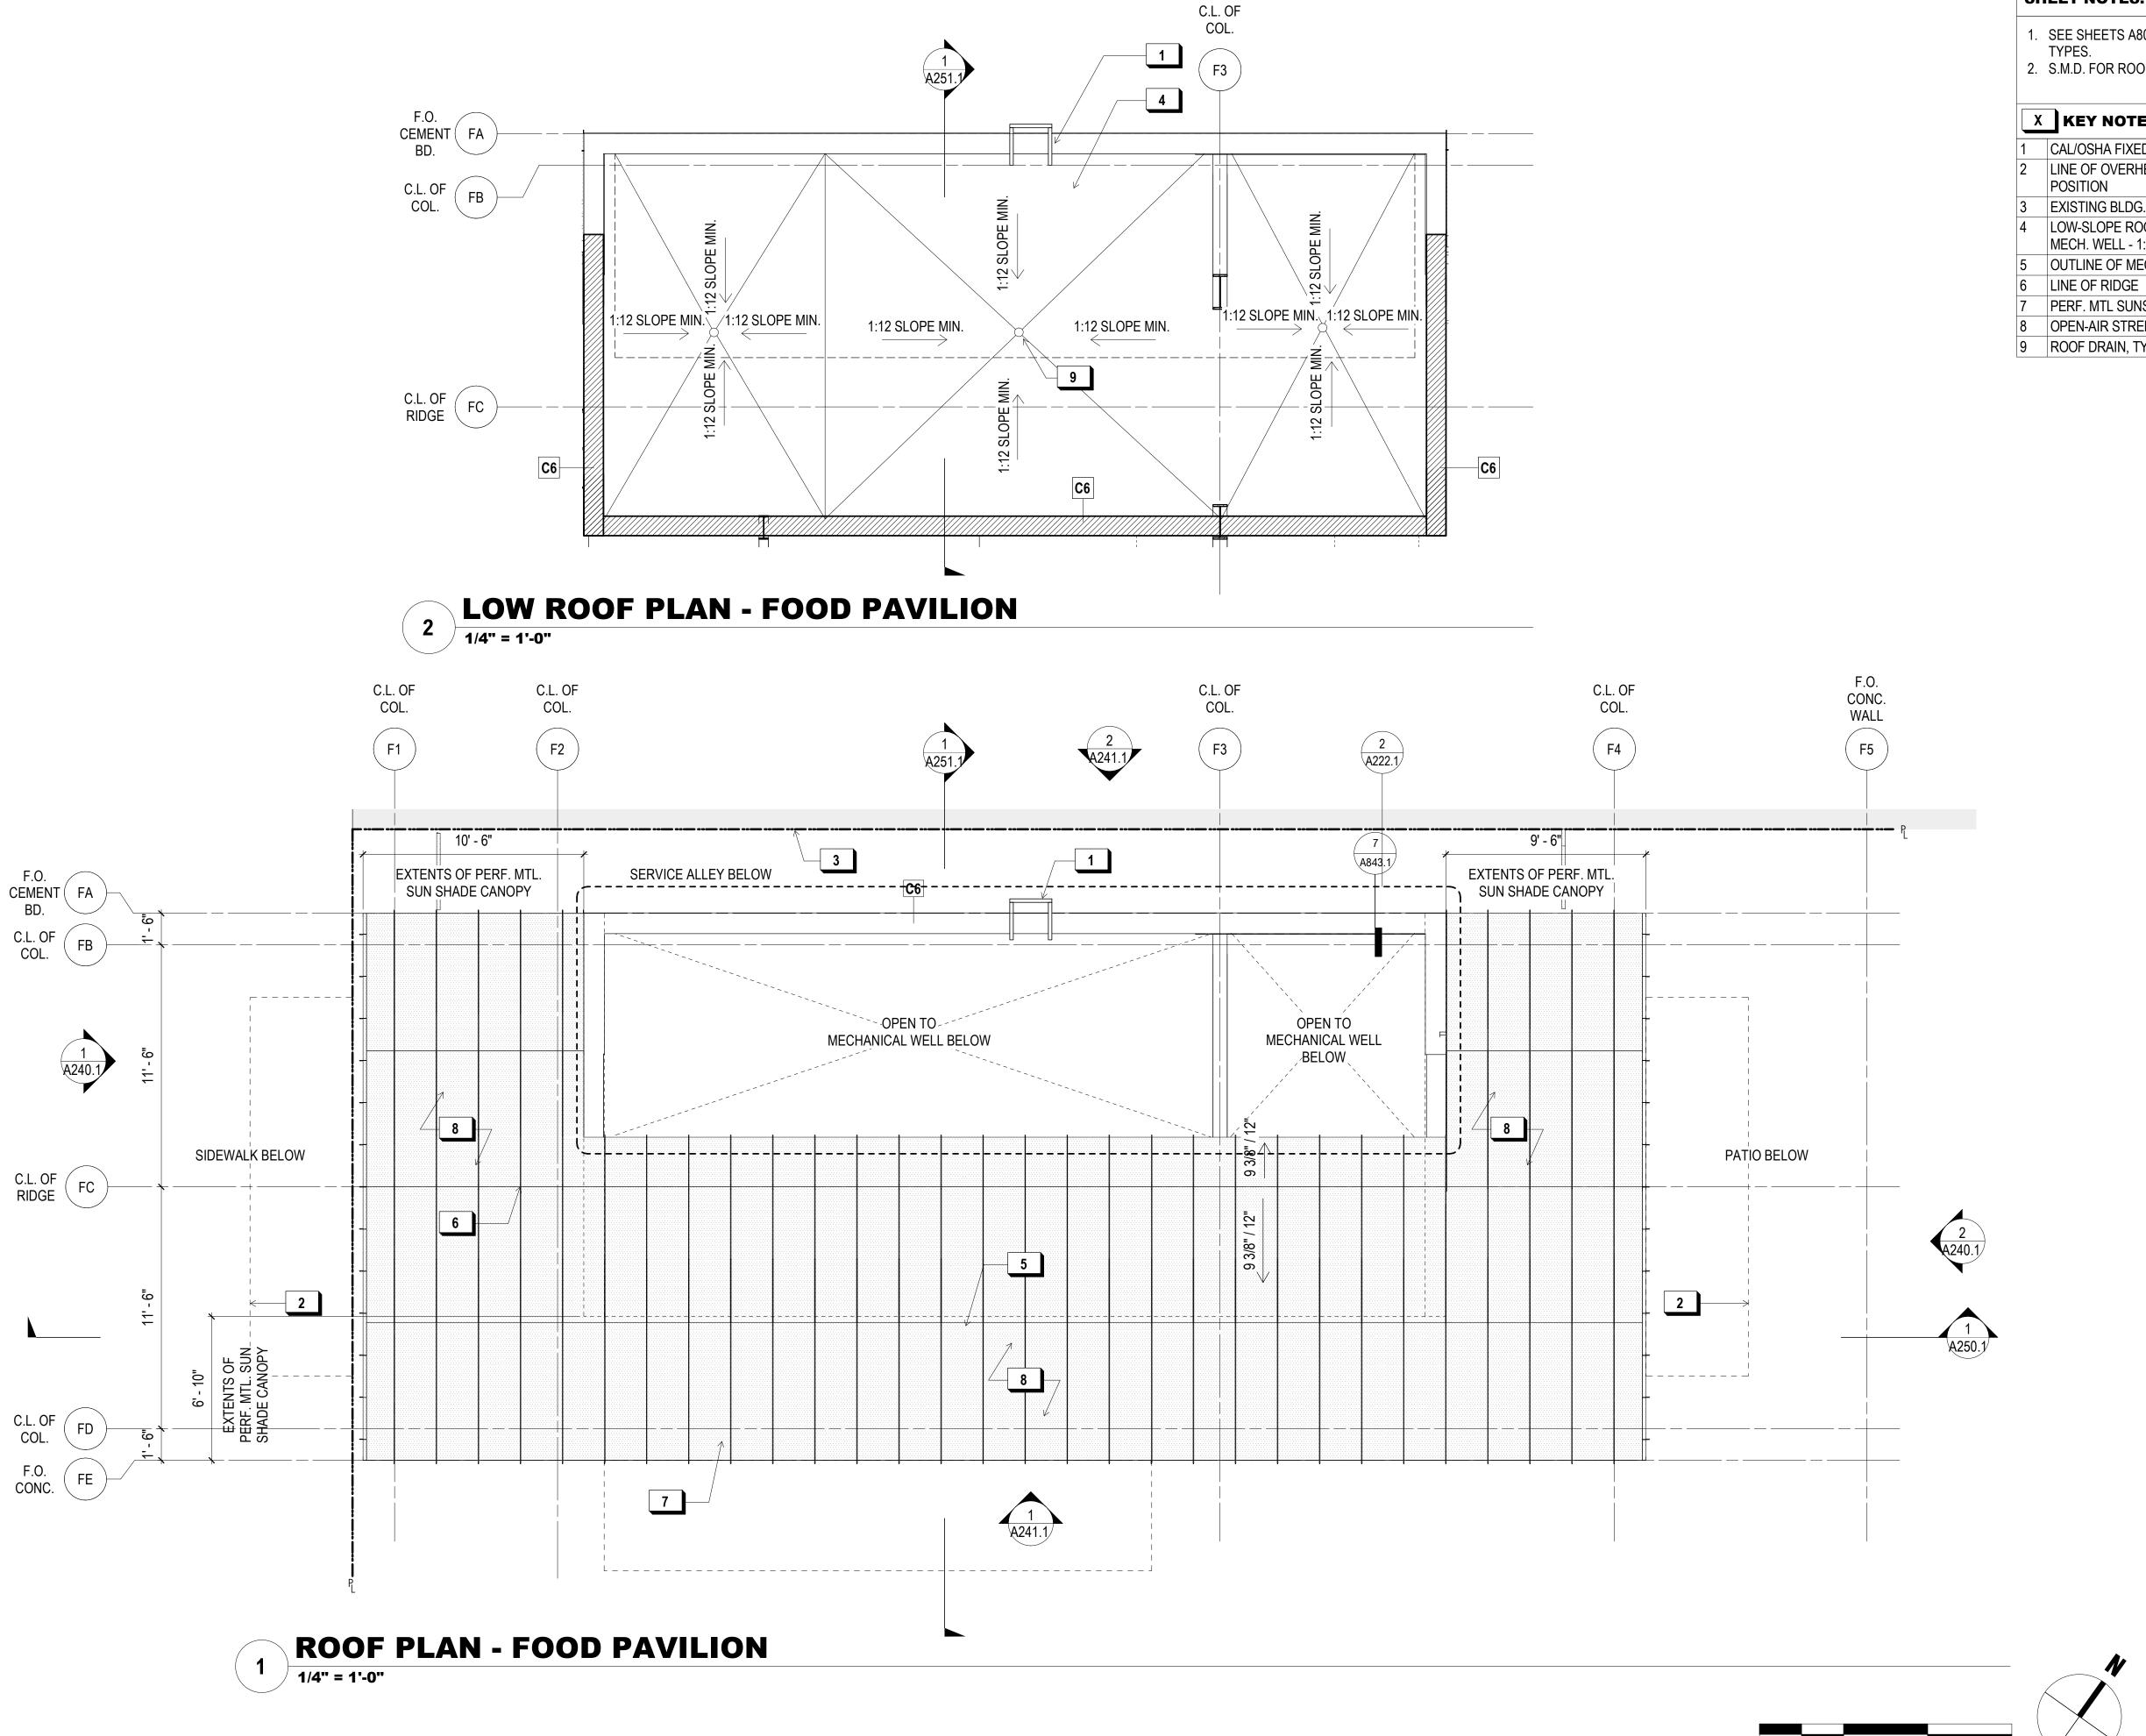

SHEET NOTES:

- 1. SEE SHEETS A80.1-A803.1 FOR WALL
- 2. S.M.D. FOR ROOF EQUIP. DETAILS

X KEY NOTES:

- CAL/OSHA FIXED VERT. LADDER
- LINE OF OVERHEAD DOOR IN OPEN POSITION
- EXISTING BLDG.
- LOW-SLOPE ROOF W/ PMMA ROOFING @ MECH. WELL - 1:12 SLOPE TO DRAIN, TYP.
- OUTLINE OF MECH. ROOF LEVEL BLW.
- PERF. MTL SUNSHADE PANEL, TYP.
- OPEN-AIR STREET LEVEL SPACE BLW.
- ROOF DRAIN, TYP.

900 INNES PARK DEVELOPMENT

CITY AND COUNTY OF SAN FRANCISCO RECREATION AND PARKS DEPARTMENT 30 VAN NESS AVENUE

SAN FRANCISCO, CA 94102 PH. 415-831-2700

THE TRUST FOR PUBLIC LAND 101 MONTGOMERY STREET SUITE 900 SAN FRANCISCO, CA 94104 PH. 415-495-4014

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JENSEN ARCHITECTS PH. 415-348-9650 ECOLOGICAL RESTORATION RANA CREEK PH. 831-659-3820 STRUCTURAL ENGINEER JON BRODY STRUCTURAL ENGINEERS PH. 415-296-9494

ARCHITECT

MOFFATT AND NICHOL PH. 925-944-5411 LIGHTING NITEO CALIFORNIA PH. 415-666-2232 MEP & IT

COASTAL ENGINEER


PH. 415-489-7240 GEOTECHNICAL ENGINEER AGS, INC PH. 415-957-9240 SECURITY CONSULTANT ZBETA CONSULTING

INTERFACE ENGINEERING

FOR OFFICIAL USE

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KEY PLAN



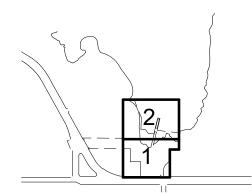

REVISIONS:

NO. DATE DESCRIPTION 01 12/18/2020 PERMIT SUBMITTAL

ISSUANCE

BID SET

DRAWN BY **JENSEN**


GGN PROJECT #

CHECKED BY


7/01/2021 FOOD PAVILION -

PROPOSED ROOF PLAN

A222.1

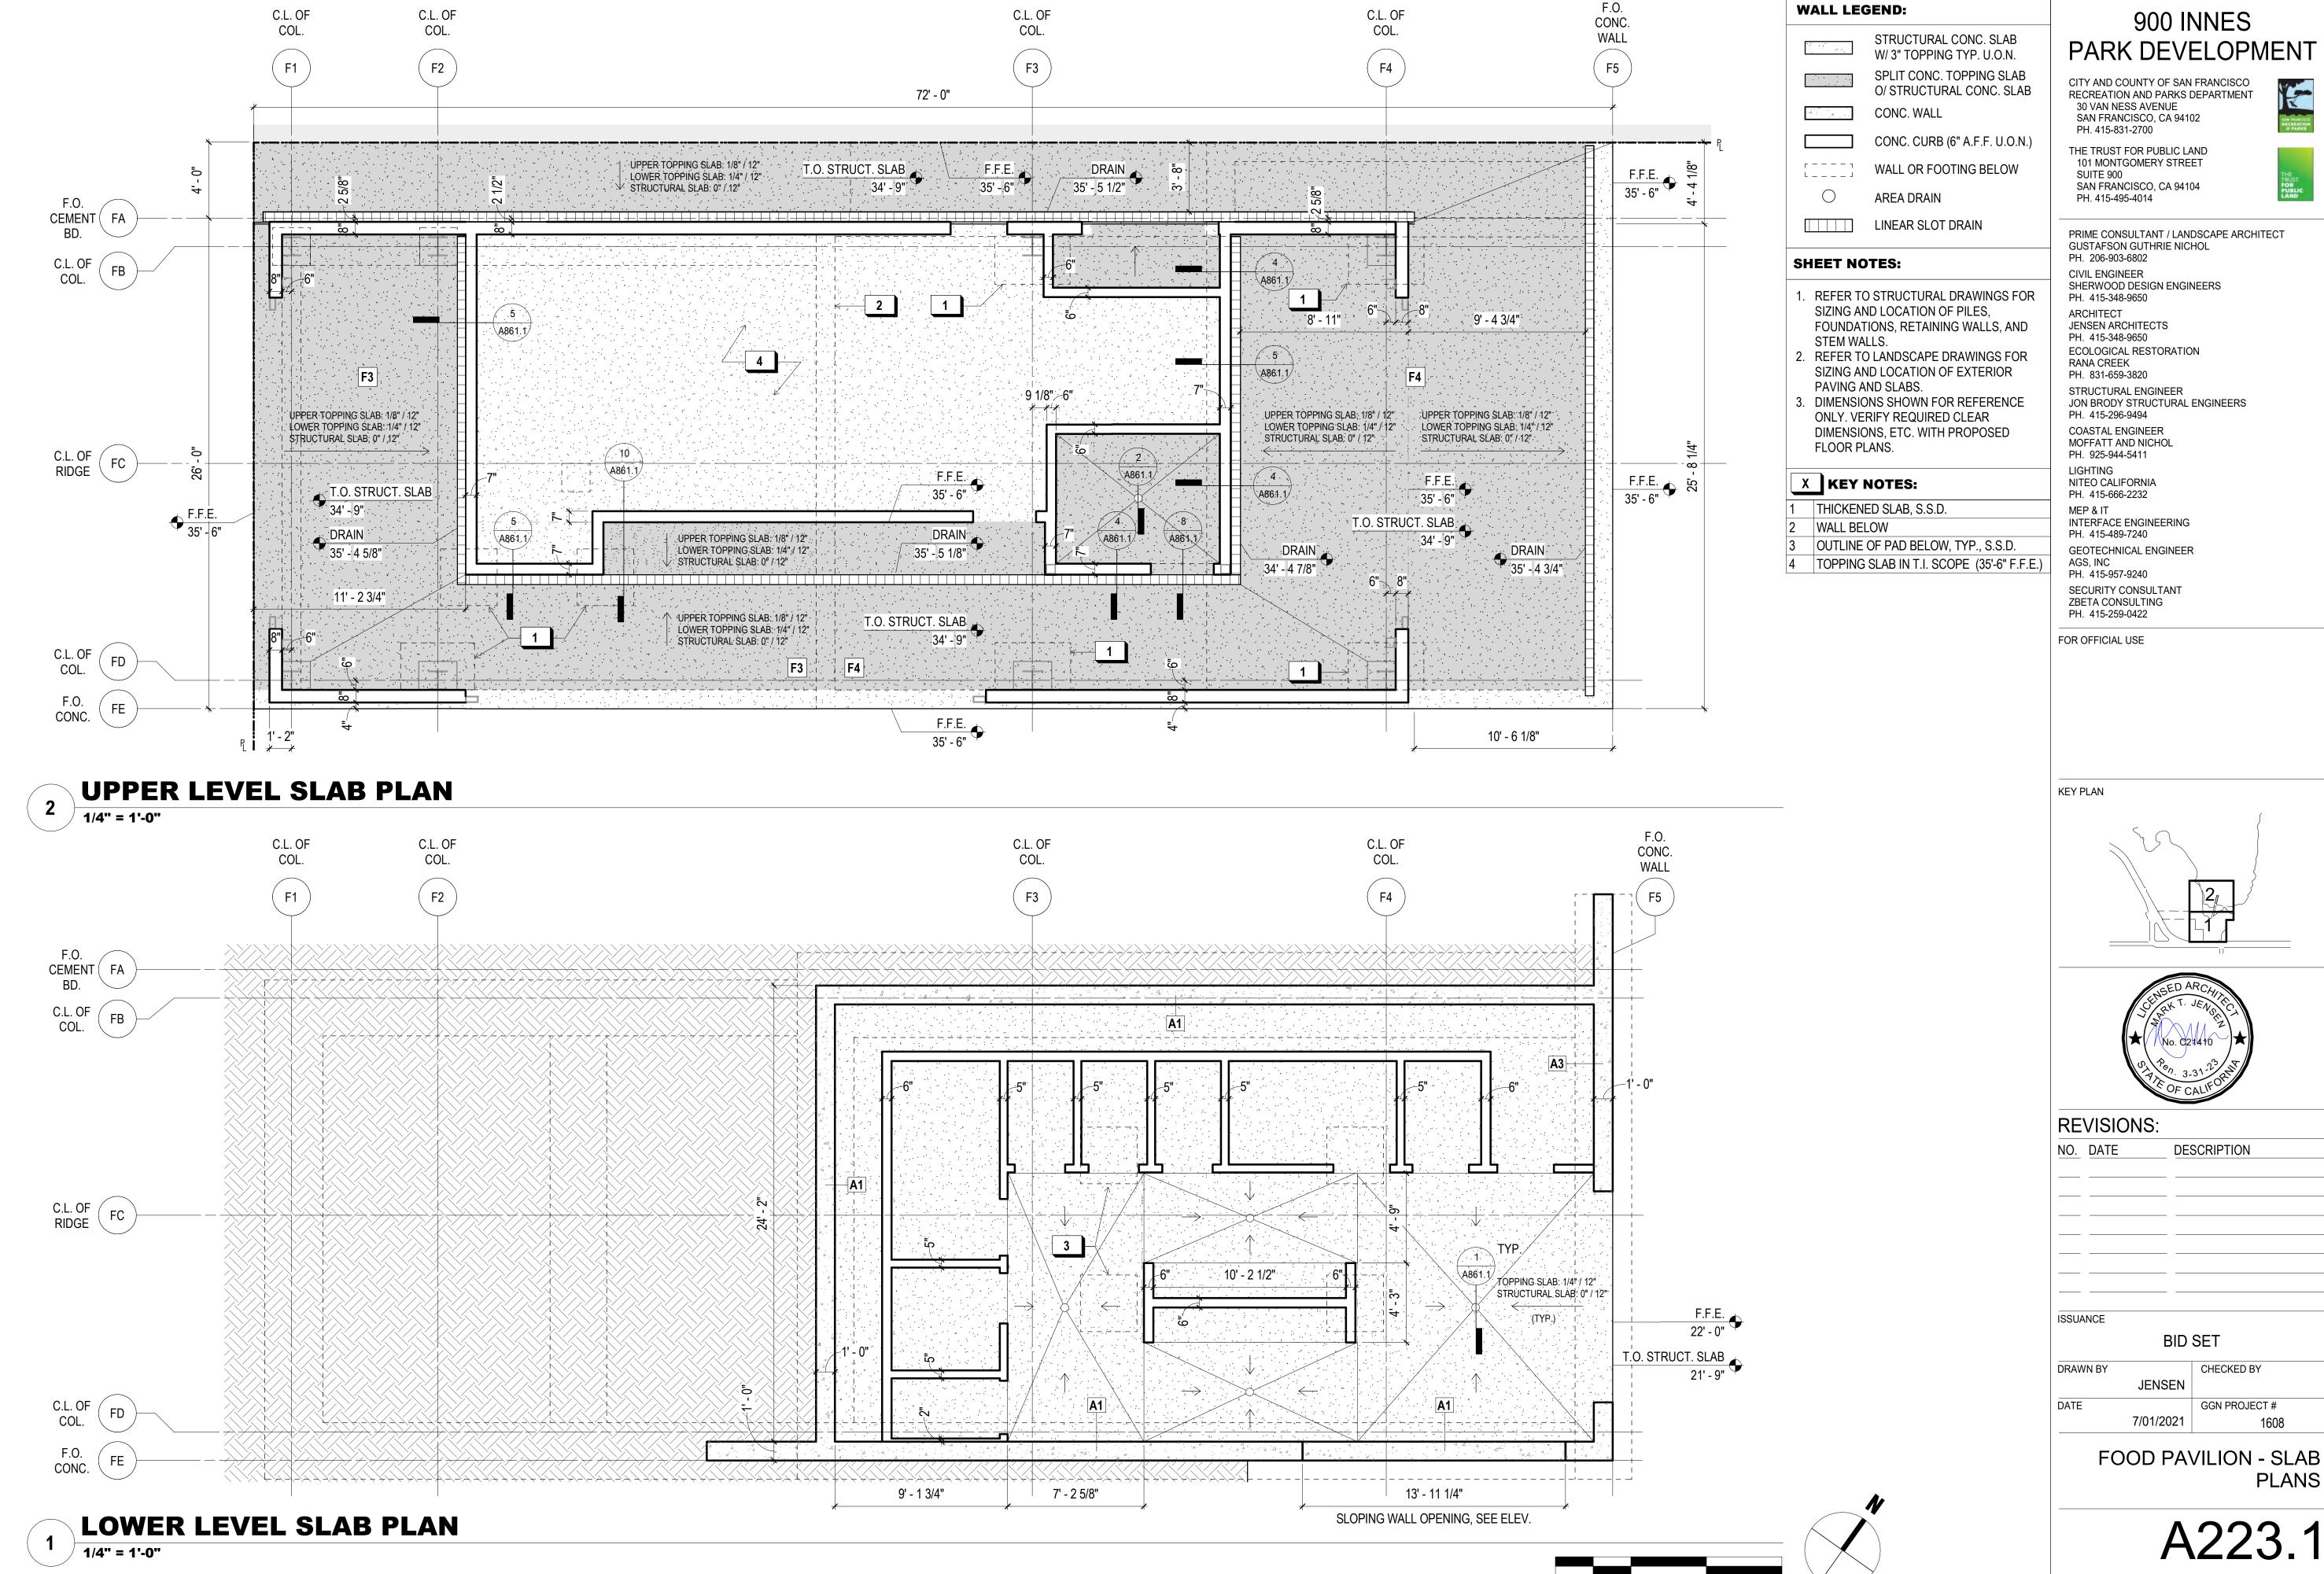


PLANS

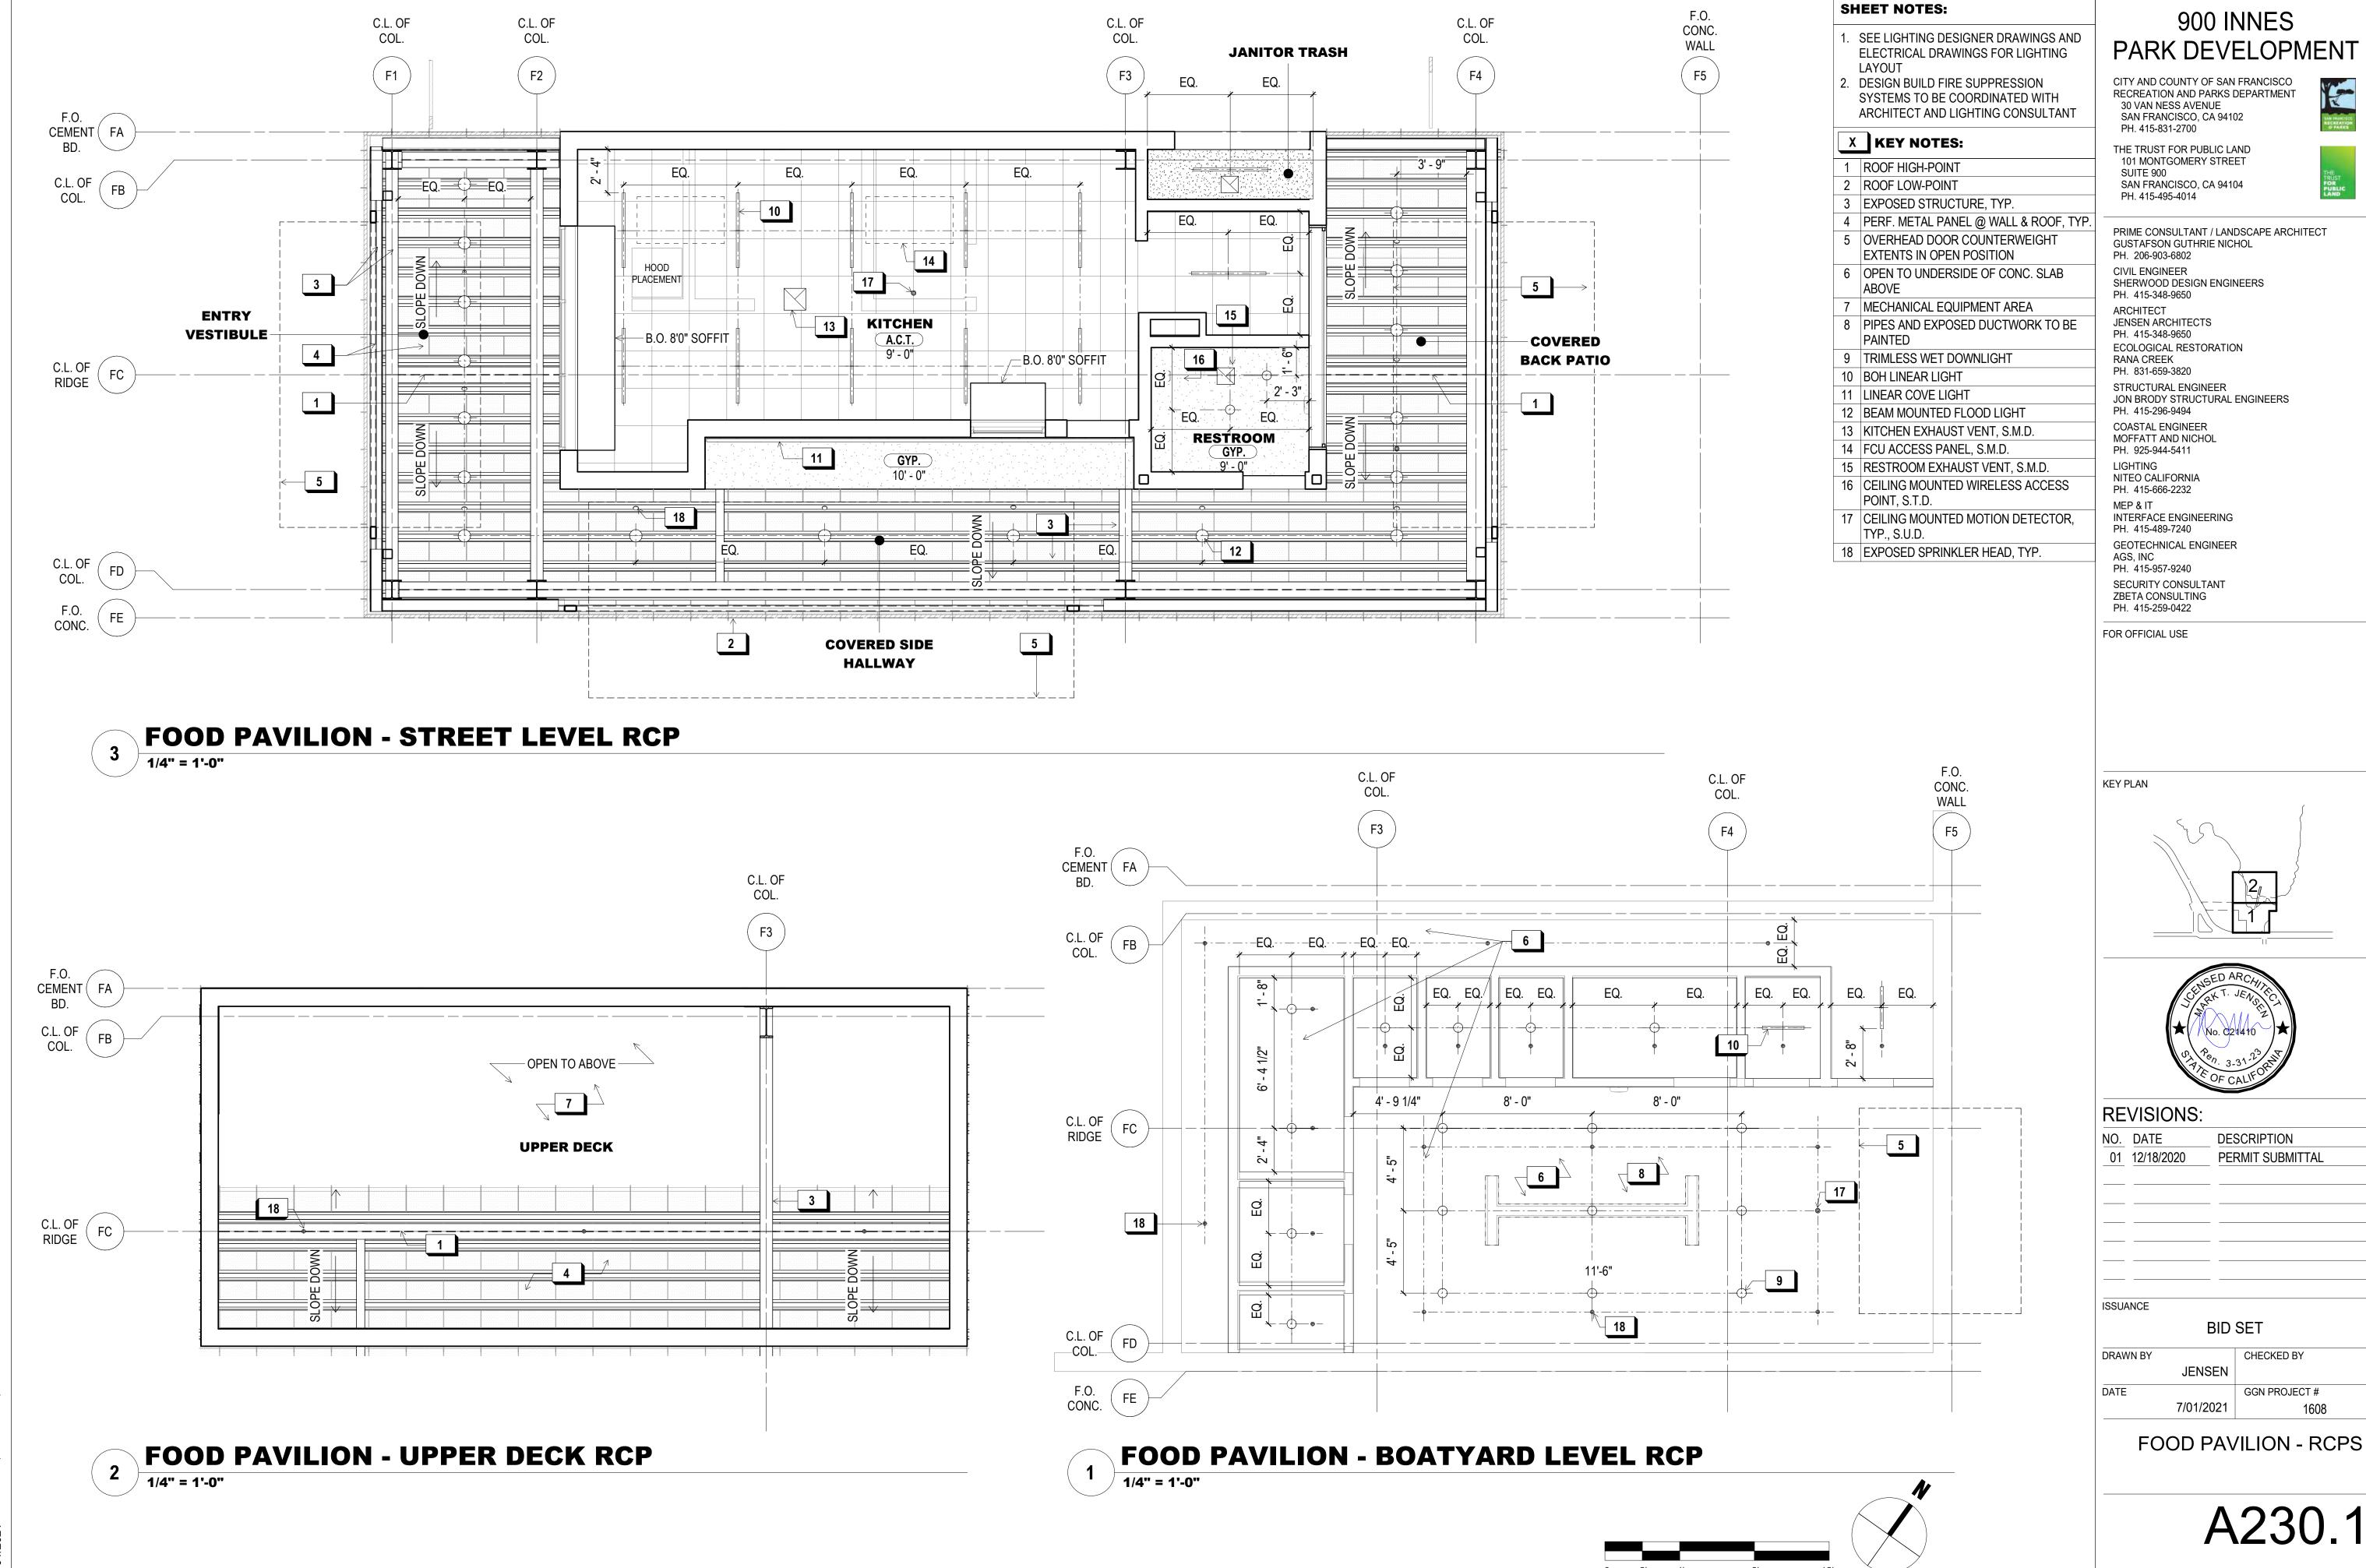

PARK DEVELOPMENT



PRIME CONSULTANT / LANDSCAPE ARCHITECT

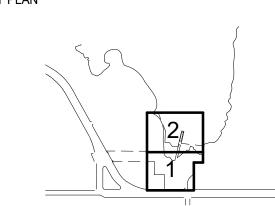





PERMIT SUBMITTAL


GGN PROJECT #

A230.1

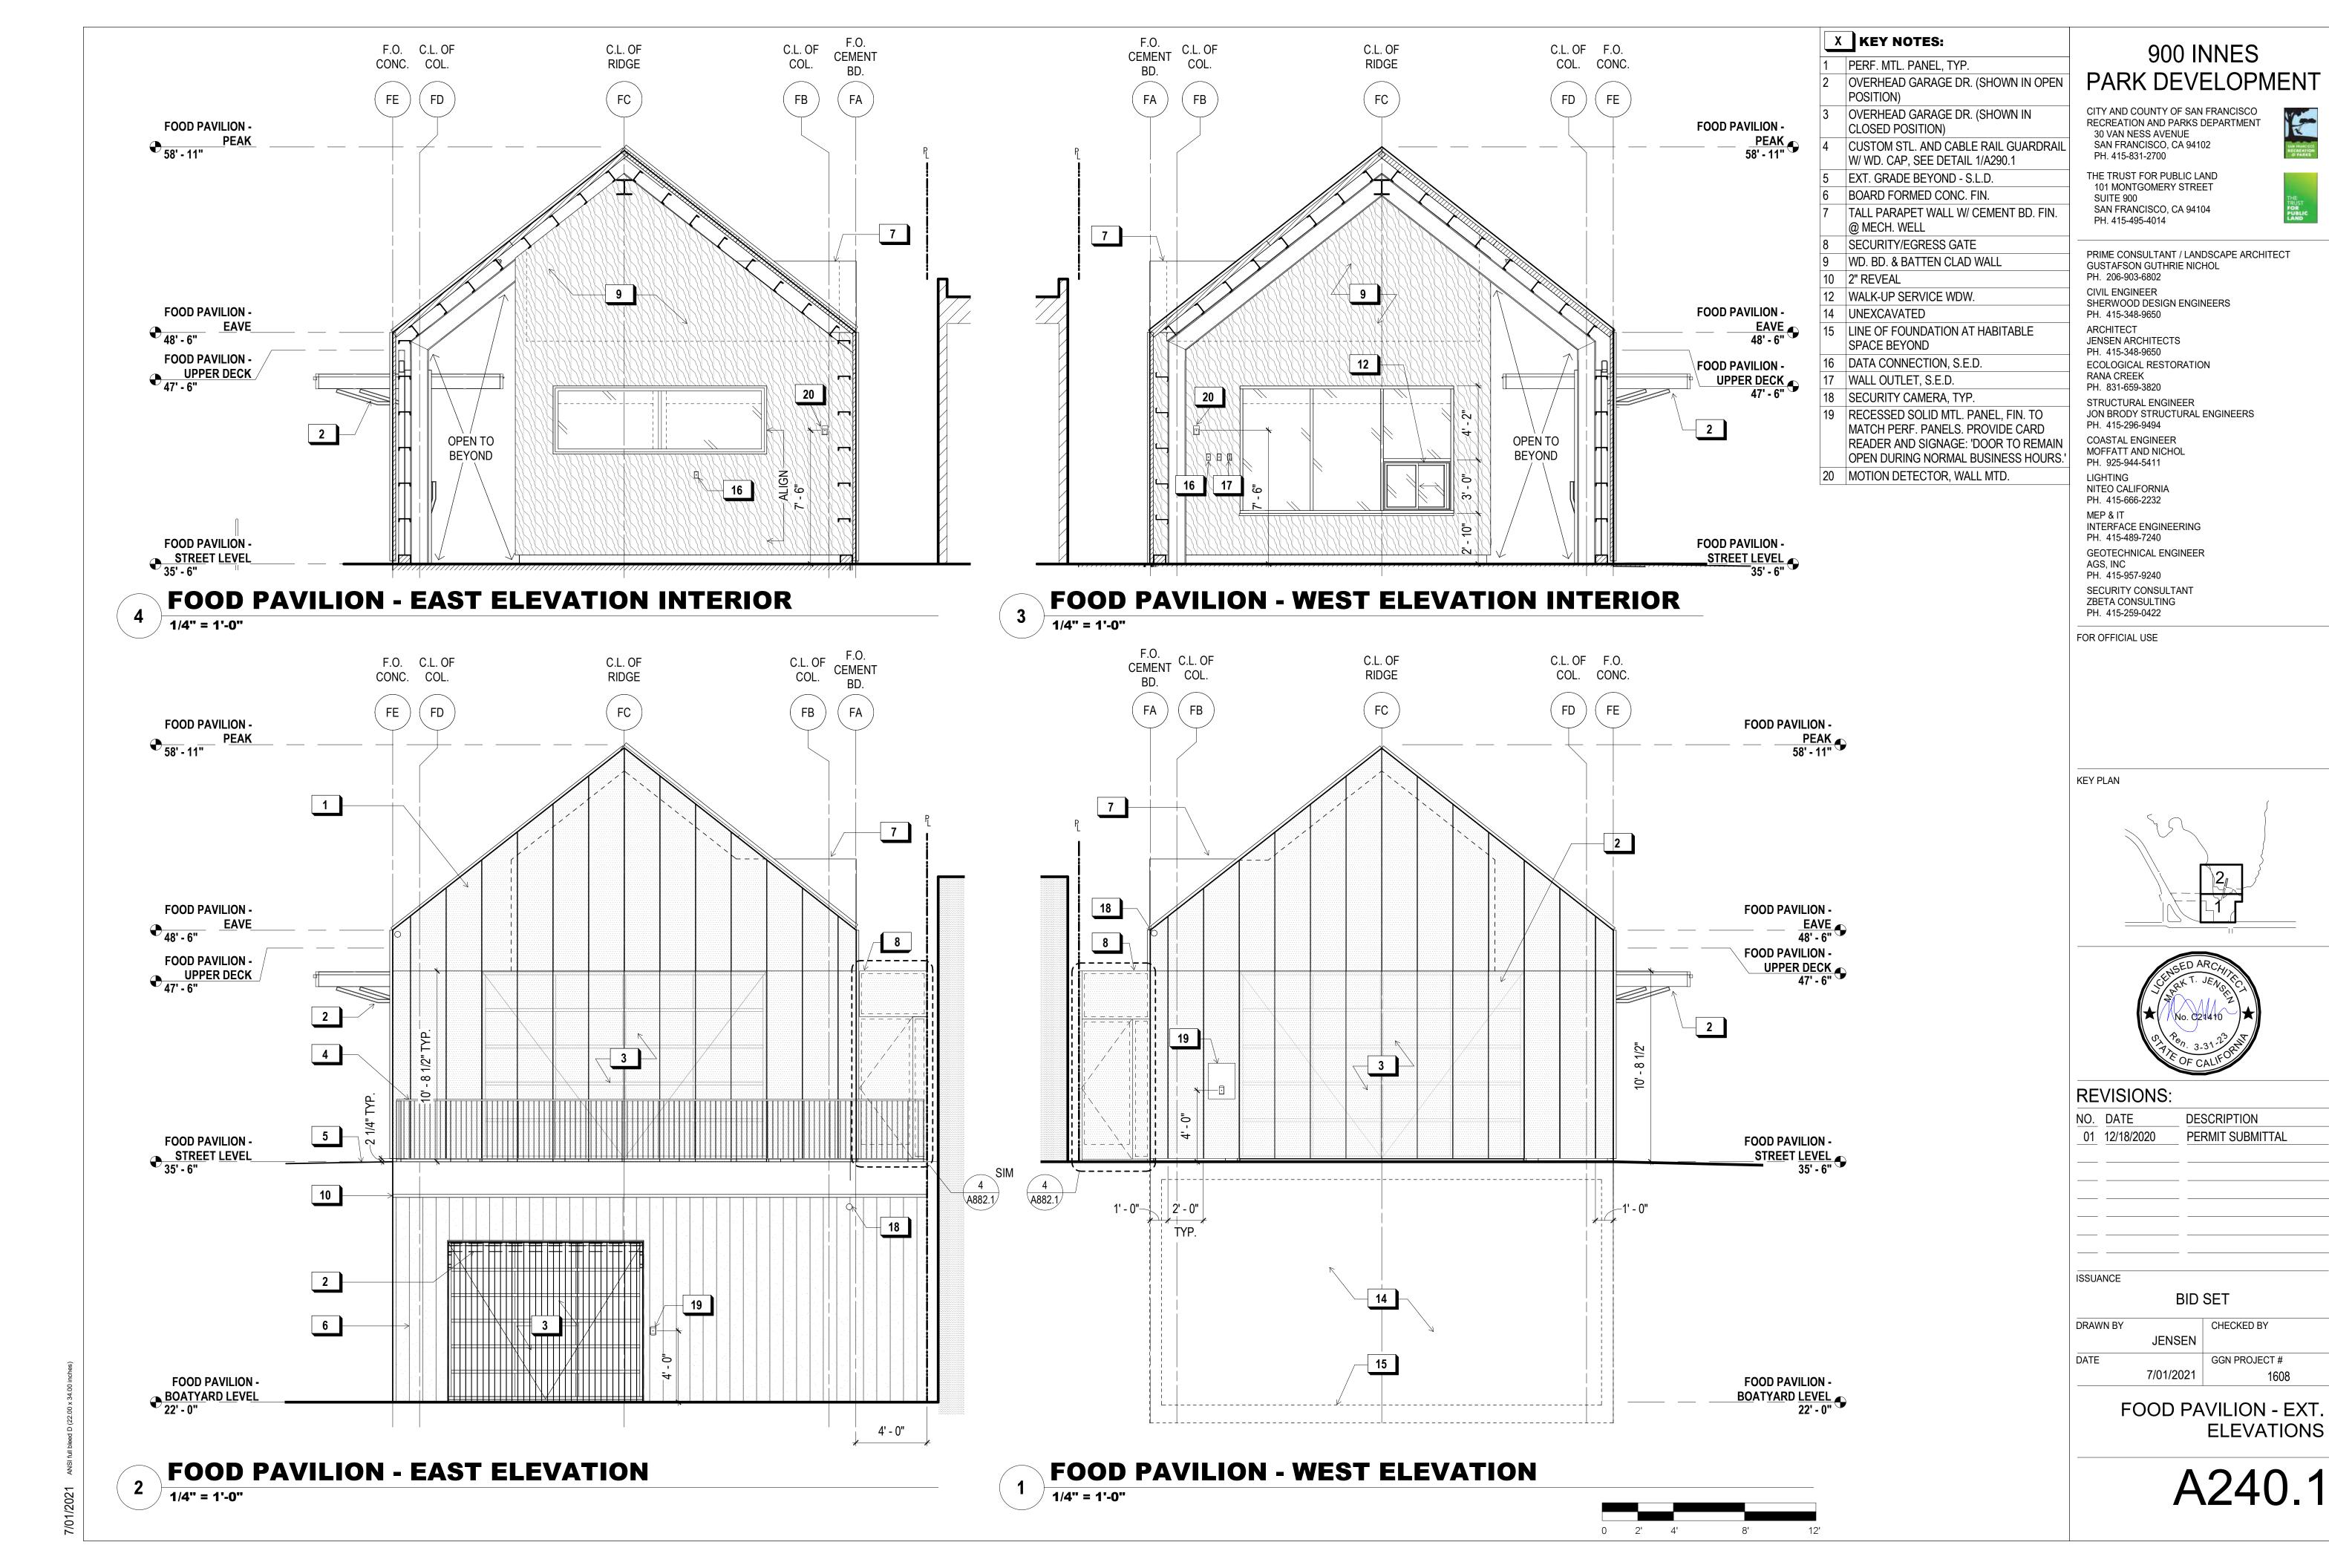

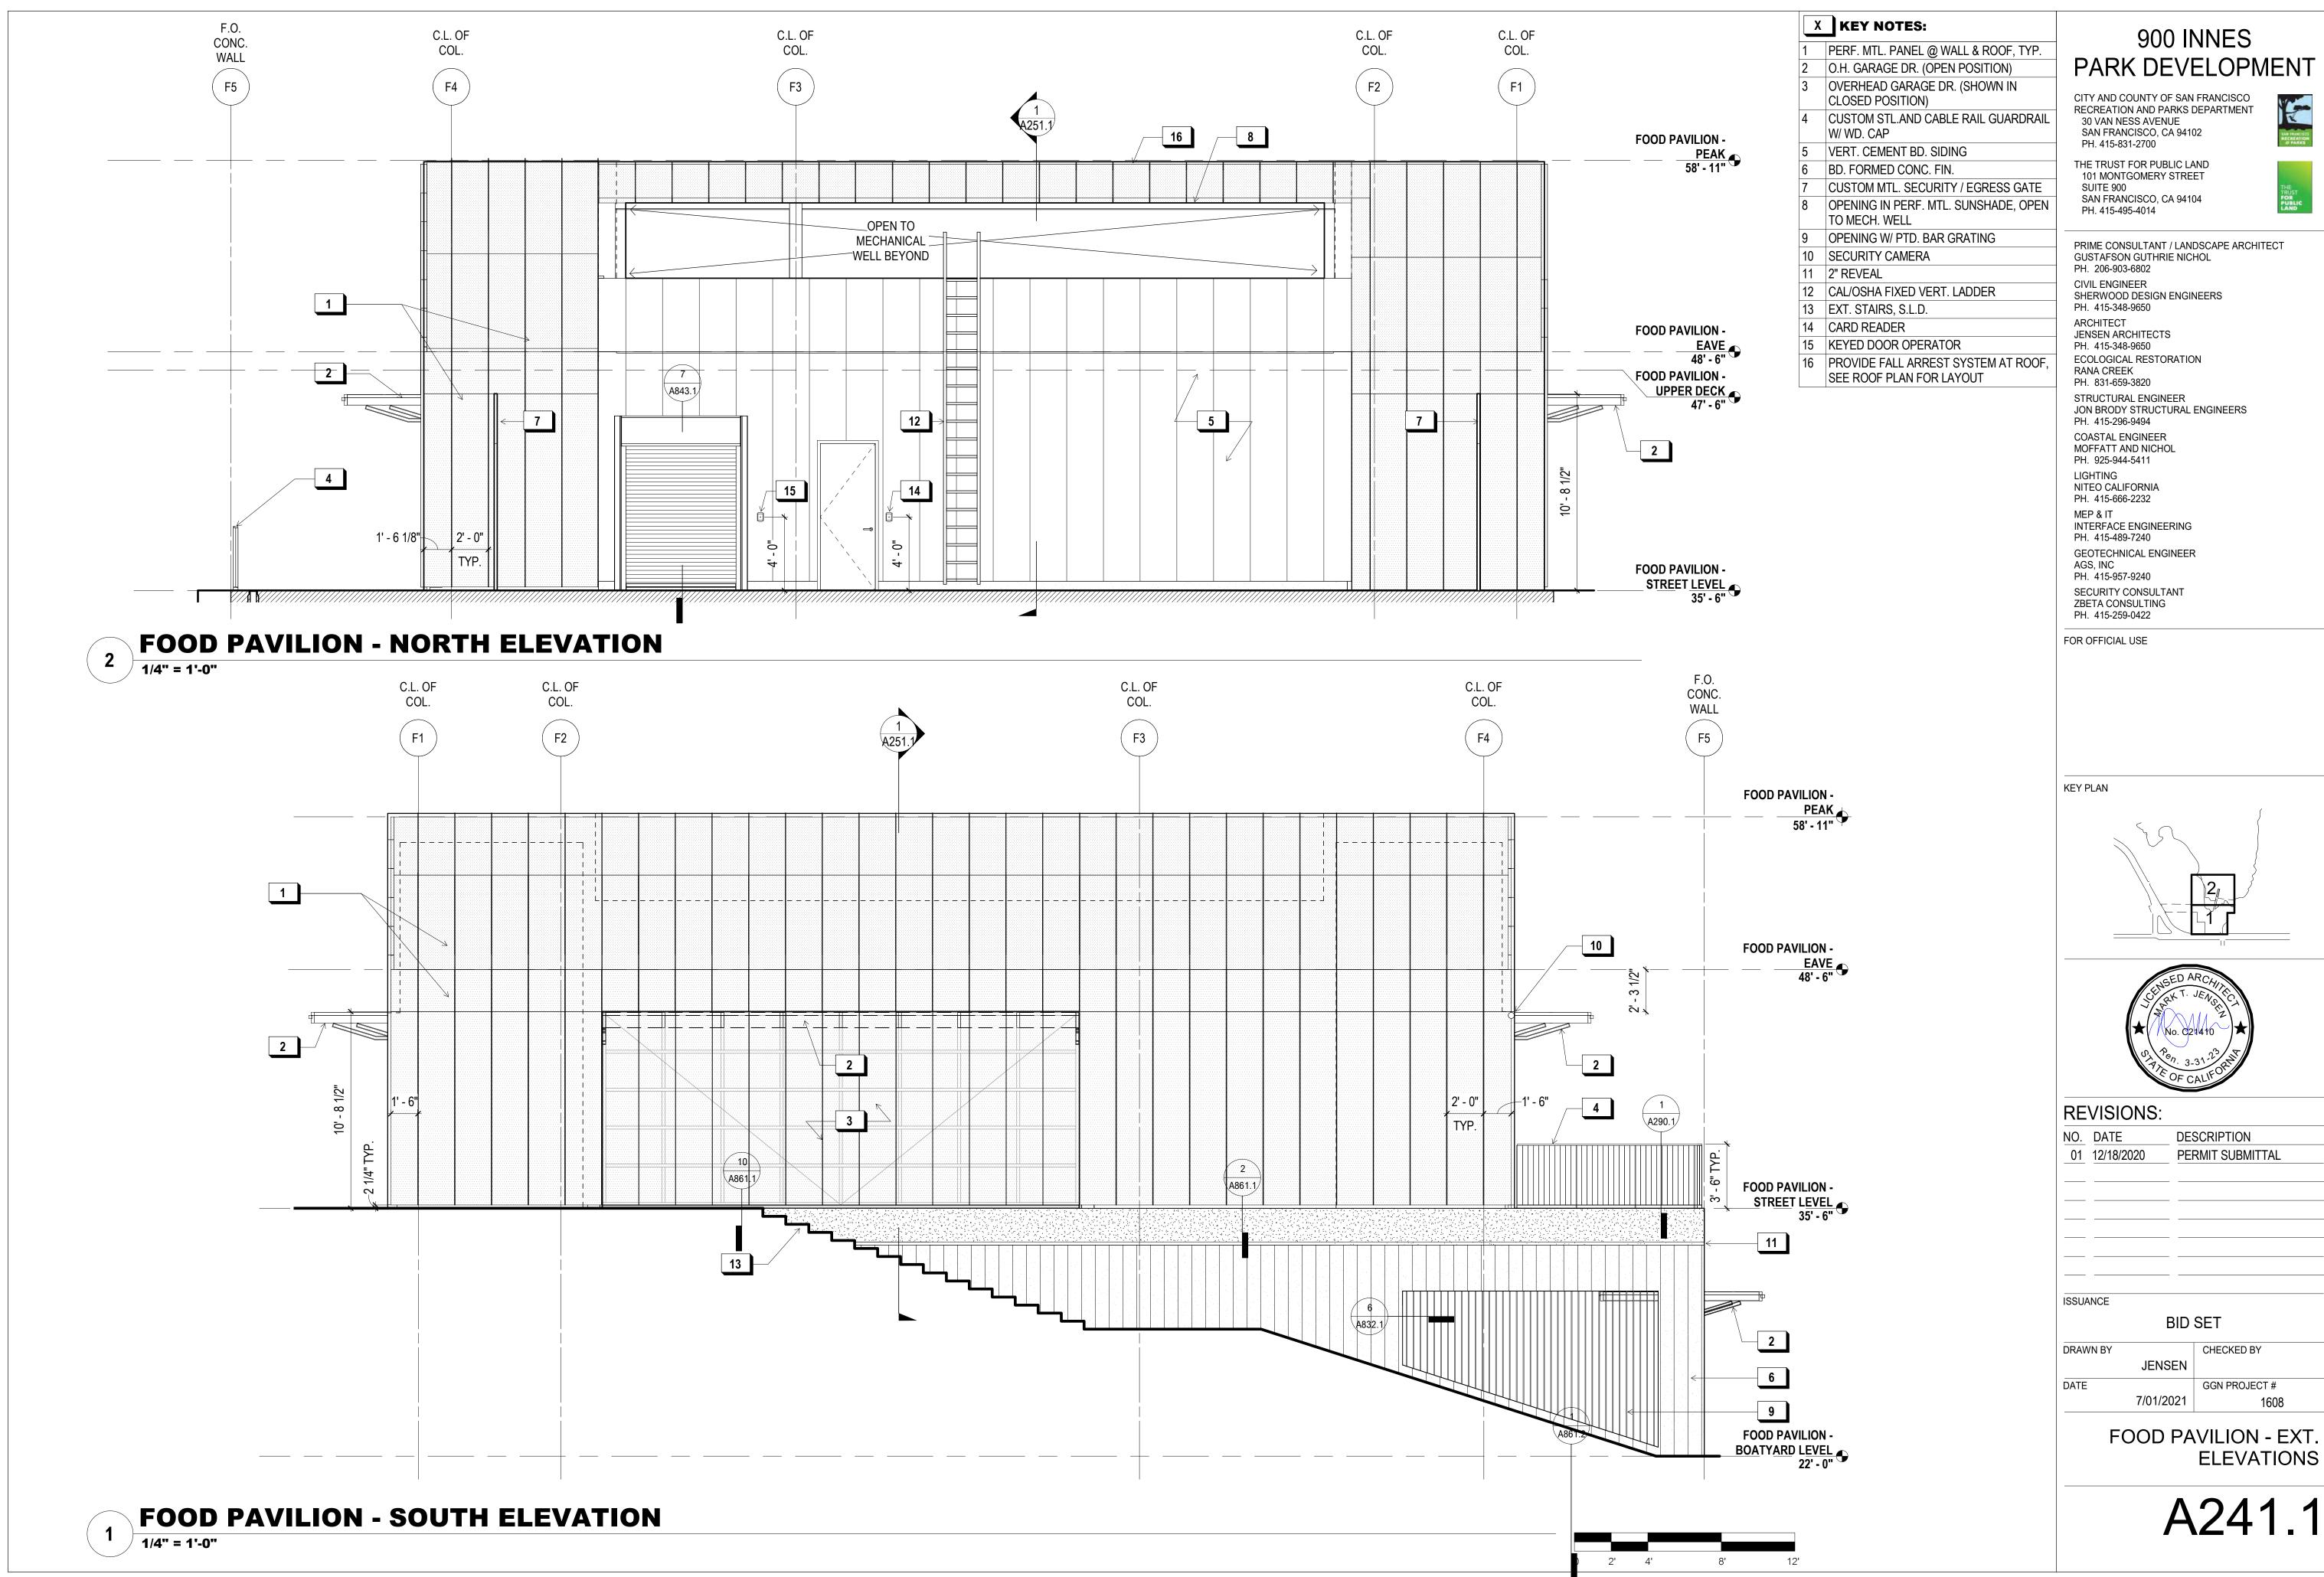

(01/2021) ANSI full bleed D (22.00 imes 34.0

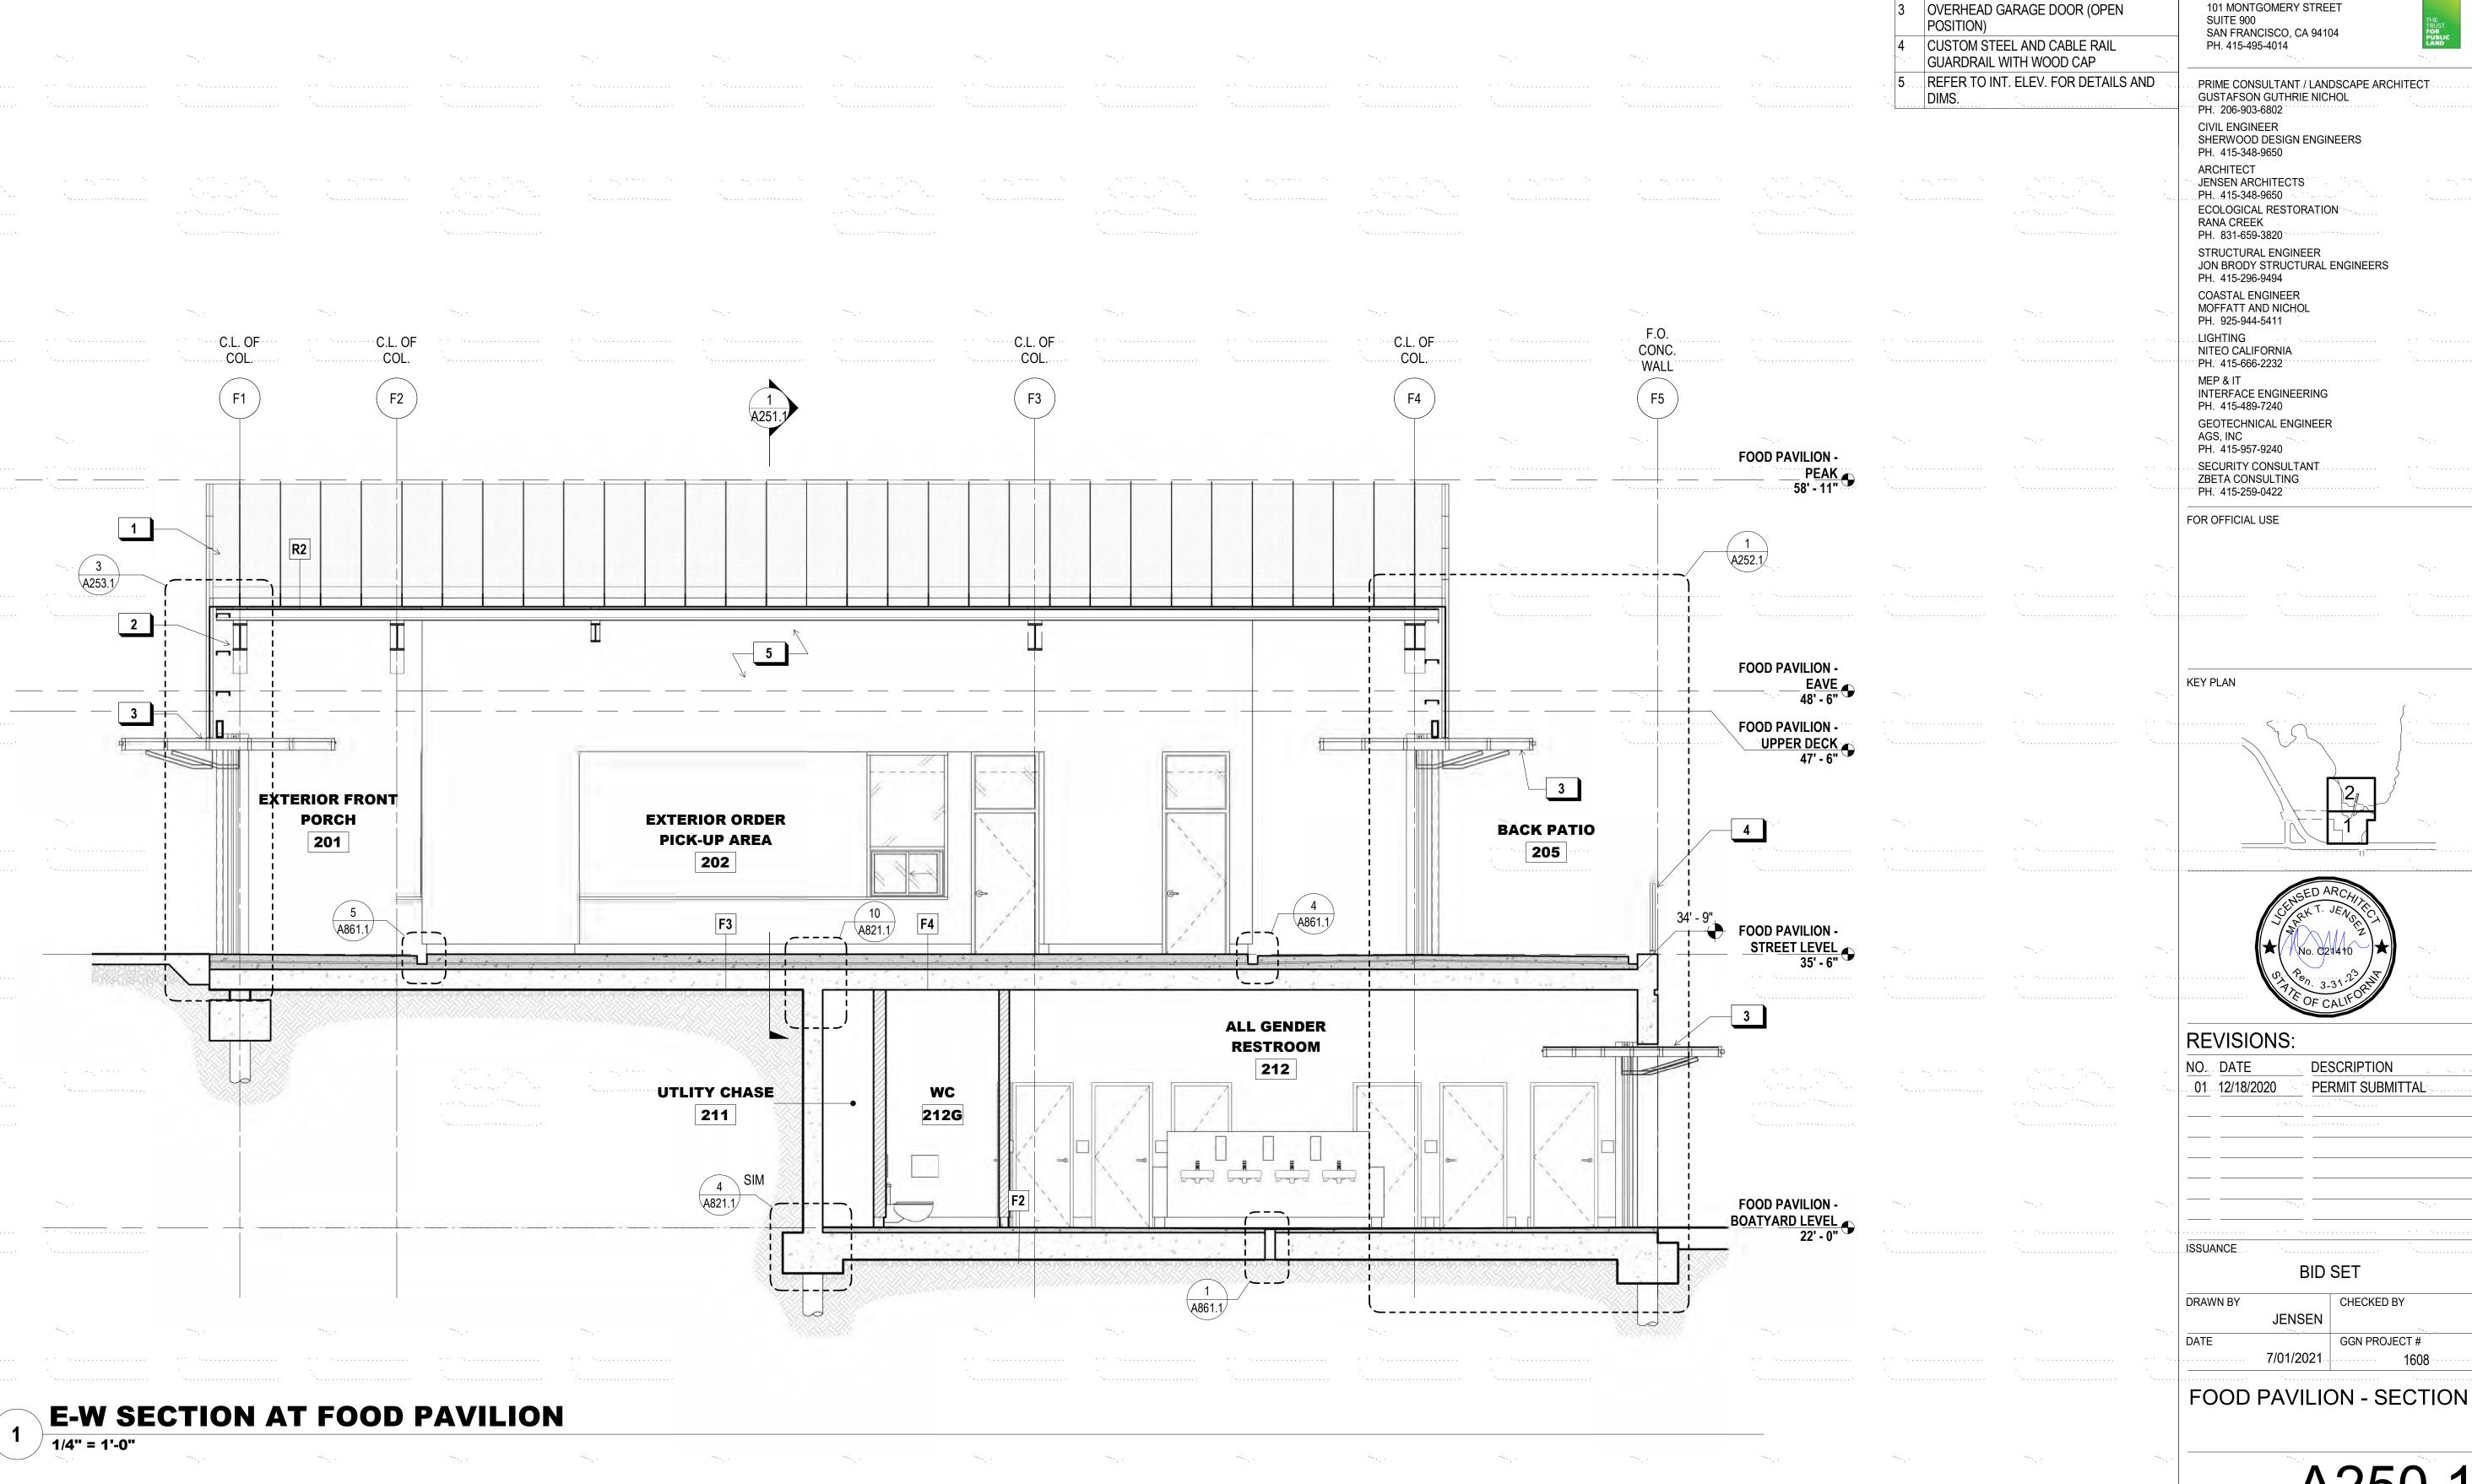

CITY AND COUNTY OF SAN FRANCISCO RECREATION AND PARKS DEPARTMENT 30 VAN NESS AVENUE

SHEET NOTES:

ASSEMBLIES.

X KEY NOTES:

PERF. METAL PANEL, TYP.

STEEL STRUCT. FRAME- S.S.D.


1. SEE SHEET A811.1 FOR FLOOR AND ROOF



SAN FRANCISCO, CA 94102 PH. 415-831-2700 THE TRUST FOR PUBLIC LAND 101 MONTGOMERY STREET



A250.1

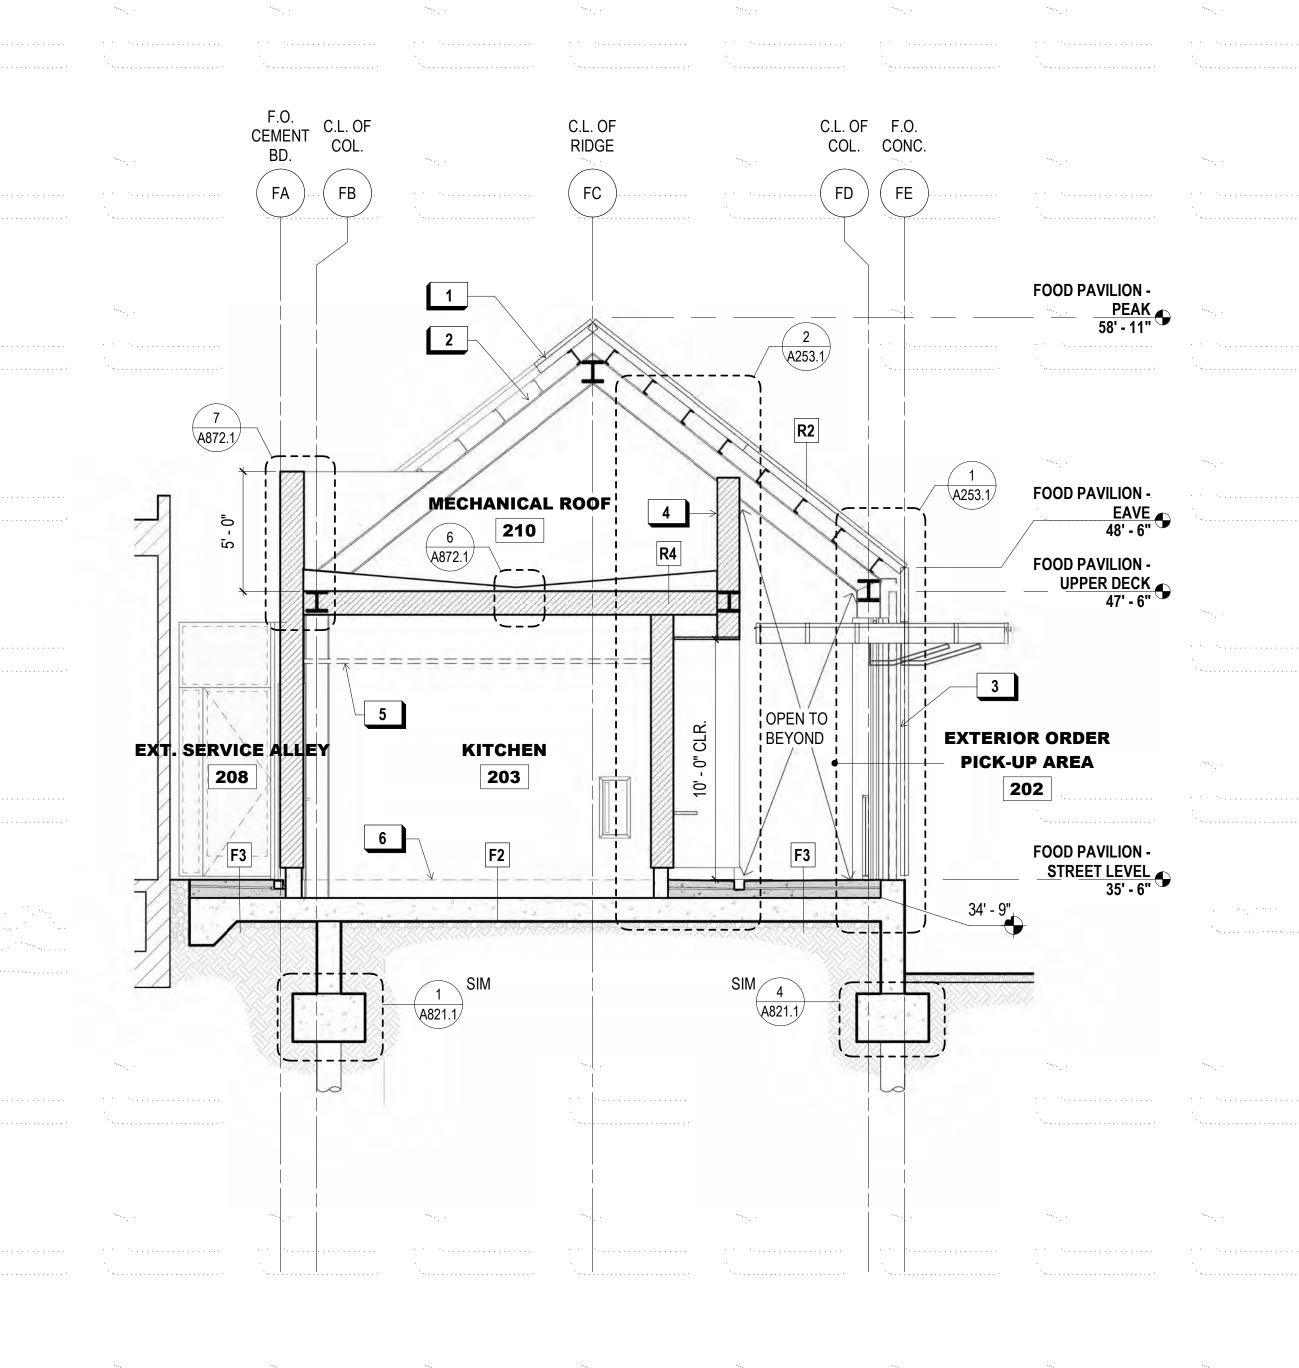

900 INNES 1. SEE SHEET A811.1 FOR FLOOR AND ROOF PARK DEVELOPMENT

CITY AND COUNTY OF SAN FRANCISCO RECREATION AND PARKS DEPARTMENT 30 VAN NESS AVENUE

SHEET NOTES:

ASSEMBLIES.

X KEY NOTES:

PERF. METAL PANEL, TYP.

PERF. MTL. O.H. DR.

@ MECH. WELL

STEEL STRUCT. FRAME- S.S.D.

TALL PARAPET WALL W/ CEMENT BD. FIN.

DROPPED T-BAR CLG. (T.I. SCOPE)

TOPPING SLAB (T.I. SCOPE)



PH. 415-831-2700 THE TRUST FOR PUBLIC LAND 101 MONTGOMERY STREET SUITE 900 SAN FRANCISCO, CA 94104 PH. 415-495-4014

RANA CREEK PH. 831-659-3820


SAN FRANCISCO, CA 94102



PRIME CONSULTANT / LANDSCAPE ARCHITECT GUSTAFSON GUTHRIE NICHOL PH. 206-903-6802 CIVIL ENGINEER SHERWOOD DESIGN ENGINEERS PH. 415-348-9650 ARCHITECT JENSEN ARCHITECTS PH. 415-348-9650 ECOLOGICAL RESTORATION

STRUCTURAL ENGINEER JON BRODY STRUCTURAL ENGINEERS PH. 415-296-9494 COASTAL ENGINEER MOFFATT AND NICHOL PH. 925-944-5411 LIGHTING NITEO CALIFORNIA PH. 415-666-2232 MEP & IT INTERFACE ENGINEERING PH. 415-489-7240 GEOTECHNICAL ENGINEER AGS, INC PH. 415-957-9240 SECURITY CONSULTANT ZBETA CONSULTING PH. 415-259-0422 FOR OFFICIAL USE

KEY PLAN

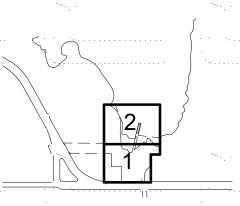



REVISIONS	:
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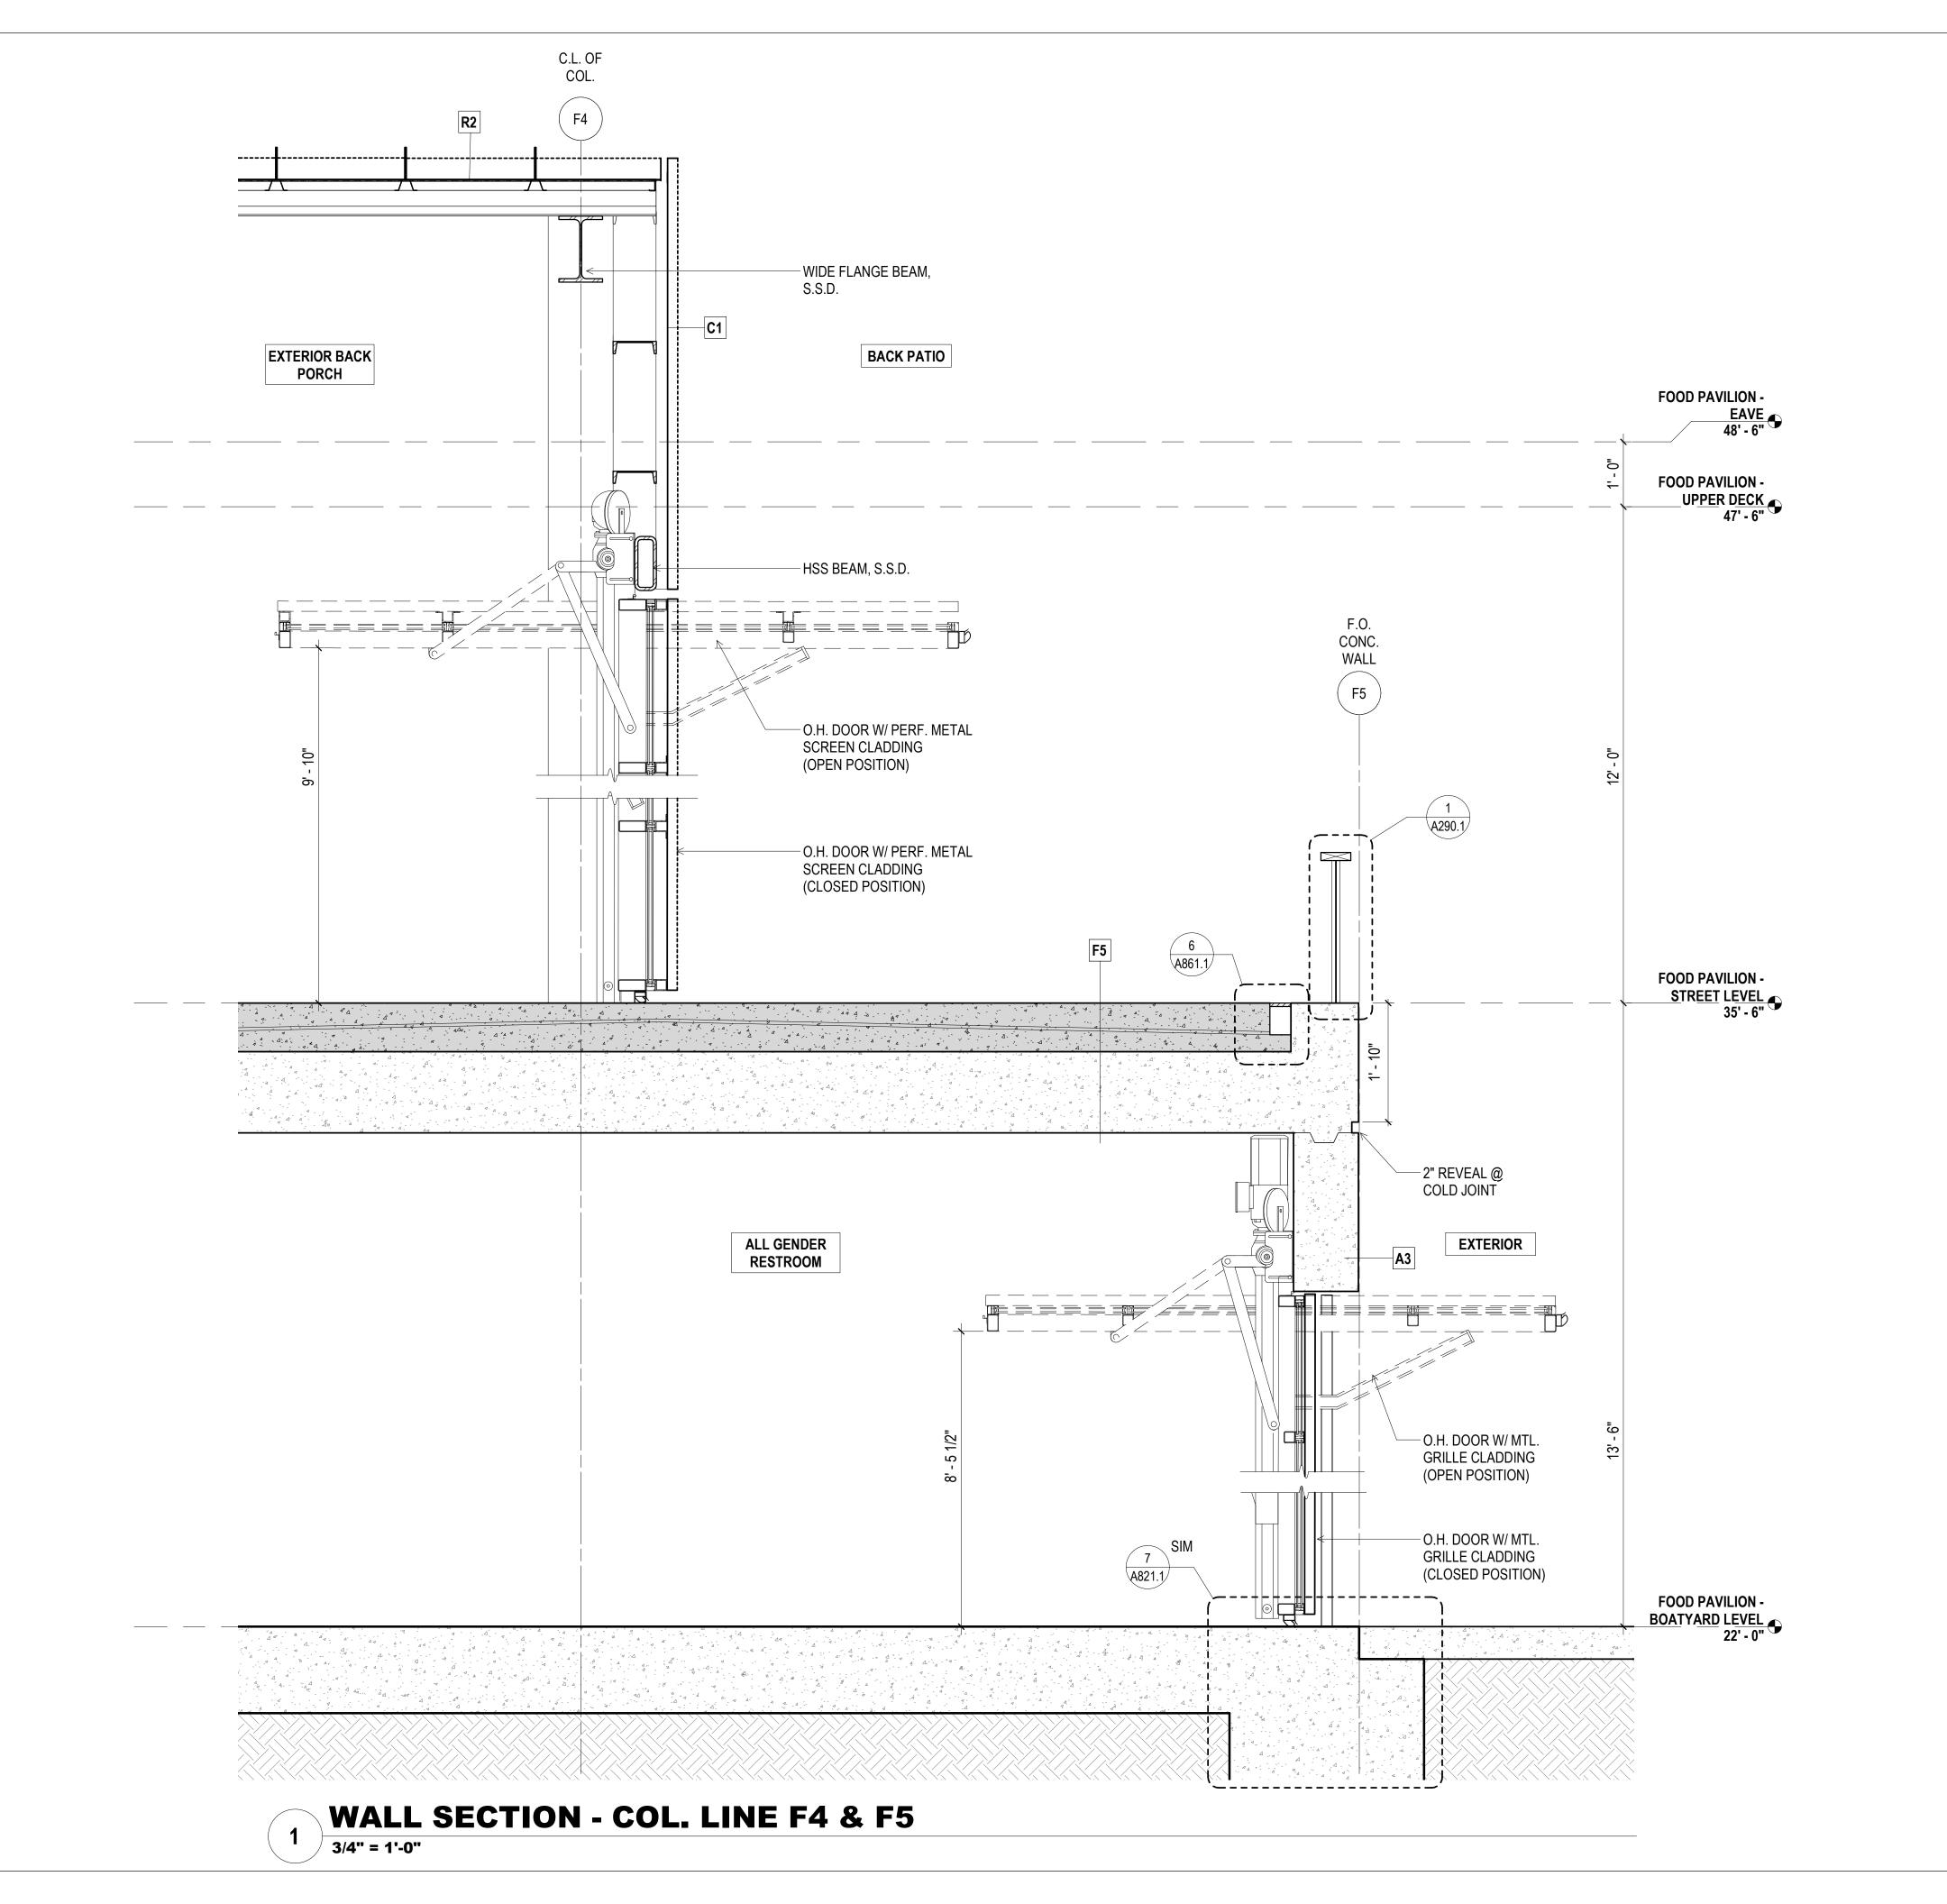
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GGN PROJECT #

7/01/2021

FOOD PAVILION - SECTION

A251.1



CITY AND COUNTY OF SAN FRANCISCO RECREATION AND PARKS DEPARTMENT 30 VAN NESS AVENUE SAN FRANCISCO, CA 94102




THE TRUST FOR PUBLIC LAND 101 MONTGOMERY STREET SUITE 900 SAN FRANCISCO, CA 94104 PH. 415-495-4014



PRIME CONSULTANT / LANDSCAPE ARCHITECT GUSTAFSON GUTHRIE NICHOL PH. 206-903-6802 CIVIL ENGINEER SHERWOOD DESIGN ENGINEERS PH. 415-348-9650 ARCHITECT JENSEN ARCHITECTS PH. 415-348-9650 ECOLOGICAL RESTORATION RANA CREEK PH. 831-659-3820 STRUCTURAL ENGINEER JON BRODY STRUCTURAL ENGINEERS PH. 415-296-9494 COASTAL ENGINEER MOFFATT AND NICHOL PH. 925-944-5411 LIGHTING NITEO CALIFORNIA PH. 415-666-2232 MEP & IT INTERFACE ENGINEERING PH. 415-489-7240 GEOTECHNICAL ENGINEER AGS, INC PH. 415-957-9240 SECURITY CONSULTANT ZBETA CONSULTING PH. 415-259-0422

KEY PLAN

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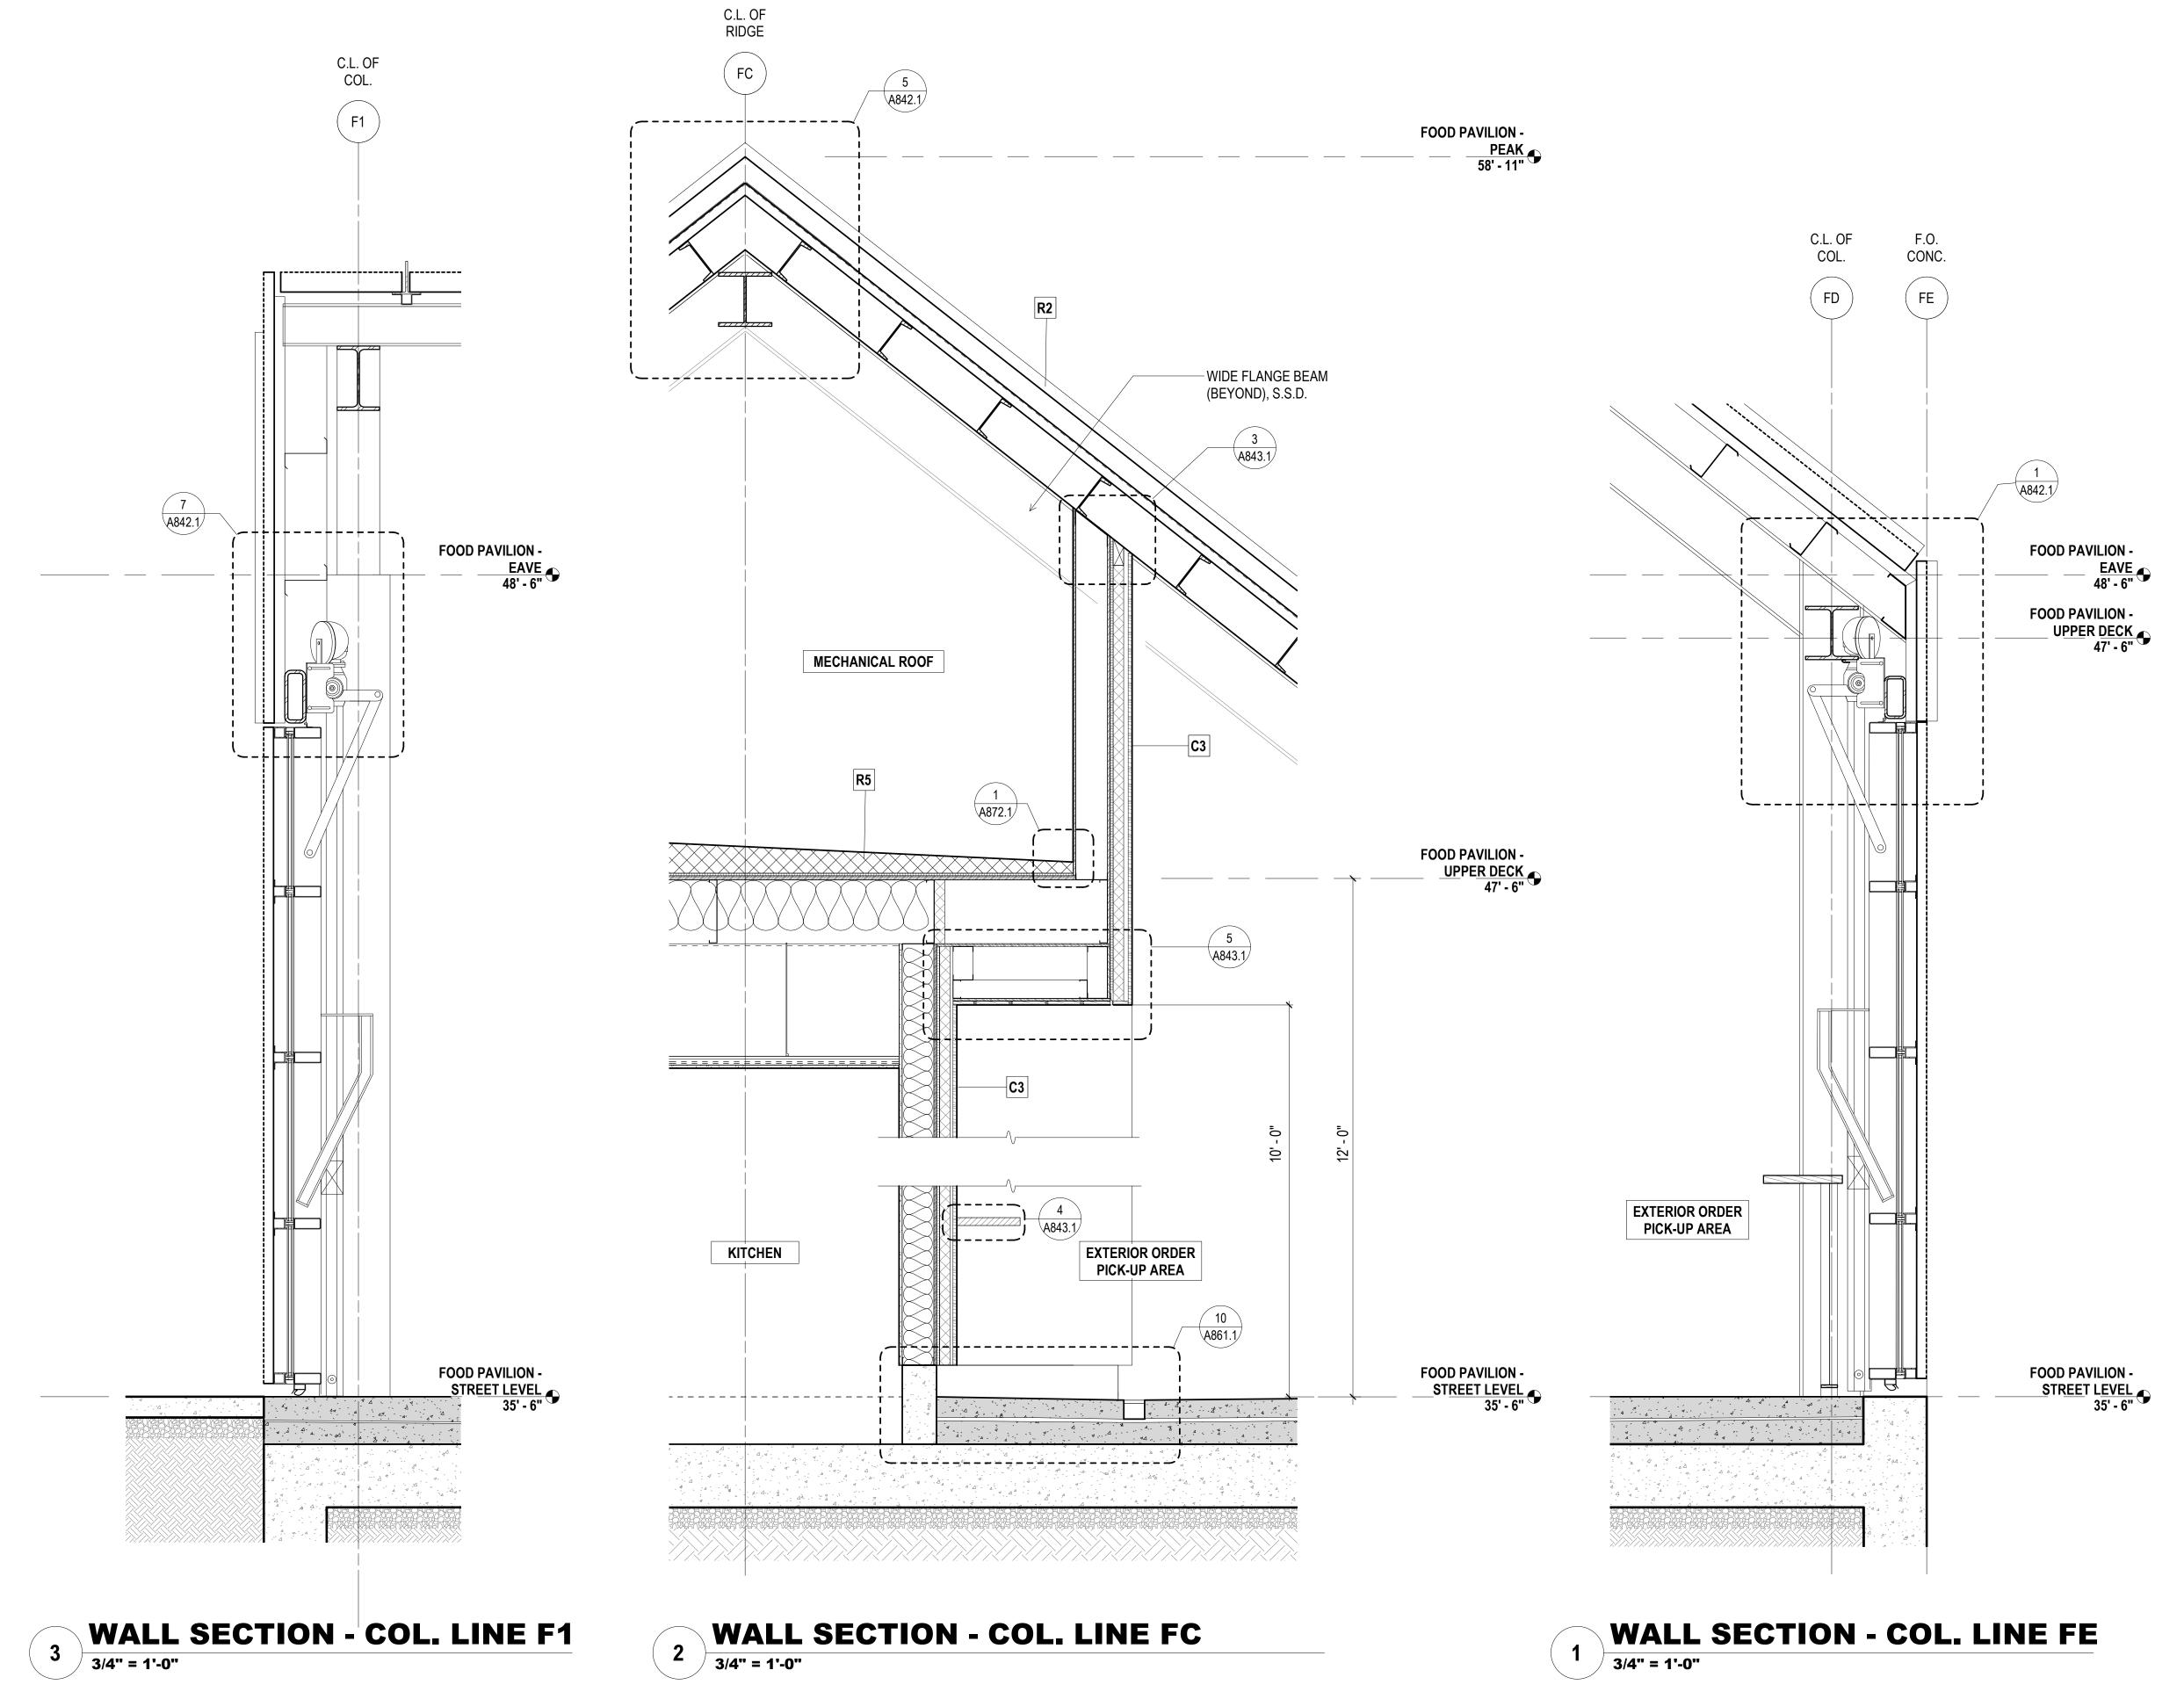
REVISIONS:		
NO. DATE	DESCRIPTION	
ISSUANCE		
	BID SET	

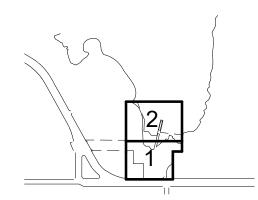JENSEN GGN PROJECT # 7/01/2021

DRAWN BY

FOOD PAVILION - WALL SECTIONS A252.1

CHECKED BY



CITY AND COUNTY OF SAN FRANCISCO RECREATION AND PARKS DEPARTMENT 30 VAN NESS AVENUE

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THE TRUST FOR PUBLIC LAND 101 MONTGOMERY STREET SUITE 900 SAN FRANCISCO, CA 94104


PH. 415-495-4014



PRIME CONSULTANT / LANDSCAPE ARCHITECT GUSTAFSON GUTHRIE NICHOL PH. 206-903-6802 CIVIL ENGINEER SHERWOOD DESIGN ENGINEERS PH. 415-348-9650 ARCHITECT JENSEN ARCHITECTS PH. 415-348-9650 ECOLOGICAL RESTORATION RANA CREEK PH. 831-659-3820 STRUCTURAL ENGINEER JON BRODY STRUCTURAL ENGINEERS PH. 415-296-9494 COASTAL ENGINEER MOFFATT AND NICHOL PH. 925-944-5411 LIGHTING NITEO CALIFORNIA PH. 415-666-2232 MEP & IT INTERFACE ENGINEERING PH. 415-489-7240 GEOTECHNICAL ENGINEER AGS, INC PH. 415-957-9240 SECURITY CONSULTANT ZBETA CONSULTING PH. 415-259-0422

FOR OFFICIAL USE

KEY PLAN

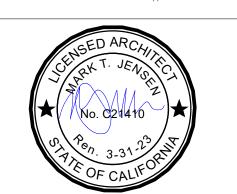

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JENSEN

7/01/2021

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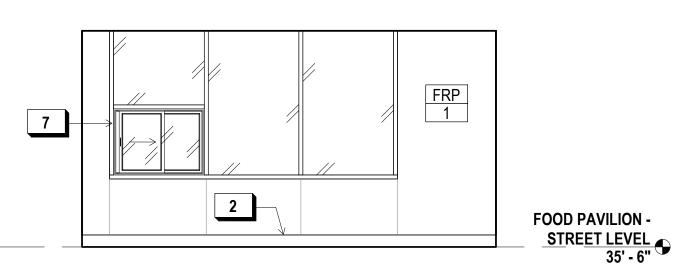
FOOD PAVILION - WALL SECTIONS

CHECKED BY


GGN PROJECT #

A253.1





EAST KITCHEN ELEVATION 2) 1/4" = 1'-0"

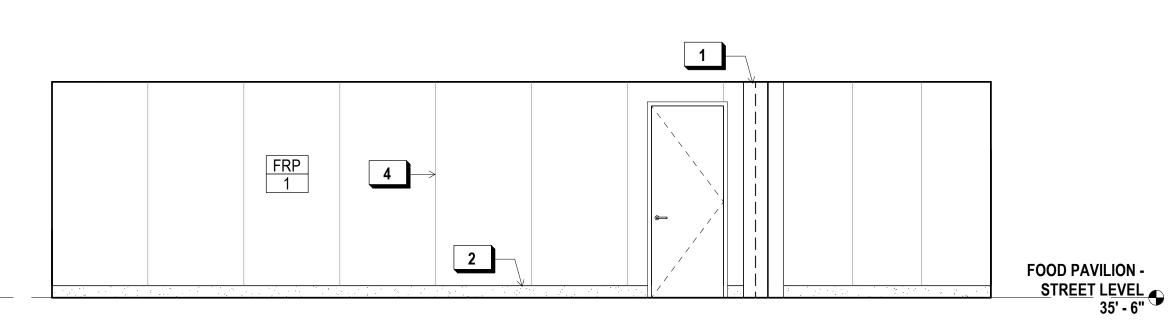

SHEET NOTES:

X KEY NOTES:

DATA CONNECTION

FRP WALL PANELING JOINT

BUILT-IN MILLWORK (BEYOND)

SLIDING SERVICE WINDOW, TYP.

LAYOUT

ELECTRICAL DRAWINGS FOR LIGHTING

2. SEE FINISH FLOOR PLANS OR PROPOSED

FLOOR PLANS FOR FINISH SCHEDULE


3. SEE FINISH FLOOR PLANS OR PROPOSED

FLOOR PLANS FOR FINISH SCHEDULE

VERTICAL STRUCTURAL SUPPORT, S.S.D.

CONC. CURB FOR FRAMED WALL, TYP.

SOUTH KITCHEN ELEVATION 1/4" = 1'-0"

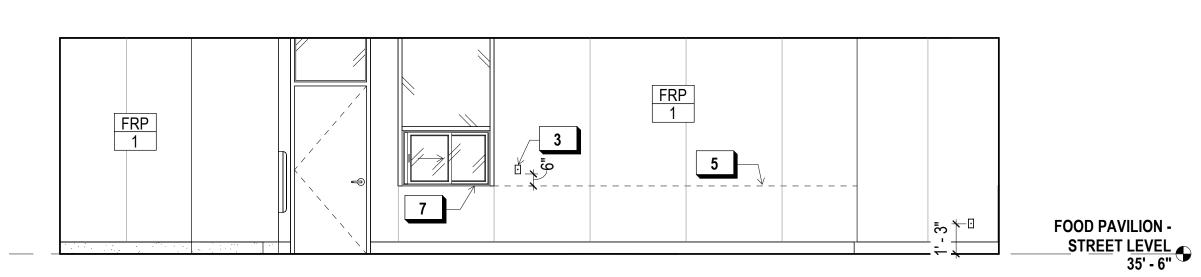


NORTH KITCHEN ELEVATION 1/4" = 1'-0"

900 INNES SEE LIGHTING DESIGNER DRAWINGS AND PARK DEVELOPMENT

CITY AND COUNTY OF SAN FRANCISCO RECREATION AND PARKS DEPARTMENT

PH. 415-495-4014

30 VAN NESS AVENUE SAN FRANCISCO, CA 94102 PH. 415-831-2700

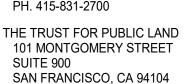




PRIME CONSULTANT / LANDSCAPE ARCHITECT GUSTAFSON GUTHRIE NICHOL PH. 206-903-6802 CIVIL ENGINEER SHERWOOD DESIGN ENGINEERS PH. 415-348-9650 ARCHITECT JENSEN ARCHITECTS PH. 415-348-9650 ECOLOGICAL RESTORATION RANA CREEK PH. 831-659-3820 STRUCTURAL ENGINEER JON BRODY STRUCTURAL ENGINEERS PH. 415-296-9494 COASTAL ENGINEER MOFFATT AND NICHOL PH. 925-944-5411 LIGHTING NITEO CALIFORNIA PH. 415-666-2232 MEP & IT INTERFACE ENGINEERING PH. 415-489-7240 GEOTECHNICAL ENGINEER AGS, INC PH. 415-957-9240 SECURITY CONSULTANT ZBETA CONSULTING

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PH. 415-259-0422



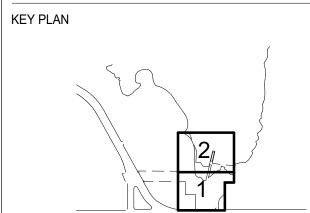

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NO. DATE	DESCRIPTION	

ISSUANCE


BID SET CHECKED BY

DRAWN BY **JENSEN**


GGN PROJECT # 7/01/2021 1608

FOOD PAVILION -**INTERIOR ELEVATIONS**

A260.1

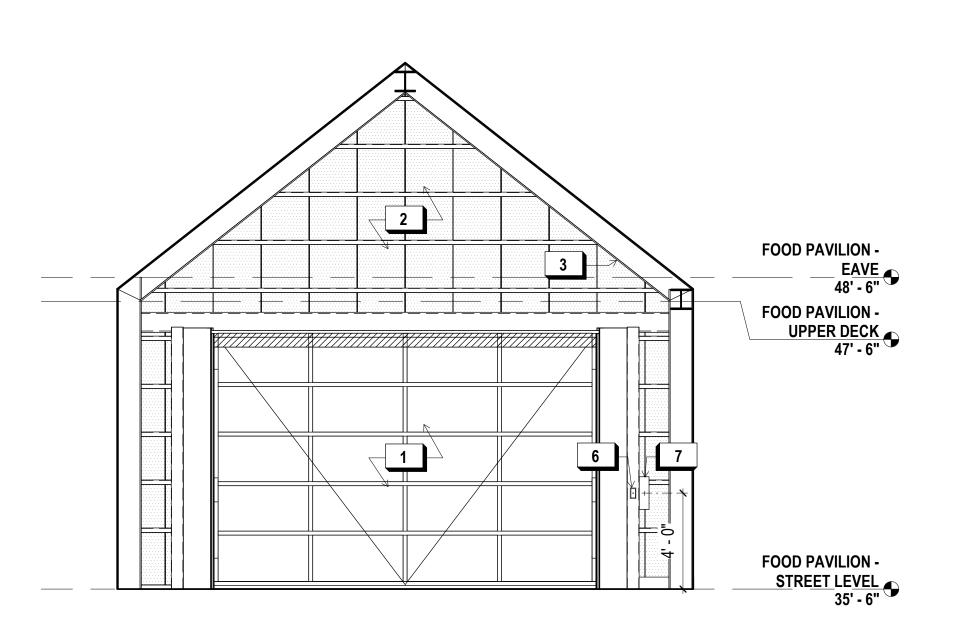


WEST OVERHEAD DOOR ELEVATION 1/4" = 1'-0"

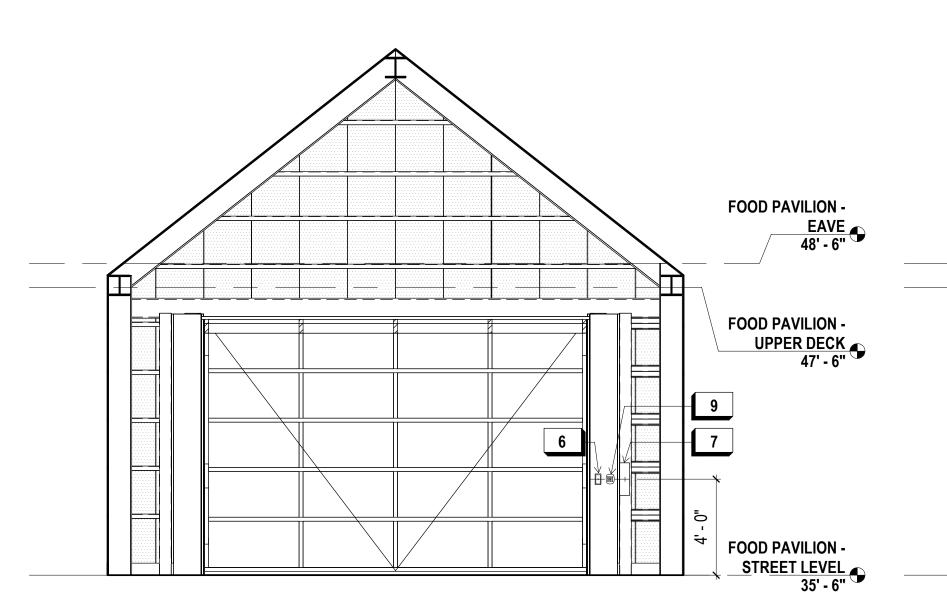


EAST OVERHEAD DOOR ELEVATION

1/4" = 1'-0"

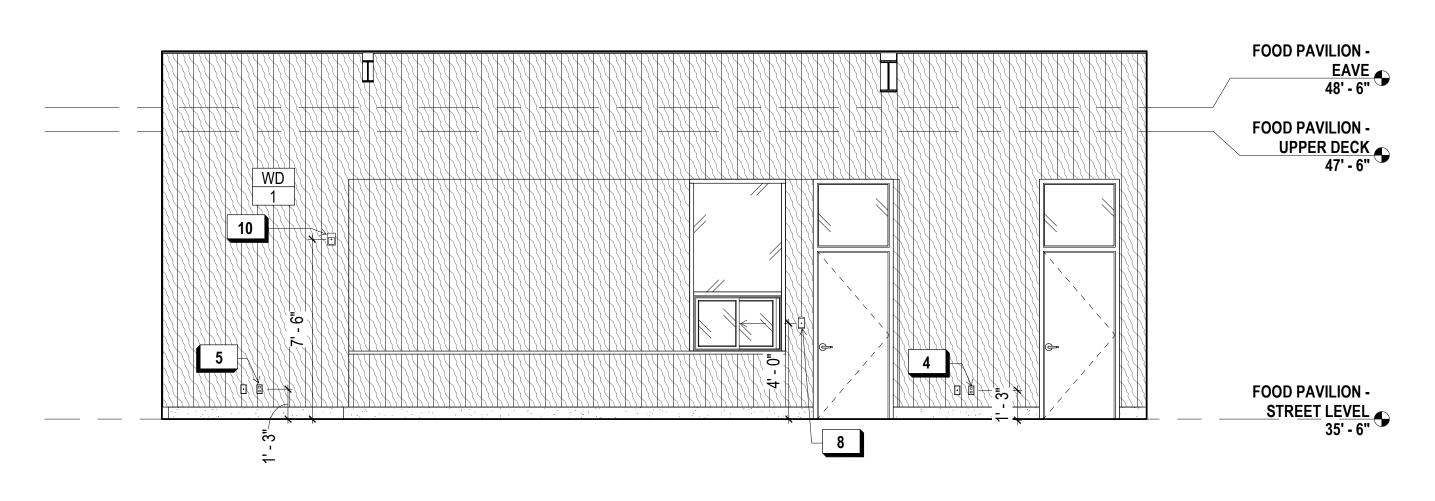

FP STREET LEVEL SOUTH INTERIOR ELEVATION

1/4" = 1'-0"

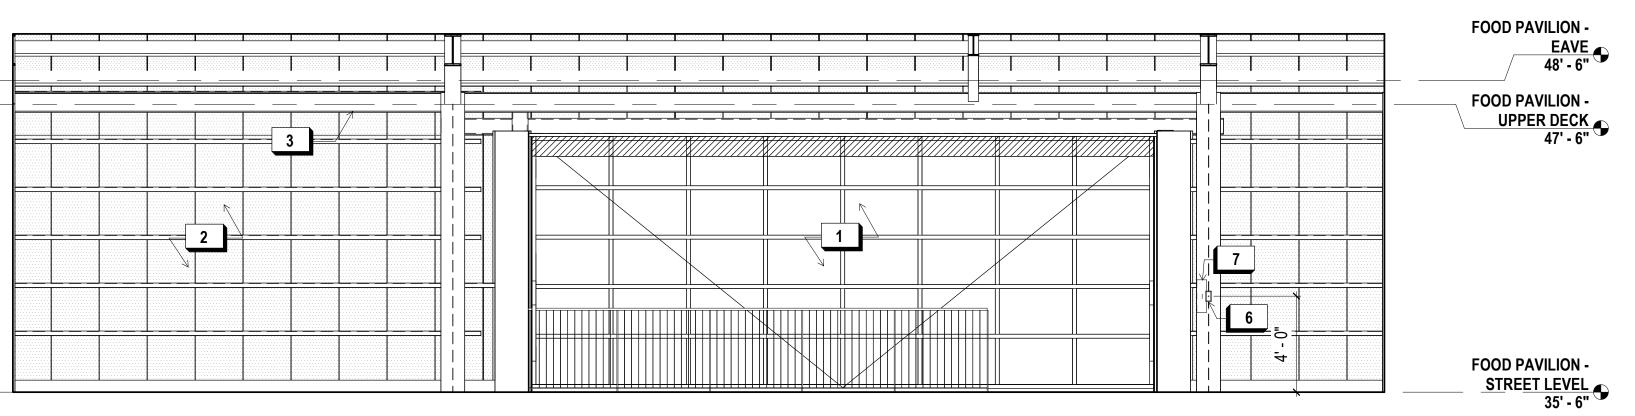

NORTH OVERHEAD DOOR ELEVATION

NORTH

SEE LIGHTING DESIGNER DRAWINGS AND ELECTRICAL DRAWINGS FOR LIGHTING 900 INNES PARK DEVELOPMENT

CITY AND COUNTY OF SAN FRANCISCO RECREATION AND PARKS DEPARTMENT 30 VAN NESS AVENUE

SHEET NOTES:

X KEY NOTES:

WALL OUTLET

CARD READER

ALARM KEYPAD

DATA CONNECTION

2. SEE FINISH FLOOR PLANS OR PROPOSED

FLOOR PLANS FOR FINISH SCHEDULE
3. SEE FINISH FLOOR PLANS OR PROPOSED

FLOOR PLANS FOR FINISH SCHEDULE

OVERHEAD DOOR (CLOSED POSITION)

PERFORATED METAL CLADDING W/

STRUCTURAL FRAMING (BEYOND)
STEEL STRUCTURAL FRAMING, S.S.D.

OVERHEAD DOOR CONTROLLER

10 MOTION DETECTOR, WALL MTD.

OVERHEAD DOOR POWER BOX, S.E.D.

LAYOUT



SAN FRANCISCO, CA 94102 PH. 415-831-2700 THE TRUST FOR PUBLIC LAND 101 MONTGOMERY STREET SUITE 900

PH. 415-495-4014

SAN FRANCISCO, CA 94104



PRIME CONSULTANT / LANDSCAPE ARCHITECT GUSTAFSON GUTHRIE NICHOL PH. 206-903-6802

CIVIL ENGINEER
SHERWOOD DESIGN ENGINEERS
PH. 415-348-9650
ARCHITECT
JENSEN ARCHITECTS

PH. 415-348-9650 ECOLOGICAL RESTORATION RANA CREEK PH. 831-659-3820

STRUCTURAL ENGINEER
JON BRODY STRUCTURAL ENGINEERS
PH. 415-296-9494
COASTAL ENGINEER
MOFFATT AND NICHOL
PH. 925-944-5411

LIGHTING NITEO CALIFORNIA PH. 415-666-2232 MEP & IT INTERFACE ENGINEERING

PH. 415-489-7240 GEOTECHNICAL ENGINEER AGS, INC PH. 415-957-9240

AGS, INC
PH. 415-957-9240
SECURITY CONSULTANT
ZBETA CONSULTING
PH. 415-259-0422

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KEY PLAN



RE	VISIONS:	
NO.	DATE	DESCRIPTION

ISSUANCE

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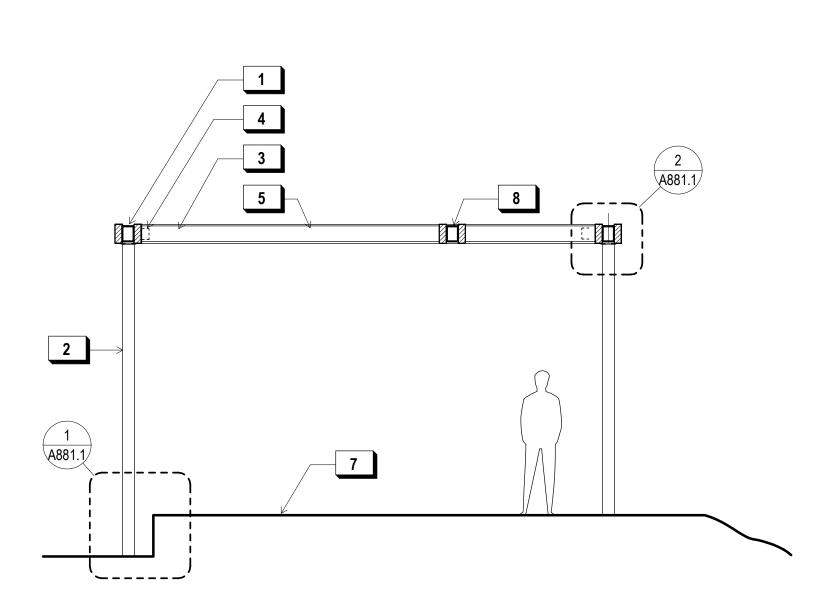
JENSEN

DATE


FOOD PAVILION INTERIOR ELEVATIONS

A261.1


GGN PROJECT #



3 <u>1/4" = 1'-0"</u>

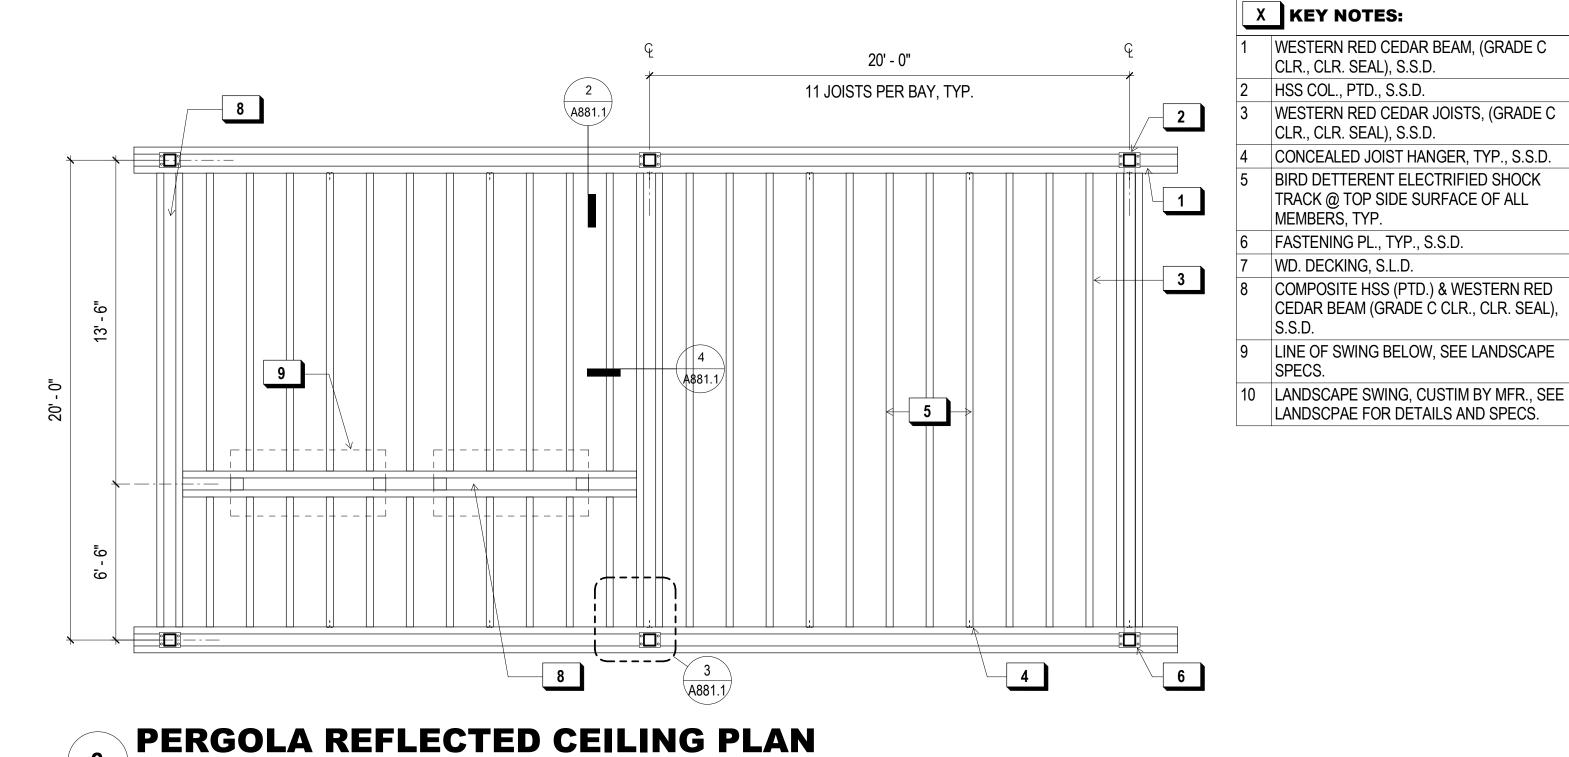

PERGOLA EAST ELEVATION 1/4" = 1'-0"

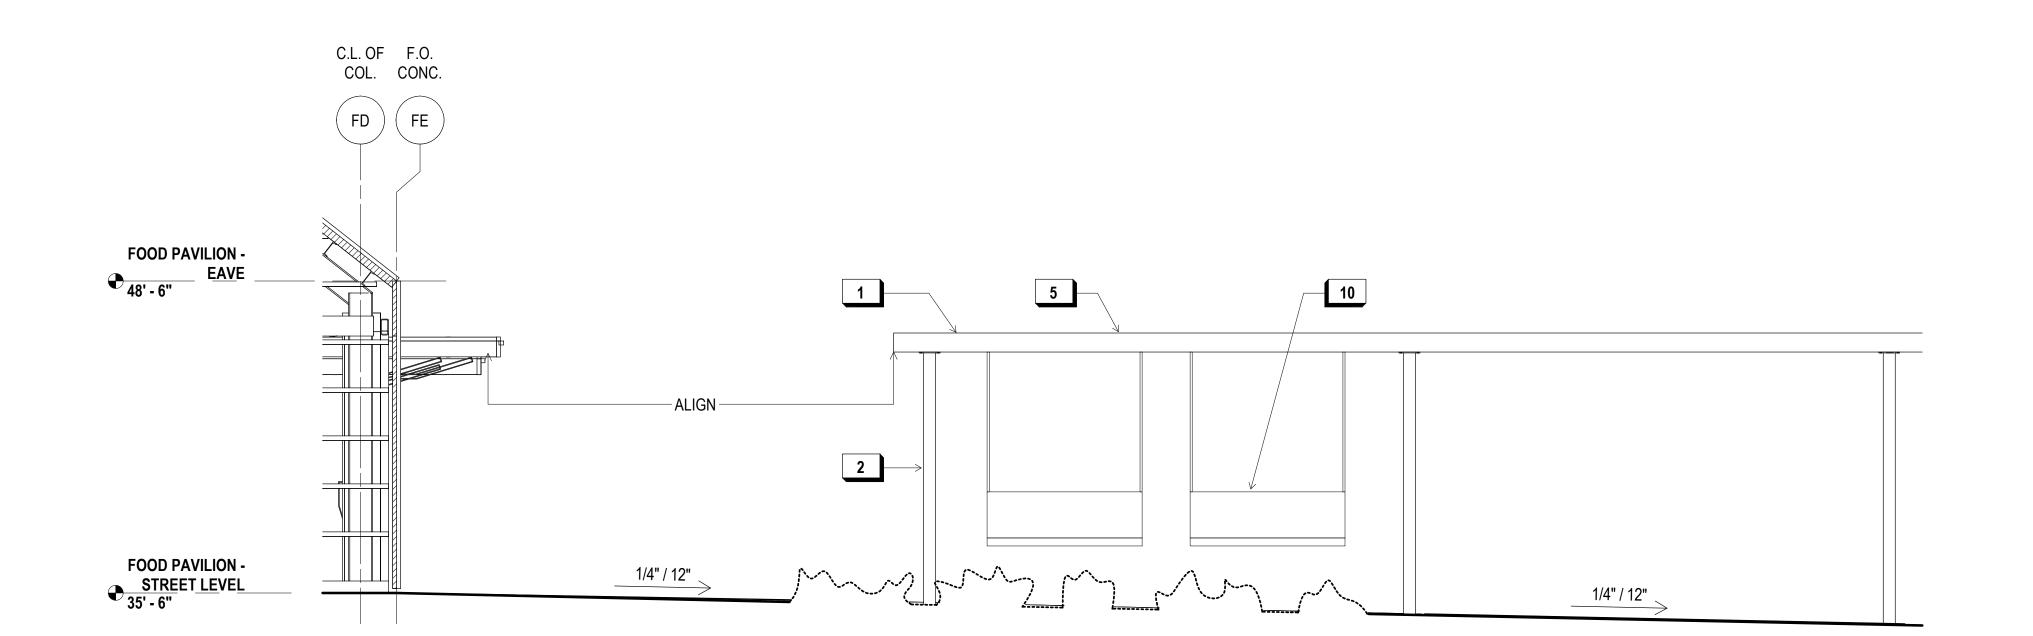

PERGOLA SOUTH ELEVATION 1 1/4" = 1'-0"

SHEET NOTES: 900 INNES 1. S.L.D. FOR FLR. FIN. AND LANDSCAPE PARK DEVELOPMENT **DETAILS**

2. S.S.D. FOR STRCUT. DETAILS

CLR., CLR. SEAL), S.S.D.

CLR., CLR. SEAL), S.S.D.

MEMBERS, TYP.

SPECS.

WD. DECKING, S.L.D.

SPECIFICATIONS

3. ALL EXTERIOR STEEL IS TO BE GALVANIZED AND PAINTED, PER

WESTERN RED CEDAR BEAM, (GRADE C

WESTERN RED CEDAR JOISTS, (GRADE C

CONCEALED JOIST HANGER, TYP., S.S.D.

BIRD DETTERENT ELECTRIFIED SHOCK

COMPOSITE HSS (PTD.) & WESTERN RED

LANDSCPAE FOR DETAILS AND SPECS.

CEDAR BEAM (GRADE C CLR., CLR. SEAL),

TRACK @ TOP SIDE SURFACE OF ALL

CITY AND COUNTY OF SAN FRANCISCO RECREATION AND PARKS DEPARTMENT 30 VAN NESS AVENUE SAN FRANCISCO, CA 94102

PH. 415-831-2700 THE TRUST FOR PUBLIC LAND 101 MONTGOMERY STREET SUITE 900 SAN FRANCISCO, CA 94104

PH. 415-495-4014



PRIME CONSULTANT / LANDSCAPE ARCHITECT GUSTAFSON GUTHRIE NICHOL PH. 206-903-6802

CIVIL ENGINEER SHERWOOD DESIGN ENGINEERS PH. 415-348-9650

ARCHITECT JENSEN ARCHITECTS PH. 415-348-9650 ECOLOGICAL RESTORATION

RANA CREEK PH. 831-659-3820 STRUCTURAL ENGINEER JON BRODY STRUCTURAL ENGINEERS PH. 415-296-9494


COASTAL ENGINEER MOFFATT AND NICHOL PH. 925-944-5411 LIGHTING

NITEO CALIFORNIA PH. 415-666-2232 MEP & IT INTERFACE ENGINEERING PH. 415-489-7240 GEOTECHNICAL ENGINEER

AGS, INC PH. 415-957-9240 SECURITY CONSULTANT ZBETA CONSULTING PH. 415-259-0422

FOR OFFICIAL USE

KEY PLAN 2/

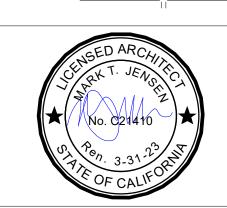

REVISIONS:		
NO. DATE		DESCRIPTION
01	12/18/2020	PERMIT SUBMITTAL

BID SET

ISSUANCE

DRAWN BY **JENSEN**

CHECKED BY GGN PROJECT # 7/01/2021

> **INNES PERGOLA DRAWINGS**

A270.1

PLUMBING FIXTURE / ACCESSORIES LEGEND				
TAG	MANUFACTURER	MODEL	DESCRIPTION	
LAV-1	AMERICAN STANDARD	DECORUM 9134001EC	WALL HUNG SINK	
LAV-2	AMERICAN STANDARD	WHEELCHAIR USERS 9141	WALL HUNG SINK	
LAV-3	AMERICAN STANDARD	OVALYN 0495	UNDERCOUNTER SINK	
WC-1	AMERICAN STANDARD	AFWALL MILLENNIUM FLOWISE ELONGATED FLUSHOMETER	WALL HUNG TOILET	
WC-2	AMERICAN STANDARD	MADERA FLOWISE FLUSHOMETER	FLOOR MOUNTED TOILET	
SP-1	GEORGIA PACIFIC	GP MANUAL 53053	MANUAL SOAP DISPENSER	
TA-1	XLERATOR	XL - BW - VOLTAGE	RECESSED HAND DRYER	
TA-2	THINAIR	TA-SB	WALL MOUNTED HAND DRYER	
SK-1	AMERICAN STANDARD	LAKEWELL SERVICE SINK - 7692	SERVICE MOP LINK	
SF-1	CHICAGO FAUCETS	807-E12-665PAB	SINGLE-INLET METERING FAUCET	
SF-2	CHICAGO FAUCETS	1100-GNAE35-369AB	MANUAL SINK FAUCET	


CT-1	KOALA KARE	KB112-01RE	RECESSED MTD. CHANGING TABLE
CT-2	KOALA KARE	KB110-SSWM	WALL MTD. CHANGING TABLE
GB-1	BOBRICK	B-6806	STAINLESS STL. GRAB BARS
TP-1	BOBRICK	B-2840	TOILET PAPER HOLDER
TSC-1	BOBRICK	B-221	TOILET SEAT COVER DISPENSER
			·

CHEET	NOTES.
2HEE I	NOTES:

- SEE DETAIL 1/A032.1 FOR TYP. ACCESSIBLE DOOR THRESHOLD AND LEVER REQUIREMENTS
- 2. SEE DETAIL 1/A033.1 FOR TYP. ACCESSIBLE DOOR CLEARANCE
- REQUIREMENTS . SEE 3A AND 3B/A032.1 FOR TYP.
- RESTROOM DR. SIGNAGE DETAILS PROVIDE SHT. MTL. PL. O/ BLK. IN WALL BEHIND GRAB BARS & WALL-MTD. FIXT., TYP. @ RESTROOMS
- . SEE FINISH FLOOR PLANS OR PROPOSED FLOOR PLANS FOR FINISH SCHEDULE

X KEY NOTES:

- TRASH BIN
- WALL MOUNTED SOAP DISPENSER
- SURFACE-MTD. HAND DRYER
- 30"x48" ACCESSIBLE CLR. FLR. SPACE DOOR SIGNAGE

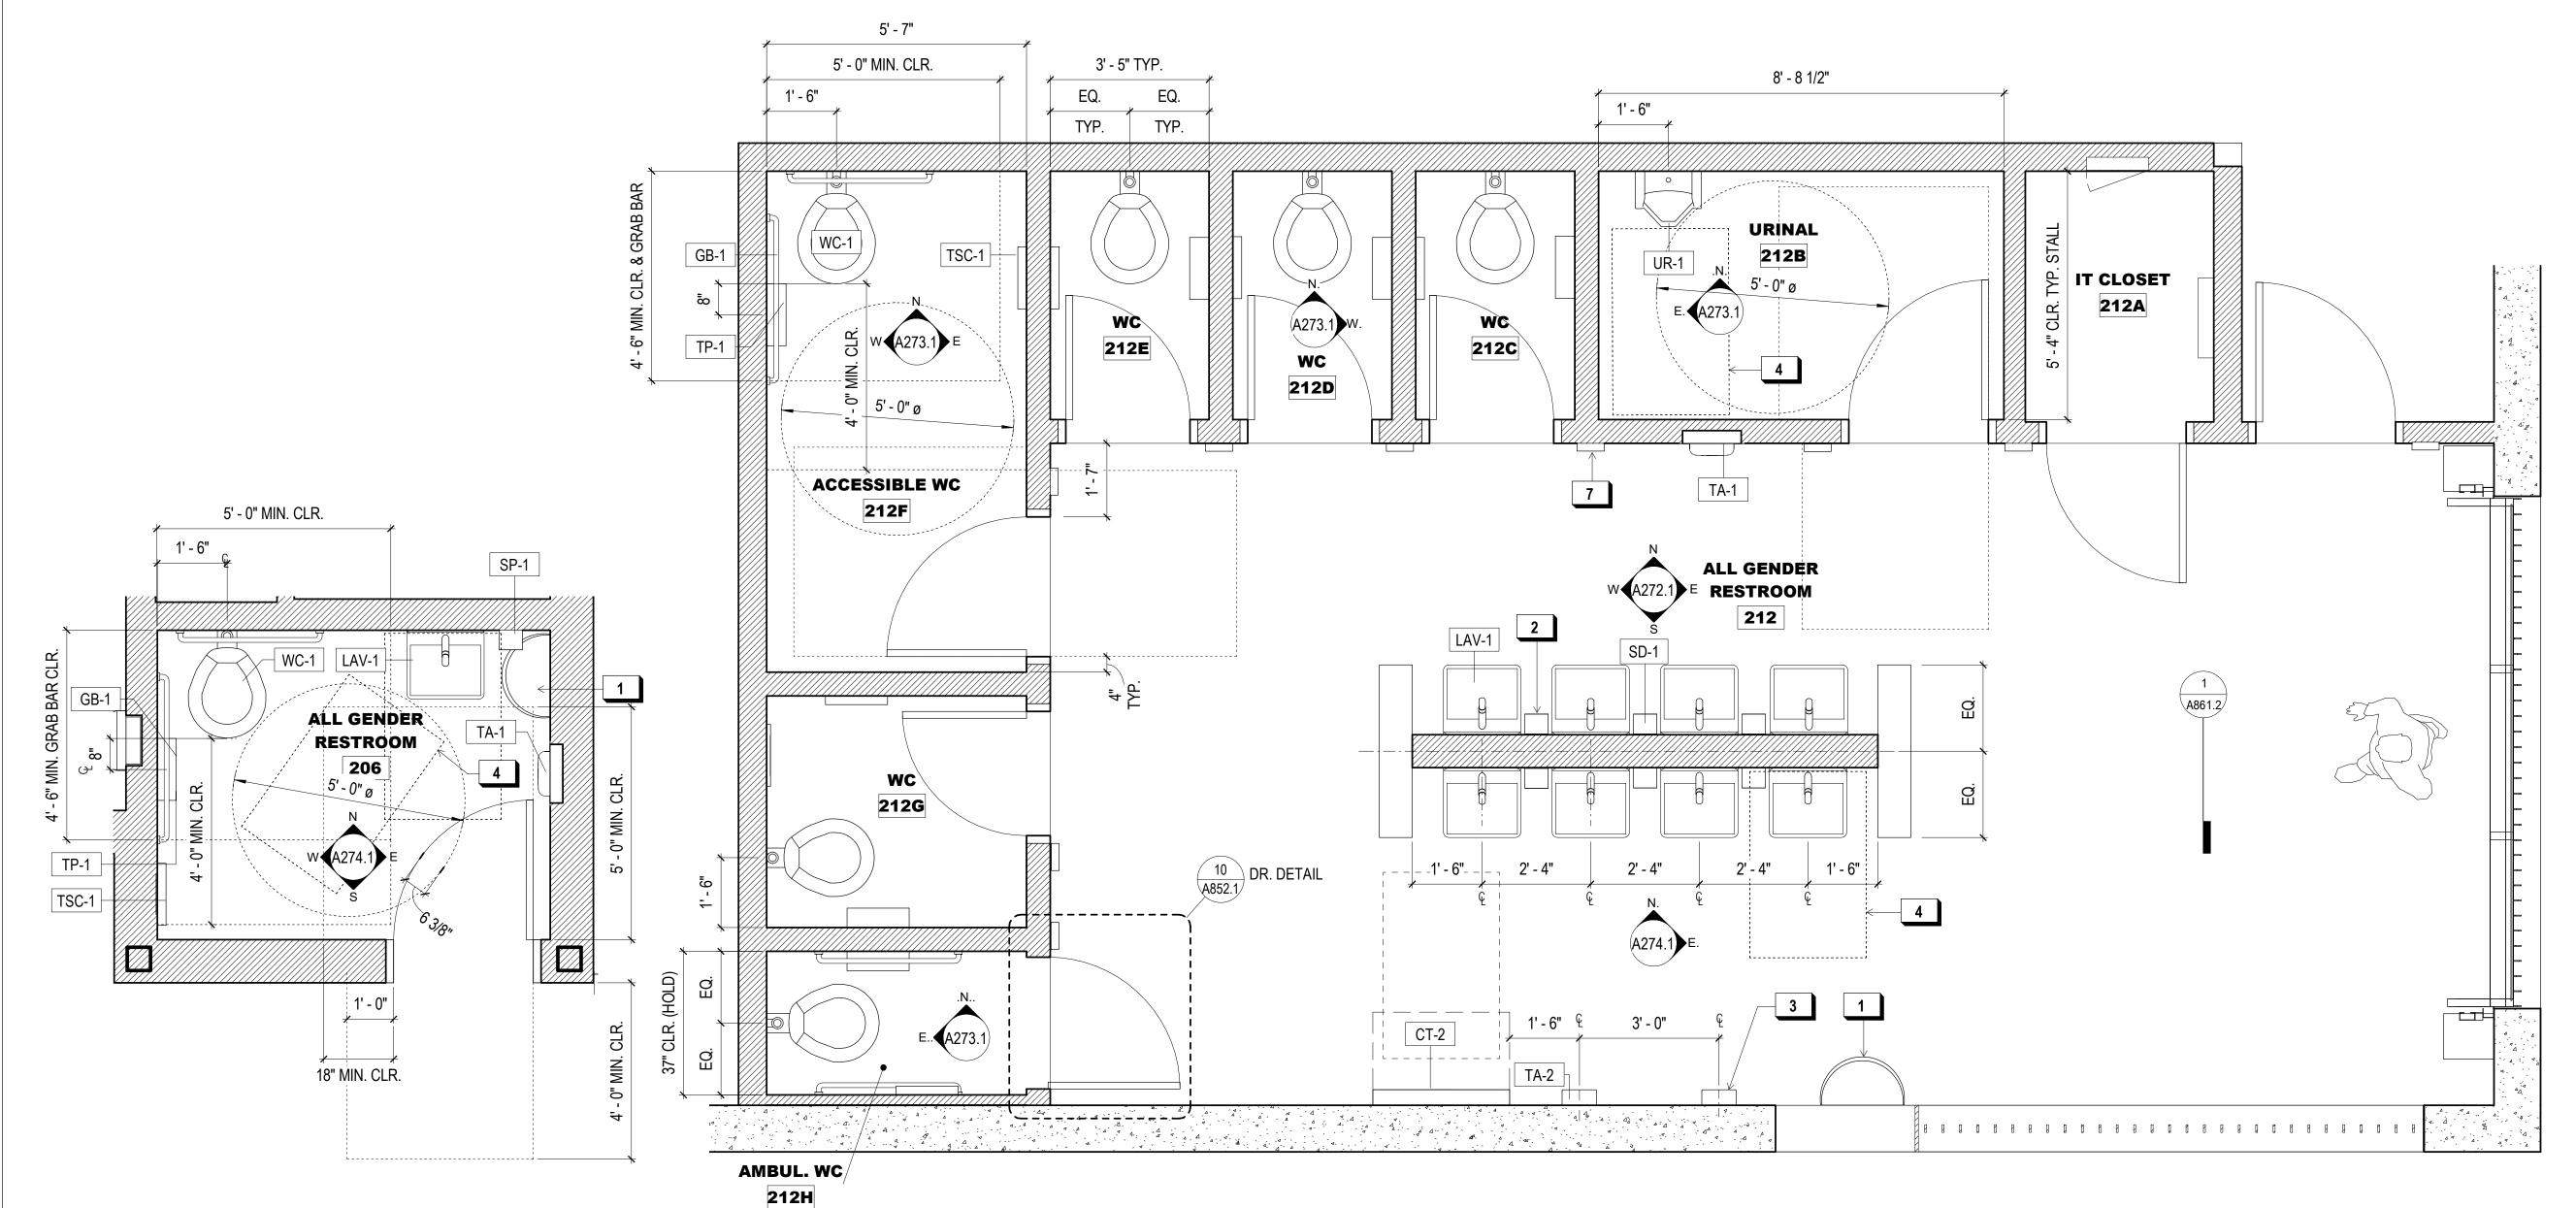

ALL GENDER RESTROOM 212 PLAN

900 INNES PARK DEVELOPMENT

CITY AND COUNTY OF SAN FRANCISCO RECREATION AND PARKS DEPARTMENT 30 VAN NESS AVENUE SAN FRANCISCO, CA 94102

PH. 415-831-2700

THE TRUST FOR PUBLIC LAND 101 MONTGOMERY STREET SUITE 900 SAN FRANCISCO, CA 94104 PH. 415-495-4014



PRIME CONSULTANT / LANDSCAPE ARCHITECT GUSTAFSON GUTHRIE NICHOL PH. 206-903-6802 CIVIL ENGINEER SHERWOOD DESIGN ENGINEERS PH. 415-348-9650 ARCHITECT

JENSEN ARCHITECTS PH. 415-348-9650 ECOLOGICAL RESTORATION RANA CREEK PH. 831-659-3820 STRUCTURAL ENGINEER


JON BRODY STRUCTURAL ENGINEERS PH. 415-296-9494 COASTAL ENGINEER MOFFATT AND NICHOL PH. 925-944-5411 LIGHTING


NITEO CALIFORNIA PH. 415-666-2232 MEP & IT INTERFACE ENGINEERING PH. 415-489-7240 GEOTECHNICAL ENGINEER

AGS, INC PH. 415-957-9240 SECURITY CONSULTANT ZBETA CONSULTING PH. 415-259-0422

FOR OFFICIAL USE

KEY PLAN

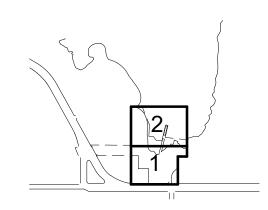

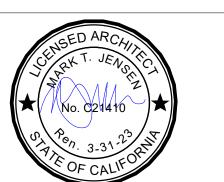

REVISIONS:

DESCRIPTION NO. DATE PERMIT SUBMITTAL 01 12/18/2020

ISSUANCE

BID SET

DRAWN BY **JENSEN**

GGN PROJECT # 7/01/2021


> **FOOD PAVILION -ENLARGED PLANS**


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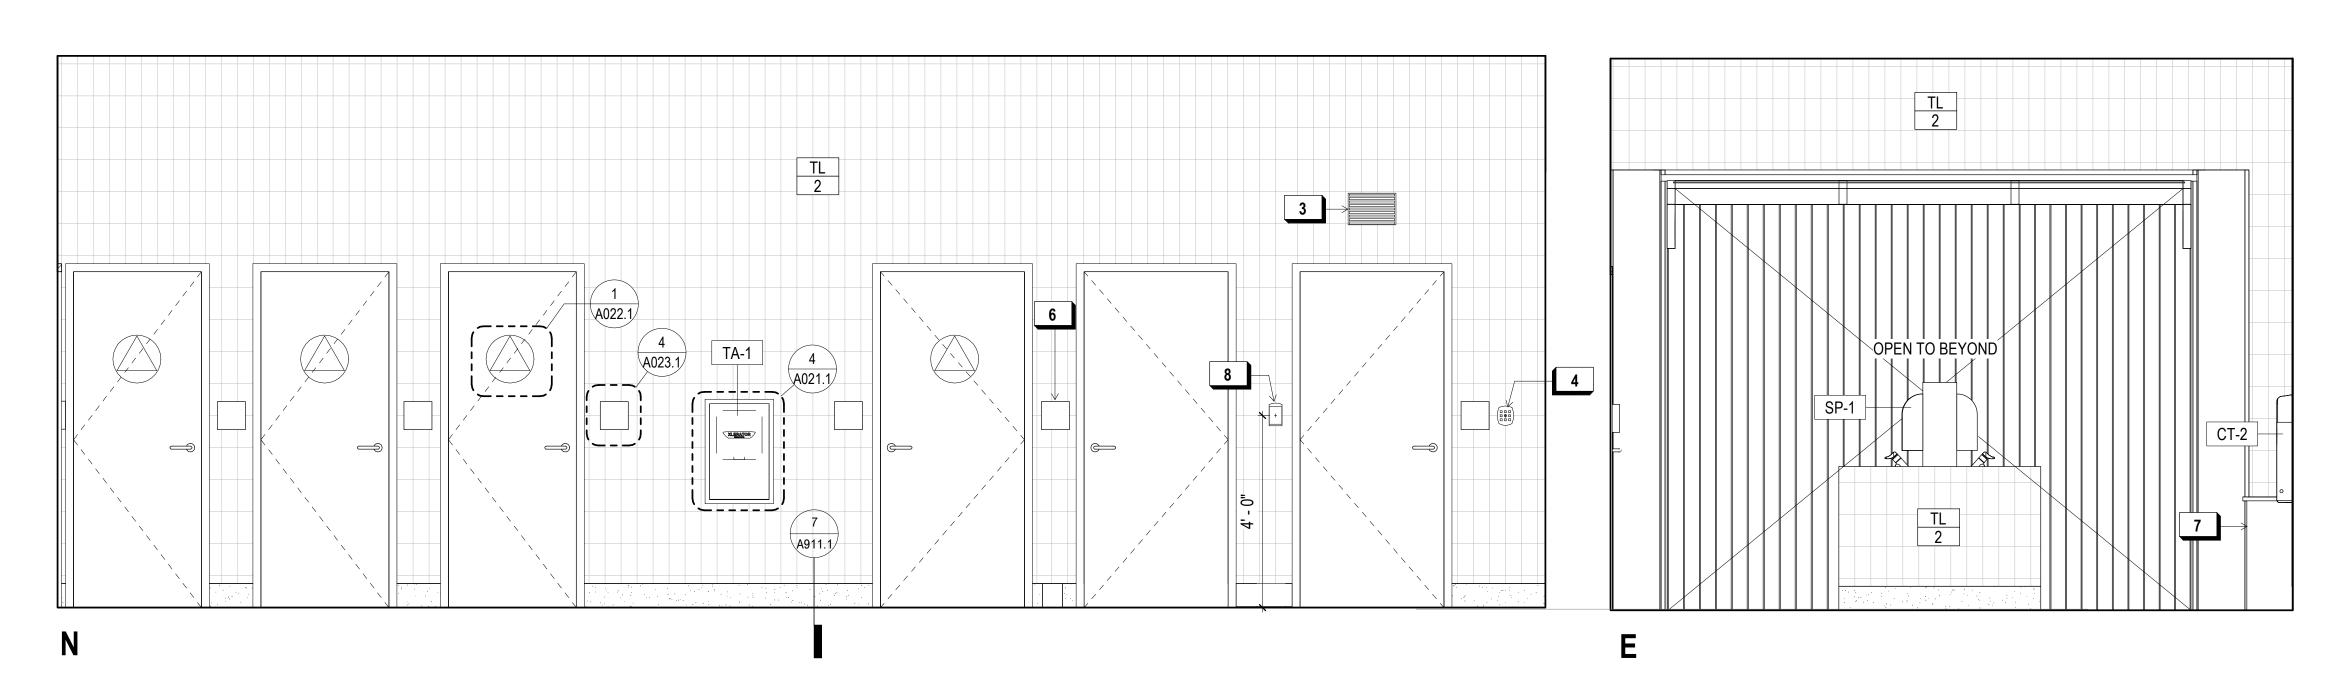
A271.1

	PLUMBING FIXTURE / ACCESSORIES LEGEND			
TAG	MANUFACTURER	MODEL	DESCRIPTION	
LAV-1	AMERICAN STANDARD	DECORUM 9134001EC	WALL HUNG SINK	
LAV-2	AMERICAN STANDARD	WHEELCHAIR USERS 9141	WALL HUNG SINK	
LAV-3	AMERICAN STANDARD	OVALYN 0495	UNDERCOUNTER SINK	
WC-1	AMERICAN STANDARD	AFWALL MILLENNIUM FLOWISE ELONGATED FLUSHOMETER	WALL HUNG TOILET	
WC-2	AMERICAN STANDARD	MADERA FLOWISE FLUSHOMETER	FLOOR MOUNTED TOILET	
SP-1	GEORGIA PACIFIC	GP MANUAL 53053	MANUAL SOAP DISPENSER	
TA-1	XLERATOR	XL - BW - VOLTAGE	RECESSED HAND DRYER	
TA-2	THINAIR	TA-SB	WALL MOUNTED HAND DRYER	
SK-1	AMERICAN STANDARD	LAKEWELL SERVICE SINK - 7692	SERVICE MOP LINK	
SF-1	CHICAGO FAUCETS	807-E12-665PAB	SINGLE-INLET METERING FAUCET	
SF-2	CHICAGO FAUCETS	1100-GNAE35-369AB	MANUAL SINK FAUCET	

CT-1	KOALA KARE	KB112-01RE	RECESSED MTD. CHANGING TABLE
CT-2	KOALA KARE	KB110-SSWM	WALL MTD. CHANGING TABLE
GB-1	BOBRICK	B-6806	STAINLESS STL. GRAB BARS
TP-1	BOBRICK	B-2840	TOILET PAPER HOLDER
TSC-1	BOBRICK	B-221	TOILET SEAT COVER DISPENSER
			<u> </u>



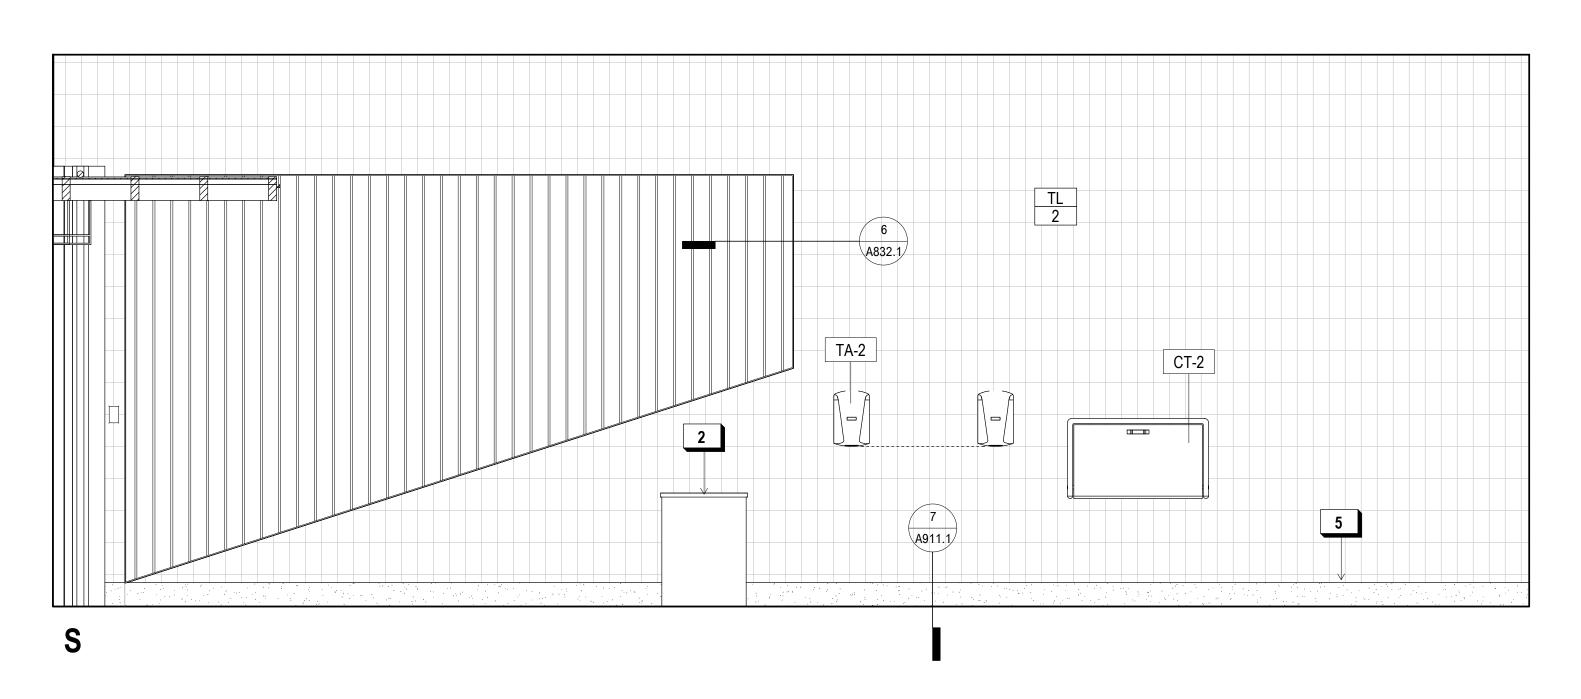

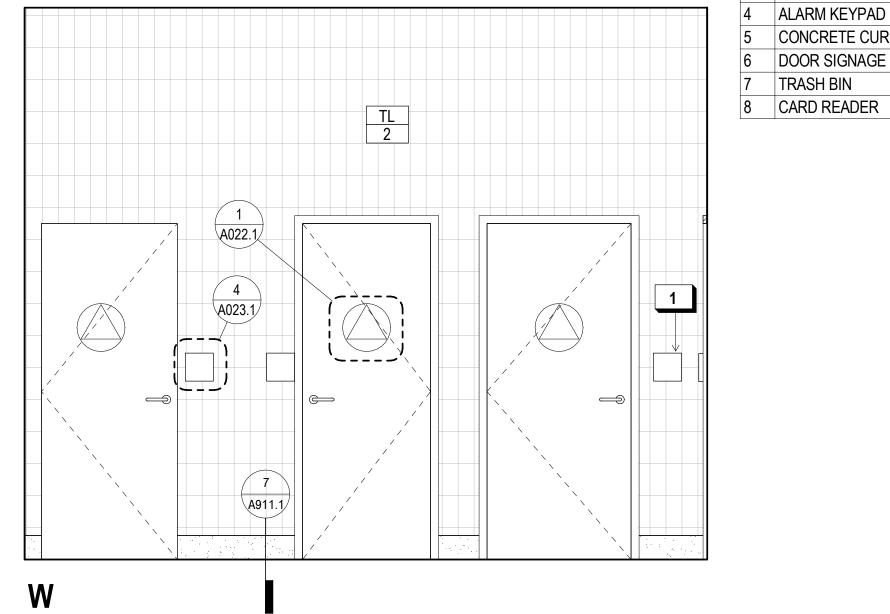

1 ALL GENDER RESTROOM 431 PLAN 1/2" = 1'-0"

SHEET NOTES:

- SEE DETAIL 1/A032.1 FOR TYP.
 ACCESSIBLE DOOR THRESHOLD AND LEVER REQUIREMENTS
- 2. SEE DETAIL 1/A033.1 FOR TYP.
 ACCESSIBLE DOOR CLEARANCE
- REQUIREMENTS
 . SEE 3A AND 3B/A032.1 FOR TYP.
 RESTROOM DR. SIGNAGE DETAILS
- 4. PROVIDE SHT. MTL. PL. O/ BLK. IN WALL BEHIND GRAB BARS & WALL-MTD. FIXT., TYP. @ RESTROOMS
- 5. SEE FINISH FLOOR PLANS OR PROPOSED FLOOR PLANS FOR FINISH SCHEDULE

X KEY NOTES:

A RET NOTES:	
1	DOOR SIGNAGE
2	TRASH BIN
3	WALL OUTLET
4	ALARM KEYPAD
5	CONCRETE CURB, TYP.
6	DOOR SIGNAGE
7	TRASH BIN

900 INNES PARK DEVELOPMENT

CITY AND COUNTY OF SAN FRANCISCO RECREATION AND PARKS DEPARTMENT 30 VAN NESS AVENUE SAN FRANCISCO, CA 94102



PH. 415-831-2700


THE TRUST FOR PUBLIC LAND
101 MONTGOMERY STREET
SUITE 900
SAN FRANCISCO, CA 94104
PH. 415-495-4014

PRIME CONSULTANT / LANDSCAPE ARCHITECT GUSTAFSON GUTHRIE NICHOL PH. 206-903-6802 CIVIL ENGINEER SHERWOOD DESIGN ENGINEERS PH. 415-348-9650 ARCHITECT JENSEN ARCHITECTS PH. 415-348-9650 ECOLOGICAL RESTORATION RANA CREEK PH. 831-659-3820 STRUCTURAL ENGINEER JON BRODY STRUCTURAL ENGINEERS PH. 415-296-9494 COASTAL ENGINEER MOFFATT AND NICHOL PH. 925-944-5411 LIGHTING NITEO CALIFORNIA PH. 415-666-2232 MEP & IT INTERFACE ENGINEERING PH. 415-489-7240 GEOTECHNICAL ENGINEER AGS, INC PH. 415-957-9240

FOR OFFICIAL USE

SECURITY CONSULTANT ZBETA CONSULTING PH. 415-259-0422

KEY PLAN

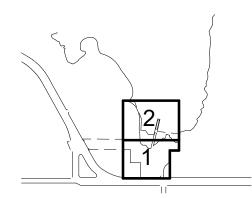



REVISIONS:	
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NO. DATE DESCRIPTION

12/18/2020 PERMIT SUBMITTAL

ISSUANCE

BID SET

DRAWN BY

JENSEN

DATE

7/01/2021 GGN PROJECT # 1608

FOOD PAVILION -ENLARGED EL.

CHECKED BY

A272.1

PLUMBING FIXTURE / ACCESSORIES LEGEND				
TAG	MANUFACTURER	MODEL	DESCRIPTION	
LAV-1	AMERICAN STANDARD	DECORUM 9134001EC	WALL HUNG SINK	
LAV-2	AMERICAN STANDARD	WHEELCHAIR USERS 9141	WALL HUNG SINK	
LAV-3	AMERICAN STANDARD	OVALYN 0495	UNDERCOUNTER SINK	
WC-1	AMERICAN STANDARD	AFWALL MILLENNIUM FLOWISE ELONGATED FLUSHOMETER	WALL HUNG TOILET	
WC-2	AMERICAN STANDARD	MADERA FLOWISE FLUSHOMETER	FLOOR MOUNTED TOILET	
SP-1	GEORGIA PACIFIC	GP MANUAL 53053	MANUAL SOAP DISPENSER	
TA-1	XLERATOR	XL - BW - VOLTAGE	RECESSED HAND DRYER	
TA-2	THINAIR	TA-SB	WALL MOUNTED HAND DRYER	
SK-1	AMERICAN STANDARD	LAKEWELL SERVICE SINK - 7692	SERVICE MOP LINK	
SF-1	CHICAGO FAUCETS	807-E12-665PAB	SINGLE-INLET METERING FAUCET	
SF-2	CHICAGO FAUCETS	1100-GNAE35-369AB	MANUAL SINK FAUCET	

CT-1	KOALA KARE	KB112-01RE	RECESSED MTD. CHANGING TABLE
CT-2	KOALA KARE	KB110-SSWM	WALL MTD. CHANGING TABLE
GB-1	BOBRICK	B-6806	STAINLESS STL. GRAB BARS
TP-1	BOBRICK	B-2840	TOILET PAPER HOLDER
TSC-1	BOBRICK	B-221	TOILET SEAT COVER DISPENSER

SHEET	NOTES:

- 1. SEE DETAIL 1/A032.1 FOR TYP. ACCESSIBLE DOOR THRESHOLD AND LEVER REQUIREMENTS
- 2. SEE DETAIL 1/A033.1 FOR TYP. ACCESSIBLE DOOR CLEARANCE REQUIREMENTS
- 3. SEE 3A AND 3B/A032.1 FOR TYP. RESTROOM DR. SIGNAGE DETAILS . PROVIDE SHT. MTL. PL. O/ BLK. IN WALL BEHIND GRAB BARS & WALL-MTD. FIXT.,
- TYP. @ RESTROOMS . SEE FINISH FLOOR PLANS OR PROPOSED

FLOOR PLANS FOR FINISH SCHEDULE X KEY NOTES:

CONC. CURB FOR FRAMED WALL, TYP.



900 INNES

PARK DEVELOPMENT


CITY AND COUNTY OF SAN FRANCISCO


SUITE 900

PRIME CONSULTANT / LANDSCAPE ARCHITECT GUSTAFSON GUTHRIE NICHOL PH. 206-903-6802 CIVIL ENGINEER SHERWOOD DESIGN ENGINEERS PH. 415-348-9650 ARCHITECT JENSEN ARCHITECTS PH. 415-348-9650 ECOLOGICAL RESTORATION RANA CREEK PH. 831-659-3820 STRUCTURAL ENGINEER JON BRODY STRUCTURAL ENGINEERS PH. 415-296-9494 COASTAL ENGINEER MOFFATT AND NICHOL PH. 925-944-5411 LIGHTING NITEO CALIFORNIA PH. 415-666-2232 MEP & IT INTERFACE ENGINEERING PH. 415-489-7240 GEOTECHNICAL ENGINEER AGS, INC PH. 415-957-9240 SECURITY CONSULTANT

FOR OFFICIAL USE

ZBETA CONSULTING PH. 415-259-0422

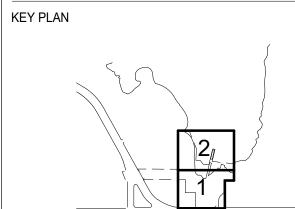

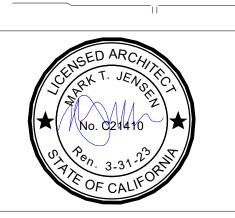

REVISIONS:			
NO.	DATE	DESCRIPTION	
01	12/18/2020	PERMIT SUBMITTAL	
	NO.	REVISIONS: NO. DATE 01 12/18/2020	


ISSUANCE


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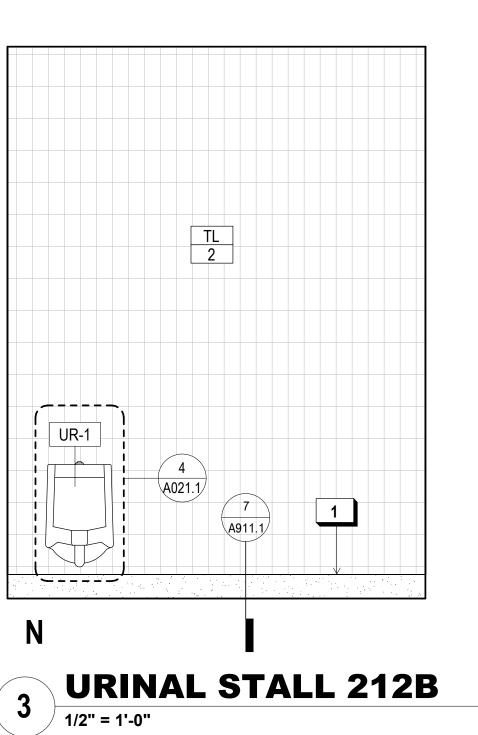
DRAWN BY **JENSEN** GGN PROJECT # 7/01/2021


FOOD PAVILION -ENLARGED EL.


A273.1




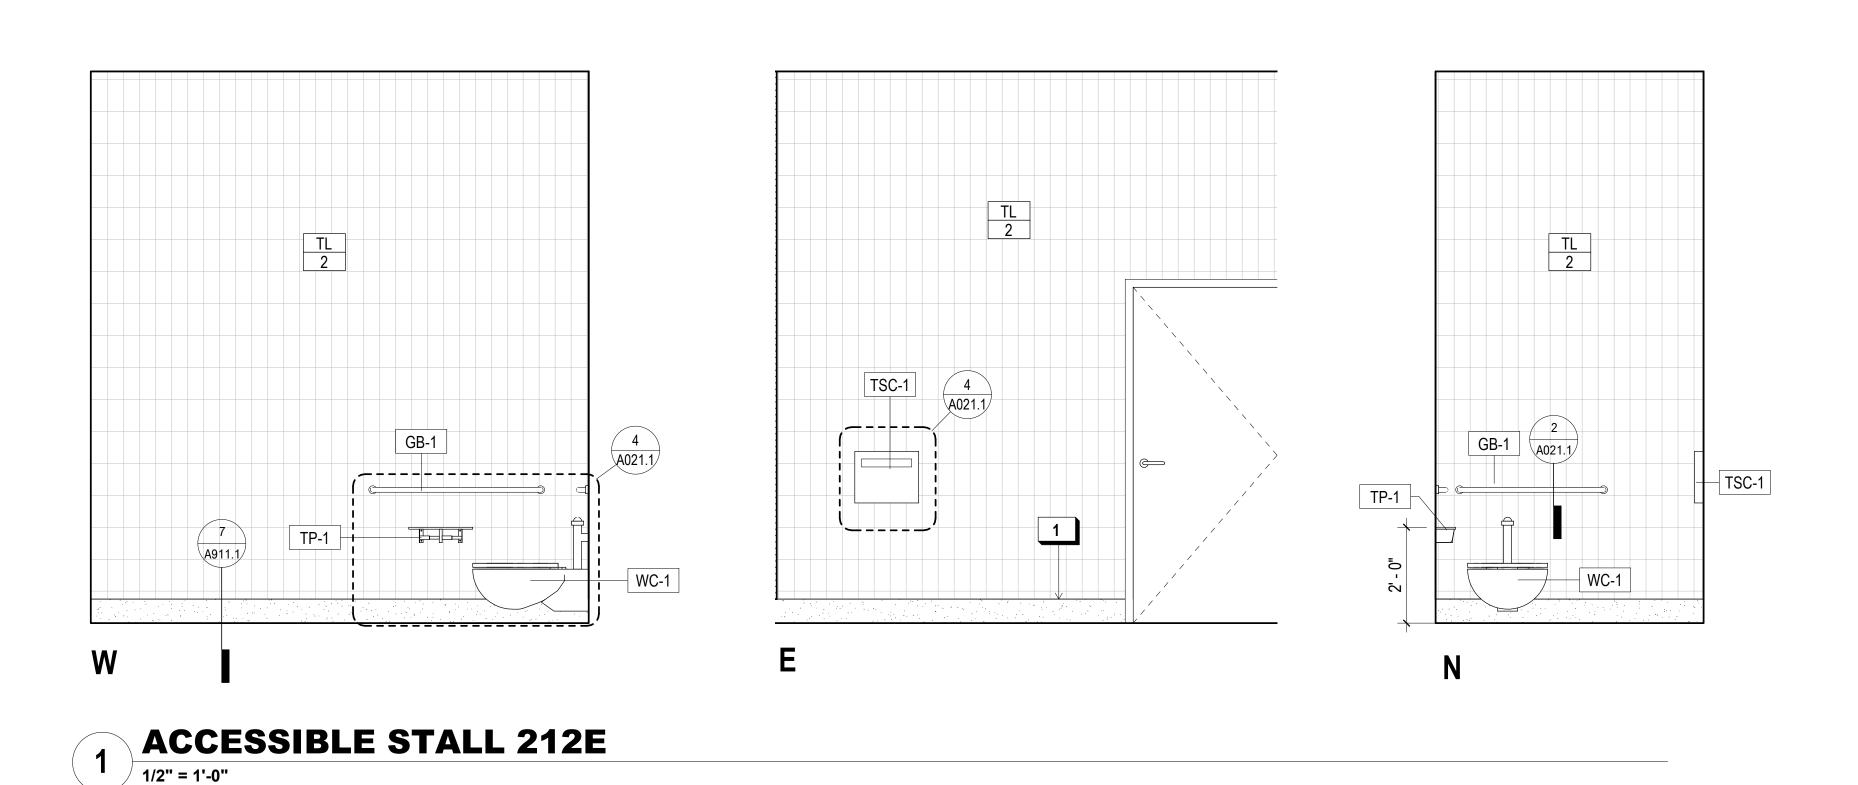

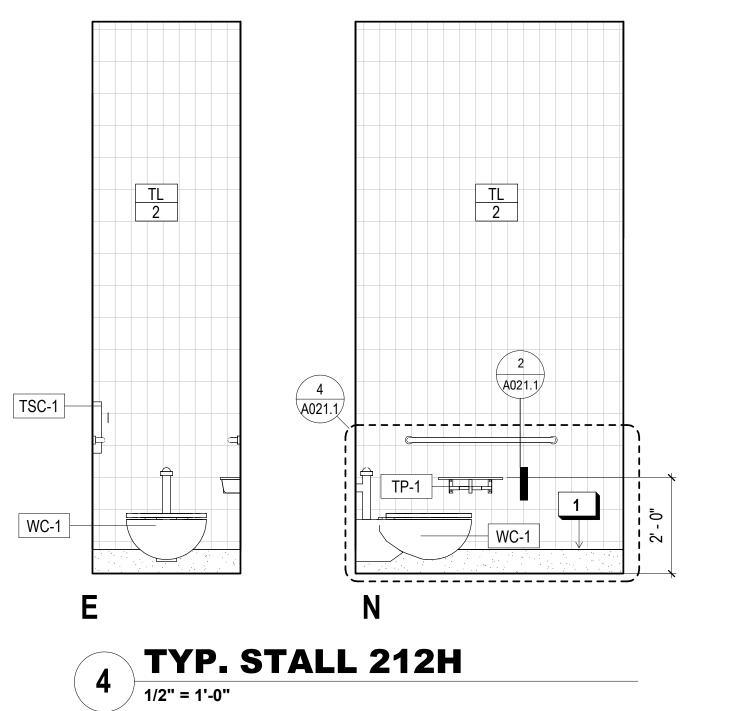

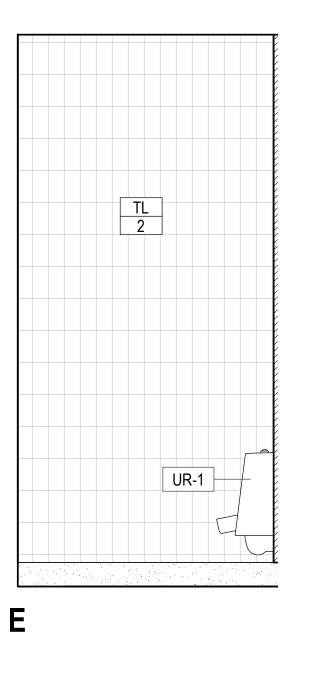

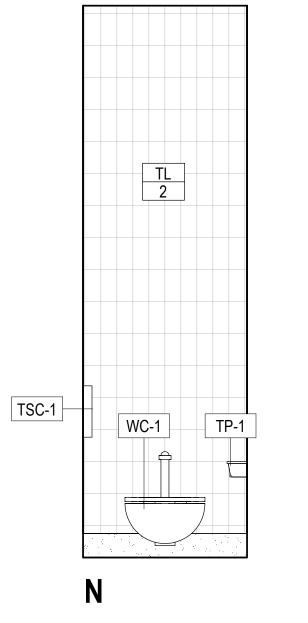

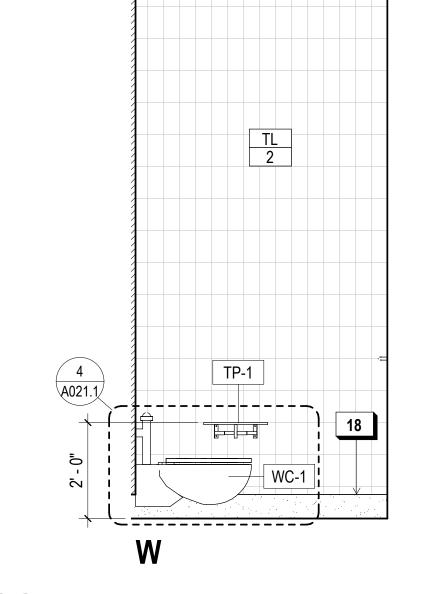


2 TYP. STALL 212C

PLUMBING FIXTURE / ACCESSORIES LEGEND					
TAG	MANUFACTURER	MODEL	DESCRIPTION		
LAV-1	AMERICAN STANDARD	DECORUM 9134001EC	WALL HUNG SINK		
LAV-2	AMERICAN STANDARD	WHEELCHAIR USERS 9141	WALL HUNG SINK		
LAV-3	AMERICAN STANDARD	OVALYN 0495	UNDERCOUNTER SINK		
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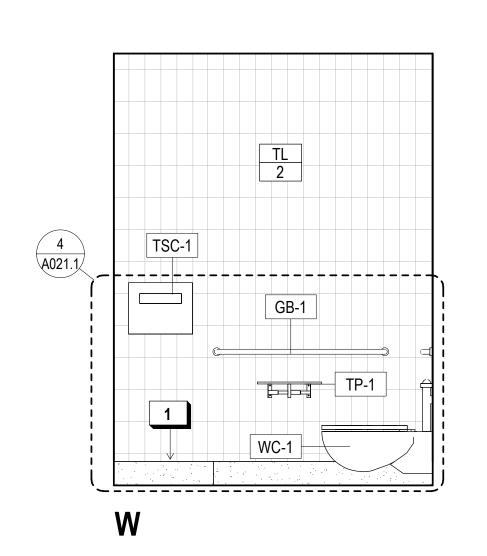
CT-1	KOALA KARE	KB112-01RE	RECESSED MTD. CHANGING TABLE
CT-2	KOALA KARE	KB110-SSWM	WALL MTD. CHANGING TABLE
GB-1	BOBRICK	B-6806	STAINLESS STL. GRAB BARS
TP-1	BOBRICK	B-2840	TOILET PAPER HOLDER
TSC-1	BOBRICK	B-221	TOILET SEAT COVER DISPENSER


LAV-1

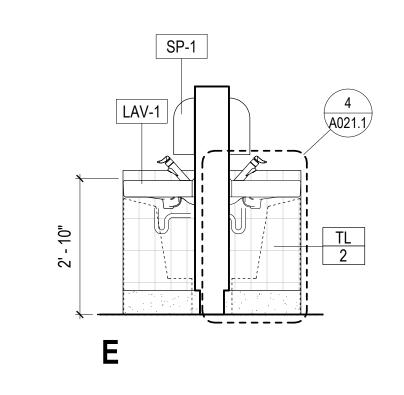



2 ISLAND SINK 212 ELEVATIONS 1/2" = 1'-0"

TP-1



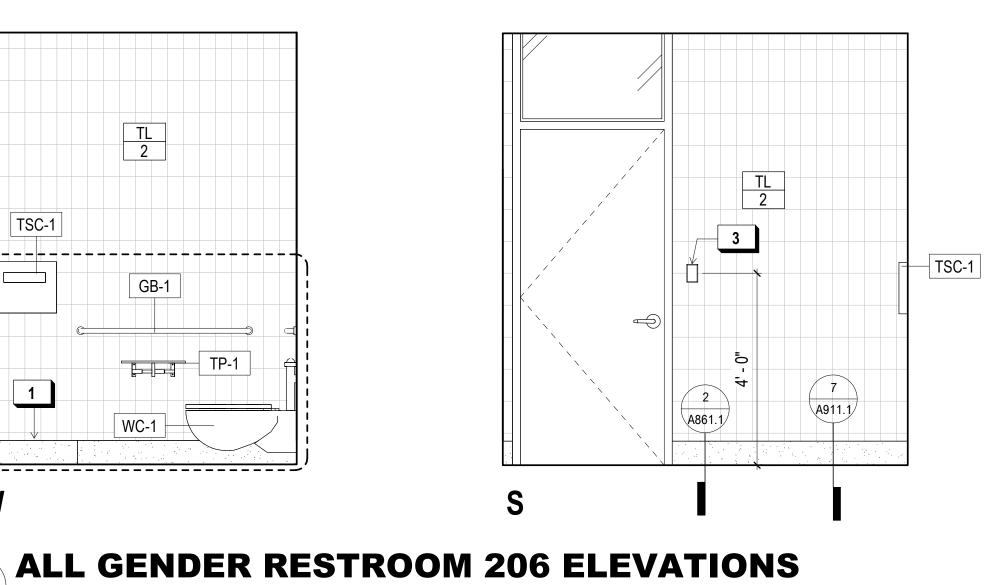

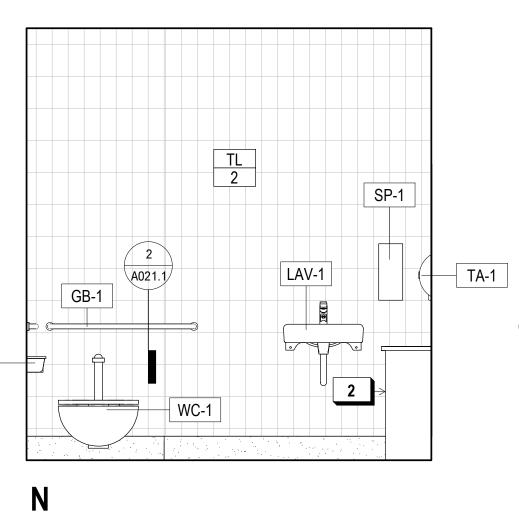

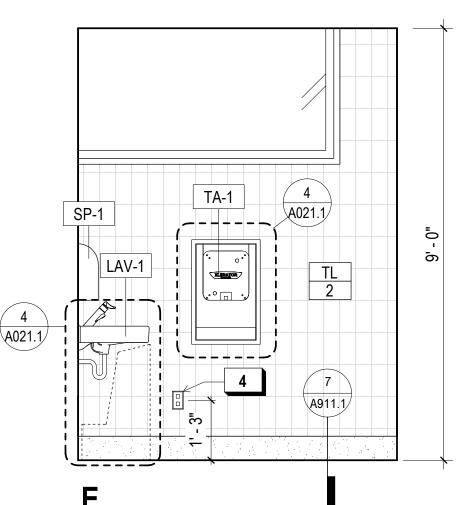

JENSEN 7/01/2021

REVISIONS:

NO. DATE

ISSUANCE

DRAWN BY

A274.1

CHECKED BY

GGN PROJECT #

FOOD PAVILION -

ENLARGED EL.

DESCRIPTION

01 12/18/2020 PERMIT SUBMITTAL

BID SET

TYP. @ RESTROOMS

FLOOR PLANS FOR FINISH SCHEDULE

CONC. CURB FOR FRAMED WALL, TYP.

OCCUPANCY SENSOR LIGHT SWITCH, S.E.D.

WALL OUTLET

SHEET NOTES:

. SEE DETAIL 1/A032.1 FOR TYP. ACCESSIBLE DOOR THRESHOLD AND LEVER REQUIREMENTS

2. SEE DETAIL 1/A033.1 FOR TYP. ACCESSIBLE DOOR CLEARANCE

REQUIREMENTS . SEE 3A AND 3B/A032.1 FOR TYP. RESTROOM DR. SIGNAGE DETAILS

. PROVIDE SHT. MTL. PL. O/ BLK. IN WALL BEHIND GRAB BARS & WALL-MTD. FIXT.,

. SEE FINISH FLOOR PLANS OR PROPOSED

X KEY NOTES:

TRASH BIN

900 INNES PARK DEVELOPMENT

PRIME CONSULTANT / LANDSCAPE ARCHITECT

CITY AND COUNTY OF SAN FRANCISCO RECREATION AND PARKS DEPARTMENT

30 VAN NESS AVENUE

PH. 415-831-2700

PH. 415-495-4014

PH. 206-903-6802

CIVIL ENGINEER

PH. 415-348-9650

JENSEN ARCHITECTS PH. 415-348-9650

ECOLOGICAL RESTORATION

STRUCTURAL ENGINEER

ARCHITECT

RANA CREEK PH. 831-659-3820

PH. 415-296-9494 COASTAL ENGINEER MOFFATT AND NICHOL PH. 925-944-5411

NITEO CALIFORNIA PH. 415-666-2232

PH. 415-489-7240

PH. 415-957-9240

FOR OFFICIAL USE

KEY PLAN

INTERFACE ENGINEERING

GEOTECHNICAL ENGINEER

SECURITY CONSULTANT ZBETA CONSULTING PH. 415-259-0422

LIGHTING

MEP & IT

AGS, INC

SUITE 900

SAN FRANCISCO, CA 94102

THE TRUST FOR PUBLIC LAND


101 MONTGOMERY STREET

SAN FRANCISCO, CA 94104

GUSTAFSON GUTHRIE NICHOL

SHERWOOD DESIGN ENGINEERS

JON BRODY STRUCTURAL ENGINEERS

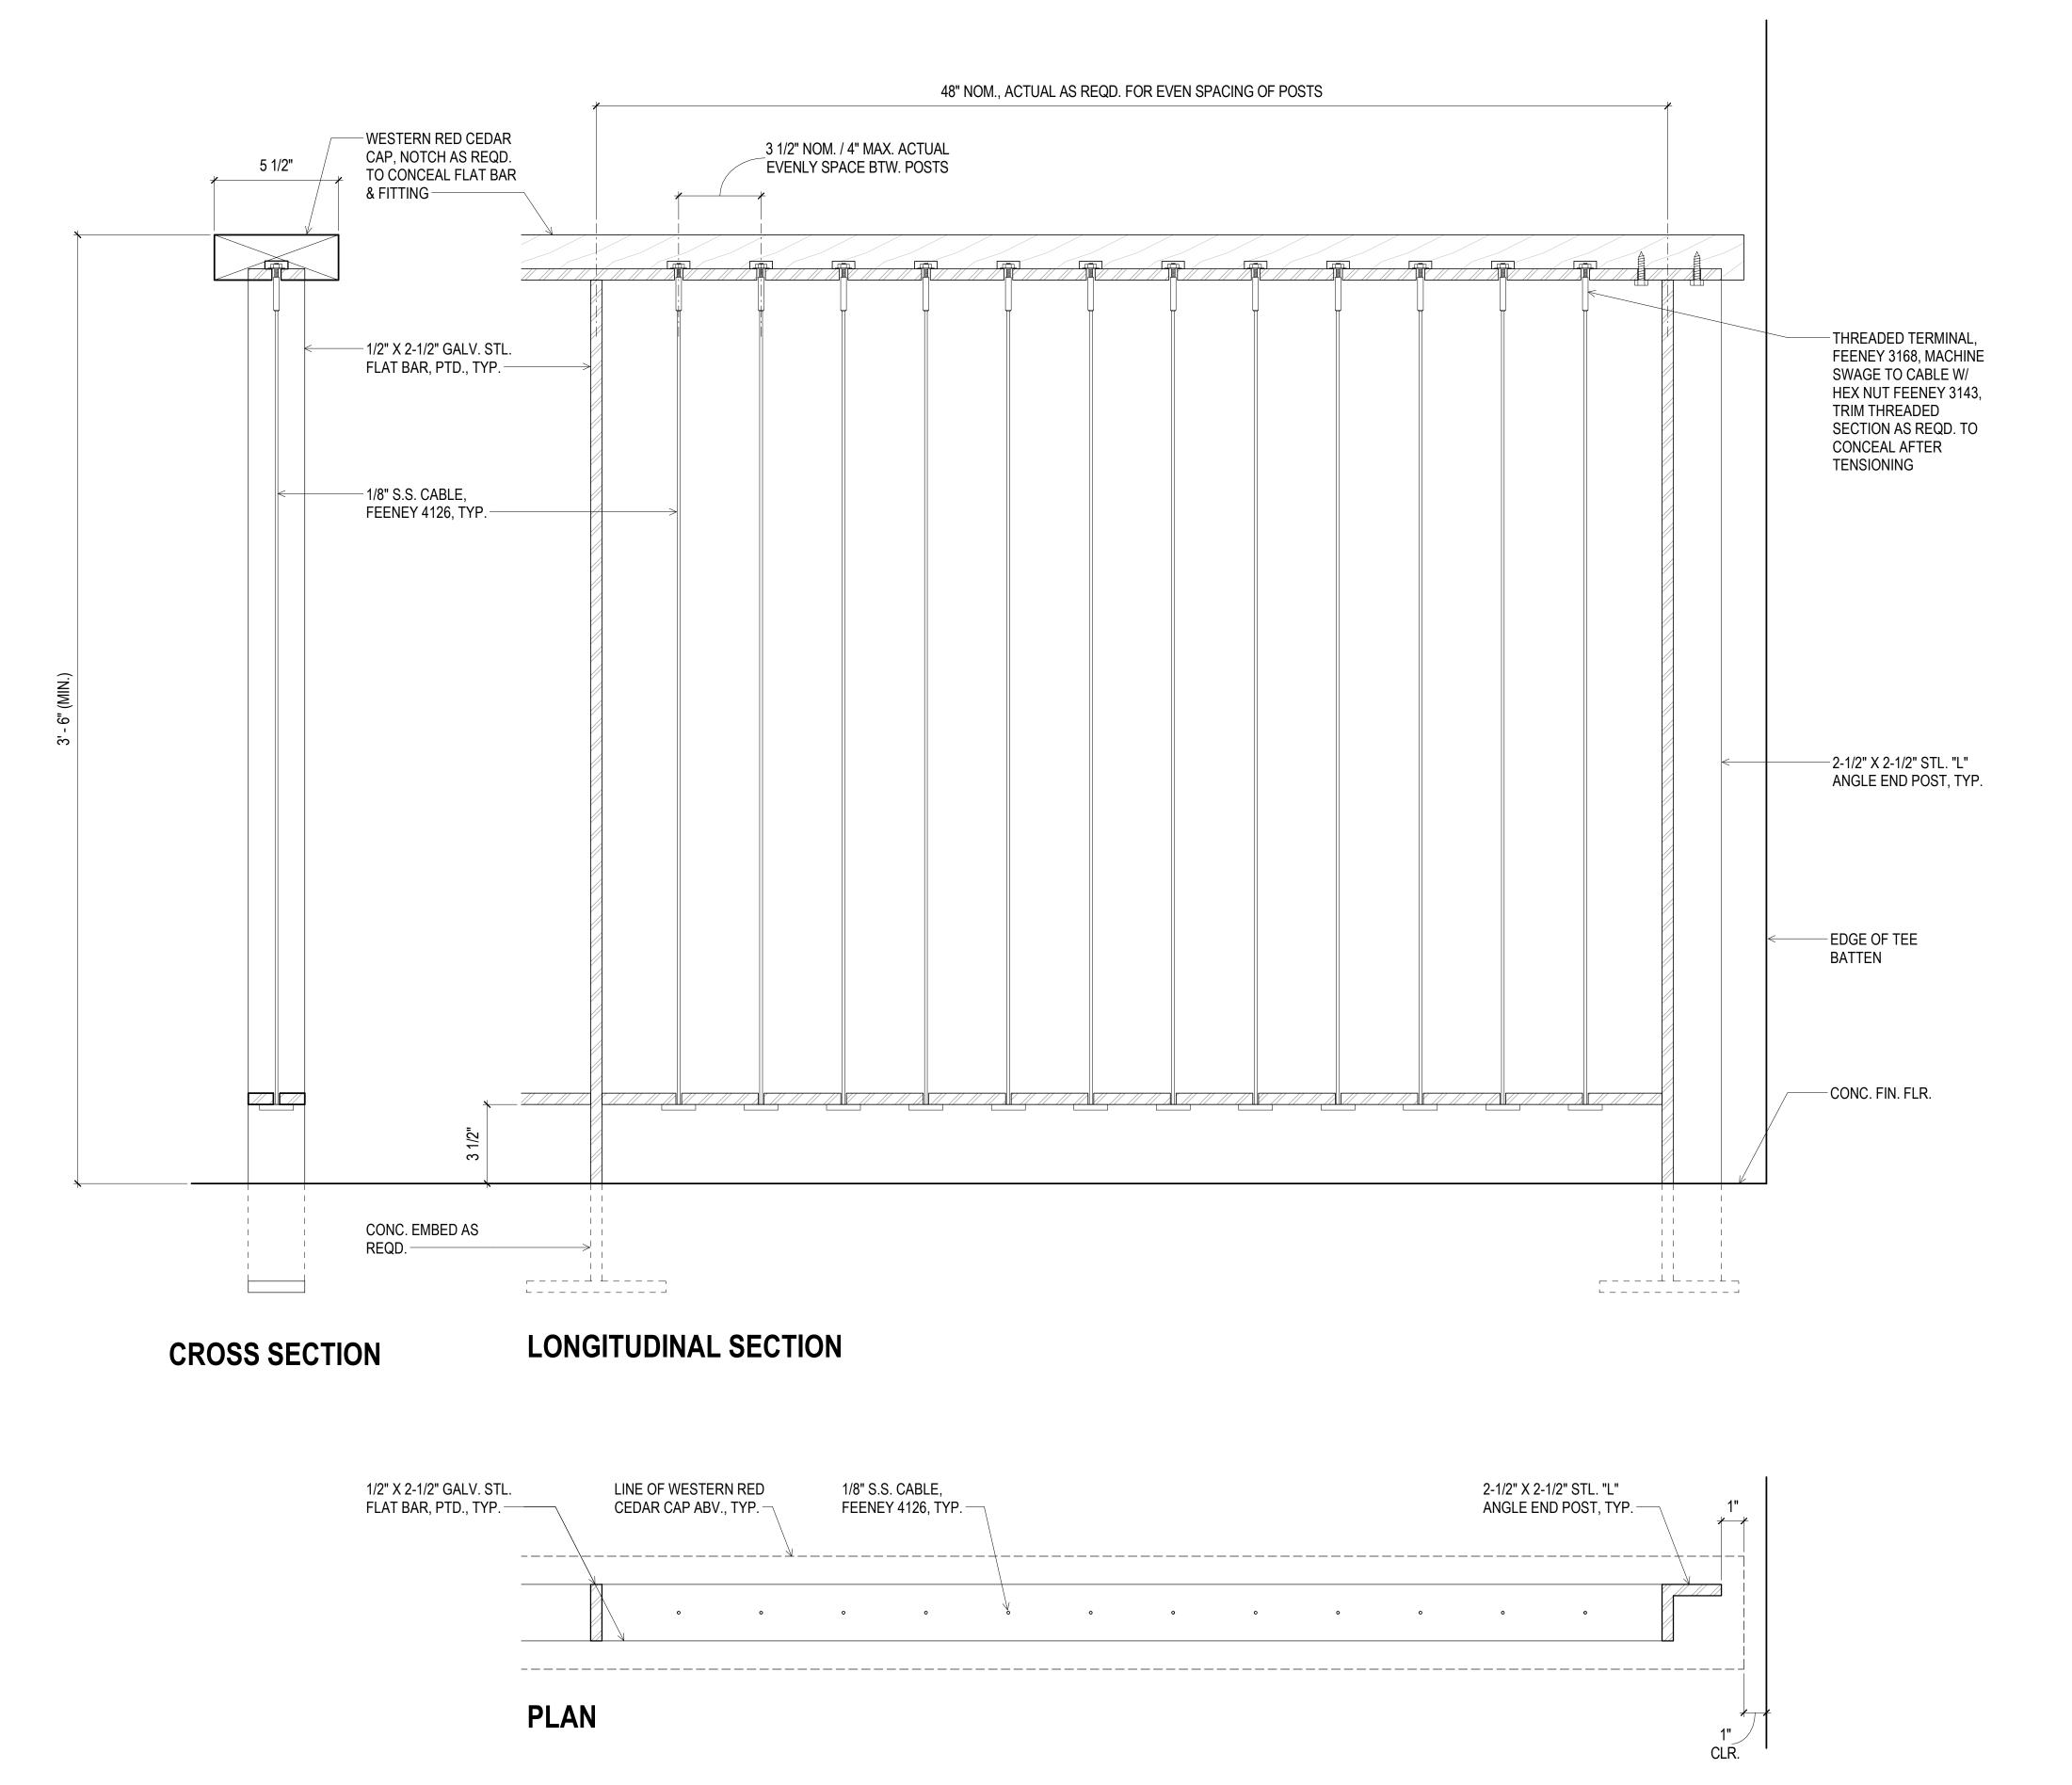

CITY AND COUNTY OF SAN FRANCISCO RECREATION AND PARKS DEPARTMENT 30 VAN NESS AVENUE SAN FRANCISCO, CA 94102

SCO MENT

PH. 415-831-2700

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PRIME CONSULTANT / LANDSCAPE ARCHITECT GUSTAFSON GUTHRIE NICHOL PH. 206-903-6802 CIVIL ENGINEER SHERWOOD DESIGN ENGINEERS PH. 415-348-9650 ARCHITECT JENSEN ARCHITECTS PH. 415-348-9650 ECOLOGICAL RESTORATION RANA CREEK PH. 831-659-3820 STRUCTURAL ENGINEER JON BRODY STRUCTURAL ENGINEERS PH. 415-296-9494 COASTAL ENGINEER MOFFATT AND NICHOL PH. 925-944-5411 LIGHTING NITEO CALIFORNIA PH. 415-666-2232 MEP & IT INTERFACE ENGINEERING PH. 415-489-7240 GEOTECHNICAL ENGINEER AGS, INC PH. 415-957-9240 SECURITY CONSULTANT ZBETA CONSULTING PH. 415-259-0422

FOR OFFICIAL USE

KEY PLAN



RE	REVISIONS:				
NO.	DATE	DESCRIPTION			
01	12/18/2020	PERMIT SUBMITTAL			

ISSUANCE BID SET

DRAWN BY

JENSEN

DATE

CHECKED BY

GGN PROJECT #


7/01/2021 16

FOOD PAVILION -GUARDRAIL DETAILS

A290.1

SHEET NOTES:

- 1. REFERENCE 2019 CBC SECTION 302 FOR OCCUPANCY DESCRIPTIONS.
- 2. REFERENCE 2019 CBC TABLE 1004.5 FOR MAX. FLOOR AREA ALLOWANCES PER OCCUPANT.
- 3. REFERENCE 2019 CBC SECTION 1005 FOR MINIMUM EGRESS AND WIDTH REQUIREMENTS.
- 4. REFERENCE 2019 CBC TABLE 1006.2.1 FOR MINIMUM NUMBER OF EXITS FOR OCC. LOAD.
- 5. REFERENCE 2019 CBC TABLE 1017.2 FOR MAX. EXIT ACCESS TRAVEL DISTANCE WITH AUTOMATIC SPRINKLER SYSTEM. (A & E <250, B <300, S-2 & U <400)
- 6. REFERENCE 2019 CPC TABLE 422-1 FOR PLUMBING FIXTURE REQUIREMENTS.
- 7. PER 2019 CPC TABLE 422-1, NOTE 4, "FOR EACH URINAL ADDED IN EXCESS OF THE MINIMUM REQUIRED, ONE WATER CLOSET SHALL BE PERMITTED TO BE DEDUCTED. THE NUMBER OF WATER CLOSETS SHALL NOT BE REDUCED TO LESS THAN TWO-THIRDS OF THE MINIMUM REQUIREMENT."

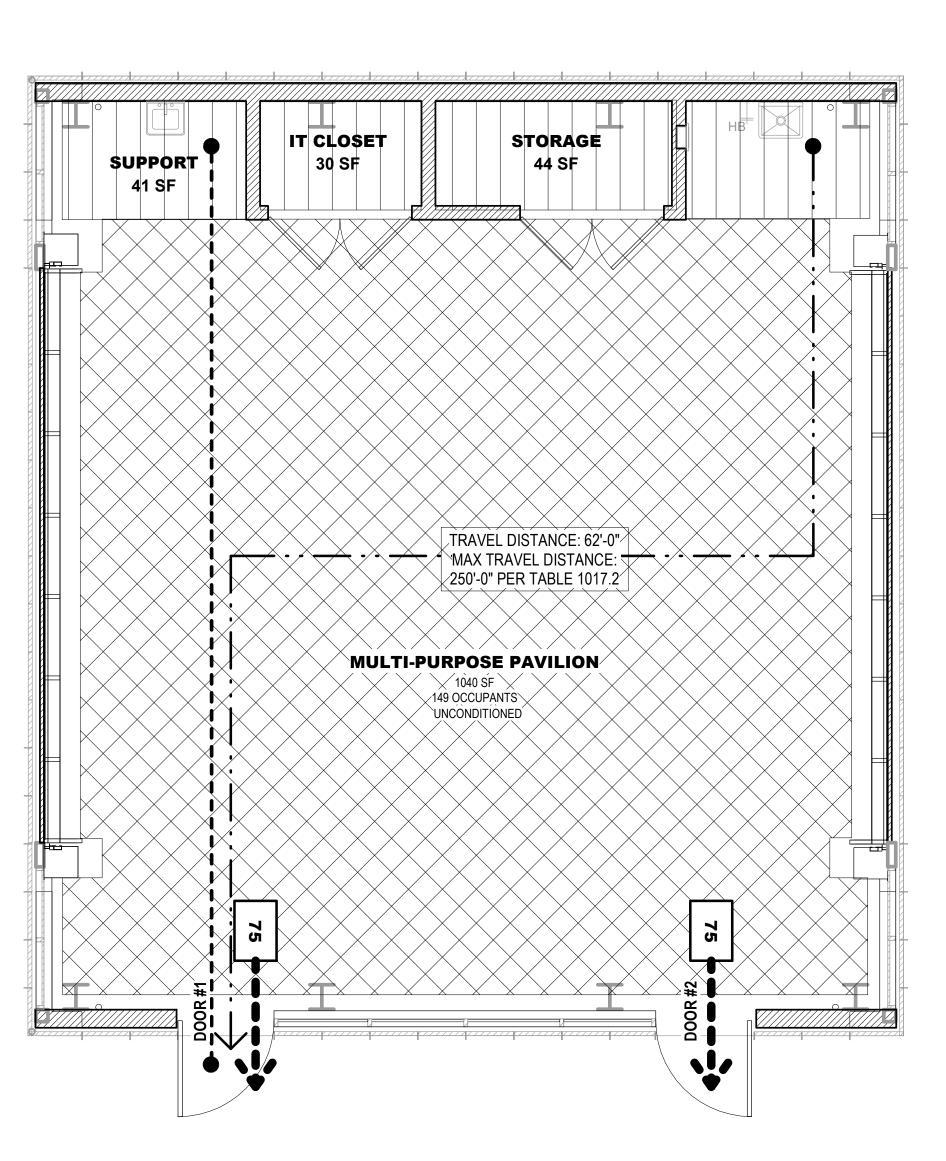

EGRESS PLAN 1/4" = 1'-0"

OCCUPANT LOAD - SHOP BUILDING

AREA	OCC. AREA (SQ FT)	FUNCTION OF SPACE	LOAD FACTOR	OCC. TOTAL	EXITS REQ.
MULTI-PURPOSE PAVILION	1040	ASSEMBLY, CONCENTRATED	1:7 NET	149	2
ACCESSORY STORAGE	153	ACCESSORY STORAGE & MECH TOTAL OCC		1 D:	1
				150	

PLUMBING FIXTURE SUMMARY

PLUMBING FIXTURE OCCUPANT COUNT SHOP BUILDING

AREA	OCCUPIED AREA (SQ FT)	PLUMBING OCCUPANCY GROUP	LOAD FACTOR	NUMBER OF OCCUPANTS
ACCESSORY STORAGE	153	(EXCLUDED)	0 SF	0
MULTI-PURPOSE PAVILION	1040	A1 - AUDITORIUM	1:30 SF	35
	Т	OTAL PLUMBING O	CCUPANT LOA	D : 35

REQUIRED RESTROOM FIXTURE COUNT

# OF OCCUPANTS	# OI	# OF FIXTURES		
35 TOTAL OCCUPANTS / 2 = 18	REQUIRED	PROVIDED (ALL GENDER)*		
18 MEN	1 W.C. / 0 URINAL	2 W.C. / 0 URINAL		
IO IVICIN	1 LAVATORIES	2 LAVATORIES		
18 WOMEN	1 W.C.	NA		
10 VVOIVIEN	1 LAVATORIES	NA		
	1 WATER FOUNTAIN	1 WATER FOUNTAIN		

*RESTROOM FIXTURES PROVIDED AT FOOD PAVILION LOWER LEVEL. SEE A020.1 FOR LOCATION


- **PER CPC TABLE 422.1, EXCEPTION 3, URINAL MAY BE OMITTED
- ***SHARED WATER FOUNTAIN. SEE A020.1 FOR LOCATION

EXITING REQUIREMENTS

EXIT COMPONENT	OCC. LOAD CAPACITY	ACTUAL OCC. LOAD	LOAD FACTOR	MIN. WIDTH	WIDTH PROVIDED
DOOR #1	210	75	0.2	34"	42"
DOOR #2	210	75	0.2	34"	42"

EGRESS LEGEND

2-HR RATED WALL

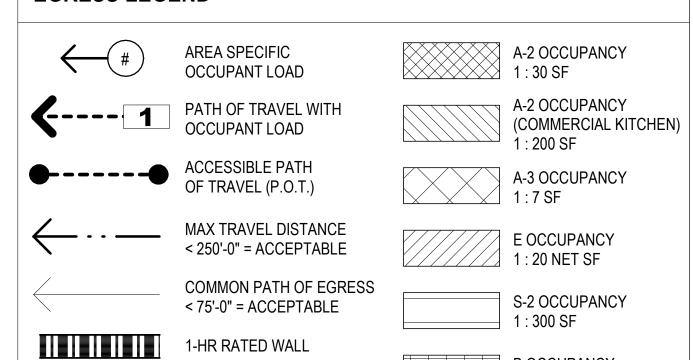

B OCCUPANCY 1:150 SF

900 INNES PARK DEVELOPMENT

CITY AND COUNTY OF SAN FRANCISCO RECREATION AND PARKS DEPARTMENT 30 VAN NESS AVENUE SAN FRANCISCO, CA 94102



THE TRUST FOR PUBLIC LAND 101 MONTGOMERY STREET SUITE 900 SAN FRANCISCO, CA 94104

PH. 415-831-2700

PH. 415-495-4014

PRIME CONSULTANT / LANDSCAPE ARCHITECT GUSTAFSON GUTHRIE NICHOL PH. 206-903-6802

CIVIL ENGINEER SHERWOOD DESIGN ENGINEERS PH. 415-348-9650 ARCHITECT

JENSEN ARCHITECTS PH. 415-348-9650 ECOLOGICAL RESTORATION RANA CREEK PH. 831-659-3820

STRUCTURAL ENGINEER JON BRODY STRUCTURAL ENGINEERS PH. 415-296-9494 COASTAL ENGINEER

MOFFATT AND NICHOL PH. 925-944-5411 LIGHTING


NITEO CALIFORNIA PH. 415-666-2232 MEP & IT INTERFACE ENGINEERING PH. 415-489-7240

GEOTECHNICAL ENGINEER AGS, INC PH. 415-957-9240 SECURITY CONSULTANT ZBETA CONSULTING

FOR OFFICIAL USE

PH. 415-259-0422

KEY PLAN

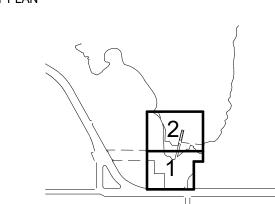



REVISIONS:

	DATE 12/18/2020	DESCRIPTION PERMIT SUBMITTAL

ISSUANCE

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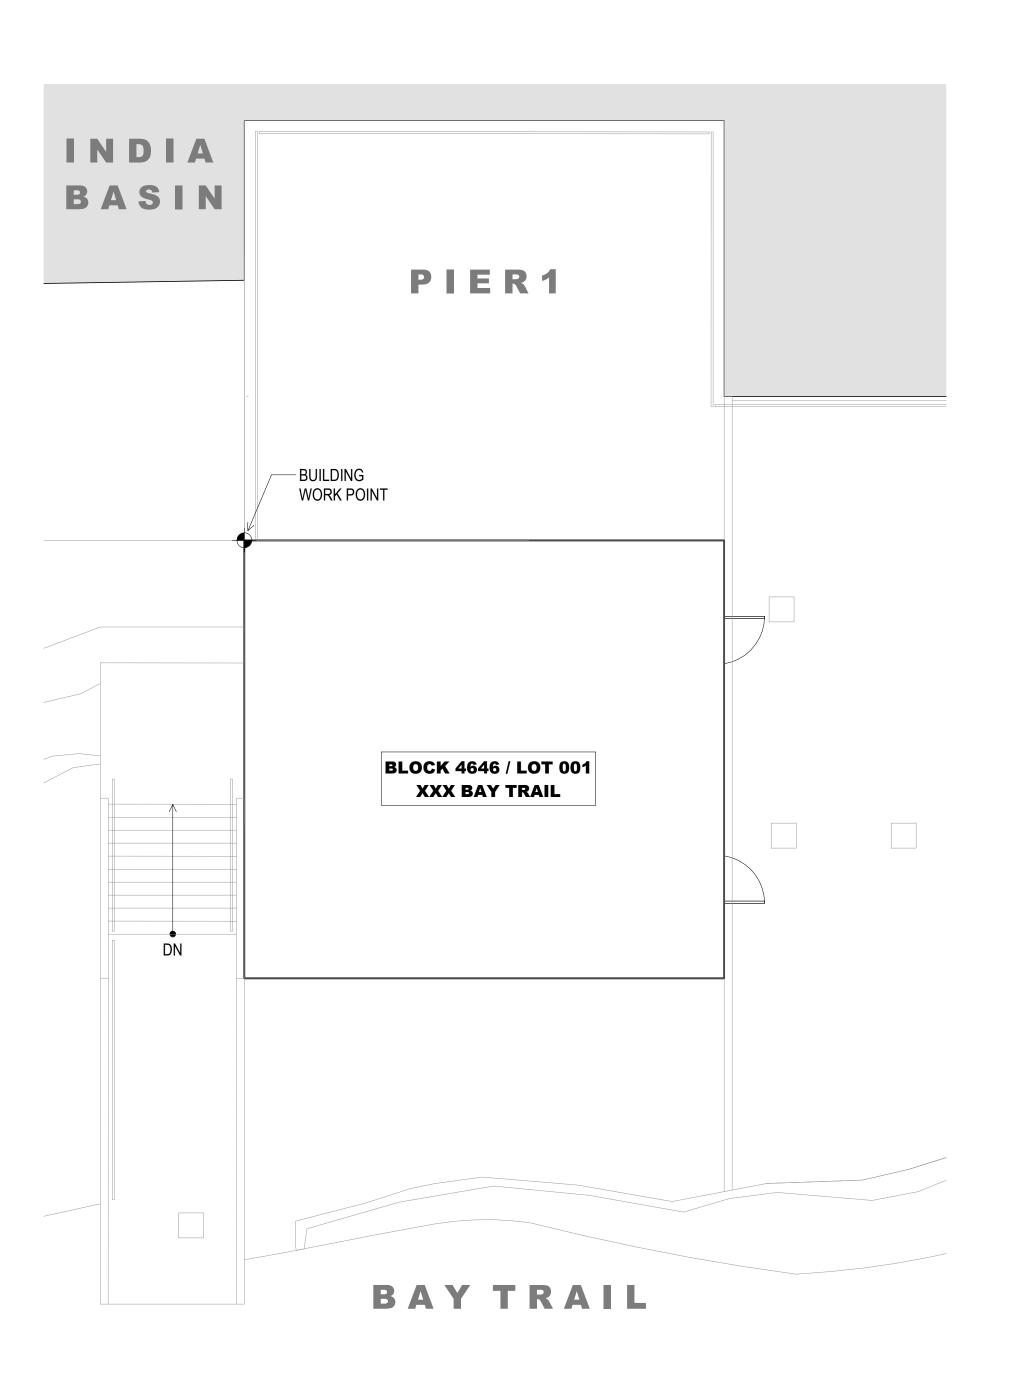
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GGN PROJECT # 7/01/2021

EGRESS / ACCESSIBLE POT / FIRE RATING PLAN

A301.1

CHECKED BY



SITE PLAN - SHOP BUILDING

1/8" = 1'-0"

BUILDING 3: SHOP BUILDING

BUILDING INFORMATION:	EXISTING	PROPOSED	REQ. / ALLOW.
CONSTRUCTION TYPE	-	TYPE V-B	-
STORIES OF OCCUPANCY	-	1	2
BASEMENTS	-	0	-
BUILDING HEIGHT	-	18'-0"	60' - 0"
OCCUPANCY GROUP	-	A-3 / B / F-2	-
FIRE SPRINKLERS	-	YES	NONE REQ.
GROSS FLOOR AREA:	EXISTING	PROPOSED	REQ. / ALLOW.
MAIN LEVEL	-	1,294 SQFT.	
TOTAL BUILDING AREA:	-	1,294 SQFT.	30,000 SQFT.
SHEET NOTES.			

SHEET NOTES:

 LANDSCAPING AND SITE SHOWN FOR REF. ONLY - SEE CIVIL, LANDSCAPE, OR COASTAL ENGINEERING DRAWINGS FOR DETAILS.

900 INNES PARK DEVELOPMENT

CITY AND COUNTY OF SAN FRANCISCO RECREATION AND PARKS DEPARTMENT 30 VAN NESS AVENUE



SAN FRANCISCO, CA 94102 PH. 415-831-2700 THE TRUST FOR PUBLIC LAND 101 MONTGOMERY STREET SUITE 900 SAN FRANCISCO, CA 94104

PH. 415-495-4014



PRIME CONSULTANT / LANDSCAPE ARCHITECT GUSTAFSON GUTHRIE NICHOL PH. 206-903-6802 CIVIL ENGINEER

CIVIL ENGINEER
SHERWOOD DESIGN ENGINEERS
PH. 415-348-9650
ARCHITECT
JENSEN ARCHITECTS
PH. 415-348-9650

ECOLOGICAL RESTORATION

RANA CREEK

PH. 831-659-3820 STRUCTURAL ENGINEER JON BRODY STRUCTURAL ENGINEERS PH. 415-296-9494 COASTAL ENGINEER MOFFATT AND NICHOL

PH. 925-944-5411
LIGHTING
NITEO CALIFORNIA
PH. 415-666-2232
MEP & IT
INTERFACE ENGINEERING
PH. 415-489-7240

GEOTECHNICAL ENGINEER
AGS, INC
PH. 415-957-9240
SECURITY CONSULTANT
ZBETA CONSULTING
PH. 415-259-0422

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JENSEN

DATE

GGN PROJECT # 1608

SHOP BUILDING -BUILDING SITE PLAN

CHECKED BY

A302.1

		ROOM FIN	NISH SCH	EDULE		
ROOM			FINIS	SH		
NO.	ROOM	FLOOR	BASE	WALL	CEILING	REMARKS
301	MULTI-PURPOSE PAVILION	CONC-3	CONC-3	PLY-1	PLY-1	
302	SUPPORT	CONC-3	CONC-3	PLY-1	PLY-1	
303	IT CLOSET	CONC-3	CONC-3	PLY-1	PLY-1	
304	STORAGE	CONC-3	CONC-3	PLY-1	PLY-1	
305	SUPPORT	CONC-3	CONC-3	PLY-1	PLY-1	


FINISH LEGEND

FINISH CODE	DESCRIPTION	MANUFACTURER	PRODUCT	SIZE	SPECIES / COLOR	FINISH
CONC-1	CONCRETE - EXT.	NA	NA	NA	NA	PENETRATING SEALER PER SPEC., WATER-WASHED EXPOSE AGGREGATE FINISH
CONC-3	CONCRETE - INTERIOR	NA	NA	NA	NA	INT / SLIP RESISTANT, SEAL PER SPEC.
PLY-1	PLYWOOD	-	PER SPEC.	AS SHOWN	PER SPEC.	BONA TRAFFIC HD

		F.	E.C. LEGEN	D	
TAG	MFR.	SERIES / MODEL	TRIM STYLE	DOOR STYLE	FINISH
FEC-1	J.L. INDUSTRIES	AMBASSADOR / 1016	1-1/2" SQUARE	V10, PULL HANDLE	WHITE POWDERCOAT
FEC-2	J.L. INDUSTRIES	AMBASSADOR / 2012	4" ROLLED	V10, FLUSH PULL	WHITE POWDERCOAT

FIRE EXTINGUISHERS:

- 1. TYPICAL: CLASS ABC, 5-LB CAPACITY, UL RATING
- 2A:10BC
- 2. COMMERCIAL KITCHEN: CLASS K, WET CLASS(WC) IN ACCORDANCE W/ CFC SECTION 904.11.5, J.L. INDUSTRIES "SATURN"

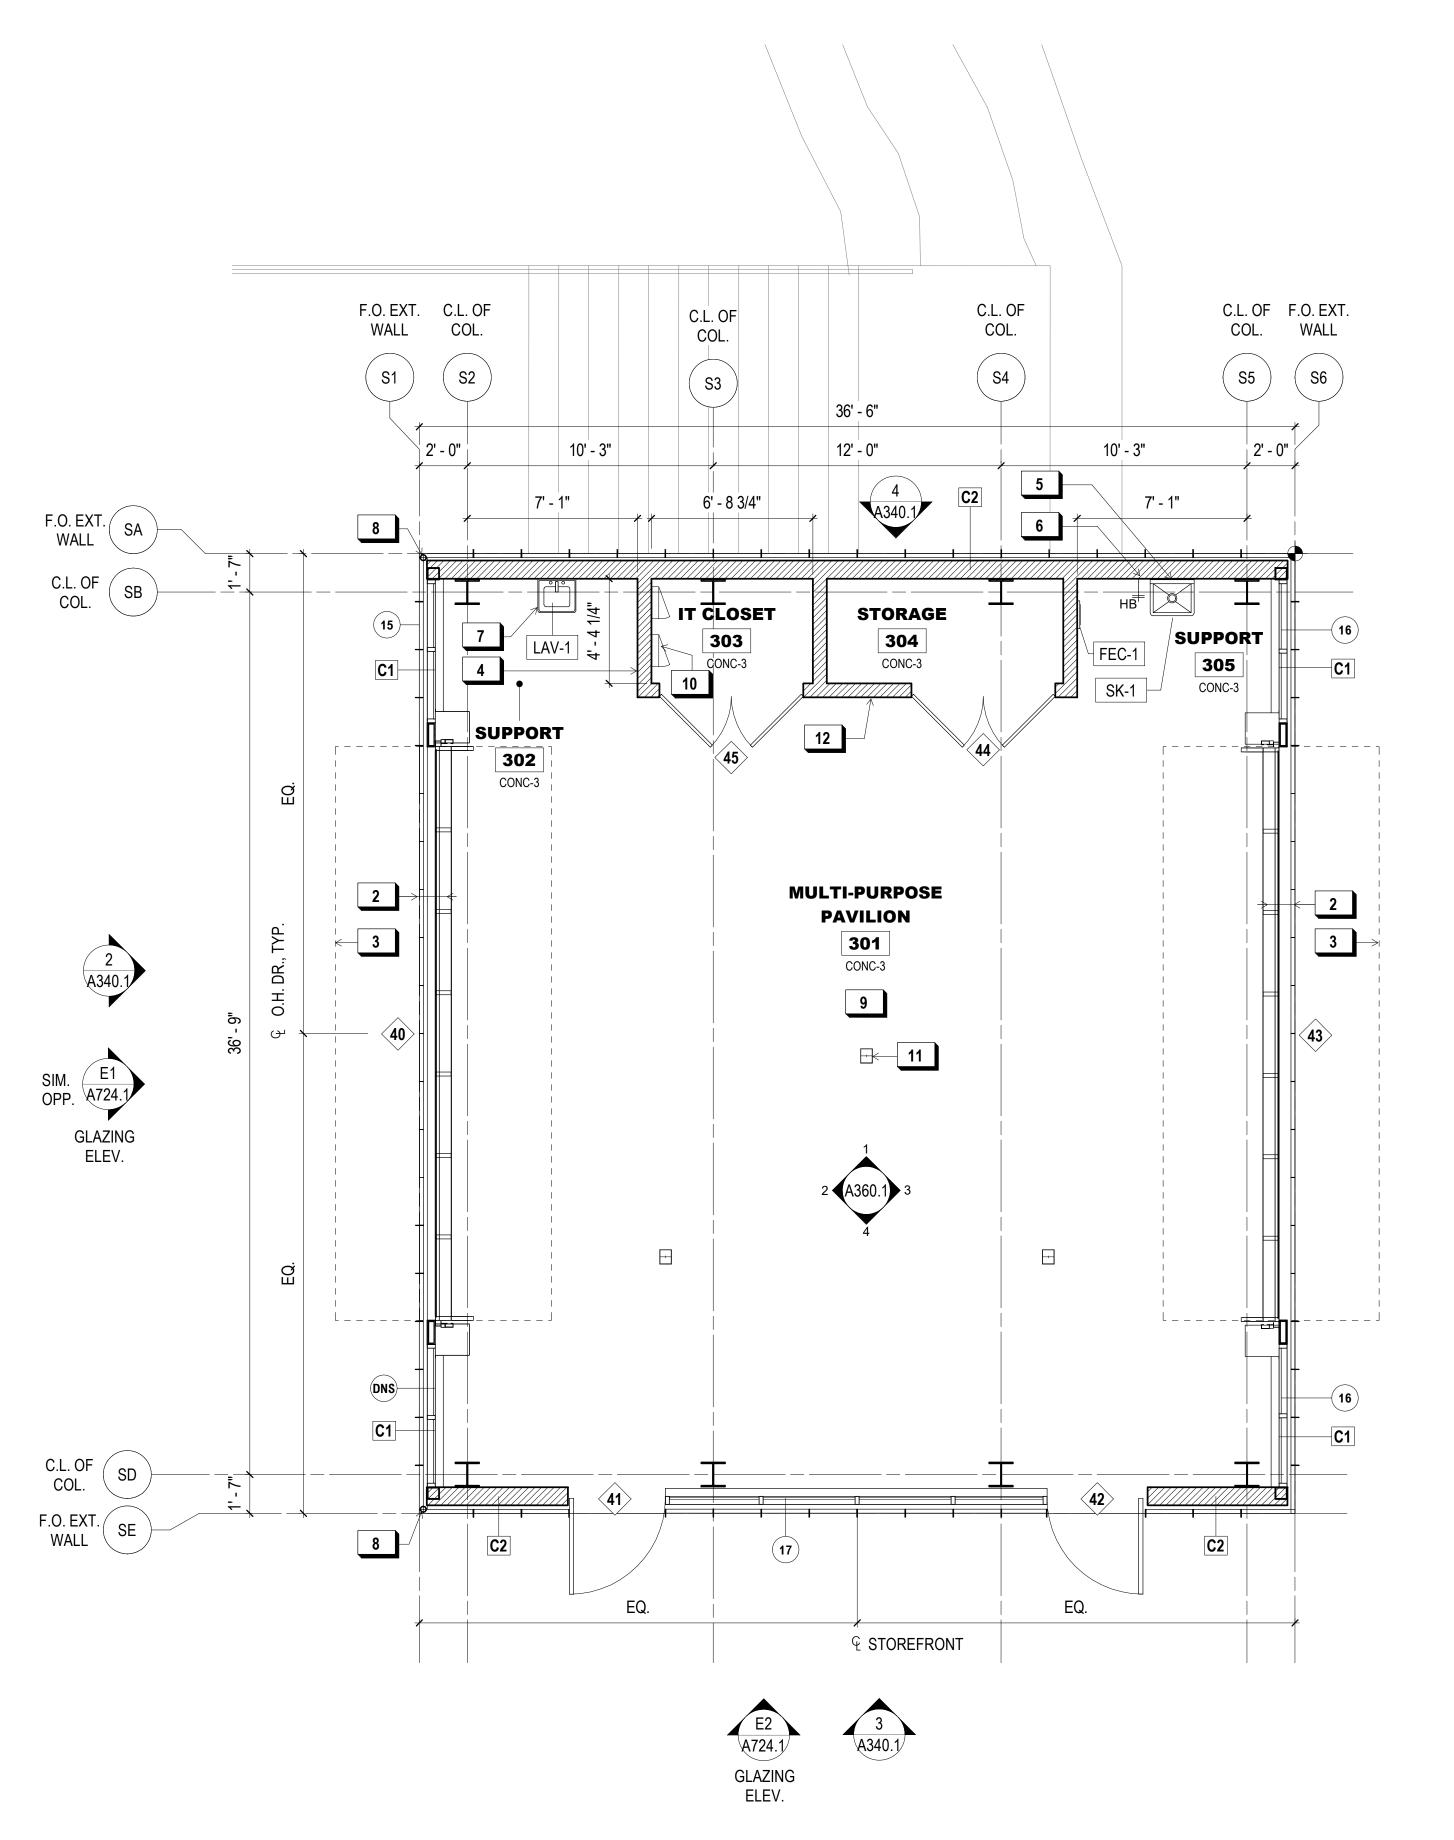

SHEET NOTES:

- 1. SEE SHEETS A801.1-A803.1 FOR WALL
- 2. ALL SWITCHES, CONTROLS, AND ELEC. RECEPTACLES NOT DEDICATED TO EQUIP. SHALL BE WITHIN AN ACCESSIBLE REACH RANGE PER CBC 2019 11B-308.1. SEE 6/A023.1 FOR TYP. MOUNTING HGTS.

WALL LEGEND:

NEW WALL / ELEMENT

NEW CONCRETE WALL

EXISTING WALL / ELEMENT

BUILDING WORKING PT. (S.L.D. FOR LOC. ON SITE)

X KEY NOTES:

- DR. IN CLOSED POSITION
- OUTLINE OF DR. IN OPEN POSITION ABOVE STUB OUT FOR FUTURE EYE-WASH
- STATION
- MOP SINK
- HOSE BIBB ACCESSIBLE SINK
- 3" D.S., NOTCH PERF. MTL. FLANGES AS
- UNCONDITIONED PAVILION, INTENDED
- FOR USE WITH OVERHEAD SECURITY DOORS IN OPEN POSITION
- 10 | ELECTRICAL PANEL, S.E.D. 11 | FLOOR OUTLET, TYP., S.E.D.
- 12 6" MTL. FRAMING @ INT. WALL, TYP.





900 INNES PARK DEVELOPMENT

CITY AND COUNTY OF SAN FRANCISCO RECREATION AND PARKS DEPARTMENT 30 VAN NESS AVENUE SAN FRANCISCO, CA 94102

SUITE 900

PH. 415-495-4014

PH. 415-831-2700 THE TRUST FOR PUBLIC LAND 101 MONTGOMERY STREET SAN FRANCISCO, CA 94104

PRIME CONSULTANT / LANDSCAPE ARCHITECT GUSTAFSON GUTHRIE NICHOL PH. 206-903-6802

CIVIL ENGINEER SHERWOOD DESIGN ENGINEERS PH. 415-348-9650 ARCHITECT JENSEN ARCHITECTS

PH. 415-348-9650 ECOLOGICAL RESTORATION RANA CREEK PH. 831-659-3820 STRUCTURAL ENGINEER

JON BRODY STRUCTURAL ENGINEERS PH. 415-296-9494 COASTAL ENGINEER MOFFATT AND NICHOL

PH. 925-944-5411 LIGHTING NITEO CALIFORNIA

PH. 415-666-2232 MEP & IT INTERFACE ENGINEERING

PH. 415-489-7240 GEOTECHNICAL ENGINEER AGS, INC PH. 415-957-9240

SECURITY CONSULTANT ZBETA CONSULTING PH. 415-259-0422

2

DESCRIPTION

BID SET

PROPOSED FLOOR PLAN

JENSEN

7/01/2021

CHECKED BY

GGN PROJECT #

SHOP BUILDING -

PERMIT SUBMITTAL

FOR OFFICIAL USE

KEY PLAN

REVISIONS:

01 12/18/2020

NO. DATE

ISSUANCE

DRAWN BY








FLOOR PLAN
1/4" = 1'-0"



A320.1

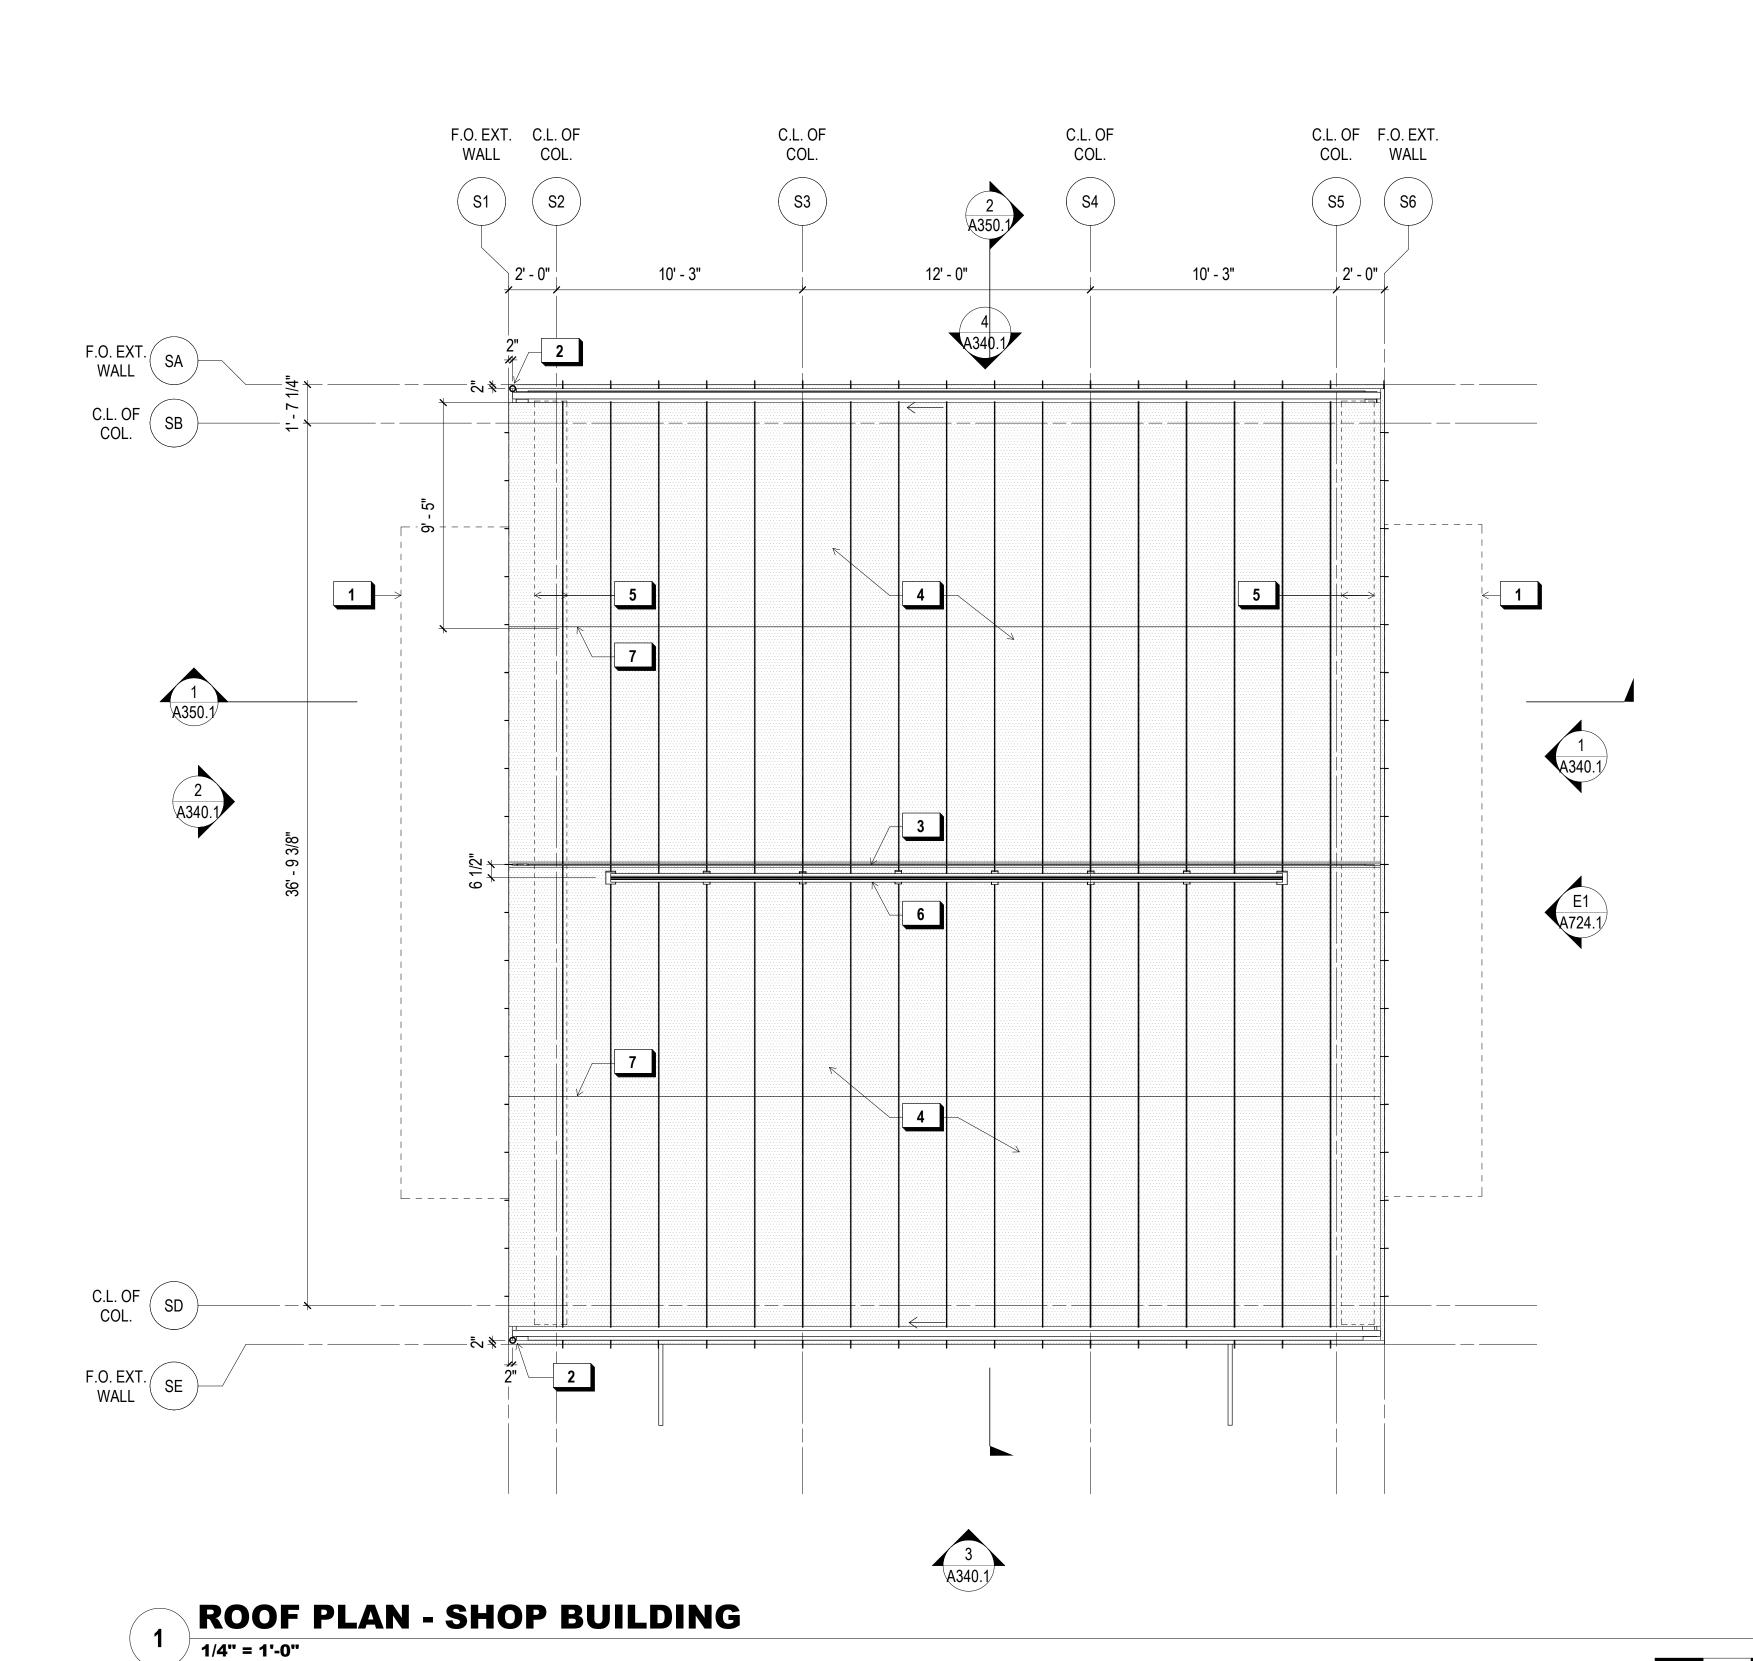

X KEY NOTES:

- LINE OF OVERHEAD DOOR (OPEN POSITION)
- CONCEALED GUTTER AND DOWNSPOUT
- 3 LINE OF RIDGE
- PERF. METAL ROOF CLADDING

 EXTENTS OF OPEN AIR SPACE BY
- 5 EXTENTS OF OPEN-AIR SPACE BELOW
 6 OSHA-COMPLIANT HORIZONTAL LIFELINE FALL PROTECTION SYSTEM, SECURE TO
- ALTERNATING BATTEN FINS
 HORIZONTAL PANEL JOINT

900 INNES
PARK DEVELOPMENT

CITY AND COUNTY OF SAN FRANCISCO RECREATION AND PARKS DEPARTMENT 30 VAN NESS AVENUE SAN FRANCISCO, CA 94102



PH. 415-831-2700


THE TRUST FOR PUBLIC LAND
101 MONTGOMERY STREET
SUITE 900
SAN FRANCISCO, CA 94104



PH. 415-495-4014 PRIME CONSULTANT / LANDSCAPE ARCHITECT GUSTAFSON GUTHRIE NICHOL PH. 206-903-6802 CIVIL ENGINEER SHERWOOD DESIGN ENGINEERS PH. 415-348-9650 ARCHITECT JENSEN ARCHITECTS PH. 415-348-9650 ECOLOGICAL RESTORATION RANA CREEK PH. 831-659-3820 STRUCTURAL ENGINEER JON BRODY STRUCTURAL ENGINEERS PH. 415-296-9494 COASTAL ENGINEER MOFFATT AND NICHOL PH. 925-944-5411 LIGHTING NITEO CALIFORNIA PH. 415-666-2232 MEP & IT INTERFACE ENGINEERING PH. 415-489-7240 GEOTECHNICAL ENGINEER AGS, INC PH. 415-957-9240 SECURITY CONSULTANT ZBETA CONSULTING PH. 415-259-0422

FOR OFFICIAL USE

KEY PLAN

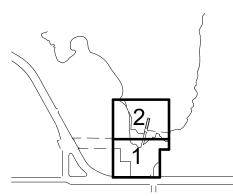



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JENSEN


GGN PROJECT #

7/01/2021 1608 SHOP BUILDING -

CHECKED BY

PROPOSED ROOF PLAN

A321.1

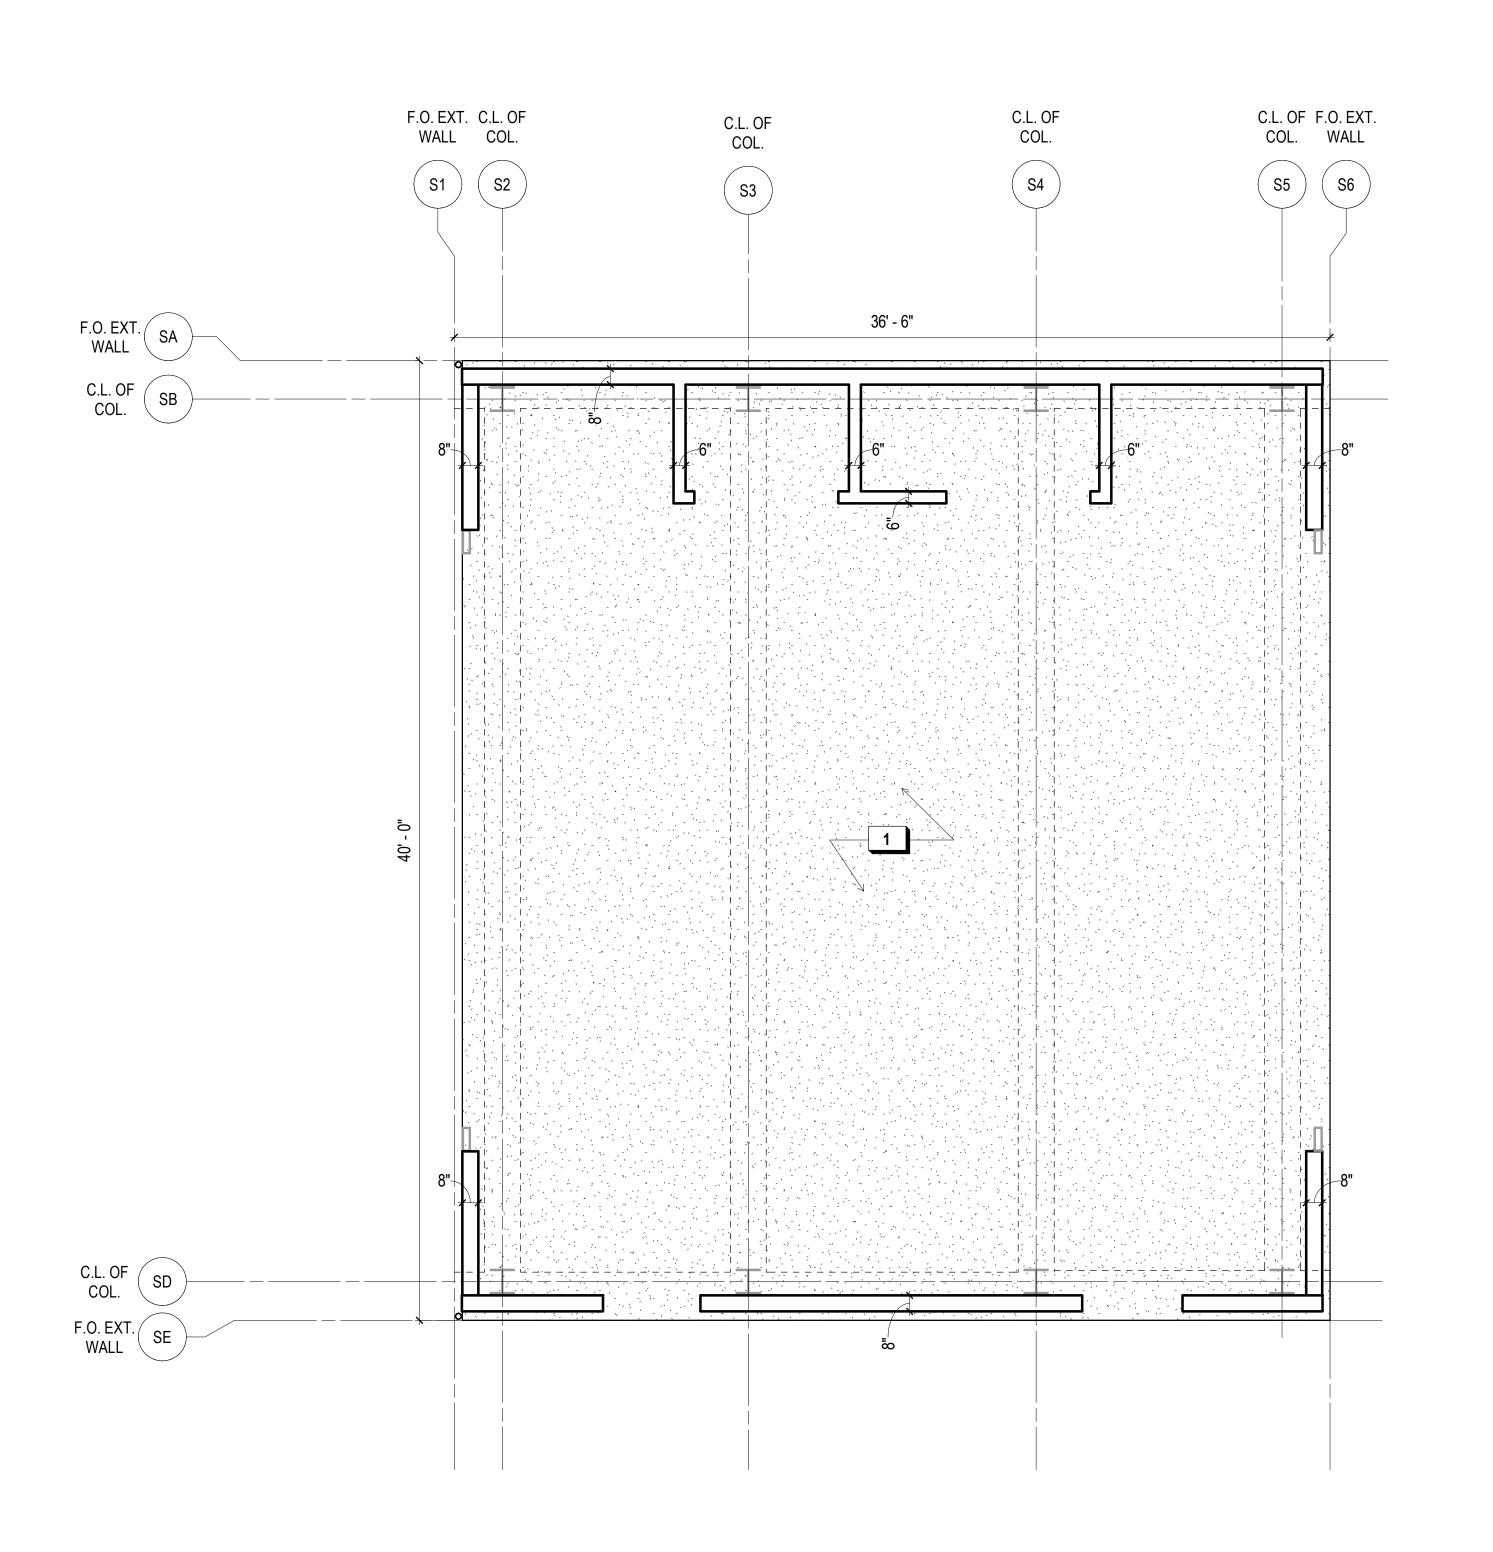

WALL LEGEND: 900 INNES STRUCTURAL CONC. SLAB PARK DEVELOPMENT W/ 3" TOPPING TYP. U.O.N. SPLIT CONC. TOPPING SLAB CITY AND COUNTY OF SAN FRANCISCO O/ STRUCTURAL CONC. SLAB RECREATION AND PARKS DEPARTMENT 30 VAN NESS AVENUE CONC. WALL SAN FRANCISCO, CA 94102 PH. 415-831-2700 CONC. CURB (6" A.F.F. U.O.N.) THE TRUST FOR PUBLIC LAND 101 MONTGOMERY STREET WALL OR FOOTING BELOW SUITE 900 L _ _ _ J SAN FRANCISCO, CA 94104 AREA DRAIN PH. 415-495-4014 LINEAR SLOT DRAIN PRIME CONSULTANT / LANDSCAPE ARCHITECT GUSTAFSON GUTHRIE NICHOL PH. 206-903-6802 **SHEET NOTES:** CIVIL ENGINEER SHERWOOD DESIGN ENGINEERS 1. REFER TO STRUCTURAL DRAWINGS FOR PH. 415-348-9650 SIZING AND LOCATION OF PILES, ARCHITECT JENSEN ARCHITECTS FOUNDATIONS, RETAINING WALLS, AND PH. 415-348-9650 STEM WALLS. ECOLOGICAL RESTORATION 2. REFER TO LANDSCAPE DRAWINGS FOR RANA CREEK SIZING AND LOCATION OF EXTERIOR PH. 831-659-3820 PAVING AND SLABS. STRUCTURAL ENGINEER 3. DIMENSIONS SHOWN FOR REFERENCE JON BRODY STRUCTURAL ENGINEERS PH. 415-296-9494 ONLY. VERIFY REQUIRED CLEAR COASTAL ENGINEER DIMENSIONS, ETC. WITH PROPOSED MOFFATT AND NICHOL FLOOR PLANS. PH. 925-944-5411 LIGHTING X KEY NOTES: NITEO CALIFORNIA PH. 415-666-2232 1 3" TOPPING SLAB O/ S.O.G. MEP & IT INTERFACE ENGINEERING PH. 415-489-7240 GEOTECHNICAL ENGINEER AGS, INC PH. 415-957-9240 SECURITY CONSULTANT ZBETA CONSULTING PH. 415-259-0422 FOR OFFICIAL USE KEY PLAN 2



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NO. DATE	DESCRIPTION


ISSUANCE **BID SET**

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CHECKED BY GGN PROJECT #

SHOP BUILDING - SLAB

A322.1

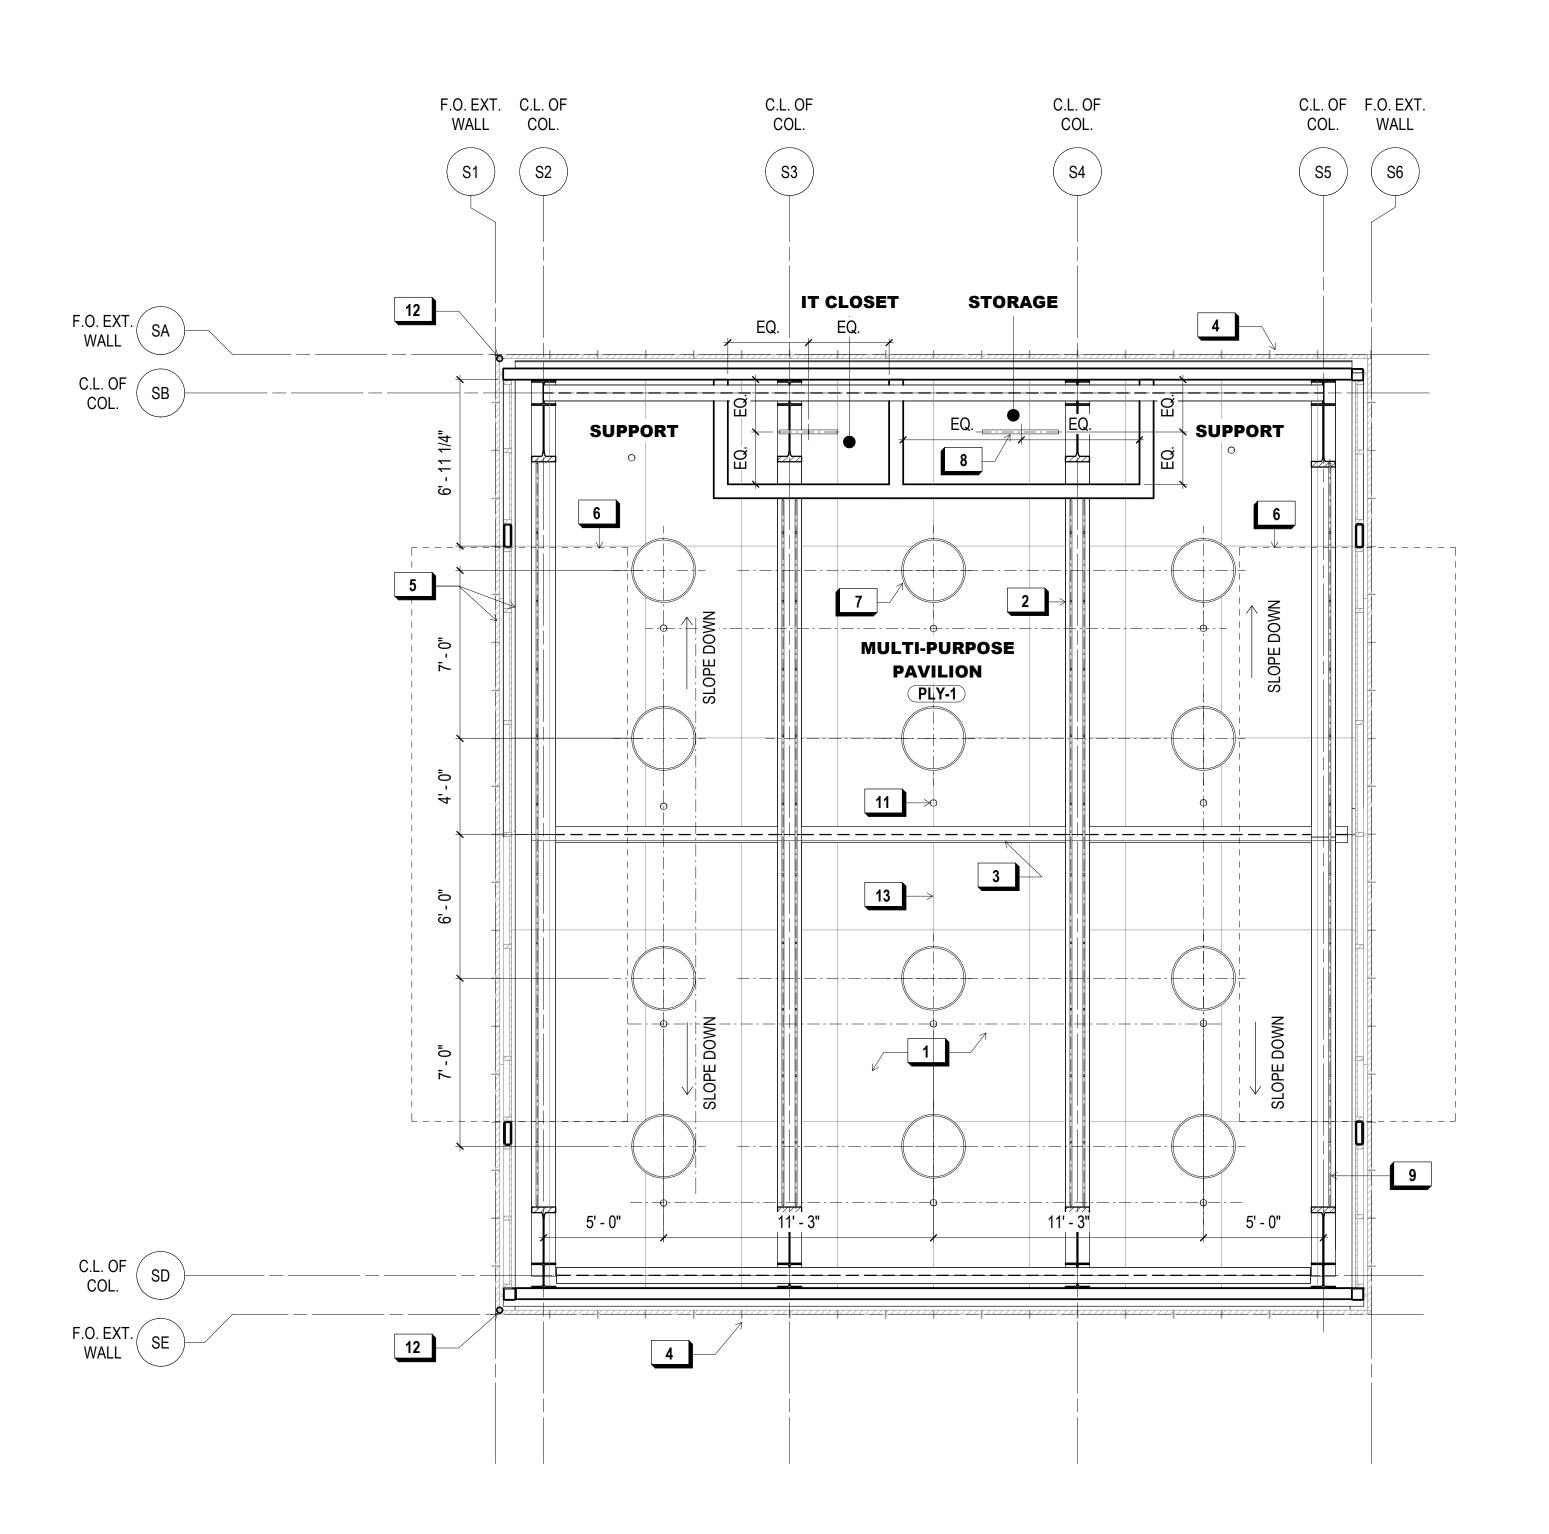

SHOP BUILDING - RCP 1/4" = 1'-0"



- SEE LIGHTING DESIGNER DRAWINGS AND ELECTRICAL DRAWINGS FOR LIGHTING LAYOUT
- 2. DESIGN BUILD FIRE SUPPRESSION SYSTEMS TO BE COORDINATED WITH ARCHITECT AND LIGHTING CONSULTANT

X KEY NOTES:

- FINISH DIRECTLY ATTACHED TO
- ROOF/FLOOR EXPOSED STRUCTURE, TYP.
- ROOF HIGH-POINT
- ROOF LOW-POINT PERF. METAL PANEL, TYP.
- OVERHEAD DOOR COUNTERWEIGHT EXTENTS IN OPEN POSITION
- PENDANT LIGHT
- PERFORATED WALL LINEAR LIGHT
- MICRO LINEAR UPLIGHT
- 11 | CONCEALED SPRINKLER HEAD, TYP.
- 12 3" DOWNSPOUT
- 13 PLYWOOD PANEL CEILING JOINT, TYP.

900 INNES PARK DEVELOPMENT

CITY AND COUNTY OF SAN FRANCISCO RECREATION AND PARKS DEPARTMENT 30 VAN NESS AVENUE SAN FRANCISCO, CA 94102



PH. 415-831-2700 THE TRUST FOR PUBLIC LAND 101 MONTGOMERY STREET SUITE 900 SAN FRANCISCO, CA 94104

PH. 415-495-4014



PRIME CONSULTANT / LANDSCAPE ARCHITECT GUSTAFSON GUTHRIE NICHOL

PH. 206-903-6802 CIVIL ENGINEER SHERWOOD DESIGN ENGINEERS

PH. 415-348-9650 ARCHITECT JENSEN ARCHITECTS PH. 415-348-9650

ECOLOGICAL RESTORATION RANA CREEK PH. 831-659-3820

STRUCTURAL ENGINEER JON BRODY STRUCTURAL ENGINEERS PH. 415-296-9494

COASTAL ENGINEER MOFFATT AND NICHOL PH. 925-944-5411 LIGHTING


NITEO CALIFORNIA PH. 415-666-2232 MEP & IT INTERFACE ENGINEERING PH. 415-489-7240

GEOTECHNICAL ENGINEER AGS, INC PH. 415-957-9240 SECURITY CONSULTANT ZBETA CONSULTING

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KEY PLAN



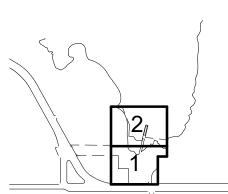

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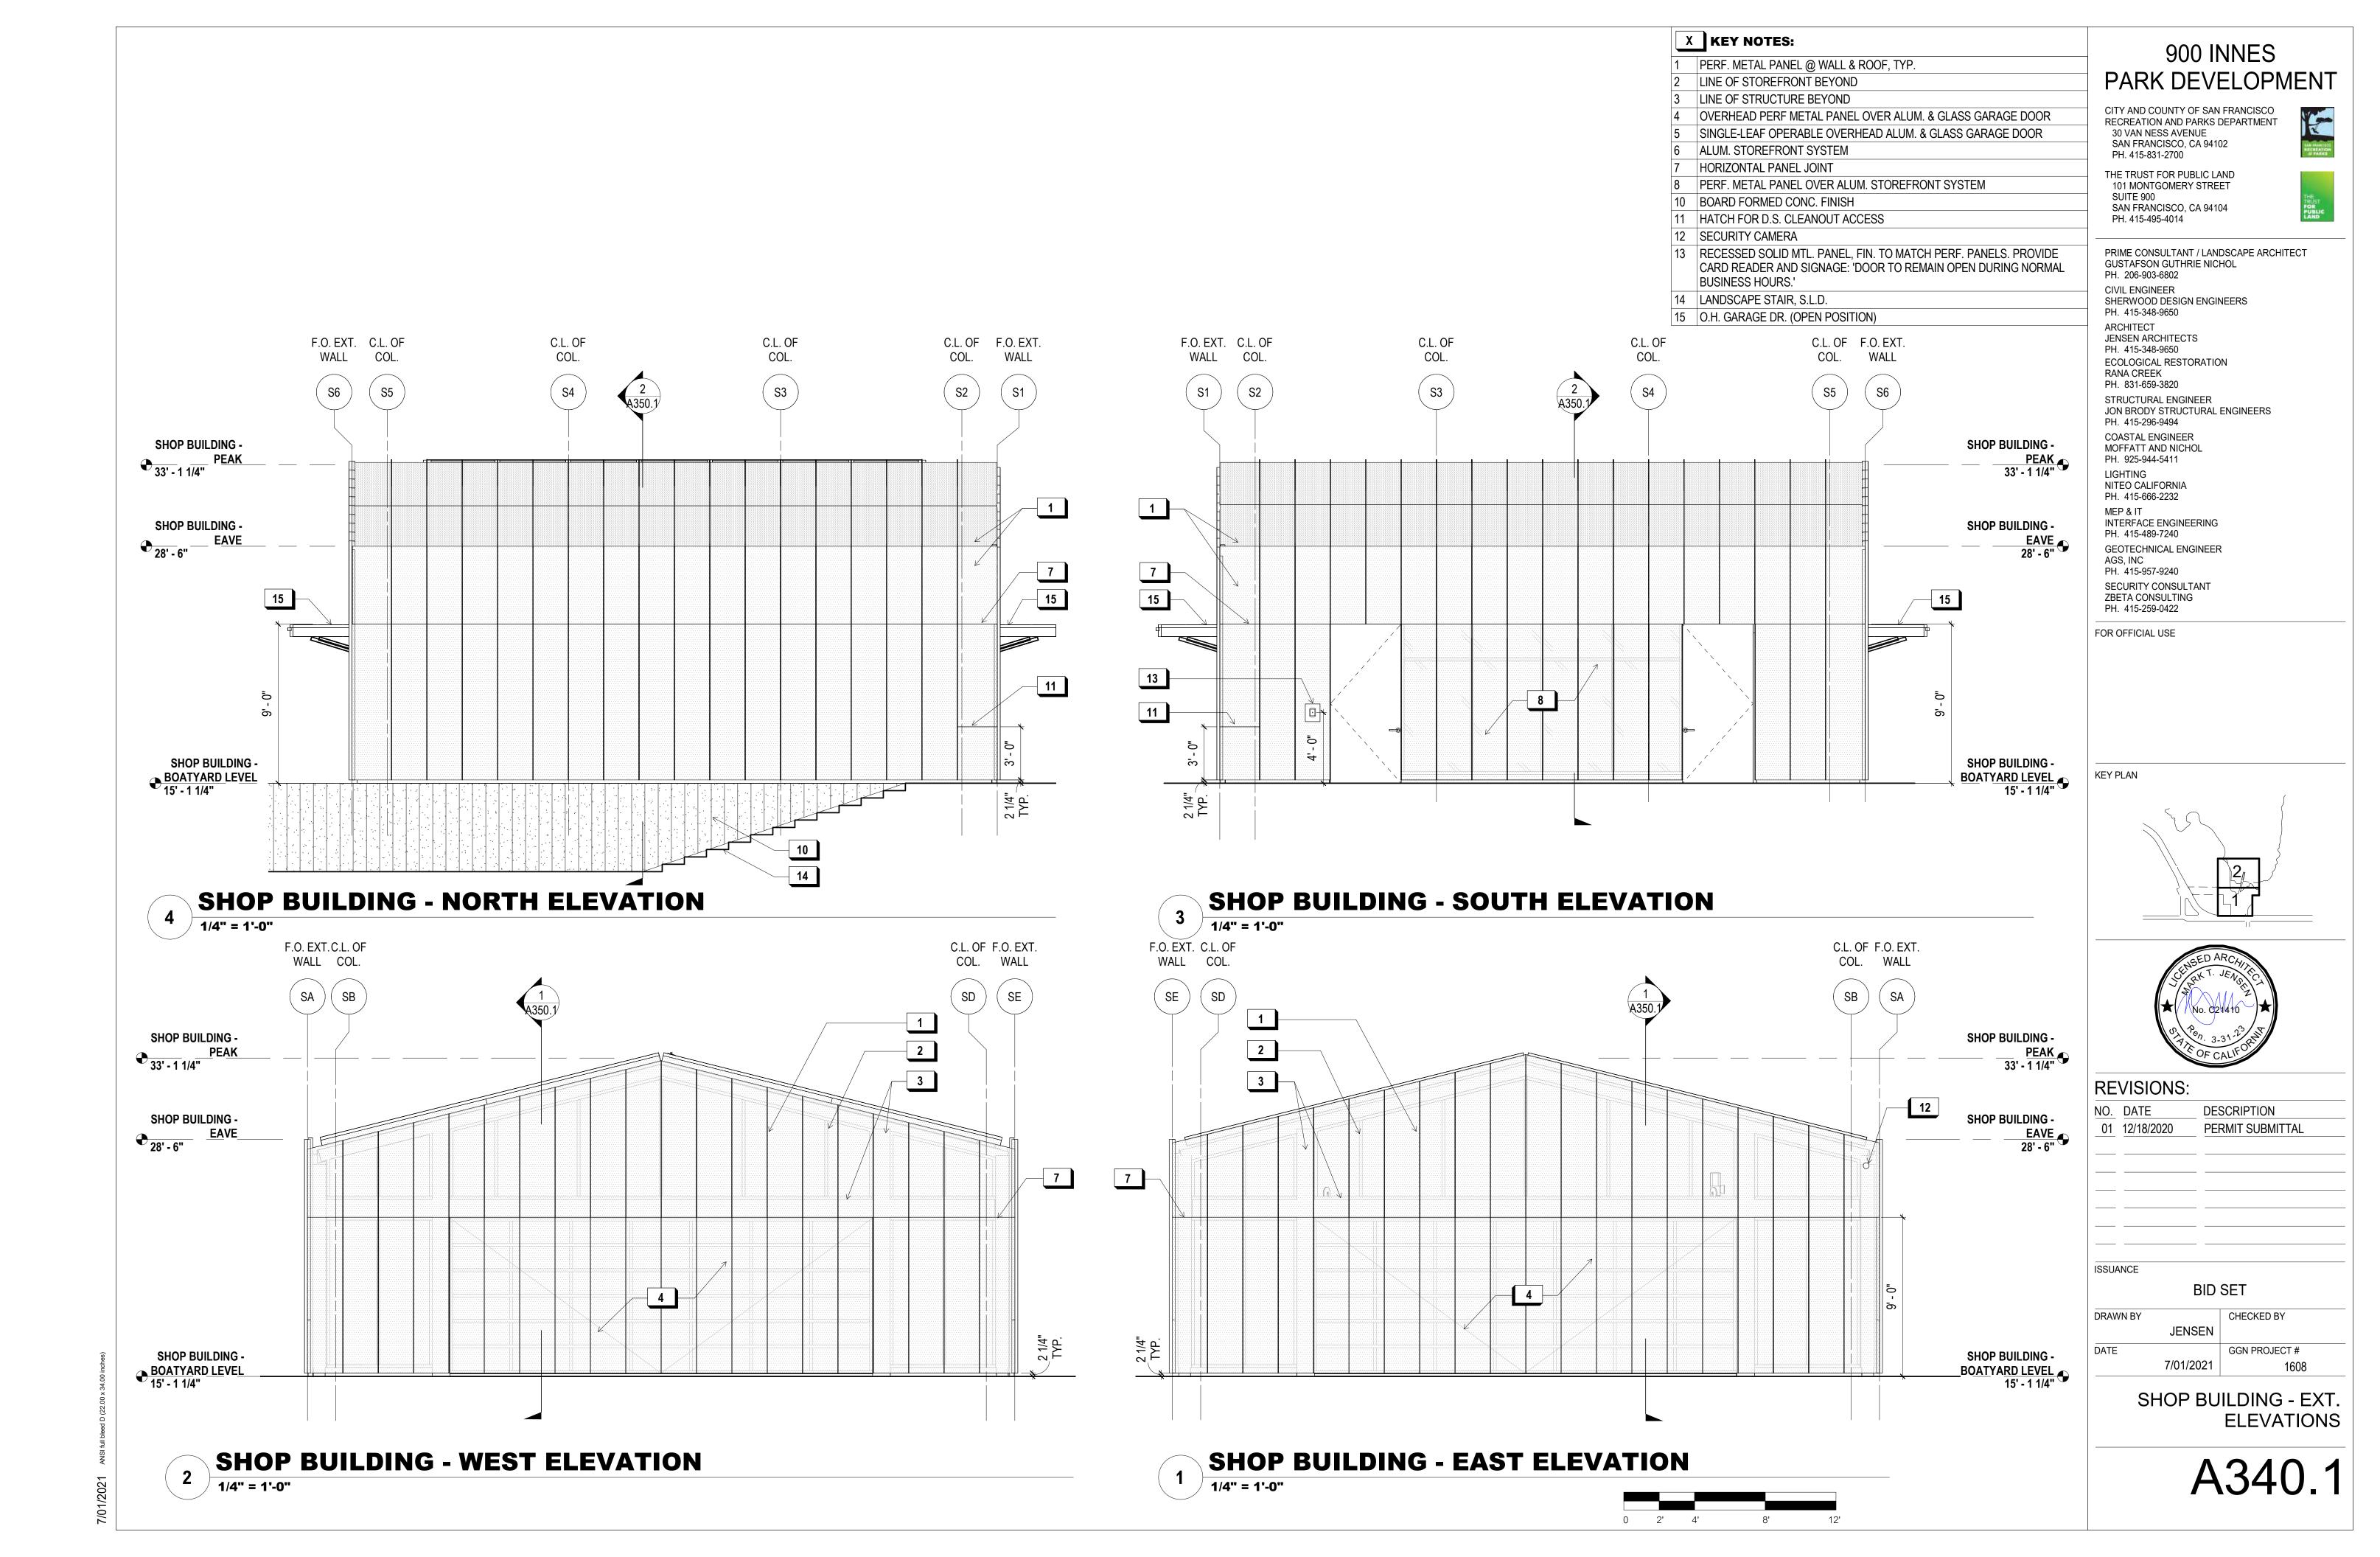
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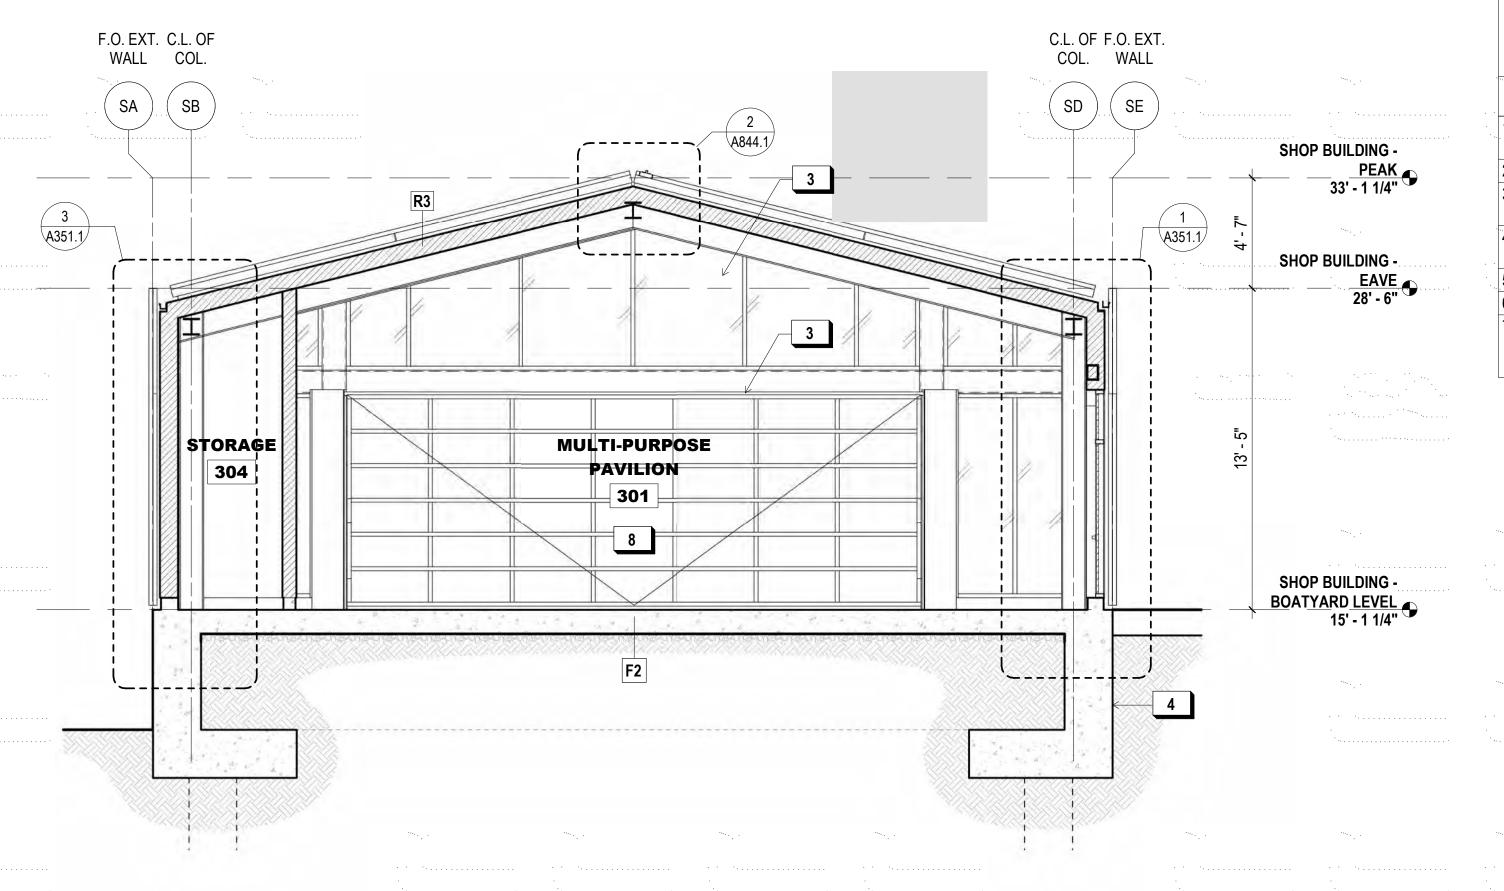
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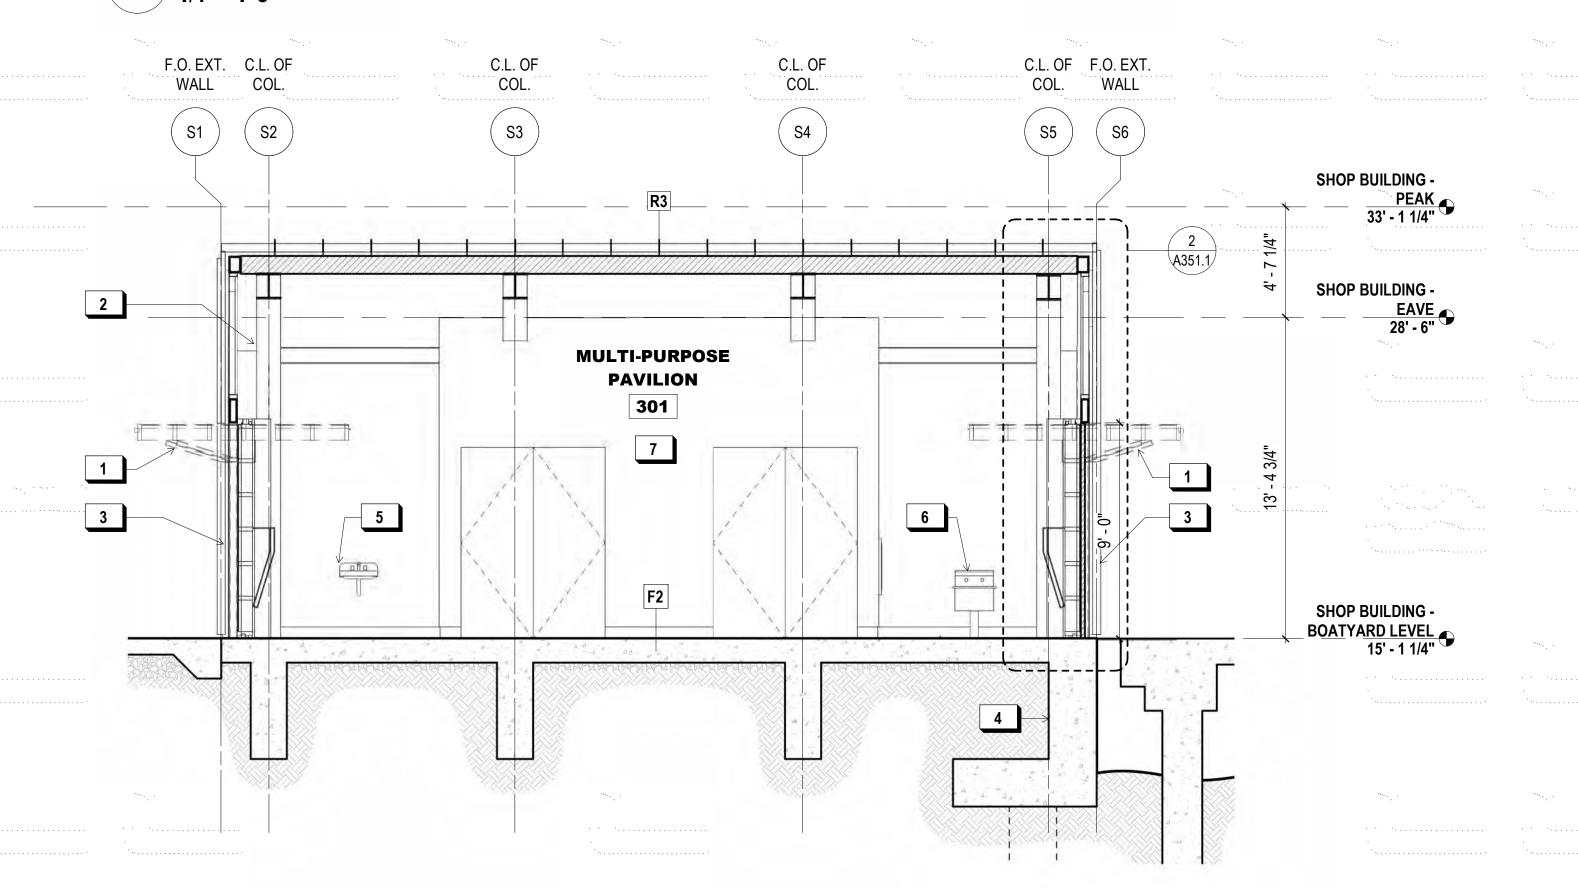
SHOP BUILDING - RCP

A330.1





N-S SECTION AT SHOP



E-W SECTION AT SHOP 1/4" = 1'-0"

1. SEE SHEET A811.1 FOR FLOOR AND ROOF ASSEMBLIES.

X KEY NOTES:

SHEET NOTES:

OVERHEAD GARAGE DOOR (OPEN POSITION)

ALUM. STOREFRONT SYSTEM OVERHEAD GARAGE DOOR (CLOSED POSITION)

CONC. RETAINING / SEA WALL, SEE

COASTAL ENG. DWGS. WALL-MTD. SINK, S.P.D.

MOP SINK, S.P.D.

UNCONDITIONED PAVILION, INTENDED FOR USE WITH OVERHEAD SECURITY DOORS IN OPEN POSITION

900 INNES

PARK DEVELOPMENT

CITY AND COUNTY OF SAN FRANCISCO RECREATION AND PARKS DEPARTMENT 30 VAN NESS AVENUE SAN FRANCISCO, CA 94102


PH. 415-831-2700 THE TRUST FOR PUBLIC LAND 101 MONTGOMERY STREET SUITE 900 SAN FRANCISCO, CA 94104

PH. 415-495-4014

PRIME CONSULTANT / LANDSCAPE ARCHITECT GUSTAFSON GUTHRIE NICHOL PH. 206-903-6802 CIVIL ENGINEER SHERWOOD DESIGN ENGINEERS PH. 415-348-9650 ARCHITECT JENSEN ARCHITECTS PH. 415-348-9650 ECOLOGICAL RESTORATION RANA CREEK PH. 831-659-3820 STRUCTURAL ENGINEER JON BRODY STRUCTURAL ENGINEERS PH. 415-296-9494 COASTAL ENGINEER MOFFATT AND NICHOL PH. 925-944-5411 LIGHTING NITEO CALIFORNIA PH. 415-666-2232 MEP & IT INTERFACE ENGINEERING PH. 415-489-7240 GEOTECHNICAL ENGINEER AGS, INC PH. 415-957-9240 SECURITY CONSULTANT

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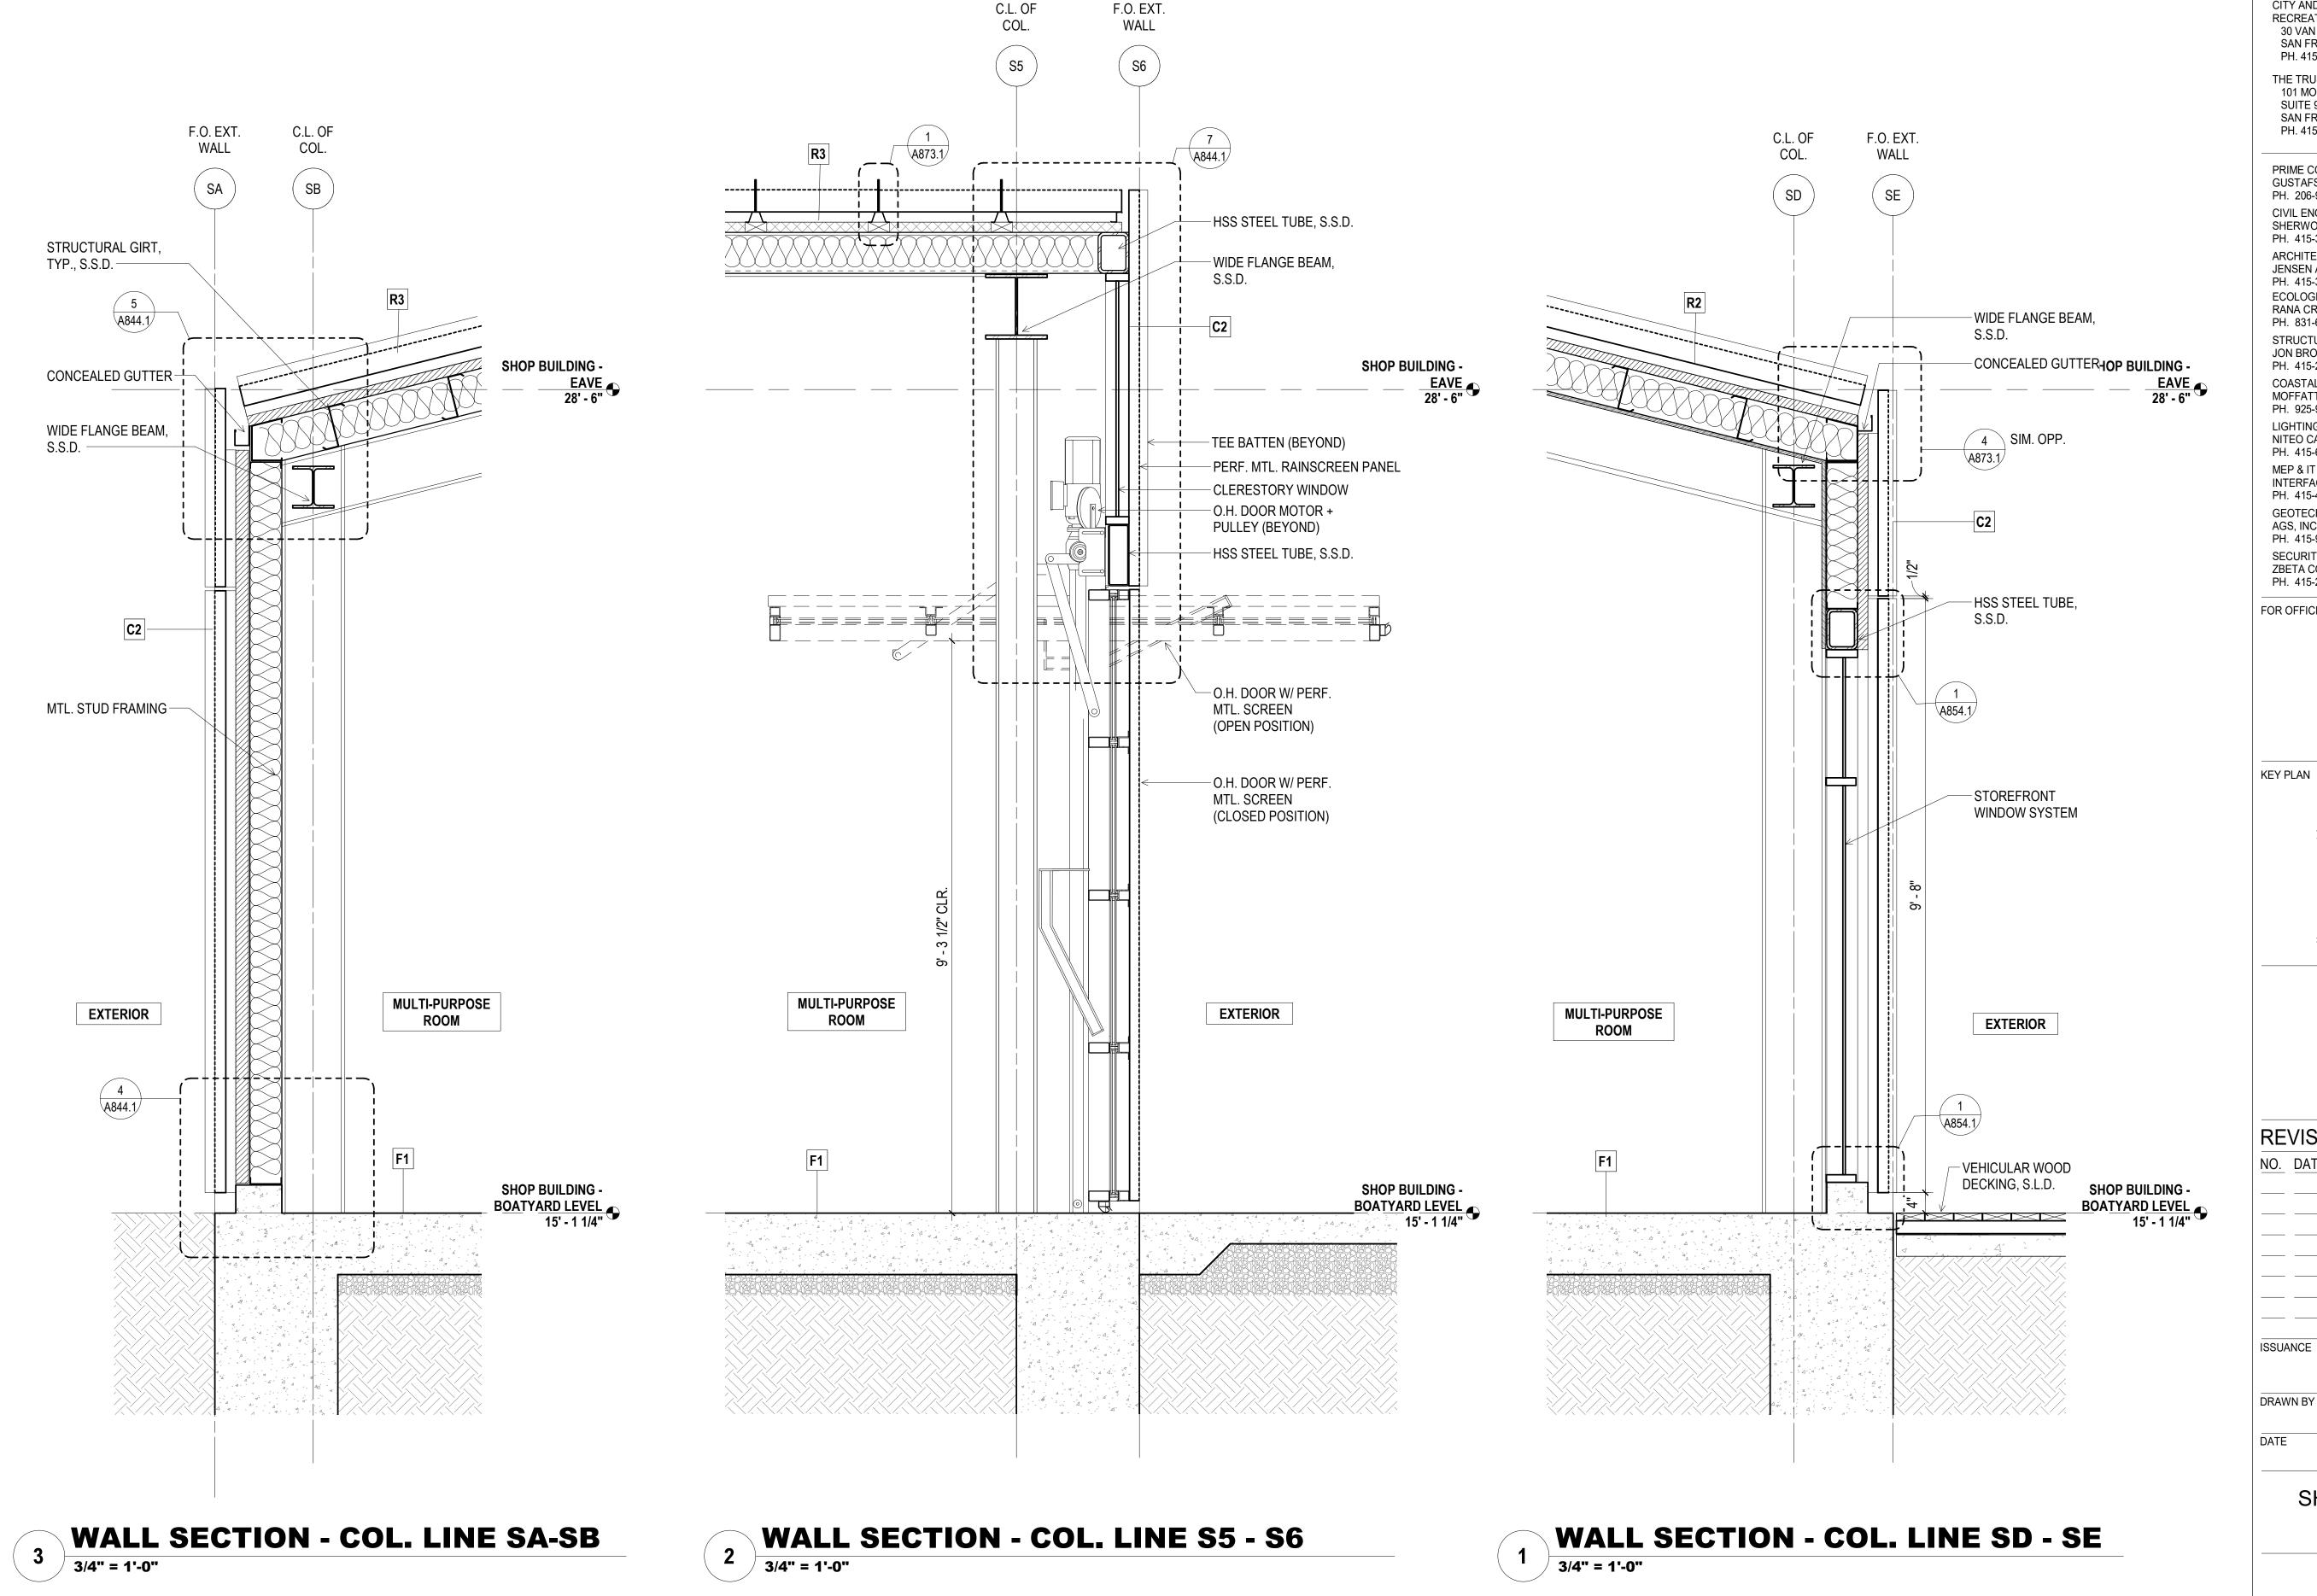
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SHOP BUILDING -SECTIONS

A350.1
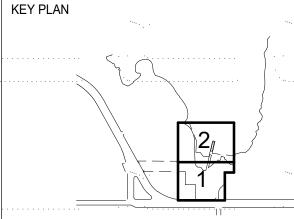
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CITY AND COUNTY OF SAN FRANCISCO RECREATION AND PARKS DEPARTMENT 30 VAN NESS AVENUE SAN FRANCISCO, CA 94102

PH. 415-831-2700

THE TRUST FOR PUBLIC LAND
101 MONTGOMERY STREET
SUITE 900

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KEY PLAN



NO.	DATE	DESCRIPTION

JENSEN


DATE GGN PROJECT #


7/01/2021 1608

SHOP BUILDING - WALL SECTIONS


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A351.1



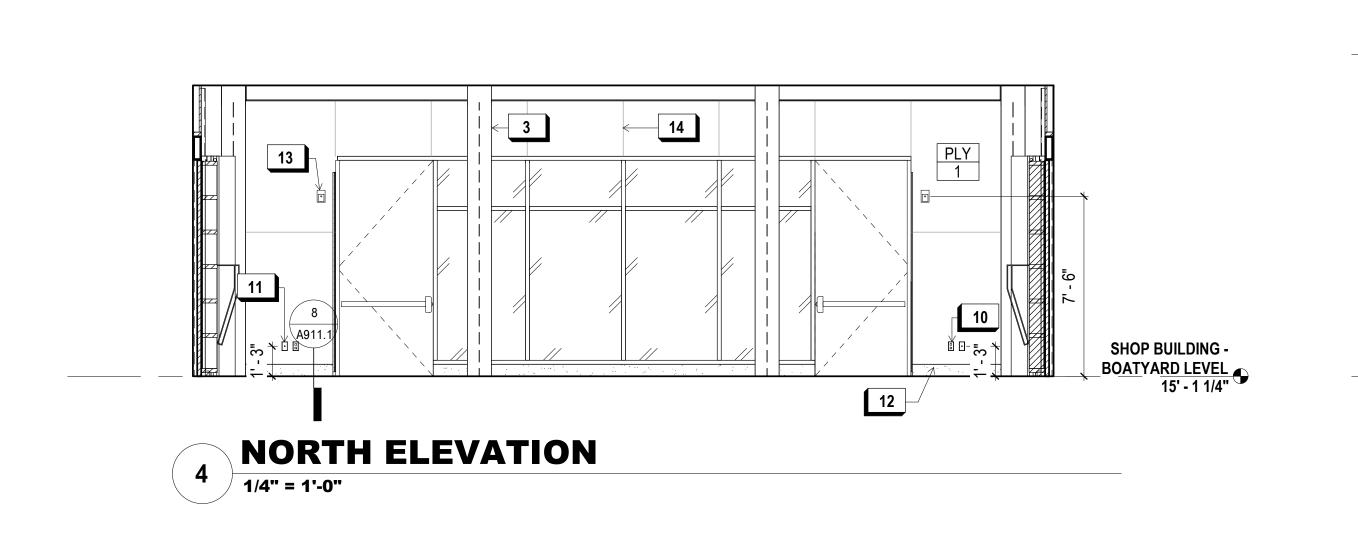

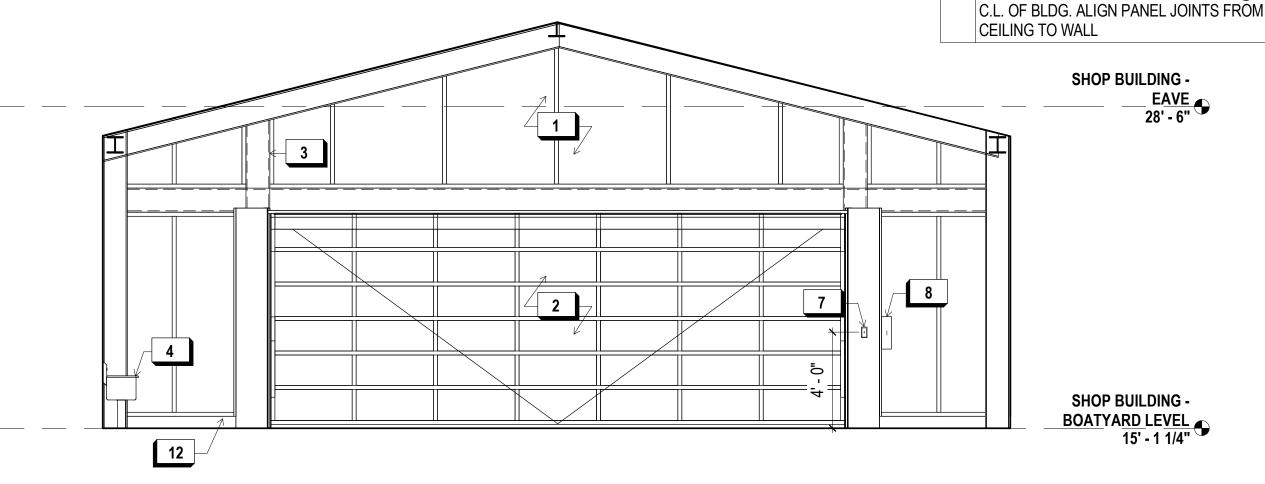SHOP BUILDING
EAVE
28' - 6" 8 SHOP BUILDING -BOATYARD LEVEL 15' - 1 1/4" 12

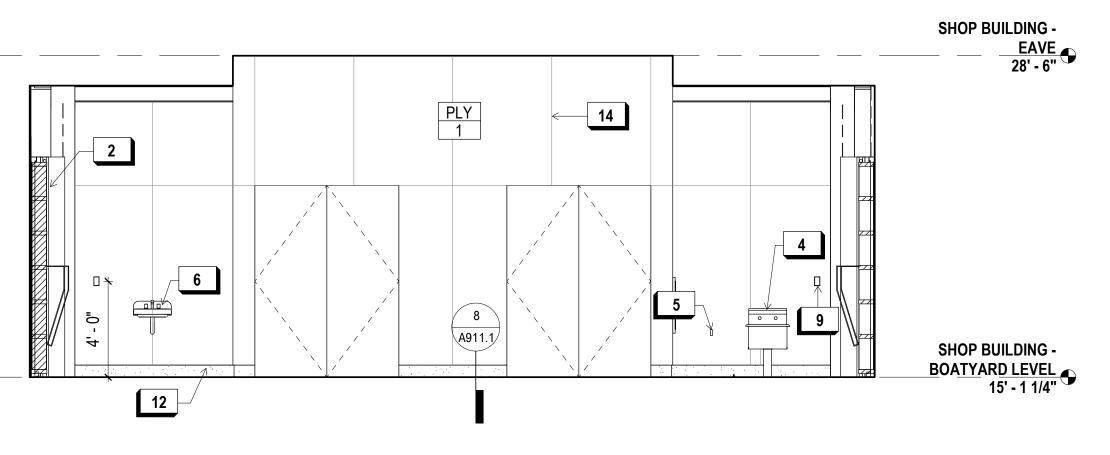

SOUTH ELEVATION
1/4" = 1'-0"

EAST ELEVATION

1/4" = 1'-0"

900 INNES SEE LIGHTING DESIGNER DRAWINGS AND PARK DEVELOPMENT

CITY AND COUNTY OF SAN FRANCISCO RECREATION AND PARKS DEPARTMENT 30 VAN NESS AVENUE

SHEET NOTES:

X KEY NOTES:

MOP SINK

HOSE BIBB

LIGHT SWITCH

11 DATA CONNECTION

12 | CONCRETE CURB

10 WALL OUTLET

ACCESSIBLE SINK

LAYOUT

ELECTRICAL DRAWINGS FOR LIGHTING

2. SEE FINISH FLOOR PLANS OR PROPOSED

FLOOR PLANS FOR FINISH SCHEDULE

3. SEE FINISH FLOOR PLANS OR PROPOSED

FLOOR PLANS FOR FINISH SCHEDULE

ALUM. FRAMED CLERESTORY WINDOW

OVERHEAD DOOR (CLOSED POSITION)

STEEL STRUCT. FRAME- S.S.D.

OVERHEAD DOOR CONTROLLER

13 MOTION DETECTOR, WALL MTD.

OVERHEAD DOOR POWER BOX, S.E.D.

14 PLYWOOD PANEL JOINT, TYP. PROVIDE 48" WIDE PANELS TYP., CENTER MODULE @



SAN FRANCISCO, CA 94102 PH. 415-831-2700 THE TRUST FOR PUBLIC LAND 101 MONTGOMERY STREET SUITE 900 SAN FRANCISCO, CA 94104

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PRIME CONSULTANT / LANDSCAPE ARCHITECT GUSTAFSON GUTHRIE NICHOL PH. 206-903-6802

CIVIL ENGINEER SHERWOOD DESIGN ENGINEERS PH. 415-348-9650

ARCHITECT JENSEN ARCHITECTS PH. 415-348-9650 ECOLOGICAL RESTORATION

RANA CREEK PH. 831-659-3820


STRUCTURAL ENGINEER JON BRODY STRUCTURAL ENGINEERS PH. 415-296-9494 COASTAL ENGINEER MOFFATT AND NICHOL

PH. 925-944-5411 LIGHTING NITEO CALIFORNIA PH. 415-666-2232 MEP & IT

INTERFACE ENGINEERING PH. 415-489-7240 GEOTECHNICAL ENGINEER AGS, INC

PH. 415-957-9240 SECURITY CONSULTANT ZBETA CONSULTING PH. 415-259-0422

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REVISIONS:		
NO.	DATE	DESCRIPTION

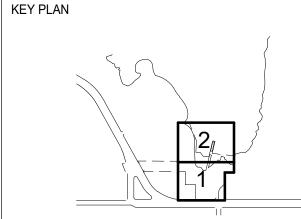BID SET

ISSUANCE

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DRAWN BY GGN PROJECT #

7/01/2021 SHOP BUILDING -

INTERIOR ELEVATIONS

A360.1

2 WEST ELEVATION
1/4" = 1'-0"