

GOLDEN GATE PARK GOLF COURSE CLUBHOUSE

A RECREATION AND PARK COMMISSION PROJECT

95% CD Set November 2020 BUREAU OF ARCHITECTURE



Ron Alameida - City Archite

Julia Laue - Principal Architect / Bureau Manager
49 S Van Ness Ave., Suite 1100, San Francisco, CA 94103
Phone (628)271-2865

Golden Gate Park Golf Clubhouse

970 47th Avenue San Francisco, CA 94121

Consultant

Bureau Mgr.

Section Mgr.

Technical Mgr.

Vito Vanoni

95% CD 11.16.2020

No. Date Revisions

PM Noah Le
PA Paul DeFrei

S NOTRUCTION

Drawing Title


COVER SHEET

G0.0 Scale: 3" = 1'-0"

Project No.

1804

C:\Users\eharriso\Documents\1804_GGP_GC_CLUBHOUSE_R18_eharriso.rvt 11/2/2020 6:18:43 PM

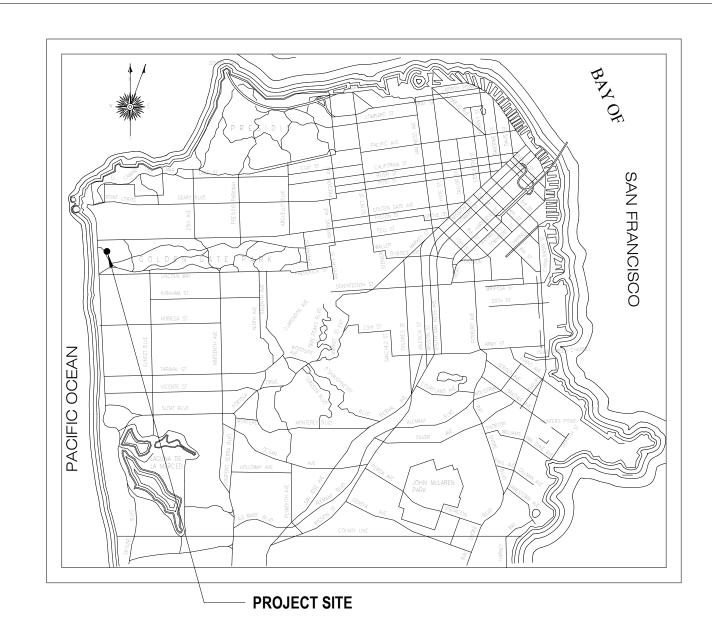

PROJECT DATA

PROJECT NAME:

GOLDEN GATE PARK GOLF CLUBHOUSE

ADDRESS:

970 47TH AVENUE SAN FRANCISCO, CA 94121

OCCUPANCY:

TYPE OF CONSTRUCTION: V (NON-SPRINKLERED)

APPLICABLE BUILDING CODES:

2019 CA BUILDING CODE (CBC) WITH SF AMENDMENTS

2019 CA ENERGY CODE WITH SF AMENDMENTS

2019 CA ADMINISTRATIVE CODE (CAC)

2019 CA ELECTRICAL CODE (CEC) WITH SF AMENDMENTS

2019 CA MECHANICAL CODE (CMC) WITH SF AMENDMENTS

2019 CA PLUMBING CODE (CPC) WITH SF AMENDMENTS

2019 CA FIRE CODE (CFC) WITH SF AMENDMENTS

2010 DOJ ADA STANDARDS FOR ACCESSIBLE DESIGN

TOTAL FLOOR AREA:

1560 SF

LOT/BLOCK NO.: 1700/001

AFF ABOVE FINISH FLOOR ACP **ACCESS PANEL** ACC ACCESSIBLE **ACOUS** ACOUSTICAL ACT ACOUSTICAL CEILING TILE ADDL **ADDITIONAL** ADJ ADJUSTABLE **ALTERNATE** AL, ALUM **ALUMINUM** AND ANGLE ANOD **ANODIZED APPROX APPROXIMATE** ARCHITECT, ARCHITECTURAL AREA DRAIN **BITUMINOUS** BLKG **BLOCKING** BD BOARD BOTTOM ВО **BOTTOM OF BLDG** BUILDING CBC CALIF BUILDING CODE CENTERLINE CLR CLEAR CONC CONCRETE CONN CONNECTION CONST, CONS CONSTRUCTION CONT CONTINUOUS CSK COUNTERSUNK DET DETAIL DIA OR DIAM DIAMETER DIAMETER DIM **DIMENSION** DOWN DWG DRAWING EACH EDGE OF SLAB EOS **ELEC** ELECTRICAL ELEVATION. ELEVATOR EL, ELEV **ENCL** ENCLOSED / ENCLOSURE EQ **EQUAL EQMT EQUIPMENT EXISTING** EXP **EXPANSION** FOC FACE OF CONCRETE FOW FACE OF WALL FE FIRE EXTINGISHER FEC FIRE EXTINGISHER CABINET FIX FIXTURE FLG FLOOR, FLOORING FT FOOT, FEET GSM GALVANIZED SHEET METAL GΑ GAUGE, GAGE GLAZING, GLASS GND GROUND GB **GYPSUM BOARD**

HARDWARE HEIGHT HOLLOW METAL HOLLOW STRUCTURAL SECTION **INSIDE DIAMETER** INSUL INSULATION INTERIOR LAMINATE MANUFACTURER MAX MAXIMUM **MECH MECHANICAL** MET, MTI METAL MINIMUM MOUNTED NOT APPLICABLE NOT IN CONTRACT NOT TO SCALE NUMBER ON CENTER OPPOSITE **OUTSIDE DIAMETER** OVER OD **OVERFLOW DRAIN OFCI** OWNER FURNISHED CONTRACTOR INSTALLED PTD PAINTED, PAPER TOWEL DISPENSER **PHMS** PAN HEAD MACHINE SCREW **PERIM** PERIMETER **PLAS** PLASTIC **PLYWD** PLYWOOD POUND, NUMBER POWDER DRIVEN FASTENER PRESSURE TREATED RAD **RADIUS** RWL RAIN WATER LEADER RCP REFLECTED CEILING PLAN RLV REFLECTED LIGHT VALUE **REQD** REQUIRED RD **ROOF DRAIN** SND SANITARY NAPKIN DISPENSER OR DISPOSER SCHEDULE. SCHEDULED SCH, SCHED SECTION SCD SEE CIVIL DRAWINGS SED SEE ELECTRICAL DRAWINGS SLD SEE LANDSCAPE DRAWINGS SMD SEE MECHANICAL DRAWINGS SPD SEE PLUMBING DRAWINGS SSD SEE STRUCTURAL DRAWINGS SAF SELF-ADHESIVE FLASHING SHT SHEET SMS SHEET METAL SCREW SIM SIMILAR SD SOAP DISPENSER SPECIFICATIONS SPRAY APPLIED FIRE RESISTIVE MATERIAL **SFRM**

BUREAU OF ARCHITECTURE



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95% CD

No. Date Revisions

Paul DeFreitas Drawn Checked

11.16.2020

Drawing Title

PROJECT DATA AND **ABBREVIATIONS**

Sheet No.

G0.10

12" = 1'-0"

Project No.

1804

Scale:

DESCRIPTION OF WORK PROJECT DIRECTORY

CONSTRUCTION OF A NEW GOLF CLUBHOUSE BUILDING CONSITING OF A PRO SHOP, BAR, KITCHEN, DINING AREA, OFFICE, AND RESTROOMS. INCLUDES EXCAVATION, SITEWORK, UTILITIES, STRUCTURAL STEEL AND CONCRETE, CARPENTRY, PLUMBING, ELECTRICAL, MECHANICAL.

CLIENT SAN FRANCISCO RECREATION & PARK DEPARTMENT CAPITAL DIVISION

ATTN: NOAH LEVY 49 S VAN NESS AVENUE, STE. 1220 SAN FRANCISCO, CA 94103 P: 628.652-6633 E: NOAH.LEVY@SFGOV.ORG

LANDSCAPE ARCHITECTURE SAN FRANCISCO PUBLIC WORKS **BUILDING DESIGN & CONSTRUCTION** BUREAU OF LANDSCAPE ARCHITECTURE

ATTN: LIZZY HIRSCH 49 S VAN NESS AVENUE, STE. 1000 SAN FRANCISCO, CA P: 628.271.2843 E: LIZZ.HIRSCH@SFDPW.ORG

ARCHITECTURE SAN FRANCISCO PUBLIC WORKS **BUILDING DESIGN & CONSTRUCTION** BUREAU OF ARCHITECTURE

ATTN: PAUL DE FREITAS 49 S VAN NESS AVENUE, STE. 1100 SAN FRANCISCO, CA 94103 P: 628.271.2865

E: PAUL.DEFREITAS@SFDPW.ORG

STRUCTURAL ENGINEER SAN FRANCISCO PUBLIC WORKS INFRASTRUCURE DESIGN & CONSTRUCTION STRUCTURAL SECTION ATTN: FRANK PIRUZMAND

49 S VAN NESS AVENUE, STE. 900 SAN FRANCISCO, CA 94103 P: 628.271.2612

E: FRANK.PIRUZMAND@SFDPW.ORG

SAN FRANCISCO PUBLIC WORKS INFRASTRUCURE DESIGN & CONSTRUCTION MECHANICAL SECTION

ATTN: JAMES NG 49 S VAN NESS AVENUE, STE. 900 SAN FRANCISCO, CA P: 628.271.2730 E: JAMES.NG@SFDPW.ORG

MECHANICAL ENGINEER

SQ

STD

STL

STO

TEMP

TPH

TSCD

UON

VIF

WO

W/O

SS, SST

SQUARE

STANDARD

STORAGE

STEEL

STAINLESS STEEL

TEMPERED, TEMPERATURE

UNLESS OTHERWISE NOTED

WEATHER RESISTIVE BARRIER

TOILET SEAT COVER DISPENSER

TOILET PAPER HOLDER

VERIFY IN FIELD

WHERE OCCCURS

WINDOW

WITHOUT WOOD

> SAN FRANCISCO PUBLIC WORKS INFRASTRUCURE DESIGN & CONSTRUCTION **ELECTRICAL SECTION**

ELECTRICAL ENGINEER

ATTN: EARL GAFFUD 49 S VAN NESS AVENUE, STE. 900 SAN FRANCISCO, CA 94103 P: 628.271.2709 E: EARL.GAFFUD@SFDPW.ORG STRUCTURAL

EXTERIOR ELEVATION

INTERIOR ELEVATION

SHEET NUMBER

SHEET NUMBER

DETAIL CALLOUT

SHEET NUMBER

SECTION CALLOUT

SHEET NUMBER

REVISION

OPTIONAL

CLOUD AROUND REVISION

REVISION NUMBER

PROJECT NORTH

DOOR SYMBOL

WINDOW SYMBOL

ROOM INDENTIFICATION

AND NUMBER

AND NUMBER

(101)

ROOM NAME

101 🚤

LEVEL NAME

10'0"

ELEVATION MARKER

DETAIL IDENTIFICATION

DETAIL IDENTIFICATION

ELEVATION IDENTIFICATION

ELEVATION IDENTIFICATION

BUREAU OF ARCHITECTURE

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970 47th Avenue

Consultant

Phone (628)271-2865 Golden Gate Park Golf Clubhouse

San Francisco, CA 94121

11.16.2020 95% CD Revisions No. Date

Drawn

Paul DeFreitas Checked

Drawing Title

SHEET INDEX AND LEGEND

Sheet No. G0.11

1/4" = 1'-0" Scale: Project No.

1804

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G2.10	LIFE SAFETY/OCCUPANCY LOAD DIAGRAM
G3.11	TOILET ROOM DOOR SIGNAGE
G3.12	DOOR EXIT SIGNAGE
G3.21	TYPICAL ACCESSIBLE DOORS AND GATES
G3.31	ACCESSIBLE DRINKING FOUNTAIN & WALL & FLOOR ACCESSORIES
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L2.0	LAYOUT & MATERIALS PLAN
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L4.0	IRRIGATION PLAN
L4.1	IRRIGATION LEGEND & NOTES
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-	LANDSCAPE CONSTRUCTION DETAILS
-	LANDSCAPE CONSTRUCTION DETAILS
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A5.12 INTERIOR ELEVATIONS - BOH

A6.10 REFLECTED CEILING PLAN

A8.20 EXTERIOR WALL DETAILS

A8.53 EXTERIOR WINDOW DETAILS

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A9.64 CASEWORK STANDARD DETAILS

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A9.10 PARTITION SCHEDULE, PARTITION DETAILS

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A5.13 INTERIOR ELEVATIONS - RESTROOMS

A5.14 INTERIOR ELEVATIONS - ADMIN AND UTILITY

A8.51 EXTERIOR WINDOW AND LOUVER SCHEDULE_WEST NORTH A8.52 EXTERIOR WINDOW AND LOUVER SCHEDULE - EAST SOUTH


S1.1 STRUCTURAL GENERAL NOTES S1.2 STRUCTURAL GENERAL NOTES S1.3 STRUCTURAL GENERAL NOTES S1.4 STRUCTURAL GENERAL NOTES S1.5 STRUCTURAL GENERAL NOTES S1.6 STRUCTURAL TYPICAL CONCRETE DETAILS S1.7 STRUCTURAL TYPICAL CONCRETE DETAILS S1.8 STRUCTURAL TYPICAL WOOD DETAILS STRUCTURAL TYPICAL WOOD DETAILS STRUCTURAL TYPICAL WOOD DETAILS FOUNDATION AND FLOOR PLAN **ROOF PLAN** EAST ELEVATION NORTH ELEVATION WEST ELEVATION S4.4 SOUTH ELEVATION **MECHANICAL** M0.01 MECHANICAL ABBREVIATIONS, SYMBOLS, AND LEGEND M0.02 MECHANICALGENERAL NOTES M0.90 MECHANICAL EQUIPMENT SCHEDULES M2.10 MECHANICAL FLOOR PLAN - DUCTWORK M2.11 MECHANICAL FLOOR PLAN - REFRIGERANT PIPING MECHANICAL SECTIONS I M3.02 MECHANICAL SETIONS II M4.01 VRF DIAGRAMS P0.01 PLUMBING ABBREVIATIONS, SYMBOLS, AND LEGEND P0.02 PLUMBING GENERAL NOTES P0.90 PLUMBING EQUIPMENT SCHEDULE P2.10 PLUMBING FLOOR PLAN - DOMESTIC WATER P2.11 PLUMBING FLOOR PLAN - WASTE & VENT P2.12 PLUMBING ROOF PLAN P4.01 DOMESTIC HOT WATER PIPING DIAGRAM ELECTRICAL LEGEND, GENERAL NOTES, ABBREVIATIONS & DRAWING LIST SINGLE LINE DIAGRAM SCHEDULES ELECTRICAL SITE PLAN LIGHTING PLAN POWER PLAN

> - ROOM NAME - ROOM NUMBER **GRID LINE IDENTIFICATION PARTITION TYPE** STUD SIZE WHERE APPLIES

PARTITION CONFIGURATION FIRE RATING, IN HOURS,

KEY NOTE

(FD) **FLOOR DRAIN**

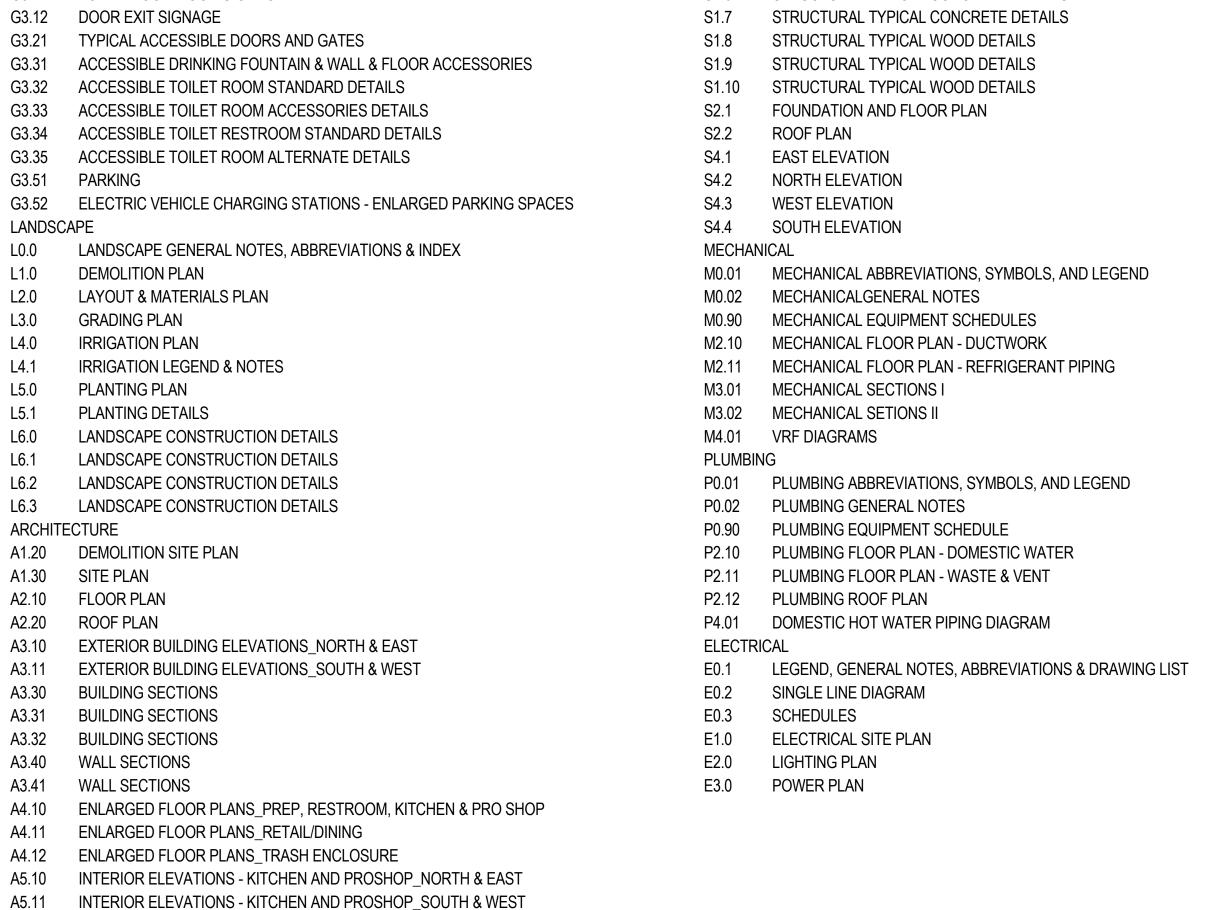

Ramps elevators, lifts At least one accessible restroom for each sex or a single unisex restroom_serving the area of remodel. pay phone. Accessible drinking fountains. Additional accessible elements such as parking, stairways, storage, alarms and signage. See the requirements 3. for additional forms listed below No additional forms required Fill out Request for Approval of Equivalent Facilitation form for each item checked and attach to plan. Fill out Request for Approval of Technical Infeasibility form for each item checked and attach to plans. Provide details from a set of City approved reference drawings, provide its permit application number and list reference drawing number on plans. No additional forms required Fill out Request for an Unreasonable Hardship form for each item checked and attach to plan. All UHR must be ratified by the Access Appeals Commission (see UHR form for details)

D.A. CHECKLIST (p. 2 of 2): The address of the project is :_

Note: upgrades below are listed in priority based on

A. One accessible

entrance including:

access, platform

and hardware for

door/gate

including:

approach walk, vertical

(landings), door / gate

An accessible route to

Parking/access aisles

the area of remodel

Curb ramps and

Corridors, hallways,

Check all applicable boxes and specify where on the drawings the details are shown:

comments can be writter

DISABILITY ACCESS COMPLIANCE FOR CITY PROJECTS Applicants to fill in project name + address before scanning this form onto their plans. For Alterations, add SF DBI – DA-02 checklist & form(s) as applicable PUBLIC **WORKS** London N. Breed Mayor Leave Area Below Blank - for PW BDC Disability Access Coordinator (DAC) Staff Use **Alaric Degrafinried Acting Director** DESIGN PHASE: Public Works Building Design and Construction DAC has reviewed & approved: Julia Laue, AIA LEED AP ☐ Pre-application meeting(s) / site permit review Principal Architect ☐ SF DBI DA-02 Checklist / Technical Infeasibility Request forms & Bureau Manager ☐ Playground ADA Inventory form Arfaraz Khambatta, CASp ☐ Accessible Means of Egress plans Disability Access Coordinator ☐ Elements exempt from accessibility requirements, per 11B-203 ☐ Exempt HVAC, reroofing, electrical or cosmetic work *only*, not affecting accessibility elements ☐ FINAL CONSTRUCTION PLANS FOR PERMIT APPLICATIONS **Building Design and** Construction 30 Van Ness Ave. Ste. #4100 CONSTRUCTION PHASE: The following inspections, if selected, are required: San Francisco, CA 94102 Call 415-557-4676 to schedule inspection(s). (415) 557-4676 Arfaraz.Khambatta@sfdpw.org ROUGH FRAMING, after plumbing & electrical rough-in is complete, prior to cover ☐ BRAILLE / TACTILE SIGNAGE, including proofs and color samples prior to fabrication ☐ Door opening force and closing speed (after final air balance, if applicable) ☐ Power door operator testing and signage per BHMA A156.19 ☐ Play Area equipment, use zones and accessible routes Off-site curb ramps, blue zone parking spaces and passenger loading zones ☐ INSPECTION AT 95% ~ 98% COMPLETE, but prior to or as-needed for T.C.O. ☐ FINAL INSPECTION ON PROJECT, sign-off on SF-DBI Job Card, if applicable

Arfaraz Khambatta, CASp Public Works, BDC Disability Access Coordinator

ACCESSIBILITY COMPLIANCE LETTER

BUREAU OF ARCHITECTURE



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Julia Laue - Principal Architect / Bureau Manager 49 S Van Ness Ave., Suite 1100, San Francisco, CA 94103 Phone (628)271-2865

Golden Gate Park Golf Clubhouse

970 47th Avenue San Francisco, CA 94121

Consultant

TECHNICAL INFEASIBILITY REQUEST

CITY AND COUNTY OF SAN FRANCISCO DEPARTMENT OF BUILDING INSPECTION

Applicant's Signature:___

Applicant's Address:

Applicant's Phone: ____

of the following factors:

The cost of providing access.

The cost of all construction contemplated.

The impact of proposed improvements on financial feasibility of the project.

4. The nature of the accessibility which would be gained or lost.

Department. All Unreasonable Hardships shall be ratified by the AAC.



London N. Breed, Mayor Tom C. Hui, S.E., C.B.O., Director

Agent

APPROVAL OF TECHNICAL INFEASIBILITY REQUEST

Unreasonable Hardship. When the enforcing agency finds that compliance with the building standard would

5. The nature of the use of the facility under construction and its availability to persons with disabilities

The details of any Technical Infeasibility or Unreasonable Hardship shall be recorded and entered into the files of the

make the specific work of the project affected by the building standard infeasible, based on an overall evaluation

To be used where it is technically infeasible to meet the prescriptive requirements of the code within the scope of work of an alteration or within an existing path of travel to the area of work of an alteration or addition. as per CBC section 11B-202.3

1.	Site Address:	2.	Floor:				
3.	Permit Application No.:	4.	4. Request No.:				
5.	Existing Use:	6.	Proposed Use:				
7.	Existing Occupancy:	8.	Proposed Occupancy:				
9.	Description of proposed alteration element or path of	travel up	ograde for which technical infeasibility approval is requested:				
infe Cha	easible, the alteration shall provide equivalent facilitation apter 2, section 202; <i>Technically Infeasible</i> This alteration is technically Infeasible due to:	n or com	determines compliance with applicable requirements is technically apply with the requirements to the maximum extent feasible. See CBC and maximum extent feasible are CBC and maximum extent feasible.				
11.	Detailed description of the technical infeasibility. (provi	ide detai	ils, documents and drawings if required or requested by staff)				
12.	. Compliance with the regulations will be provided t	to the m	aximum extent feasible; (give description)				
	(For the re-use of this form.) I have verified that the ab possible. Applicant initials and date		ed compliance is still in effect and is the maximum degree of complian				

Applicants Email: _

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APPROVAL OF TECHNICAL INFEASIBILITY REQUEST (page 2)

BUILDING INSPECTION STAFF USE ONLY
al infeasibility request is: THIS PERMIT ONLY) DENIED
Date:

If your Request for Approval of Technical Infeasibility has been denied, the plans examiner shall inform you of the reasons for denying that request. In addition, the plans examiner's group supervisor shall provide you with a second opinion regarding

If your Request for Approval of Technical Infeasibility has been denied, you may file an appeal with the Access Appeals Commission. Please refer to the Access Appeals Commission Information Guide, available at the Customer Services desk, for complete information on this process.

Please submit appeals in person to:

Secretary, Access Appeals Commission 1660 Mission Street, 3rd Floor San Francisco, CA 94103 (415) 558-6110

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No. Date Revisions Drawn Checked

11.16.2020

Drawing Title

ADA COMPLIANCE CHECKLIST **COMPLIANCE MEASURES**

et No.		G1.10
	Scale:	12" = 1'-0"

1804

Project No.

GS6: San Francisco Green Building Submittal Form for Municipal Projects Form version: October 10, 2017 (For permit applications January 2017 - December 2019) INSTRUCTIONS: MUNICIPAL REFERENCES VERIFICATION 1. Select one (1) column to the right. CHECK THE ONE COLUMN 2. For each requirement in the column, indicate evidence of fulfillment in the References column. THAT BEST DESCRIBES YOUR PROJECT 3. Fill out the project information in the Verification box at the right. COMMERCIAL 4. Attach LEED Scorecard on separate, subsequent sheet. PROJECT NAME *This form includes the requirements of San Francisco Green CONSTRUCTION PROJECTS INTERIORS 5. Submittal must be a minimum of 24" x 36". Building Code and Environment Code Chapter 7. Major & MAJOR Renovations as defined by Environment Code Chapter RENOVATION* 7 also include Major Alterations as defined by SFGBC, BLOCK/LOT 10,000 sq.ft. DRAWING OR SPECIFICATION # 10,000 sq.ft. 10,000 sq.ft. (If not applicable, indicate "N/A". or any not meeting or greater or greater DESCRIPTION OF REQUIREMENT LÉED MPR's **ADDRESS** GOLD (60+) CERTIFIED Required LEED Certification Level Environment Code sec.705 Project is required to achieve sustainability certification listed at right. CERTIFIED, LEÉD CI LEED Point Adjustment for PRIMARY OCCUPANCY SFGBC 5.104 Retention/Demolition of Enter any applicable point adjustments in box at right. Historic Features/Building LEED Points shown Enter current expected LEED score in box at right. BUILDING GROSS FLOOR AREA on Current Scorecard LEED Scorecard Submittals Submit LEED Scorecard to Municipal Green Building Task Force at 100% Concept Design and As-Built (LEED Online is acceptable means of submittal). LEED PROJECTS for projects ≥10,000 sq.ft., use products that comply with LEED emissions & content requirements for paints, coatings, adhesives, sealants, flooring, composite wood, ceiling/wall/thermal/acoustic insulation, Code sec.706 furniture if part of scope, and exterior applied products if healthcare or school project. Projects ≥10,000 square feet LOW-EMITTING MATERIALS LEED EQc2 (3 pts) LEED EQc2 (3 pts) 5. 504.4.1-6 CALGreen 5.504.4.1-6 For projects <10,000 sq.ft., use products that comply with the emission limit requirements of 5.504.4.1-6 for adhesives, sealants, paints, coatings, carpet systems including cushions and adhesives, resilient understand Environment Code Chapter7 flooring (80% of area), and composite wood products. equires all applicable projects ≥10,000 square eet to attain LEED Gold certification from PVC ELIMINATION Environment Code sec.509 Specify no materials containing PVC ISGBC/GBCI. No Green Building Compliance Professional of Record is required. LEAD ELIMINATION Environment Code sec.711 Specify no materials containing lead. Environment Code ch.8 Specify no tropical hardwoods or virgin redwoods PROJECT MANAGER (name) VIRGIN REDWOOD BAN Meet flush/flow requirements for: toilets (1.28gpf); urinals (0.125gpf wall, 0.5gpf floor); showerheads (2.0gpm); lavatories (1.2gpm private, 0.5gpm public/common); kitchen faucets (1.8gpm); wash fountains 1.8gpm); metering faucets (0.2gpc); food waste disposers (1gpm/8gpm) INDOOR WATER USE LEED WEp2 Environment 5.303.3 LEED WEc2 (2 pts) REDUCTION Code sec.706, LEED WEc2 (4 pts) Additionally, for projects ≥10,000 sq.ft., use minimum 30% less potable water as calculated using a baseline with toilets (1.6gpf); urinals (1.0gpf); showerheads (2.5gpm); lavatories (2.2gpm private, 0.5gpm PROJECT MANAGER (sign & date) CALGreen 5.303.3 public); kitchen faucets (2.2gpm). NON-POTABLE WATER REUSE Health Code art.12C New buildings ≥40,000 sq.ft. must calculate a water budget. New buildings ≥250,000 sq.ft. must treat and use available rainwater, graywater, and foundation drainage for toilet and urinal flushing and irrigation. PROJECT MANAGER AGENCY New construction projects with aggregated landscape area ≥500 sq.ft., or existing projects with modified landscape area ≥1,000 sq.ft., shall use low water use plants or climate appropriate plants, restrict turf WATER-EFFICIENT IRRIGATION Administrative Code ch.63 areas and comply with Model Water Efficient Landscape Ordinance restrictions by calculated ETAF ≤ .45 or by prescriptive compliance for projects with ≤2,500 sq.ft. of landscape area. NON-LEED PROJECTS WATER METERING CALGreen 5.303.1 For area of project, provide submeters for spaces projected to consume >1,000gal/day (or >100gal/day in buildings >50,000 sq.ft.) Projects <10,000 square feet, Comply with all provisions of the CA Energy Code. receiving a waiver, or not Environment For projects ≥10,000 sq.ft., produce a whole-building energy simulation, or follow ASHRAE 50% Advanced Design Guide, or follow Advanced Building Core Performance Guide. Achieve energy use below **ENERGY EFFICIENCY** LEED EAp2 LEED EAp2 Code sec.706, meeting LEED MPR's established baseline by 5% for New Construction, 3% for Major Renovations, 2% for Core & Shell, 3% for Commercial Interiors. Commercial Interiors alternate compliance – reduce lighting power density by 5% CA Energy Code below ASHRAE 90.1-2010 and install ENERGY STAR equipment for 50% of all eligible ENERGY STAR equipment. his project is not required to obtain LEED ertification because it is <10,000 square ZERO NET ENERGY TARGET Environment Code sec. 706 Set target for annual energy consumption. Reporting required to Municipal Green Building Task Force. See Enviornment Regulations for guidance, tools and methods eet, does not meet LEED Minimum Program lequirements, and/or received a waiver from Determine feasibility to achieve Zero Net Energy (≤3 stories). Reporting required to Municipal Green Building Task Force. See Enviornment Regulations for guidance, tools and methods. ZERO NET ENERGY FEASIBILITY Environment Code sec.706 n/r nvironment Code Chapter 7 from the Director Department of Environment. An informational Analyze Benefit/Cost Analysis for solar plus battery storage for defined building types. Reporting required to Municipal Green Building Task Force. See Enviornment Regulations for guidance, tools and methods EED scorecard will be submitted to the Environment Code sec. 706 BENEFIT/COST ANALYSIS Aunicipal Green Building Task Force at 100% concept design and as-built without requirement Planning Code sec.149, SFGBC div.5.2 New buildings with ≤10 floors must designate 15% of roof Solar Ready, per Title 24 rules. Install photovoltaics or solar hot water systems in this area. With Planning Department approval, projects subject to SFPUC f new construction BETTER ROOFS or further LEED documentation or certification Stormwater Requirements may substitute living roof for solar energy systems. ≥2,000 sq.ft. New buildings ≥11 floors must acquire renewable onsite energy or achieve 5 points under LEED credit Optimize Energy Performance (EAc2) RENEWABLE ENERGY SFGBC 5.201.1.3 PROJECT MANAGER (name) For projects ≥10,000 sq.ft., comply with LEED Cx requirements – OPR, BOD, systems testing, operations manual, and Enhanced and Monitoring-Based Commissioning. Code sec.706 COMMISSIONING (Cx) .410.2-5.410.4.5.1 LEED EAc1 (3+ pts) | LEED EAc1 (4+ pts) For projects <10,000 sq.ft. and all new equipment in alterations & additions, comply with 5.410.2-5.410.4.5.1 – test and adjust all equipment. CALGreen 5.410.2-5.410.4.5.1 PROJECT MANAGER (sign & date) Planning Code sec.155.1-3. CAL Green 5.106.4 BICYCLE PARKING Provide short- and long-term bike parking equal to 5% of motorized vehicle parking, or meet SF Planning Code sec.155.1-3, whichever is greater. 5.106.4 PROJECT MANAGER AGENCY DESIGNATED PARKING CALGreen 5.106.5.2 f >10 total stalls added, comply with Table 5.106.5.2 (approx. 8% of total spaces). WIRING FOR EV CHARGING CALGreen 5.106.5.3 Install electrical systems to provide electricity for EV chargers at 6% of spaces or per 5.106.5.3 (installation of chargers is not required.) Green Building Compliance construction construction Professional of Record Environment have been retained by the project sponsor RECYCLING BY OCCUPANTS Provide adequate space and equal access for storage, collection and loading of compostable, recyclable and landfill materials. review all submittal documents and verify hat all approved construction document and construction fulfill the requirements of the LEED MRp2, LEED MRc5 **CONSTRUCTION & DEMOLITION Environment Code** Divert a minimum of 75% of total C&D debris including at least 4 material streams. For 100% of mixed C&D debris use registered transporters and registered processing facilities. 75% diversion San Francisco Green Building Code. It is my (C&D) WASTE MANAGEMENT sec.706, sec.708 & ch.14 professional opinion that the requirement of the San Francisco Green Building Cod vill be met. I will notify the Department Building Inspection if the project will, for any REFRIGERANT MANAGEMENT CALGreen 5.508.1 Use no halons or CFCs in HVAC. reason, not substantially comply with these equirements, if I am no longer the Gree Building Compliance Professional of Recor CA Energy Code, CALGreen 5.106.8 or the project, or if I am otherwise no longer LIGHT POLLUTION REDUCTION Comply with CA Energy Code for Lighting Zones 1-4. Comply with 5.106.8 for Backlight/Uplight/Glare. construction construction esponsible for assuring the compliance of the roject with the San Francisco Green Building BIRD-SAFE BUILDINGS Planning Code sec.139 Glass facades and bird hazards facing and/or near Urban Bird Refuges may need to treat their glass for opacity. Health Code art.19F & art.19 CALGreen 5.504.7 TOBACCO SMOKE CONTROL Prohibit smoking within 25 feet of building entries, air intakes, and operable windows LICENSED PROFESSIONAL Public Works Code rojects disturbing ≥5,000 sq.ft. in combined or separate sewer areas, or replacing ≥2,500 impervious sq.ft. in separate sewer area, must implement a Stormwater Control Plan meeting SFPUC Stormwater STORMWATER CONTROL PLAN if applicable if applicable if applicable (sign & date) art.4.2 sec.147 **AFFIX STAMP BELOW:** Public Works Code if project disturbs f project disturbs if project disturbs CONSTRUCTION SITE RUNOFF Submit a construction site Erosion and Sedimentation Control Plan to SFPUC for approval. ≥5,000 sq.ft. art.4.2 sec.146 ≥5,000 sq.ft. ≥5,000 sq.ft. limited to envelope ACOUSTICAL CONTROL CALGreen 5.507.4.1-3 Comply with sound transmission limits (STC-50 exteriors near freeways/airports; STC-45 exteriors if 65db Leq at any time; STC-40 interior walls/floor-ceilings between tenants). alterations & additions CALGreen 5.504.1-3 Seal permanent HVAC ducts/equipment stored onsite before installation. (CONSTRUCTION) AIR FILTRATION CALGreen 5.504.5.3 Provide MERV-8 filters on HVAC for regularly occupied, actively ventilated spaces. (OPERATIONS) ENHANCED IAQ STRATEGIES Environment Code sec. 706 LEED EQc1 (1 pt) LEED EQc1 (1 pt) Comply with entry, cross-contamination, filtration, natural ventilation, mixed-mode requirements. CONSTRUCTION IAQ Environment Code sec.706 During construction, meet SMACNA IAQ guidelines; provide MERV-8 filters on all HVAC. LEED EQc3 LEED EQc3 n/r MANAGEMENT PLAN LEED EQc4 (2 pts) IAQ ASSESSMENT Environment Code sec.706 Before occupancy, test air quality for particulates, ozone, CO, and all listed VOCs. LEED EQc4 (2 pts)

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Consultant

11.16.2020

Revisions

Drawn

Checked


Drawing Title

GREEN BUILDING FORMS

G1.20

Project No.

Scale:

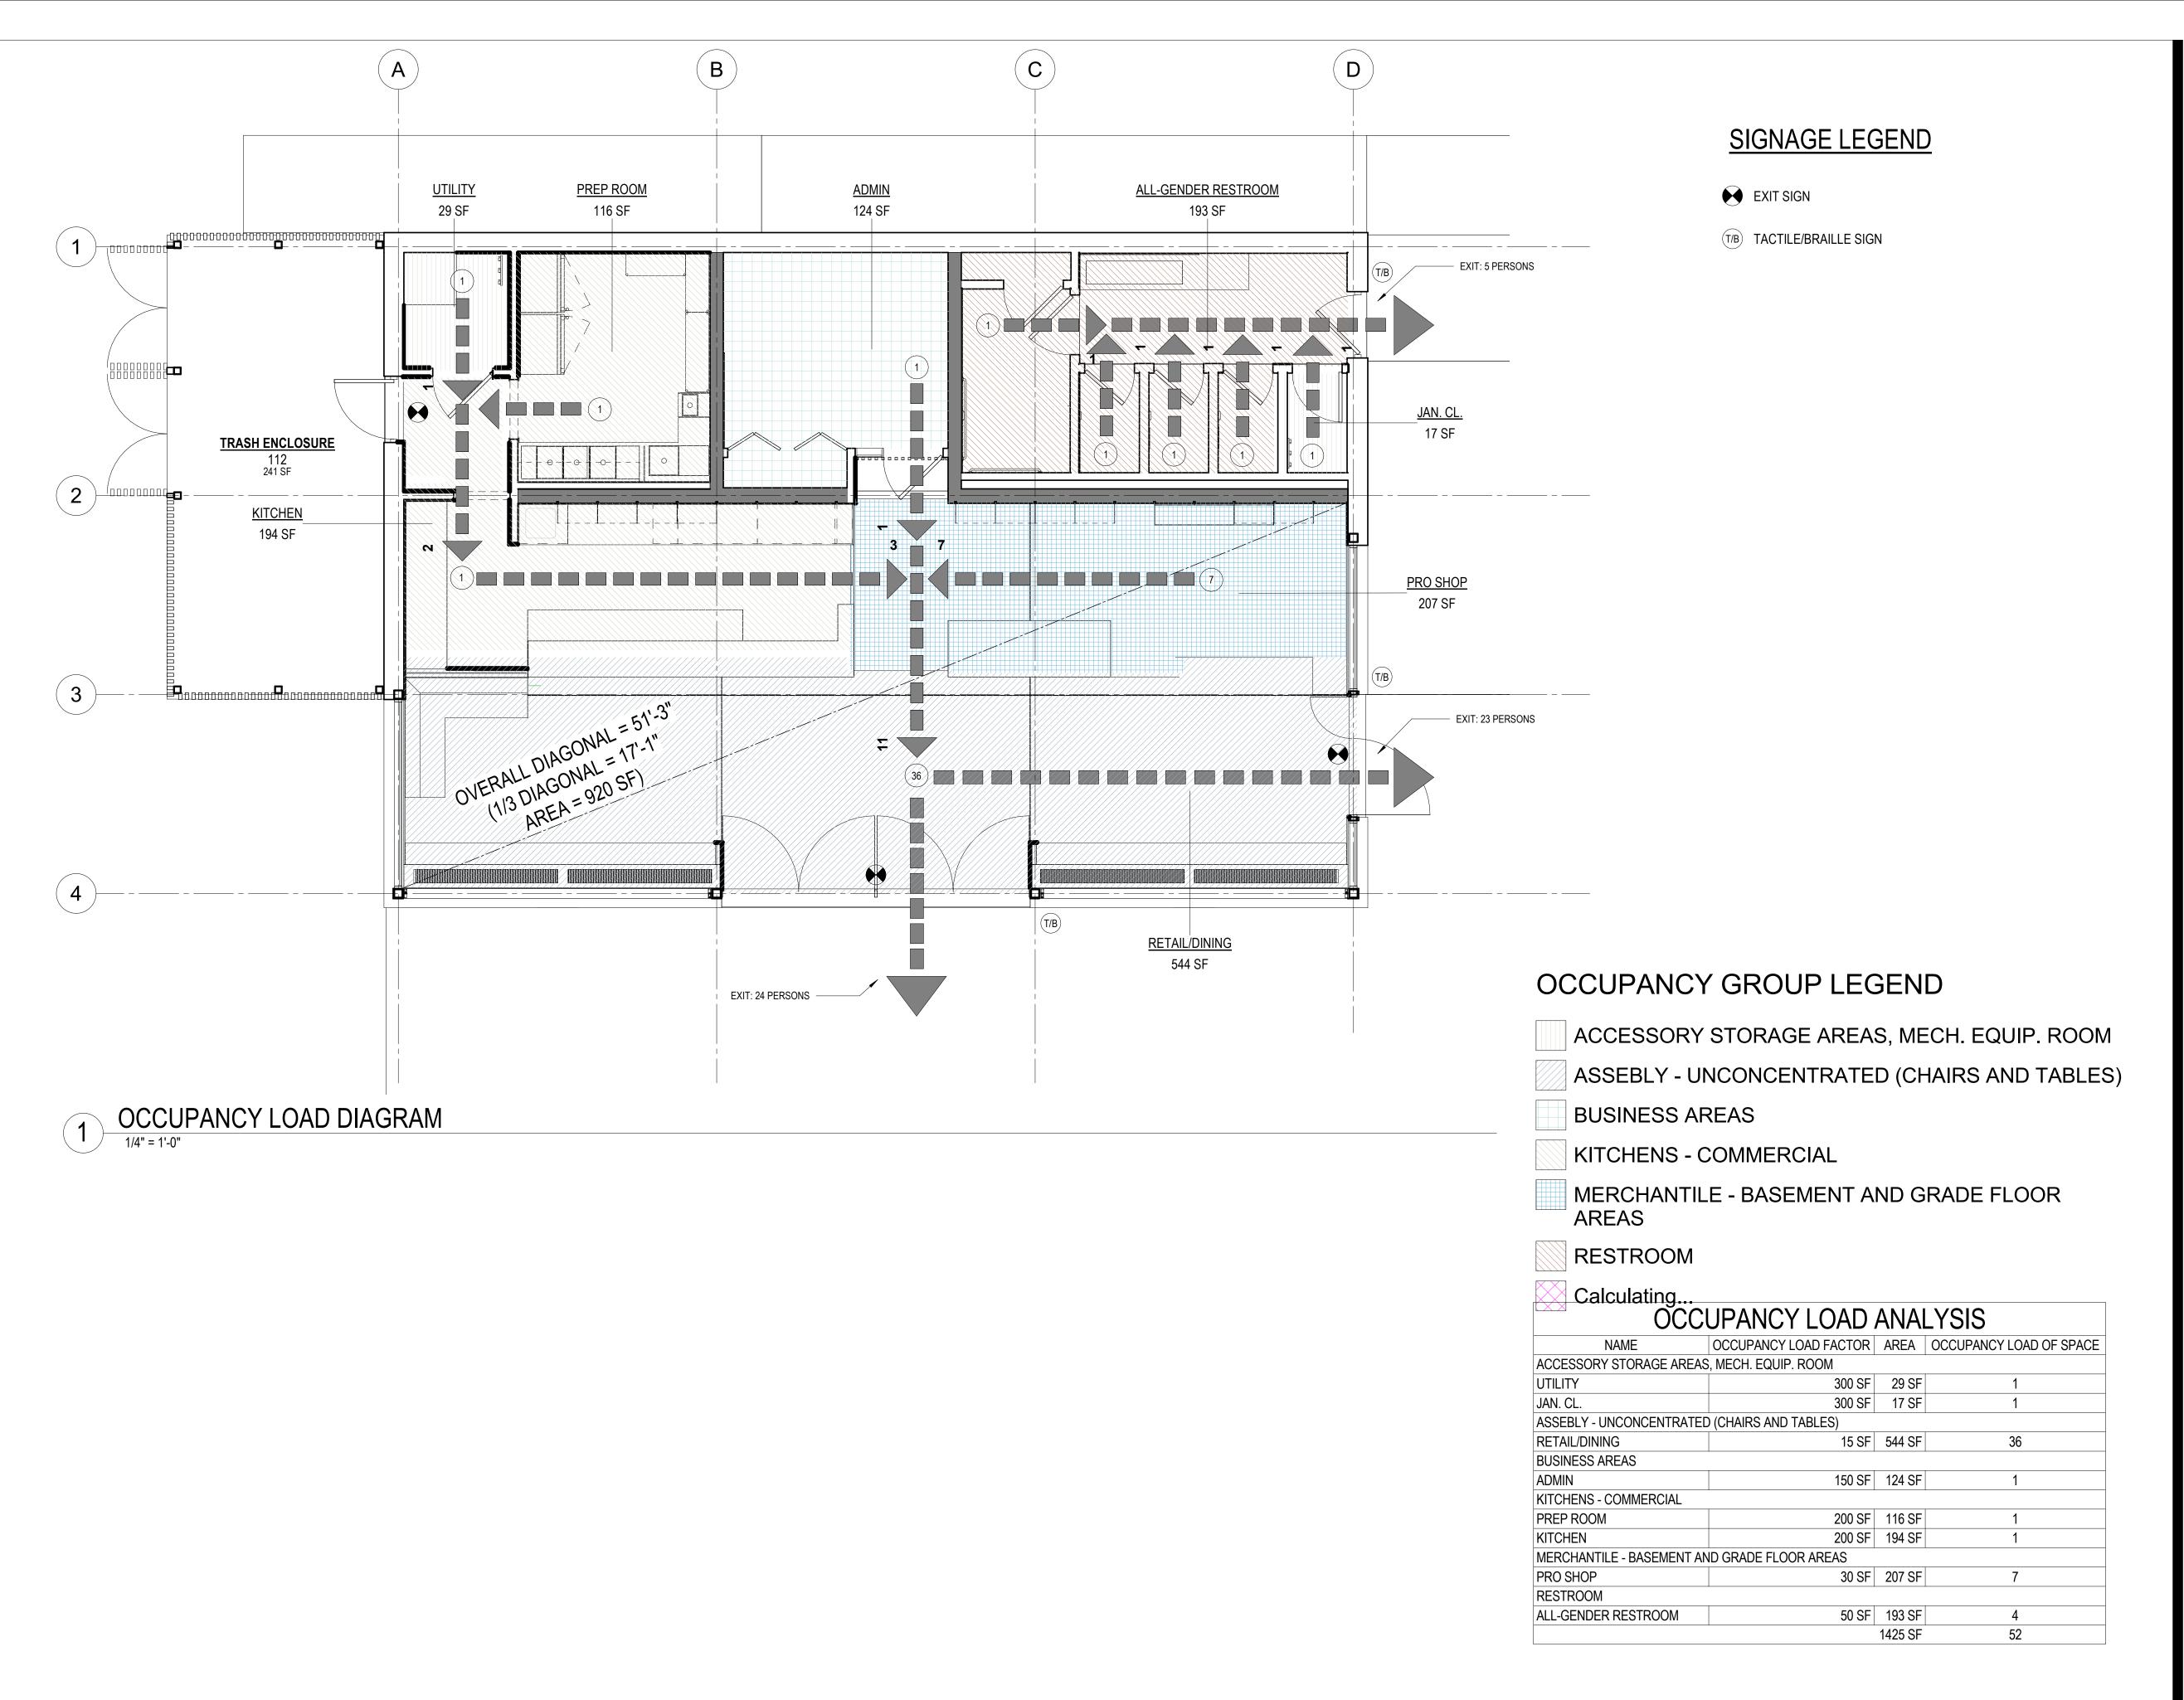

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95% CD

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Drawing Title

LIFE SAFETY/OCCUPANCY LOAD DIAGRAM

Sheet No.

G2.10

As indicated

Project No.



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No. Date Revisions

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Checked

Drawing Title

ACCESSIBILITY DIAGRAMS


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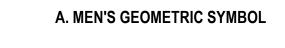
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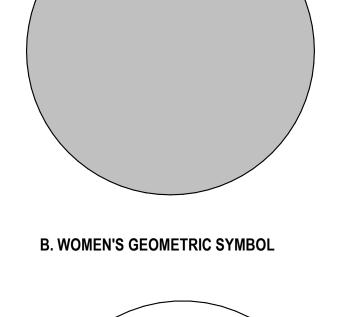
1/8" RADIUS TYP. -(1)(3)(5)


RESTROOM SIGNAGE


A. MEN'S GEOMETRIC SYMBOL






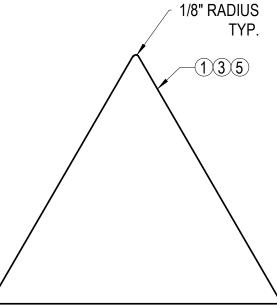

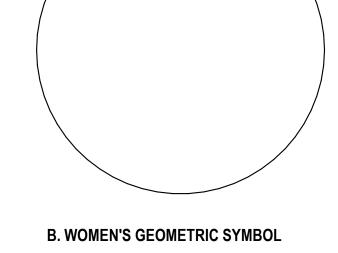

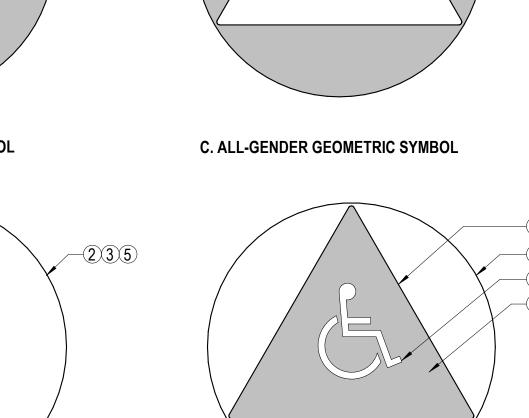

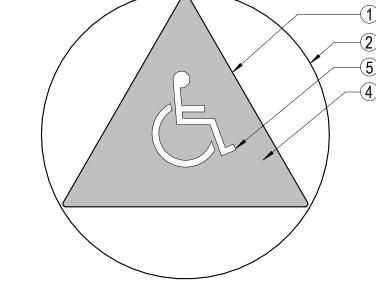

C. ALL-GENDER GEOMETRIC SYMBOL

NOTES FOR LIGHT OR DARK COLORED DOORS OR WALLS:

- TRIANGULAR SIGN MATERIAL SHALL BE 1/4" THICK WITH POLISHED AND EASED EDGES. ADHERE SIGN TO DOOR WITH NON-STAINING SILICONE SEALANT AND FOAM TAPE WITHOUT ANY MECHANICAL FASTENERS, UON. SEE SIGNAGE SCHEDULE FOR MATERIALS.
- CIRCULAR SIGN MATERIAL SHALL BE 1/4" THICK WITH POLISHED AND EASED EDGES. ADHERE SIGN TO DOOR WITH NON-STAINING SILICONE SEALANT AND FOAM TAPE WITHOUT ANY MECHANICAL FASTENERS, UON. SEE SIGNAGE SCHEDULE FOR MATERIALS.
- SIGN SHALL BE LIGHT ON DARK OR DARK ON LIGHT BACKGROUND COLOR WITH ADJACENT DOOR, SIGN SURFACES, OR WALL. ALL SIGNAGE FINISHES SHALL BE NON-GLARE MATTE OR EGGSHELL
- ALL GENDER SIGN SHALL BE A 1/4" THICK TRIANGULAR SHEET (A) SECURED ON TOP OF CIRCULAR SHEET (B) WITH DOUBLE-SIDED SHEET TAPE. UON, COLOR SHALL BE LIGHT ON DARK OR DARK ON LIGHT AND THE CIRCLE SHALL CONTRAST PER NOTE C.
- PROVIDE ISA SYMBOL ON SIGNS AT ACCESSIBLE ALL-GENDER TOILET ROOMS.

RESTROOM DOOR GEOMETRIC SYMBOL 3" = 1'-0" DAC APPROVED R06 2019.08.01

BABY CHANGE SIGNS DAC CUSTOM 2019.08.01 DAC CUSTOM 2019.08.01

ISA SYMBOL

STANDARD COLORS ARE WHITE FIGURE ON BLUE BACKGROUND APPROXIMATING FEDERAL STANDARD 595C - F3 15000. NON-TACTILE UON.

COLOR EXCEPTIONS:

- 1A. ON TOILET AND BATHING ROOM DESIGNATION SIGNS OR WHEN APPROVED BY THE CITY REPRESENTATIVE.
- FUNCTION BUTTON ON DESIGNATED ORIENTED ELEVATOR SYSTEM - BACKGROUND SHALL BE BLACK.
- THE APPROPRIATE CITY REPRESENTATIVE MAY APPROVE OTHER COLORS PROVIDED THE SYMBOL CONTRAST IS LIGHT ON DARK OR DARK ON LIGHT
- ON THE ACCESSBILITY FUNCTION BUTTON ON HALL CALL CONSOLES IN A DESTINATION-ORIENTED ELEVATOR SYSTEM THE INTERNATION SYMBOL OF ACCESSIBILITY SHALL BE A WHITE SYMBOL ON A BLACK BACKGROUND.
- EXCEPTIONS FOR SIZE ON EVACUATION MAPS, POWERED DOOR ACTIVATOR SWITCHES, AND ASSEMBLY SEATING.
- STYLE OF FIGURE SHALL COMPLY WITH THAT IN BLDG CODE AND FACE TO RIGHT. A BORDER IS PERMITTED INSIDE OR OUTSIDE MIN REQUIRED ISA DIM.
- SIGNS ON NON-GLASS SURFACES SHALL BE BAKED ENAMEL ON METAL AND MECHANICALLY FASTENED.
- SIGNS ON GLASS SHALL BE OPAQUE VINYL AND READABLE FROM BOTH SIDES OR HAVE WHITE OR BLACK BACKING W/O EXPOSED AIR BUBBLES.

DAC APPROVED R06 2019.08.01

ROOM IDENTIFICATION SIGN NOTES:

TOILET ROOM SIGNS SHALL BE MOUNTED AS SHOWN IN DETAIL 1 ON THIS SHEET.


VERIFY LOCATION OF BABY CHANGING SIGNS 4/A & 4/B WITH CITY REPRESENTATIVE IN

TACTILE CHARACTERS AND TEXT

- CHARACTER SHALL BE RAISED 1/32" MIN ABOVE THE BACKGROUND. SIGN COLOR SHALL CONTRAST WITH ITS BACKGROUND, LIGHT ON DARK OR DARK ON LIGHT.
- CHARACTERS SHALL BE UPPER CASE, SAN SERIF. CHARACTERS SHALL NOT BE ITALIC, OBLIQUE, SCRIPT, HIGHLY DECORATIVE, OR OF OTHER UNUSUAL
- CHARACTER PROPORTIONS, HEIGHT, STROKE, THICKNESS, SPACING AND LINE SPACING SHALL COMPLY WITH CBC 11B-703.2 RAISED CHARACTERS REQUIREMENTS. CHARACTERS SHALL BE 3/4" HEIGHT AND FORMATTED HORIZONTALLY, UON.
- NON-TACTILE CHARACTERS AND TEXT
 - SHALL COMPLY WITH NOTE A, PARAGRAPHS II AND III AND WITH NOTES D
- BRAILLE (SEE PROJECT SPECIFICATIONS FOR APPROVAL)
 - BRAILLE SHALL BE CONTRACTED GRADE 2 BRAILLE TRANSLATION OF THE TEXT AND BE POSITIONED BELOW THE CORRESPONDING TEXT HORZONTALLY. CENTER JUSTIFY BRAILLE ON SIGN, UON.
 - BRAILLE DOTS SHALL BE DOMED OR ROUNDED. SPACING SHALL CONFORM TO
 - CBC 11B-703.3. ALL BRAILLE OT BE VERIFIED AND APPROVED BY LIGHTHOUSE FOR THE BLIND.
- MATERIAL & FINISH
 - 1/4" THICK SOLID MELAMINE SHEET UON, EASED OR ROUNDED EDGES, CORNERS. AND VERTICES AT 1/16" MIN OR CHAMFERED AT 1/8" MAX.
 - NON-GLARE, MATTE OR EGGSHELL, UON
 - THE COLOR OF THE SIGN SHALL CONTRAST W/ THE BACKGROUND LIGHT ON DARK OR DARK ON LIGHT DOORS OR WALLS.

MOUNTING

INTERIOR SIGNS SHALL BE ADHERED TO DOOR OR WALL WITH NON-STAINING SILICONE SEALANT AND FOAM TAPE WITHOUT MECHANICAL FASTENERS, UON. EXTERIOR SIGNS SHALL BE MECHANICALLY FASTENED AND WITH SILICONE ADHESIVE. FASTENERS SHALL BE STAINLESS STEEL AND TAMPER PROOF.

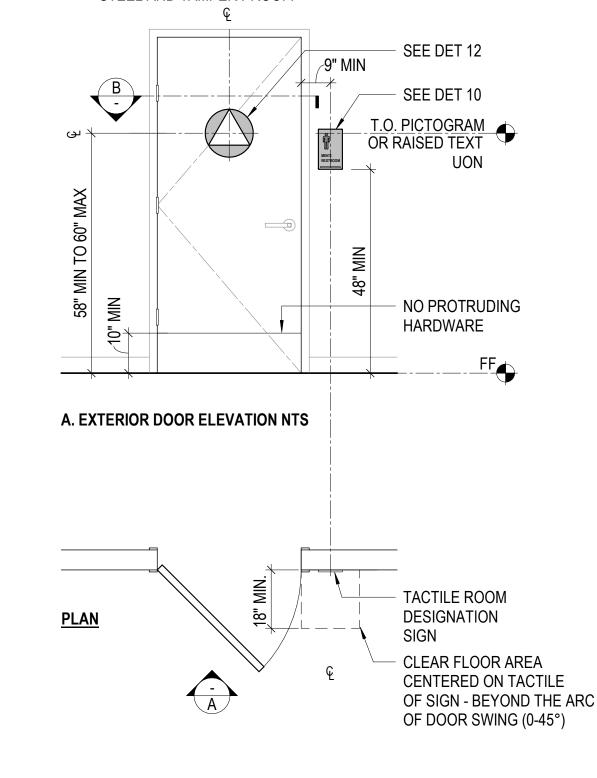

B. CLEAR FLOOR AREA REQUIREMENTS - NTS

SIGN MOUNTING LOCATIONS (IN ORDER OF PREFERENCE):

- WALL MOUNT ADJACENT TO LATCH SIDE OF DOOR.
- INACTIVE LEAF OF A DOUBLE DOOR WITH A SINGLE ACTIVE LEAF.
- THE RIGHT DOOR OF A DOUBLE DOOR WITH 2 ACTIVE LEAFS. WHERE THERE IS NO WALL SPACE ON THE LATCH SIDE OF A SINGLE DOOR OR RIGHT SIDE OF A DOUBLE DOOR, SIGN SHALL BE

LOCATED ON THE NEAREST ADJACENT WALL - COORDINATE LOCATION WITH CITY REPRESENTATIVE.

INTERNATIONAL SYMBOL OF ACCESSIBILITY (1) TOILET OR BATHING ROOM ENTRANCE SIGNS

DAC APPROVED R06 2019.08.01

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Consultant

11.16.2020 Design Development

No. Date Revisions

Paul DeFreitas Drawn

Drawing Title

Checked

TOILET ROOM DOOR SIGNAGE


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As indicated

Project No.

1804



ROOM NAME

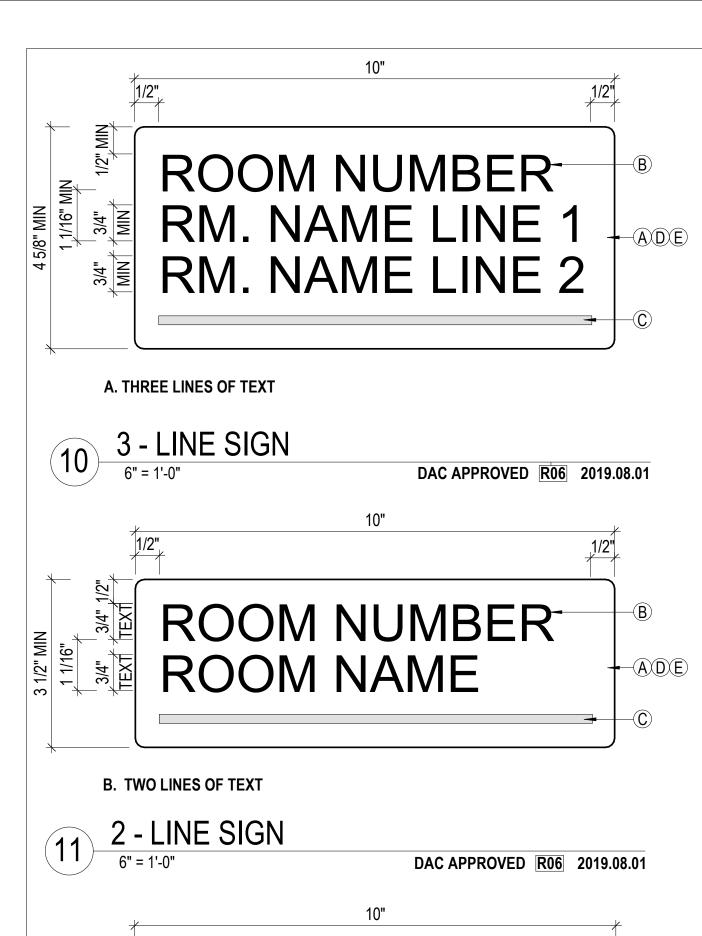REFER TO SIGNAGE SCHEDULE FOR TEXT.

TACTILE ROOM NAME SIGN



7 1/4"

EXIT

5 1/8"

1/4" RADIUS, TYP 6" X 6" MIN, BLACK, NON-GLARE, INTERNATIONAL SYMBOL OF ACCESS FOR HEARING LOSS **GRAPHIC ON HIGH CONTRAST** WHITE BACKGROUND UON ASSISTIVE LISTENING-5/8" HEIGHT SANS SERIF FONT DEVICE AVAILABLE WITH 3/8" LINE SPACING - 3/16" DIAMETER HOLE, TYP.


ASSISTIVE LISTENING DEVICE NOTES:

- USE STAINLESS STEEL VANDAL RESISTANT FASTENERS.
- SIGNS SHALL BE NON-REFLECTIVE AND NON-TACTILE.
- TEXT SHALL BE SAN SERIF FONT


AND CHARACTERS OR GRAPHIC.

- GRAPHIC FIELD 6" X 6" MINIMUM IN AREA. GRAPHIC AND BACKGROUND: LIGHT-ON-DARK OR DARK-ON-LIGHT
- **USE THE FOLLOWING COLORS:** WHITE: WHITE COLOR NO. 17875 IN FEDERAL STANDARD 595B
- BLACK: NO 17038 IN FEDERAL STANDARD 595B TEXT FORMAT IS HORIZONTAL. 1" CLEARANCE AROUND ALL BORDERS BETWEEN EDGE OF SIGN




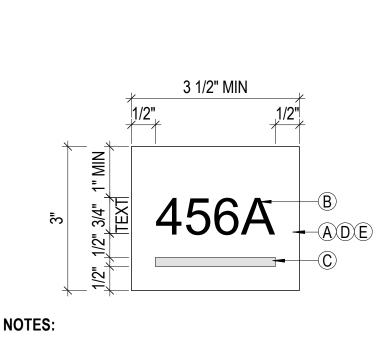

1. REFER TO SIGNAGE SCHEDULE FOR TEXT.

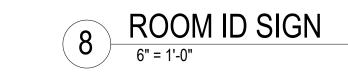

DAC APPROVED R06 2019.08.01

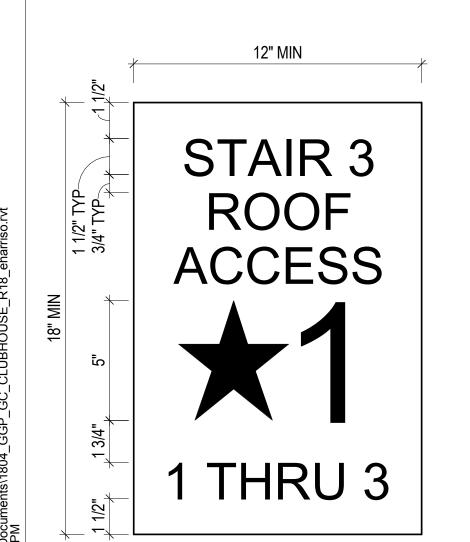

B. SINGLE LINE OF TEXT

NOTES:

6" = 1'-0"

STAIR 3 NO ROOF ACCESS 1 THRU 3

DAC APPROVED R06 2019.08.01

-(A)D(E)

NON-TACTILE STAIRWAY ID NOTES:

- STAIRWAY IDENTIFICATION SIGNS ARE REQUIRED IN STAIRWAYS CONNECTING MORE THAN THREE STORIES.
- THE SIGN SHALL BE PROVIDED ON EACH STAIRWAY LANDING.
- SEE SIGN SCHEDULE FOR STAIR NUMBERING AND DESIGNATION OF TERMINUS OR ROOF ACCESS.
- PROVIDE A FIVE POINT STAR FOR EGRESS FLOOR NUMBER. DESIGNATE MEZZANINES AS THE LETTER 'M' AND DESIGNATE BASEMENTS AS THE LETTER 'B'.
- SIGN PANEL IS 3/16" THICK, SEE SIGN SCHEDULE FOR SIGN MATERIAL AND COLOR.
- SIGN SHALL BE PHOTO LUMINESCENT PER 1025.4.
- TEXT SHALL BE SAN SERIF BLACK SIZE AS SHOWN IN DETAIL

6" MIN AUTOMATIC **CAUTION** OF SIGN **DOOR ACTIVATE SWITCH TO OPERATE**

POWER DOOR CAUTION SIGNAGE NOTES:

- UNLESS OTHERWISE NOTED, BACKGROUND COLOR SHALL BE BLACK. TEXT AND GRAPHICS YELLOW.
- 2. UNLESS OTHERWISE NOTED, BACKGROUND COLOR SHALL BE YELLOW, TEXT AND GRAPHICS BLACK.
- IF 'KNOWING ACT' OR 'ACTIVE SWITCH TO OPERATE' SWITCH IS USED TO INITIATE DOOR OPERATION, BACKGROUND COLOR SHALL BE BLUE. TEXT AND GRAPHICS SHALL BE WHITE AND THE LETTERS SHALL BE 5/8" HIGH MIN.
- VINYL STICKER SHALL BE MOUNTED ON BOTH SIDES OF DOOR 50" +/-12" FROM THE FINISHED FLOOR TO THE CENTERLINE OF THE SIGN.
- PROVIDE ISA SIGN SHEET G3.11 DETAIL 6 ON BOTH SIDES OF DOOR OR IMMEDIATELY ADJACENT WINDOW

POWERED DOOR SIGN 6

DAC APPROVED R06 2019.08.01

TACTILE EXIT SIGNAGE NOTES:


WALL AND TOILET ROOM SIGNS SHALL BE MOUNTED AS SHOWN IN DETAIL 3 ON THIS

VERIFY LOCATION OF ASSSITIVE LISTENING DEVICE SIGN 4/A & 4/B WITH CITY REPRESENTATIVE IN FIELD.

- TACTILE CHARACTERS AND TEXT
 - CHARACTER SHALL BE RAISED 1/32" MIN ABOVE THE BACKGROUND. SIGN COLOR SHALL CONTRAST WITH ITS BACKGROUND, LIGHT ON DARK OR
 - CHARACTERS SHALL BE UPPER CASE, SAN SERIF. CHARACTERS SHALL NOT BE ITALIC, OBLIQUE, SCRIPT, HIGHLY DECORATIVE, OR OF OTHER UNUSUAL
 - CHARACTER PROPORTIONS, HEIGHT, STROKE, THICKNESS, SPACING SHALL COMPLY WITH CBC 11B-703.2 RAISED CHARACTERS REQUIREMENTS. CHARACTERS SHALL BE 3/4" HEIGHT AND FORMATTED HORIZONTALLY, UON.
- NON-TACTILE CHARACTERS AND TEXT SHALL COMPLY WITH NOTE A, PARAGRAPHS II AND III AND WITH NOTES D
- - BRAILLE (SEE PROJECT SPECIFICATIONS FOR APPROVAL) BRAILLE SHALL BE CONTRACTED GRADE 2 BRAILLE TRANSLATION OF THE TEXT AND BE POSITIONED BELOW THE CORRESPONDING TEXT
 - HORZONTALLY. CENTER JUSTIFY BRAILLE ON SIGN, UON BRAILLE DOTS SHALL BE DOMED OR ROUNDED. SPACING SHALL CONFORM TO CBC 11B-703.3.
- MATERIAL & FINISH
 - 1/4" THICK SOLID MELAMINE SHEET UON, EASED OR ROUNDED EDGES. CORNERS. AND VERTICES AT 1/16" MIN OR CHAMFERED AT 1/8" MAX.
 - NON-GLARE, MATTE OR EGGSHELL, UON
 - THE COLOR OF THE SIGN SHALL CONTRAST W/ THE BACKGROUND LIGHT ON DARK OR DARK ON LIGHT DOORS OR WALLS.

MOUNTING

INTERIOR SIGNS SHALL BE ADHERED TO DOOR OR WALL WITH NON-STAINING SILICONE SEALANT AND FOAM TAPE WITHOUT MECHANICAL FASTENERS, UON. EXTERIOR SIGNS SHALL BE HELD IN PLACE WITH SILICONE ADHESIVE AND MECHANICALLY FASTENED. FASTENERS SHALL BE STAINLESS STEEL AND TAMPER PROOF.

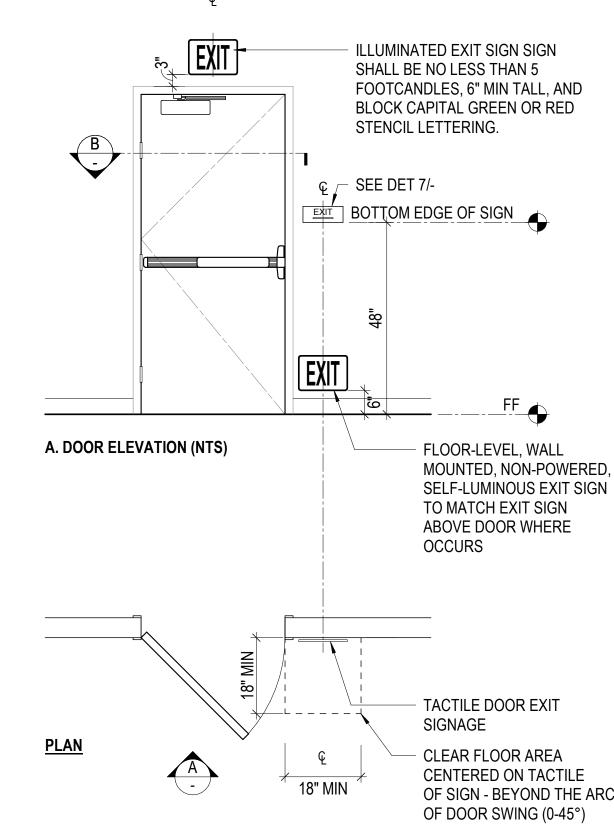

B. CLEAR FLOOR AREA REQUIREMENTS - NTS

SIGN MOUNTING LOCATIONS (IN ORDER OF PREFERENCE):

- WALL MOUNT ADJACENT TO LATCH SIDE OF DOOR
- INACTIVE LEAF OF A DOUBLE DOOR WITH A SINGLE ACTIVE LEAF. THE RIGHT DOOR OF A DOUBLE DOOR WITH 2 ACTIVE LEAFS.
- WHERE THERE IS NO WALL SPACE ON THE LATCH SIDE OF A SINGLE DOOR OR RIGHT SIDE OF A DOUBLE DOOR, SIGN SHALL BE LOCATED ON THE NEAREST ADJACENT WALL - COORDINATE LOCATION WITH CITY REPRESENTATIVE.

EXIT SIGNAGE LOCATIONS

1/2" = 1'-0"

DAC APPROVED R06 2019.08.01





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Consultant

11.16.2020 Design Development No. Date Revisions

Drawn Checked

Paul DeFreitas

Drawing Title

DOOR EXIT SIGNAGE

Sheet No.


G3.12

As indicated Scale: Project No.

1804

STAIRWAY IDENTIFICATION SIGN 3" = 1'-0"

DAC APPROVED R06 2019.08.01

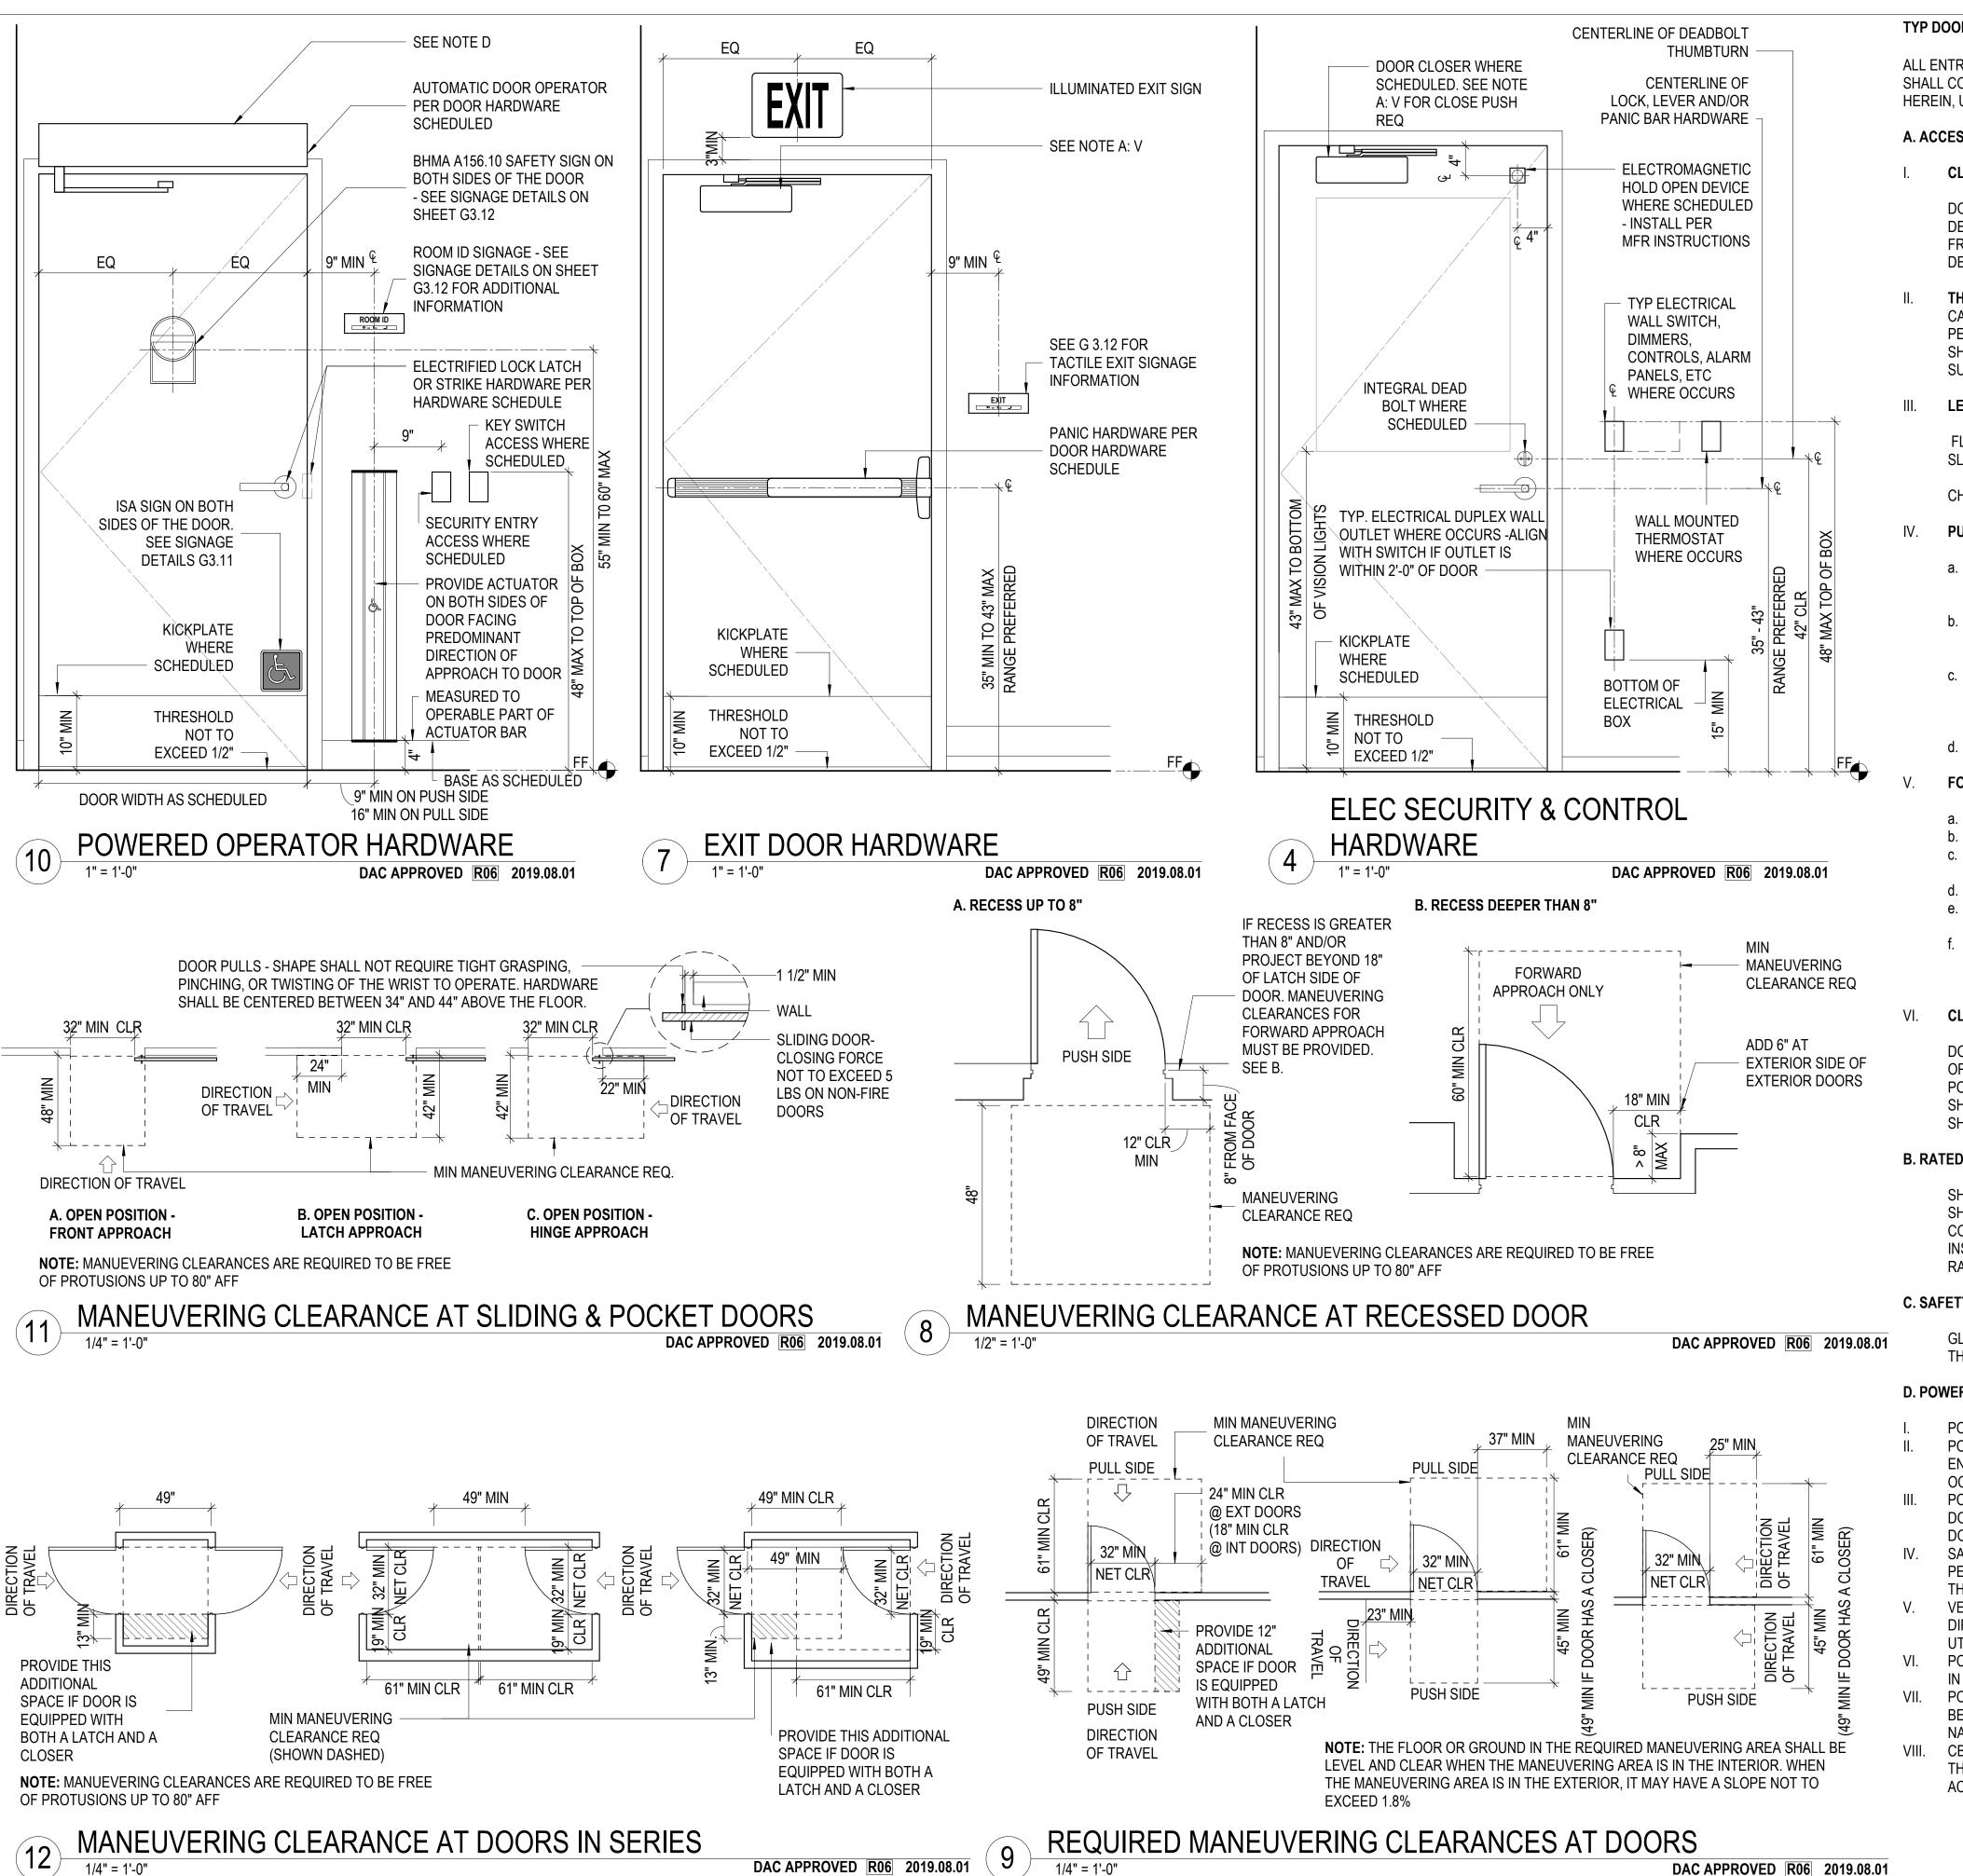

TYP DOOR AND GATE ACCESSIBILITY REQUIREMENTS:

ALL ENTRANCE DOORS, DOORS ON ACCESSIBLE ROUTES, EXIT DOORS AND GATES SHALL COMPLY WITH TITLE 24 CALIFORNIA BUILDING CODE (CBC) AND AS SUPERSEDED HEREIN. UNLESS OTHERWISE MODIFIED IN THE CONSTRUCTION DOCUMENTS.

A. ACCESSIBLE DOORS AND GATES:

CLEARANCES.

DOORS AND GATES SHALL BE CAPABLE OF AN OPENING SWEEP OF 90 DEGREES MIN. THE CLEAR OPENING AT DOORS AND GATES SHALL BE 32" MIN FROM FACE OF DOOR JAMB STOP TO FACE OF DOOR WHEN OPENED TO 90 DEGREE POSITION, UON.

THRESHOLDS. TOP OF THRESHOLDS SHALL NOT EXCEED 1/2" AFF FLOOR, CARPET FINISH. OR CONCRETE. CHANGES IN LEVEL OF 1/4" MAX HIGH SHALL BE PERMITTED TO BE VERTICAL. CHANGES IN LEVEL BETWEEN 1/4" MIN TO 1/2" MAX SHALL BE BEVELED WITH A SLOPE NOT STEEPER THAN 1:2.THE SLOPE OF TOP SURFACE OF THRESHOLDS SHALL NOT EXCEED 1:20.

LEVEL MANEUVERING CLEARANCES.

FLOOR AREAS ON EITHER SIDE OF DOOR SHALL NOT EXCEED 1.8 PERCENT SLOPE IN ANY DIRECTION.

CHANGES IN LEVEL ARE NOT PERMITTED.

PUSH-SIDE KICK PLATE AREAS

- SWINGING DOOR AND GATE SURFACES WITHIN 10" OF THE FINISH FLOOR OR GROUND SHALL HAVE A SMOOTH SURFACE ON THE PUSH SIDE EXTENDING THE FULL WIDTH OF THE DOOR OR GATE.
- ON GLASS DOORS. THE KICK PLATE AREA SHALL BE A MATERIAL OTHER THAN GLASS. PROTRUDING HINGE AND LOCKING PADS ARE TO BE PERMITTED IN THE KICK-PLATE AREA.
- SURFACE MOUNTED BOLTS OR PROTRUDING RIMS OF CYLINDER LOCKS ARE NOT PERMITTED IN THIS AREA. PARTS CREATING HORIZONTAL OR VERTICAL JOINTS IN THIS SURFACE SHALL BE WITHIN 1/16" OF THE SAME PLANE AT THE OTHER, AND BE FREE OF SHARP OR ABRASIVE EDGES.
- CAVITIES CREATED BY ADDED KICK PLATES SHALL BE CAPPED.

FORCE FOR PUSHING OR PULLING OPEN A DOOR OR GATES:

- INTERIOR DOORS AND GATES: 5 LBS MAX
- SLIDING OR FOLDING DOORS AND PEDESTRIAN-GATES: 5 LBS MAX.
- REQUIRED FIRE DOORS: THE MIN OPENING FORCE ALLOWABLE BY THE APPROPRIATE ADMINISTRATIVE AUTHORITY, NOT TO EXCEED 15LBS MAX.
- EXTERIOR HINGED DOORS: 5 LBS MAX.
- AT POWERED DOORS, MANUAL DOOR LEAFS IN THE SAME LOCATION: 8
- 1/2 LBS MAX. DOORS TO ROOMS FOR FACILITIES LISTED IN CBC 11B-203 GENERAL EXCEPTIONS ARE NOT REQUIRED TO COMPLY WITH THESE FORCE REQUIREMENTS.

CLOSING SPEED OR GATES.

DOORS WITH AUTOMATIC CLOSERS SHALL BE ADJUSTED SO THAT FROM THE OPEN POSITION OF 90 DEGREES. THE TIME REQUIRED TO MOVE THE DOOR TO A POSITION TO 12 DEGREES FROM LATCH IS 5 SECONDS MIN SPRING HINGES SHALL BE ADJUSTED SO THAT FROM 70 DEGREES, THE DOOR OR GATE SHALL MOVE TO THE CLOSED POSITION IN 1.5 SECONDS.

B. RATED DOOR ASSEMBLIES.

SHALL BE POSITIVE LATCHING AND INCLUDE A CLOSER. RATED ASSEMBLIES SHALL COMPLY WITH CBC CHAPTER 10 REQUIREMENTS AND THOSE OF THE CONSTRUCTION DOCUMENTS AND SPECIFICATIONS.MANUFACTURER'S INSTALLATION INSTRUCTIONS SHALL BE AVAILABLE ON THE JOB SITE FOR ALL RATED DOOR ASSEMBLIES.

C. SAFETY GLAZING SAFETY.

GLAZING AT DOORS SHALL COMPLY WITH CBC CHAPTER 24. SECTION 2406 AND THE DRAWINGS.

D. POWERED DOORS.

- POWERED DOORS SHALL COMPLY WITH EXCEPTIONS IN CBC 11B-404.2.9
- POWERED DOORS ARE REQUIRED FOR PRIMARY PUBLIC AND EMPLOYEE ENTRANCES TO BUILDINGS AND FACILITES, UON. WHERE A PAIR OF DOORS OCCURS IN THAT ASSEMBLY, BOTH LEAFS SHALL BE POWERED.
- POWERED DOORS ARE PERMITTED IN LIEU OF OPENING FORCES NOTED IN DOOR AND GATE REQUIREMENTS NOTE A.5. MANUAL FORCE ON POWERED DOOR PANELS IS 8 1/2 LBS.
- SAN FRANCISCO BUILDING DEPARTMENT INFORMATIONAL BULLETINS PERMISSIBLE USE OF POWERED DOORS IN ALTERATIONS IS ACCEPTED BY THESE REQUIREMENTS
- VERTICAL DOOR ACTUATORS ARE REQUIRED, AND ARE REQUIRED TO BE DIRECTLY WIRED TO DOOR OPERATOR UON. WHERE SENSING DEVICES ARE UTILIZED, A LOW PUSH PLATE SHALL BE PROVIDED UON.
- POWERED DOORS SHALL HAVE KEYED OR TOGGLE WALL SWITCH DISCONNECT IN THE NEAR VICINITY OF THE POWERED DOOR
- POWERED DOOR HARDWARE, ACTUATORS AND DISCONNECT IS PERMITTED TO BE INTEGRATED WITH SECURITY SYSTEMS. OBTAIN AN OPERATIONAL NARRATIVE FROM THE CITY'S REPRESENTATIVE.
- CBC 11B-404.2.9 EXCEPTIONS C, D AND E CONTAIN SIGNAGE REQUIREMENTS THAT ARE NOT COMPLETELY IDENTIFIED IN DETAILS SHOWN IN THE TYPICAL ACCESSIBLE DOOR AND GATE SHEET

DAC APPROVED R06 2019.08.01

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No. Date Revisions

11.16.2020

Noah Levy Paul DeFreitas Drawn Checked Checker


Drawing Title

TYPICAL ACCESSIBLE DOORS AND **GATES**

Sheet No.

Project No.

G3.21 As indicated Scale:

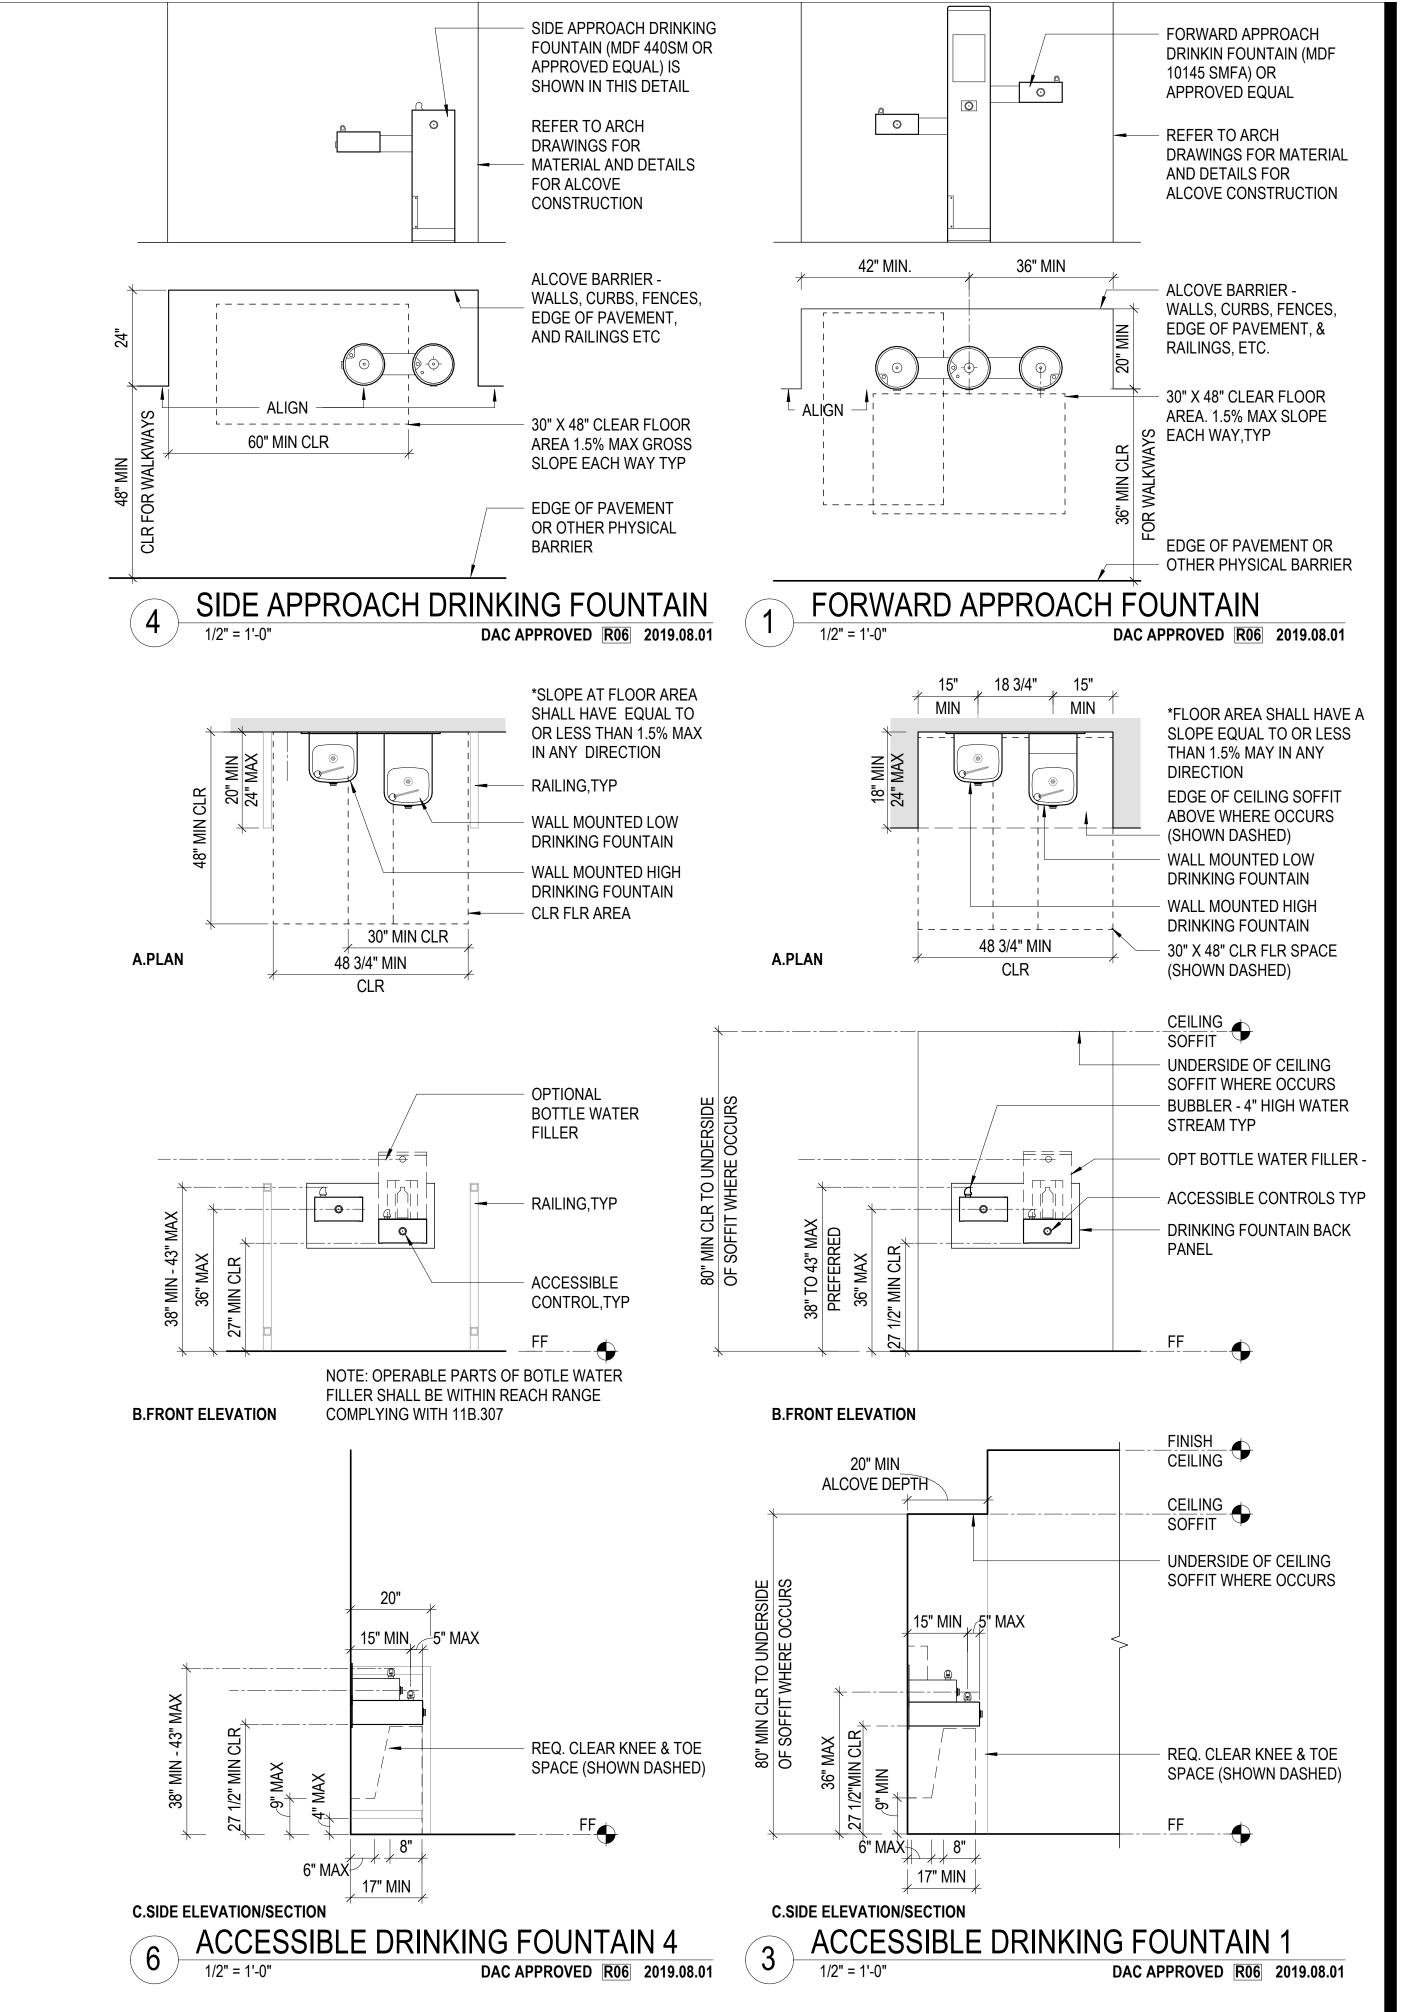

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Design Development

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Paul DeFreitas Drawn

Drawing Title

Checked

ACCESSIBLE DRINKING FOUNTAIN & WALL & FLOOR ACCESSORIES


Sheet No.

G3.31

1/2" = 1'-0"

Scale: Project No.

1804

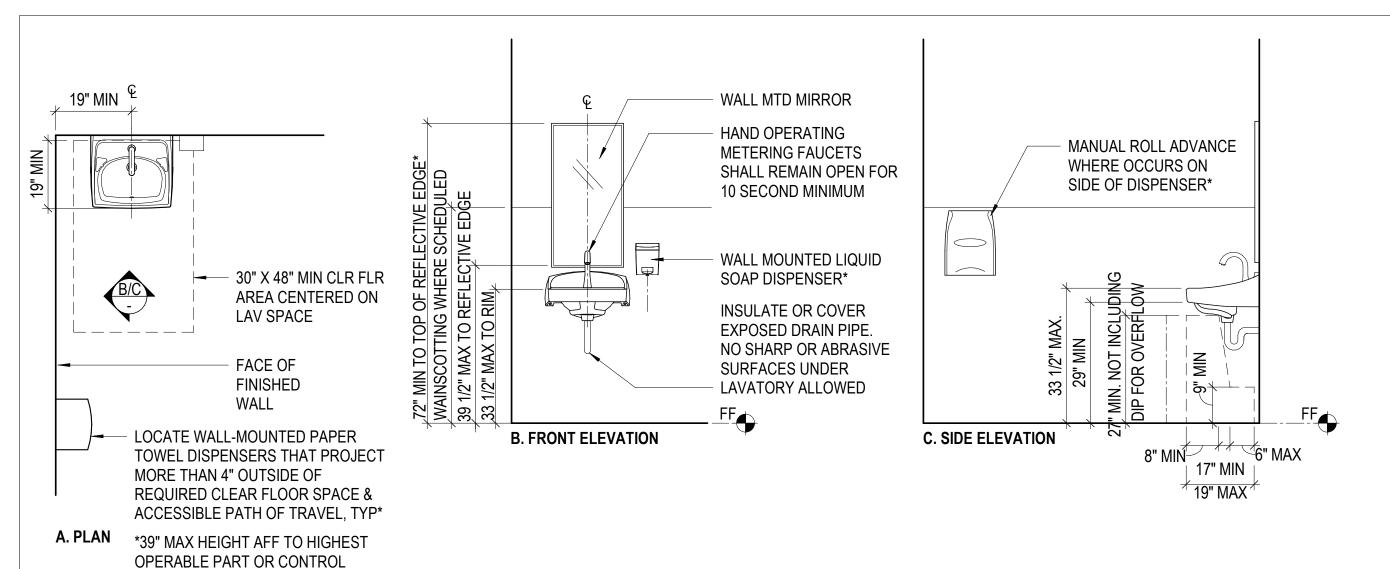

WALL-MOUNTED LAVATORY WITH AUTOMATIC FAUCET

- CLEAR FLOOR SPACE

(SHOWN DASHED) TYP

61" MIN CLR

30" X 48" MIN

CLR FLR

CENTERED


AREA

ON LAV

SPACE

DOUBLE TOILET TISSUE ROLL DISPENSERS THAT CONTROL DELIVERY OR PERMIT CONTINUOUS PAPER FLOW ARE NOT PERMITTED

A. SURFACE MOUNTED DOUBLE ROLL DISPENSER

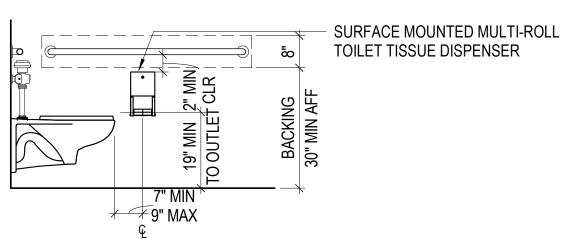

3. SURFACE MOUNTED MUTLI-ROLL DISPENSER

C. SIDE ELEVATION

DAC APPROVED R06 2019.08.01

PROVIDE 8"MIN HEIGHT BACKING

MIN HEIGHT AT SIDE WALL BEHIND

GRAB BARS AND BETWEEN STUDS.

BEHIND WATER CLOSET AND 8"

REFER SPECIFICATIONS FOR

OPERATED FLUSH ACTIVATOR

CONTROLS ON THE WIDE SIDE

MORE INFORMATION

HANDS-FREE SENSOR

UON. LOCATE MANUAL

OF THE TOILET

FINISH FACE OF WALL OR

PARTITION OR SIDE OF


ANY FIXTURE

54" MIN

22

B. FRONT ELEVATION



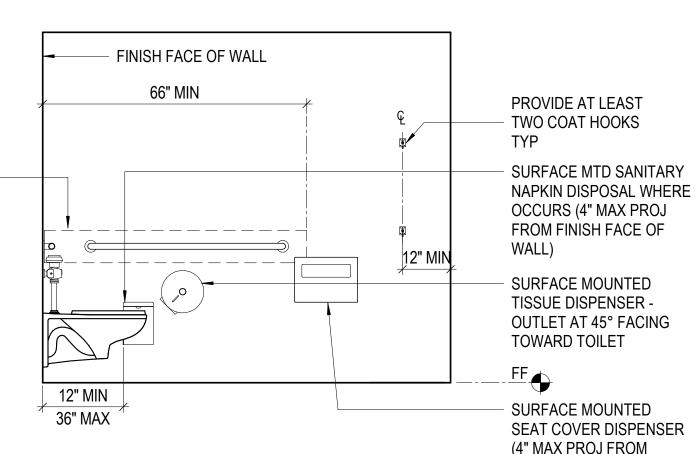

WALL-MOUNTED TOILET

1/2" = 1'-0"

19" MIN

A. PLAN

DAC APPROVED R06 2019.08.01

FINISH FACE OF WALL)

GENERAL TOILET AND BATHING ROOM ACCESSIBILITY NOTES:

- 1. THE MINIMUM, MAXIMUM, AND ABSOLUTE DIMENSIONS SHOWN IN THESE STANDARD DETAILS VARY FROM THOSE IN TITLE 24 CALIFONRIA BUILDING CODE AND/OR AMERICANS WITH DISABILITIES ACT 2010 ADA STANDARD (ADAAG). DIMENSIONS THAT ARE NOT STATED AS "MAXIMUM" OR "MAX" OR "MINIMUM" OR "MIN" ARE ABSOLUTE (1101B.4). ALL DIMENSIONS ARE SUBJECT TO CONVENTIONAL INDUSTRY TOLERANCES EXCEPT WHERE THE REQUIREMENT IS STATED AS A RANGE WITH SPECIFIC MINIMUM AND MAXIMUM END POINTS.
- BATHING, LOCKER, AND CHANGING TOILET ROOMS SHALL CONTAIN A 60" DIAMETER MANEUVERING SPACE OR EQUIVALENT T-SHAPED SPACE. THE MANEUVERING SPACES ARE PERMITTED TO UNDERLAP SOME OBJECTS. TOE & KNEE SPACE AT ONLY ONE END OF EITHER THE BASE OR ONE AREA OF T-SHAPED SPACE. A DOOR IS PERMITTED TO UNDERLAP A TOILET ROOM'S REQUIRED MANEUVERING SPACE BY 12" MAX.
- TOILET ROOMS ARE TO CONTAIN A CLEAR 44" MIN PATH TO WHEELCHAIR AND ACCESSIBLE TOILET COMPARTMENTS, EXCEPT FOR INTERVENING DOOR WIDTHS.
- 4. TRASH CAN IS NOT PERMITTED TO OCCUPY THE CLEAR FLOOR SPACE OF ANY FIXTURE OR DOOR.
- DOORS ARE NOT PERMITTED TO ENCROACH ON THE REQUIRED CLEAR FLOOR SPACE AT ANY FIXTURE. EXCEPTION: WHERE THE TOILET OR BATHING ROOM IS FOR INDIVIDUAL USE AND A 30" X 48" CLEAR FLOOR SPACE IS PROVIDED WITHIN THE ROOM BEYOND THE ARC OF THE DOORS.
- THE CLEAR FLOOR AREAS OF ANY FIXTURE, ACCESSIBLE ROUTE AND MANEUVERING SPACE ARE PERMITTED TO OVERLAP.
- 7. MOUNTING HEIGHT OF COUNTERS AND FIXTURES SHALL TAKE INTO ACCOUNT FLOOR SLOPE TO DRAIN.
- 8. FLOOR SLOPE TO DRAIN SHALL NOT EXCEED 1.5% IN ANY DIRECTION.
- 9. FIXTURE AND TOILET CLEARANCES ARE TO FACE OF FINISH.
- 10. NO ACCESSORIES OR COMBINATION UNITS ARE TO BE MOUNTED BEHIND OR ABOVE GRAB BARS.
- THE REAR GRAB BAR SHALL BE PERMITTED TO BE 24 " MINIMUM LONG, CENTERED ON THE WATER CLOSET, WHERE WALL SPACE DOES NOT PERMIT A 36 " MINIMUM GRAB BAR DUE TO THE LOCATION OF A RECESSED FIXTURE ADJACENT TO THE WATER CLOSET. FIXTURES RECESSED BEHIND ATER CLOSET SHALL NOT PROTRUDE FORWARD OF WALLS FACE OF FINISH BEHIND WATER CLOSET.
- WHERE AN ADMINISTRATIVE AUTHORITY REQUIRES FLUSH CONTROLS FOR FLUSH VALVES TO BE LOCATED IN A POSITION THAT CONFLICTS WITH THE LOCATION OF THE REAR GRAB BAR, THE THE REAR BAR SHALL BE PERMITTED TO BE SPLIT OR SHIFTED TO THE OPEN SIDE OF THE TOILET AREA.
- 13. ACCESSORIES SHALL BE LOCATED ON AN ACCESSIBLE ROUTE AND WITHIN ACCESSIBLE REACH RANGE. PROVIDE CLEAR FLOOR SPACE THAT ALLOWS A FORWARD OR PARALLEL APPROACH BY A PERSON USING A WHEELCHAIR. ALL USER OPERABLE PARTS & CONTROLS SHALL BE LOCATED WITHIN 40" MAX FROM THE FINISH FLOOR.CONTROLS AND OPERATING MECHANISMS SHALL BE OPERABLE WITH ONE HAND AND SHALL NOT REQUIRE TIGHTGRASPING, PINCHING OR TWISTING OF THE WRIST. THE FORCE REQUIRED TO ACTIVATE CONTROLS SHALL BE NO GREATER THAN 5 POUNDS OF FORCE.
- 14. DOOR TO SINGLE USER TOILET OR BATHING SHALL BE PROVIDED WITH AN ACCESSIBLE PRIVACY LATCH.
- 15. THE CLEAR FLOOR AREA ON BOTH SIDES OF DOOR OF WHEELCHAIR ACCESSIBLE TOILET COMPARTMENT SHALL BE CLEAR OF ANY OBSTRUCTIONS & CLEAR OF THE ARC OF THE SWING OF ANY OTHER DOOR. DOORS SHALL HAVE 18" PULL SIDE STRIKE SIDE CLEARANCE.
- 15. VERIFY WALL STRUCTURE, BACKING & MOUNTING REQUIREMENTS IN FIELD EACH GRAB BAR SHALL SUPPORT A FORCE OF 250 LBS MIN APPLIED IN ANY DIRECTION TO ANY POINT OF THE GRAB BAR.
- 16. WHERE PROVIDED, BABY CHANGE APPLIANCES WHEN DEPLOYED SHALL NOT ENCROACH ON DOORWAY MANUEVERING AREAS AND BE PLACED ON TOILET CLEAR FLOOR AREAS ABOVE OR BELOW GRAB BARS.
- 17. SEPERATE GRAB BARS ON ADJACENT WALLS ARE TO BE INSTALLED AT A COMMON HEIGHT.

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No. Date Revisions

PM
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Paul DeFreitas
Drawn
Author

CONSTRUCTION

11.16.2020

Drawing Title

Checked

ACCESSIBLE TOILET ROOM STANDARD DETAILS

Sheet No.

G3.32

1/2" = 1'-0"

Project No.


1804

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TOWEL DISPENSER NOTES

- ALL HARD ROLL PAPER TOWEL DISPENSERS SHALL BE EITHER ELECTRONIC AUTOMATIC DISPENSER THAT CAN DISPENSE TOWELS WITHOUT TOUCHING ANY CONTROLS OR HAVE A MANUAL PAPER ADVANCE LEVER.
- THE CONTROLS SHALL BE OPERABLE WITH ONE HAND AND SHALL NOT REQUIRE TIGHT GRASPING, PINCHING, OR TWISTING OF THE WRIST. THE FORCE REQUIRED TO ACTIVATE THE CONTROLS SHALL BE NO GREATER THAN 5 LB OF FORCE.
- AT LEAST ONE PAPER TOWEL DISPENSER IN EACH WASHROOM WHERE SCHEDULED SHALL BE MOUNTED PER THIS DETAIL SUCH THAT A LL USER OPERABLE CONTROLS OR PARTS ARE WITHIN 46" OF THE FINISH FLOOR. ANY ADDITIONAL TOWEL DISPENSERS MAY BE MOUNTED SUCH THAT THE BOTTOM OF THE DISPENSER IS 52" AFF.
- 4. ALL ACCESSORIES LOCATED IN MULTI-USER TOILER BATHING, LOCKER OR CHANGING ROOMS MORE THAN 27" AFF MUST NOT PROTRUDE MORE THAN 4" FROM WALL.

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AUTOMATIC HAND DRYER


1/2" = 1'-0"

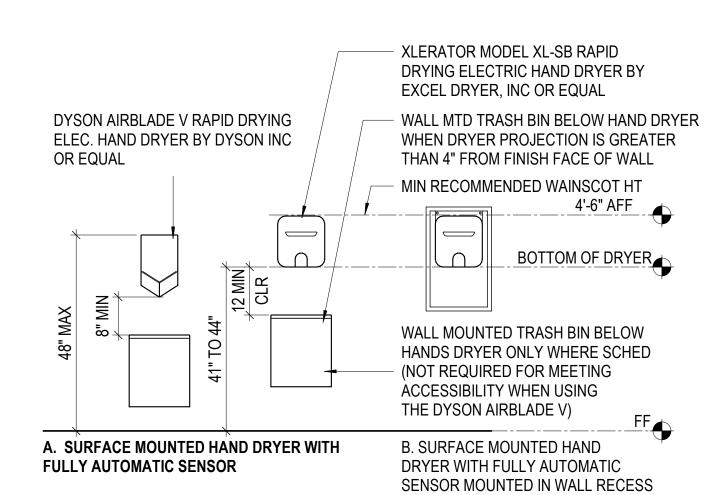(4" MAX. PROJECTION FROM FINISH FACE OF WALL)

DAC APPROVED R06 2019.08.01


RECEPTACLE

WALL ACCESSORY DETAILS

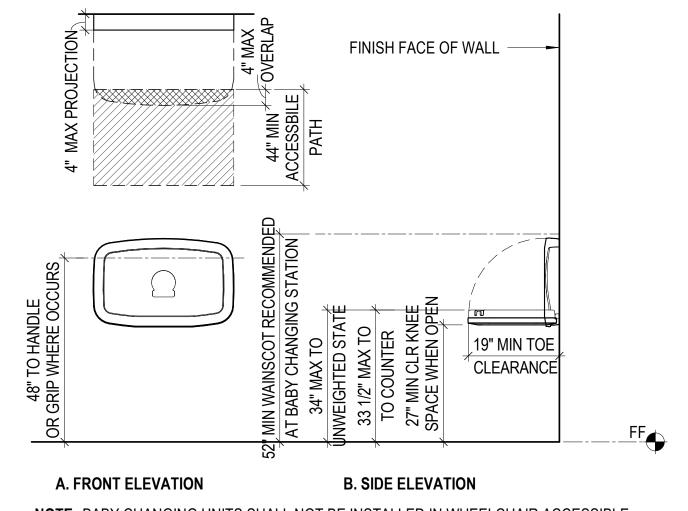

NOTE: BABY CHANGING UNITS SHALL NOT BE INSTALLED IN WHEELCHAIR ACCESSIBLE TOILET COMPARTMENTS. BABY CHANGING UNITS SHALL NOT BE INSTALLED WHERE IN OPEN OR CLOSED POSITION, IT WOULD OVERLAP THE CLEAR FLOOR AREA REQUIRED AT A DOOR OR THE ACCESSIBLE ROUTEIN A MULTI-USER TOILET OR BATHING ROOM.



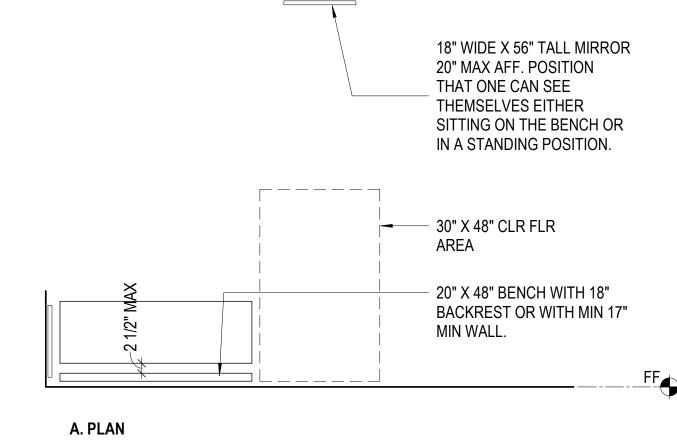

NOTE: BENCHES SHALL BE AFFIXED TO THE WALL OR FLOOR. ALLOWABLE STRESSED SHALL NOT BE EXCEEED FROR MATERIALS USED WHEN A VERTICAL OR HORIZONTAL FORCESOF 250 LBS IS APPLIED AT ANY POINT ON THE SEAT, FASTENER, MOUNTIGN DEVICE, OR SUPPORTING STRUCTURE.



11.16.2020 Design Development

No. Date

PM		0

Revisions

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Drawn Checked


Drawing Title

Project No.

ACCESSIBLE TOILET ROOM **ACCESSORIES DETAILS**

Sheet No. G3.33 1/2" = 1'-0" Scale:

1804

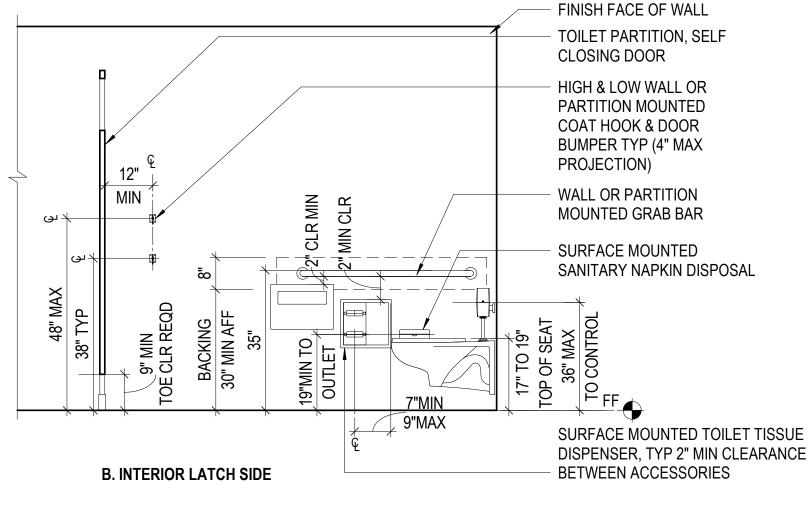

36" ABSOLUTE EQ EQ FINISH FACE OF WALL **SELF-CLOSING DOOR** 54" MIN 42" GRAB BAR BOTH SIDES OF CLR COMPARTMENT SURFACE MOUNTED MIN (SANITARY NAPKIN TISSUE DISPENSER -DISPOSAL MOUNT FLUSH SIDE AMBULATORY COMPARTMENT BETWEEN ACCESSORIE 32" MIN SURFACE MOUNTED SEAT COVER
DISPENSER
FF CLEAR W/ DOOR / OPEN AT 90° 35" TO 37" 7"MIN PERMITTED 9"MAX SELF-CLOSING DOOR A. PLAN VIEW **B. INTERIOR LATCH SIDE**

1. ALL PARTITION MOUNTED GRAB BARS MUST BE ABLE TO SUPPORT A MIN OF 250 LBS. IN ANY DIRECTION BOTH AT THE GRAB BAR AND AT THE

2. RECESSED OR SEMI RECESSED COMBINATION TOILET TISSUE, SEAT COVER DISPENSER OR OTHER DISPOSAL UNITS ARE NOT PERMITTED

WITH DOCUMENTED CERTIFICATION BY TOILET PARTITION MANUFACTURER

BETWEEN THE WALL, PARTITION, AND GRAB BAR.

36" STANDARD

COMPARTMENT

-4" MAX

SELF-CLOSING

APPROACH

60 X 72" MANUVERING FOR LATCH SIDE

DAC APPROVED R06 2019.08.01


3. SEE DET 10/G3.33 FOR ACCESSORIES

1. ALL PARTITION MOUNTED GRAB BARS MUST BE ABLE TO SUPPORT A MIN OF 250 LBS. IN ANY DIRECTION BOTH AT THE GRAB BAR AND AT THE PARTITION WITH DOCUMENTED CERTIFICATION BY TOILET PARTITION MFR. 2. RECESSED OR SEMI-RECESSED TOILET TISSUE, SEAT COVER DISPENSER OR OTHER DISPOSAL UNITS ARE NOT PERMITTED BETWEEN THE WALL OR PARTITION AND GRAB BAR

3. SEE DET 10/G3.33 FOR ACCESSORIES

4. AT LEAST ONE SIDE PARTITION MUST PROVIDE A TOE CLEARANCE AT 9" MIN AFF AND 6" DEEP MIN BEYOND THE THE COMPARTMENT SIDE FACE OF THE PARTITION.

TOILET COMPARTMENT AND ADJACENT AMBULATORY TOILET COMPARTMENTS 1/2" = 1'-0"

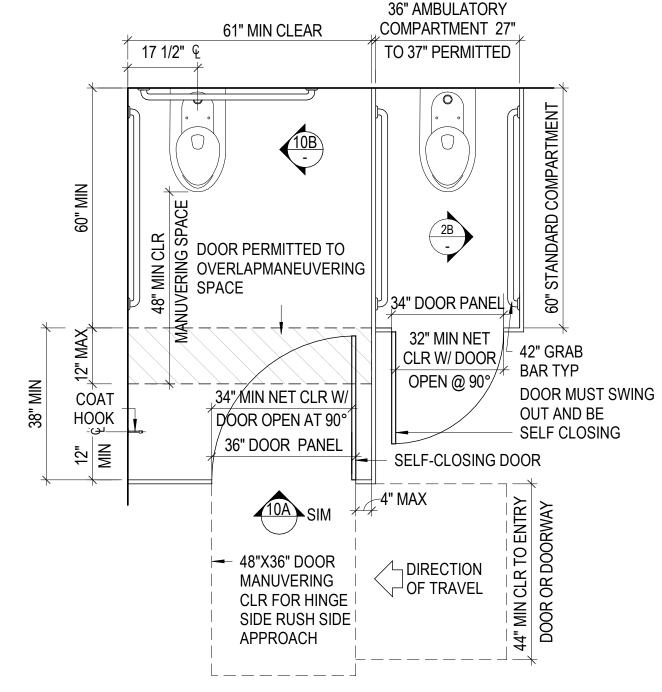

TOILET COMPARTMENT W/ FRONT-OPEN INSWING DOOR & ADJACENT AMBULATORY COMPARTMENT

DAC APPROVED R06 2019.08.01

DAC APPROVED R06 2019.08.01

17 1/2" Q

61" MIN CLEAR

MIN REQ CLR

19" MIN CLR 36" DOOR PANEL

TOILET COMPARTMENT

10A SIM


61" MIN CLR

W/ FRONT-OPEN OUTSWING DOOR

MANEUVERING SPACE

IN FRONT OF TOILET

(SHOWN HATCHED)

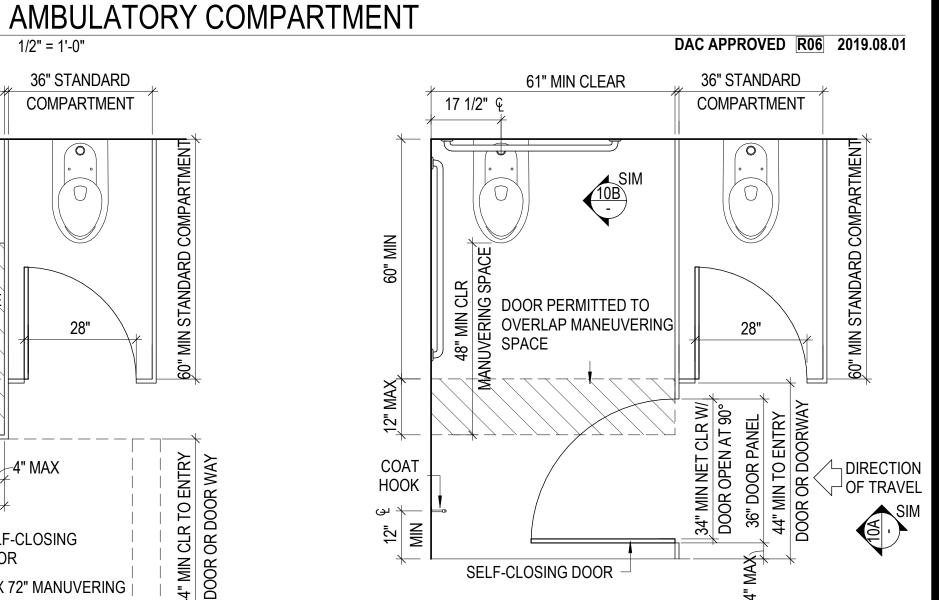

NOTE: IN TOILET ROOMS W/ THREE OR MORE COMPARTMENTS, LOCATE ABULATORY TOILET COMPARTMENT AWAY FROM ACCESSIBLE STALL

TOILET COMPARTMENT W/ IN-SWING -SIDE ENTRY DOOR

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Drawing Title

ACCESSIBLE TOILET RESTROOM STANDARD DETAILS

G3.34 1/2" = 1'-0"

Project No.

MIN REQ CLR MANEUVERING SPACE IN FRONT OF TOILET

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Drawing Title

ACCESSIBLE TOILET ROOM ALTERNATE DETAILS

Sheet No.

G3.35

1/2" = 1'-0"

Scale: Project No.

1804

DAC APPROVED R06 2019.08.01

TOILET_COMPARTMENT_W/

IN-SWINGING SIDE DOOR

AMBULATORY COMPARTMENT -

IN-SWING DOOR 1/2" = 1'-0" DAC APPROVED **R06** 2019.08.01

TOILET COMPARTMENT ADJACENT TO

2. PAINT TYPE MUST MATCH

WHITE ISA PICTOGRAM & BORDER

BLUE FIELD - COLOR SHALL BE

FEDERAL STANDARD 595B

APPROX TO COLOR NO 15090 IN

DAC APPROVED R06 2019.08.01

STRIPING MATERIAL


ALIGN BOTTOM EDGE OF DECAL

INTERNATIONAL SYMBOL OF

ACCESSIBILITY - PAVING DECAL

WITH EDGE OF 4" PARKING STALL

48" MIN ACC PATH OF TRAVEL

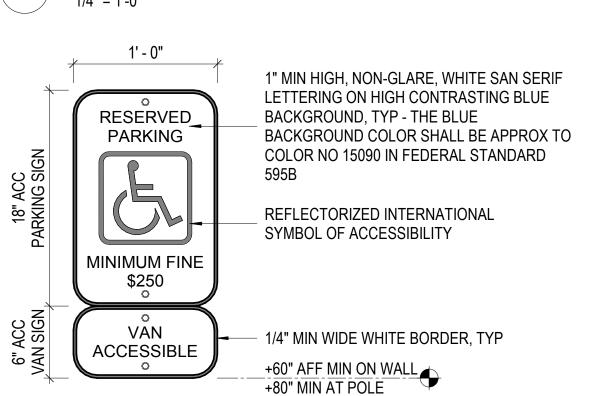


ACCESSIBLE PARKING STALL SIGN

PER TYP DETAIL 6 - POST MOUNT

WHERE INDICATED ON PLANS

EDGE OF CURB

WHERE OCCURS —

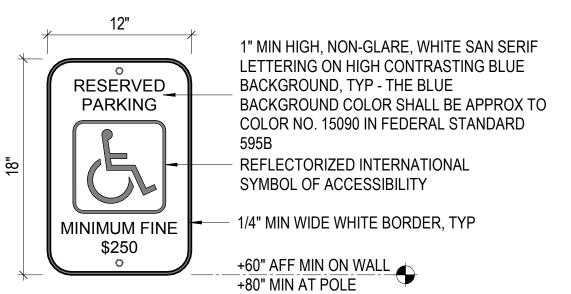

DRIVE AISLE OFFSET REQUIRED TO

ACCOMMODATE STALLS AT 30°

ACCESSIBLE PARKING STALL SIGN

PARKING SPACE DESIGN NOTES

GENERAL PARKING, ELECTRICAL VEHICLE PARKING AND VALET PARKING SHALL BE CALCULATED SEPARATELY. SPECIALIZED PARKING FOR EMPLOYEES VERSUS PUBLIC VS. MEDICAL ETC. SHALL BE CALCULATED SEPARATELY.

ACCESSIBLE ROUTES

- AN ACCESSIBLE ROUTE SHALL CONNECT ACCESS AISLES OF ACCESSIBLE PARKING SPACES TO BUILDINGS AND FACILITY ENTRANCES AND WALKS AND SIDEWALKS THAT SERVE OTHER ACCESSIBLE ELEMENTS ON A SITE CBC 11B-208.3 PROVIDES OTHER PLANNING CRITERIA.
- FLOOR SURFACES AT ACCESSIBLE SPACES, ADJACENT ACCESS AISLES AND ACCESSIBLE ROUTES SHALL
 - BE FIRM, STABLE, AND SLIP RESISTANT.
 - CROSS SLOPE IN ANY DIRECTION SHALL NOT EXCEED 1.5% MAX.
 - OPENINGS IN FLOOR OR GROUND SURFACES OF THESE AREAS SHALL NOT PERMIT THE PASSAGE OF A 1/2" DIAMETER SPHERE.
 - CHANGES IN ELEVATION SHALL NOT EXCEED 1/4" MAX.
 - DETECTABLE WARNINGS, DRAINS, OR GRATES ARE NOT PERMITTED TO BE PLACED IN OR ON PARKING SPACE OR ADJACENT ACCESS AISLE SURFACES.

VERTICAL CLEARANCES

THE VERTICAL CLEARANCE ALONG VEHICULAR ROUTE TO AND FROM ACCESSIBLE SPACES ARE REQUIRED TO BE MINIMUM 114" CLEAR. THE ACCESSIBLE ROUTE LEADING TO AND FROM ACCESS AISLES TO BUILDING AND FACILITY ENTRANCE, OR DESIGNATED ROUTE TO EXITS, SHALL BE 120" CLEAR MAX.

D. PAVING

ACCESSIBLE PARKING SPACES, PASSENGER LOADING ZONES, ELECTRIC VEHICLE SPACES REQUIRED BY CBC 11B-228.3, AND ADJACENT ACCESS AISLES SHALL BE CONCRETE PAVING UON. CONSTRUCTION DETAILS INCLUDING REINFORCING ARE SHOWN ELSEWHERE ON DRAWINGS.

PARKING SPACE SIGNS AND MOVEMENT MARKINGS

- ACCESSIBLE PARKING SPACES SHALL BE IDENTIFIED BY A SIGN BEARING THE STANDARD ISA SYMBOL IN WHITE ON A BLUE BACKGROUND, THE TEXT "RESERVED PARKING" OR "PARKING ONLY", AND THE TEXT, "\$250 MINIMUM
- VAN ACCESSIBLE SIGNS SHALL BE IDENTIFIED BY A SIGN WITH THE TEXT "VAN ACCESSIBLE" WHICH MAY BE SEPARATED OR INTEGRATED WITH THE FIRST SIGN.
- SIGNS SHALL BE MOUNTED ON A WALL SURFACE, POLE OR HUNG FROM OVERHEAD STRUCTURE. MIN MOUNTING HEIGHTS ARE NOTED IN DETAILS.
- IV. PARKING SPACE, PASSENGER LOADING AND UNLOADING SPACE AND ACCESS AISLE PAVEMENT MARKINGS SHALL BE THERMOPLASTIC MATERIALS. STANDARD SIZES AND GRAPHICS ARE SHOWN IN DETAILS. TECHNICAL CRITERIA FOR MATERIALS ARE LOCATED IN SPECIFICATIONS.
- THE "UNAUTHORIZED VEHICLES" TOWING SIGN SHALL BE POSTED AS SHOWN IN PLANS.

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PARKING

Sheet No. G3.51

Scale:

Project No.

1804

As indicated

DAC APPROVED R06 2019.08.01

Original Sheet Size: 22"x34"

VAN ACCESSIBLE PARKING STALL SIGN DAC APPROVED R06 2019.08.01

EQ

REQUIRED SLOPES

TYPICAL WHEEL STOP

4" WHITE STRIPE, TYP

4" BLUE STRIPE, TYP

TYPICAL PAVEMENT

EQ

SYMBOL - SEE DETAIL

12" MIN HIGH WHITE TEXT.

MASK OUT STRIPING WHEN

TEXT OVERLAPS STRIPING

144" MIN

(108" MIN IF ADJACENT ACCESS

AISLE WIDTH IS 100" OR GREATER) **Q**

(SHOWN SHADED)

EDGE OF

CURB WO

EQ

VAN ACCESSIBLE PARKING STALL

PARKING

60" MIN

ACCESS AISLE (

DAC APPROVED R06 2019.08.01

TYPICAL EDGE OF

DAC APPROVED R06 2019.08.01

DRIVE AISLE

ALIGN TYP -

KING STALL NO COET LENGTH SHO

SEE NOTE B FOR

EQ

, 36" TYP

TYPICAL WHEEL STOP

DIAGONAL STRIPING

4" WHITE STRIPE, TYP

4" BLUE STRIPE, TYP

TYPICAL PAVEMENT

SYMBOL - SEE DETAIL 12

EQ 36" TYP EQ

108" MIN CAR ACC STALL

36"

OC TYP


12" MIN HIGH WHITE TEXT

MASK OUT STRIPING WHEN

TEXT OVERLAPS STRIPING

(SHOWN SHADED)

4" WIDE WHITE

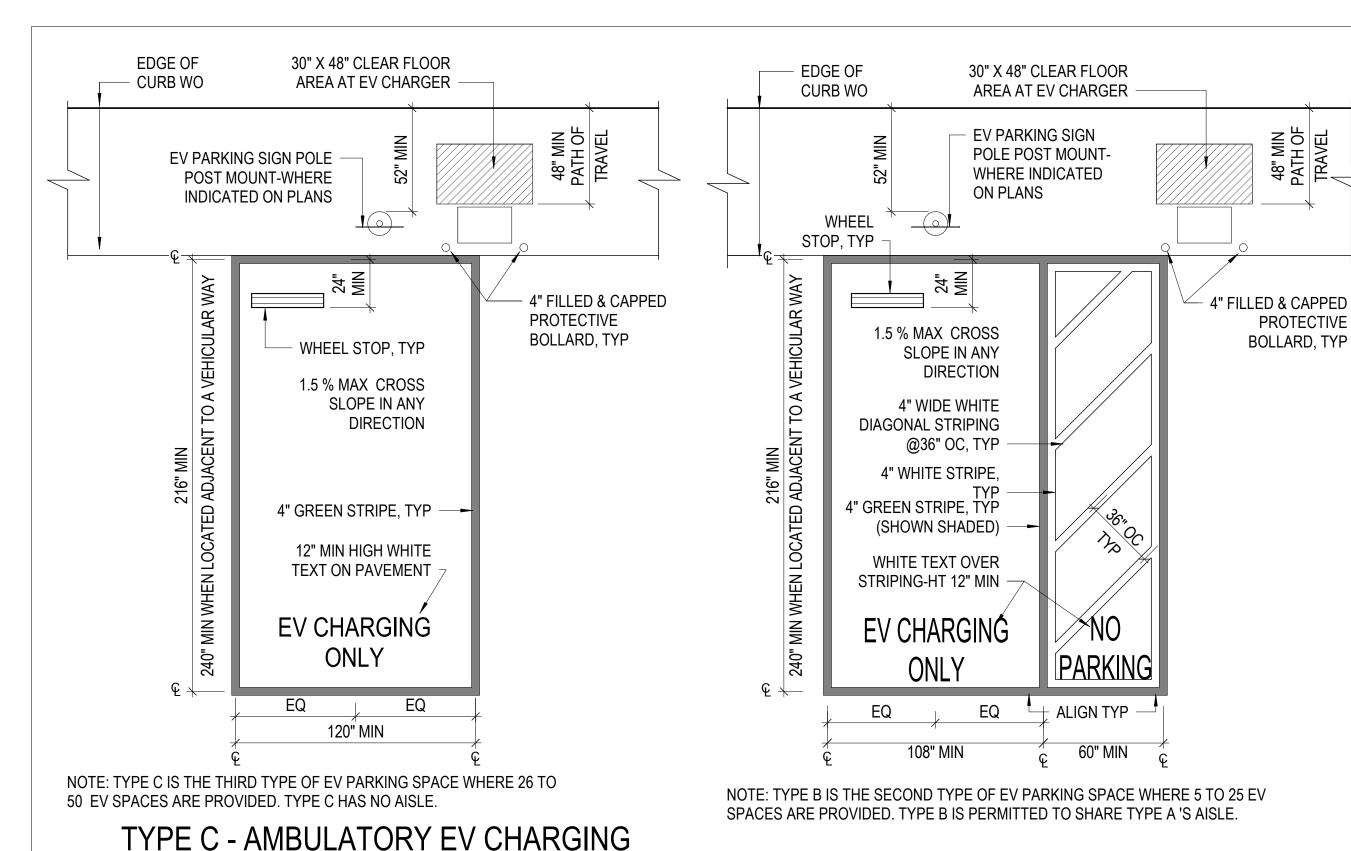

ELECTRIC VEHICLE CHARGING STATION (EVCS) ENLARGED PARKING SPACE DESIGN NOTES

DAC APPROVED R06 2019.08.01

THESE PLANS DETAILS APPLY TO EVCS THAT ARE ENLARGED SPACES AND WHICH ALSO HAVE A POTENTIAL TO BE CONVERTED TO EV PARKING SPACES, SUCH AS "EV-READY" SPACES. EV PARKING SPACE SHALL COMPLY WITH STANDARD ACCESSIBLE PARKING REQUIREMENTS AND INCLUDE EV SIGN DETAIL FIVE.

CALCULATION OF ENLARGED EVCS PARKING SPACES

STATION

1/4" = 1'-0"

- ENLARGED EVCS SPACES FOR THE PUBLIC AND GENERAL PARKING AND / OR D. "EV READY" SHALL BE CALCULATED PER CBC SECTION 228.2. WHEN NEW EVCS ARE PROVIDED FOR PUBLIC OR COMMON USE, THE TOTAL
- NUMBER OF EXISTING AND NEW SPACES SHALL BE USED IN THIS CALCULATION. WHERE AN EV CHARGER CAN SIMULTANEOUSLY CHARGE MORE THAN ONE
- VEHICLE, THE NUMBER OF EV CHARGERS PROVIDED SHALL BE CONSIDERED EQUIVALENT TO THE NUMBER OF ELECTRIC VEHICLES THAT CAN BE SIMULTANEOUSLY CHARGED.
- EVCS NOT AVAILABLE TO THE GENERAL PUBLIC AND INTENDED FOR USE BY A DESIGNATED VEHICLE OR DRIVER SHALL NOT BE REQUIRED TO COMPLY WITH THESE REQUIREMENTS OR CALCULATION. EXAMPLES INCLUDE, BUT ARE NOT LIMITED TO: EVCS SERVING PUBLIC OR PRIVATE FLEET VEHICLES OR PRIVATE FLEET VEHICLES AND EVCS ASSIGNED TO AN EMPLOYEE.
- EVCS ENLARGED SPACES PROVIDED FOR NEW OR EXISTING PARKING FACILITY MAY SERVE AS ENLARGED SPACES IN "EV-READY" PARKING LOTS THAT BECOME FULLY OR PARTIALLY CONVERTED TO EVCS.
- B. ACCESSIBLE ROUTES
 - AN ACCESSIBLE ROUTE SHALL CONNECT ACCESS AISLES OF TYPES A AND B ACCESS AISLES TO BUILDINGS AND FACILITY ENTRANCES AND WALKS AND SIDEWALKS THAT SERVE OTHER ACCESSIBLE ELEMENTS ON A SITE. AN ACCESSIBLE ROUTE SHALL CONNECT THE ENLARGED EVCS PARKING SPACE, AND THE EVCS CHARGER WHICH IT SERVES. CORDS FROM AN EVCS CHARGER SHALL NOT CROSS THIS ACCESSIBLE ROUTE.

FLOOR SURFACES

FLOOR SURFACES AT ENLARGED PARKING SPACES, THE ADJACENT ACCESS AISLES AND ACCESSIBLE ROUTES SHALL:

- BE FIRM, STABLE, AND SLOPE RESISTANCE.
- CROSS SLOPE IN ANY DIRECTION SHALL NOT EXCEED 1.5% MAX.
- OPENINGS IN FLOOR OR GROUND SURFACES OF THESE AREAS SHALL NOT PERMIT THE PASSAGE OF A 1/2" DIAMETER SPHERE.
- CHANGES IN ELEVATION SHALL NOT EXCEED 1/4" MAX

DETECTABLE WARNINGS, DRAINS OR GRATES ARE NOT PERMITTED TO BE PLACED IN OR ON EVCS ENLARGE PARKING SPACE OR ADJACENT ACCESS AISLE SURFACES. WHEN USED ON ACCESSIBLE ROUTES CROSSING HAZARDOUS VEHICULAR AREAS OR ON CURB RAMPS. DETECTABLE WARNING TILES SHALL CONFORM TO PUBLIC WORKS STANDARD 102,859, SHEET RX-6. WHERE SHOWN IN DRAWINGS, DETECTABLE WARNINGS SHALL BE EMBEDDED COMPOSITE CONCRETE PANELS. SURFACE MOUNTED PANELS ARE NOT PERMITTED UON.

DAC APPROVED R06 2019.08.01


TYPE B - EV CHARGING STATION

PROTECTIVE

VEHICULAR ROUTE TO AND FROM TYPE A AND B ENLARGED SPACES ARE REQUIRED TO BE 98" CLEAR. THE ACCESSIBLE ROUTE LEADING TO AND FROM ACCESS AISLES TO BUILDING AND FACILITY ENTRANCES, OR DESIGNATED ROUTE TO EXITS. SHALL BE 80" MAX CLEAR.

E. PAVING MATERIAL


- TYPE A AND B EVCS ENLARGED PARKING SPACES AND THEIR ADJACENT ACCESS AISLES SHALL BE CONCRETE PAVING. CONSTRUCTION DETAILS INCLUDING REINFORCING ARE SHOWN ELSEWHERE ON DRAWINGS.
- SIGNS AND PAVEMENT MARKINGS
 - EVCS PARKING SPACES SHALL BE IDENTIFIED BY THE SIGN IN DETAIL FIVE.
- WHERE FOUR OR FEWER TOTAL EVCS ARE PROVIDED. IDENTIFICATION WITH THE INTERNATIONAL SYMBOL OF ACCESSIBILITY (ISA) AND SIGNS IDENTIFYING VAN ACCESSIBLE SPACES SHALL NOT BE REQD. WHEN REQD THE ISA GRAPHIC AND "VAN ACCESSIBLE" TEXT MAY APPEAR ON THE SAME EV SIGN PANEL OR SHALL BE MOUNTED ON A WALL SURFACE, POLE OR HUNG FROM OVERHEAD STRUCTURE. ISA SIGN IS NOT REQUIRED AT FLEET EV CHARGING SPACES BYT IS REQUIRED AT EV PARKING SPACES PER CBC 11B.
- EVCS ENLARGED PARKING SPACE AND ADJACENT ACCESS AISLE PAVEMENT MARKINGS SHALL BE THERMOPLASTIC MATERIALS. STANDARD SIZES AND GRAPHICS ARE SHOWN IN DETAILS. TECHNICAL CRITERIA FOR MATERIALS ARE LOCATED IN SPECIFICATIONS.
- G. ELECTRIC VEHICLE CHARGERS AT ENLARGED EVCS SPACES
 - ELECTRICAL VEHICLE CHARGERS SHALL BE ON ACCESSIBLE ROUTE THAT CONNECTS IT TO THE ENLARGED EVCS PARKING SPACE. IT SHALL NOT BE LOCATED WITHIN THE ENLARGED EVCS SPACE OR ACCESS AISLE AREA.
 - A 30" MIN AND 48" MAX CLEAR FLOOR OR GROUND SPACE SHALL BE LOCATED ADJACENT TO AND CENTERED ON THE OPERABLE CONTROLS SIDE OF THE CHARGING UNIT. OPERABLE PARTS AND CHARGING CORE STORAGE SHALL COMPLY WITH CBC SECTION 11B-309 OPERABLE PARTS. POINT-OF SALES DEVICES SHALL COMPLY WITH TECHNICAL AND PERFORMANCE CRITERIA OF CBC SECTION 11B-812.10.3.

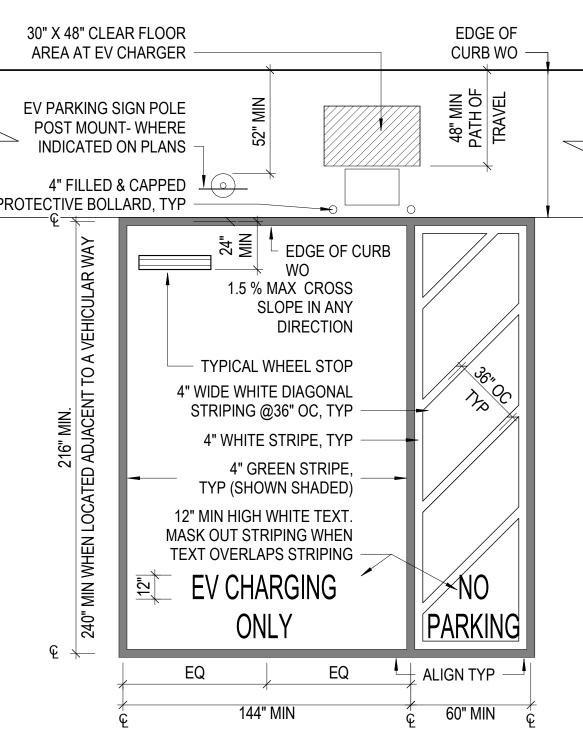

NOTE: TYPE A IS THE FIRST TYPE OF EV PARKING SPACE WHERE 1 TO 4 SPACES ARE PROVIDED.



- A CHARGER MAY SERVE MULTIPLE EVCS SPACES. THE CORD(S) SHALL NOT OBSTRUCT ACCESS AISLE OF ACCESSIBLE ROUTES OR THEIR CLEAR HEIGHTS. CHARGERS UNITS SERVING MORE THAN ONE EVCS SHALL BE ADJACENT TO AND WITHIN THE COMBINED PROJECTED WIDTH OF THE VEHICLE SPACES BEING SERVED.
- WHERE THE LONG DIMENSION OF A VEHICLE SPACE IS PARALLEL TO THE VEHICULAR WAY, THE CHARGER SHALL BE ADJACENT TO AND 48" MAX FROM THE HEAD END OR FOOT END OF THE VEHICLE SPACE OR ITS ACCESS AISLE
- IN ALTERATIONS AT EXISTING FACILITIES WHERE AN ACCESSIBLE ROUTE OR GENERAL CIRCULATION PATH IS NOT PROVIDED ADJACENT TO THE HEAD AND OF THE VEHICLE SPACE OR ACCESS AISLE, THE CHARGER MAY BE LOCATED WITHIN THE PROJECTED WIDTH OF THE ACCESS AISLE 36" MAX FROM THE HEAD END OF THE SPACE.

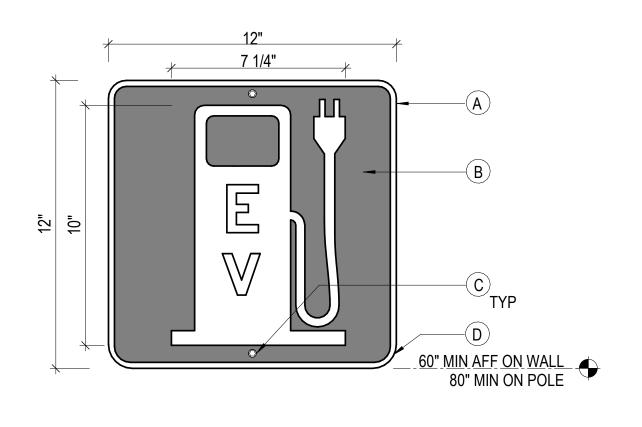

SIGN NOTES FOR VAN EVCS SIGNS:

A. .080" THICK ALUM SIGN B. GRAPHICS PRINTED ON REFLECTED VINYL, BACKGROUND COLOR RAL 6001 - EMERALD GREEN, SURFACED APPLIED TO ALUM PLATE C. 3/8" DIA MOUNTING HOLES

D. 1- 1/2" RADIUS CORNERS


3" = 1'-0"

ELECTRIC VEHICLE WALL OR POLE SIGN

DAC APPROVED R06 2019.08.01

Design Development

11.16.2020

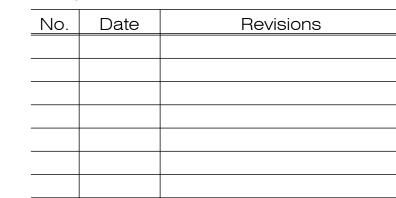

BUREAU OF ARCHITECTURE

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Consultant

M	
	Noah Levy
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	Paul DeFreitas
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	Author
necked	

Drawing Title

ELECTRIC VEHICLE CHARGING STATIONS - ENLARGED PARKING **SPACES**

neet No.		

As indicated Scale: Proiect No.

1804

G3.52

March Marc			GS	S6: S	San Francisco Green Building Submittal Form for Munici	pal Pro	jects		Form version: October 10, 2017 (For permit applications, January 2017 - December 2010)
Part	INS	RUCTIONS:					MUNICIPAL		and the second second second second	
Part	100 March 100 Colonia 100 Colo	- Maria San Maria San San Maria (1985) - Maria (19	icate evidence of fulfillment in t	the References	column.	H				
Maria	4. Atta	ach LEED Scorecard on separate, su	bsequent sheet.		*THAT BEST DESCRIBES YOUR PROJECT *This form includes the requirements of San Francisco Green Building Code and Environment Code Chapter 7. Major	CONSTRUCTION & MAJOR	COMMERCIAL INTERIORS	SMALL PROJECTS		PROJECT NAME
Maria					7 also include Major Alterations as defined by SFGBC, where applicable.	10,000 sq.ft.		10,000 sq.ft.	[[[[[[[[[[[[[[[[[[[BLOCK/LOT
Page		TITLE	SOURCE OF REQUIREMENT	LEED v4 CREDIT	DESCRIPTION OF REQUIREMENT			or any not meeting LEED MPR's	(If not applicable, indicate "N/A".)	ADDRESS
### 1865 ##			Environment Code sec.705		Project is required to achieve sustainability certification listed at right.	CERTIFIED	CERTIFIED, LEED CI	n/r		
	9	Retention/Demolition of	SFGBC 5.104		Enter any applicable point adjustments in box at right.			n/r		PRIMARY OCCUPANCY
Mark 1908	-				Enter current expected LEED score in box at right.			n/r		BUILDING GROSS FLOOR AREA
Part		LEED Scorecard Submittals			Submit LEED Scorecard to Municipal Green Building Task Force at 100% Concept Design and As-Built (LEED Online is acceptable means of submittal).	•	•	= €2		1 550 000 150 7 0
### 1800			Environment Code sec.706		For projects ≥10,000 sq.ft., use products that comply with LEED emissions & content requirements for paints, coatings, adhesives, sealants, flooring, composite wood, ceiling/wall/thermal/acoustic insulation, furniture if part of scope, and exterior applied products if healthcare or school project					
Manufacture	LS.	LOW-EMITTING MATERIALS	OR CALGreen 5.504.4.1-6	EQc2	For projects <10,000 sq.ft., use products that comply with the emission limit requirements of 5.504.4.1-6 for adhesives, sealants, paints, coatings, carpet systems including cushions and adhesives, resilient	LEED EQc2 (3 pts)	LEED EQc2 (3 pts)	5. 504.4.1-6		I understand Environment Code Chapter7
March Marc	TERIA	PVC ELIMINATION	Environment Code sec.509		200 200	•	•	•		requires all applicable projects ≥10,000 square feet to attain LEED Gold certification from USGBC/GBCI. No Green Building Compliance
Mathematical Math	ΜĀ	LEAD ELIMINATION	Environment Code sec.711		Specify no materials containing lead.		•	• 1		Professional of Record is required.
### 1865년 ### 1			Environment Code ch.8		Specify no tropical hardwoods or virgin redwoods.	•	•	•		PROJECT MANAGER (name)
### 14 #	~	INDOOR WATER USE REDUCTION	Code sec.706.	WEp2, WEc2	(1.8gpm); metering faucets (0.2gpc); food waste disposers (1gpm/8gpm). Additionally, for projects ≥10,000 sq.ft., use minimum 30% less potable water as calculated using a baseline with toilets (1.6gpf); urinals (1.0gpf); showerheads (2.5gpm); lavatories (2.2gpm private, 0.5gpm	LEED WEp2, LEED WEc2 (2 pts)		5.303.3		PROJECT MANAGER (sign & date)
March Marc	MATER	NON-POTABLE WATER REUSE	Health Code art.12C	WEc2	New buildings ≥40,000 sq.ft. must calculate a water budget. New buildings ≥250,000 sq.ft. must treat and use available rainwater, graywater, and foundation drainage for toilet and urinal flushing and irrigation.	•	n/r	n/r		1
Marie Mar	>	WATER-EFFICIENT IRRIGATION	Administrative Code ch.63	WEp1, WEc	New construction projects with aggregated landscape area ≥500 sq.ft., or existing projects with modified landscape area ≥1,000 sq.ft., shall use low water use plants or climate appropriate plants, restrict turf areas and comply with Model Water Efficient Landscape Ordinance restrictions by calculated ETAF ≤.45 or by prescriptive compliance for projects with ≤2,500 sq.ft. of landscape area.	•	•	• 8 • 8		PROJECT MANAGER AGENCY
Marie		WATER METERING	CALGreen 5.303.1	WEc4	For area of project, provide submeters for spaces projected to consume >1,000gal/day (or >100gal/day in buildings >50,000 sq.ft.).	•	•	•		NON-LEED PROJECTS
# 160 전 170 전 17		ENERGY EFFICIENCY	Code sec.706,	EAp2, EAc2	For projects ≥10,000 sq.ft., produce a whole-building energy simulation, or follow ASHRAE 50% Advanced Design Guide, or follow Advanced Building Core Performance Guide. Achieve energy use below established baseline by 5% for New Construction, 3% for Major Renovations, 2% for Core & Shell, 3% for Commercial Interiors. Commercial Interiors alternate compliance – reduce lighting power density by 5%	LEED EAp2	LEED EAp2	•		receiving a waiver, or not meeting LEED MPR's
March Property P		ZERO NET ENERGY TARGET	Environment Code sec.706	EAc2	Set target for annual energy consumption. Reporting required to Municipal Green Building Task Force. See Enviornment Regulations for guidance, tools and methods.	•	n/r	n/r		certification because it is <10,000 square feet, does not meet LEED Minimum Program
Section Sect	≿		Environment Code sec.706		Determine feasibility to achieve Zero Net Energy (≤3 stories). Reporting required to Municipal Green Building Task Force. See Environment Regulations for guidance, tools and methods.	•	n/r	n/r		Environment Code Chapter 7 from the Director
Market M	.NER(PV + ENERGY STORAGE BENEFIT/COST ANALYSIS				•	n/r	7.37.43 7.38.		LEED scorecard will be submitted to the Municipal Green Building Task Force at 100%
Part		BETTER ROOFS	Planning Code sec.149, SFGBC div.5.2	various	New buildings with ≤10 floors must designate 15% of roof Solar Ready, per Title 24 rules. Install photovoltaics or solar hot water systems in this area. With Planning Department approval, projects subject to SFPUC Stormwater Requirements may substitute living roof for solar energy systems.	•	n/r			for further LEED documentation or certification.
Companies Comp		RENEWABLE ENERGY	1175 95 95	EAc2, EAc5	New buildings ≥11 floors must acquire renewable onsite energy or achieve 5 points under LEED credit Optimize Energy Performance (EAc2).	•	n/r	n/r		DDO IECT MANACED (nama)
SCYCLE FASCING Promptogenes 1		COMMISSIONING (Cx)	Code sec.706 OR		THE PROPERTY OF THE PROPERTY O		LEED EAp1, LEED EAc1 (4+ pts)	5.410.2-5.410.4.5.1		
Mark	ទ្ធ	BICYCLE PARKING	Planning Code sec.155.1-3, CAL Green 5.106.4	LTc6	Provide short- and long-term bike parking equal to 5% of motorized vehicle parking, or meet SF Planning Code sec.155.1-3, whichever is greater.	•	•	5.106.4		PROJECT MANAGER (Sign & date)
Manual Policy Manual Polic	ARKIN	DESIGNATED PARKING	CALGreen 5.106.5.2	LTc7	If >10 total stalls added, comply with Table 5.106.5.2 (approx. 8% of total spaces).	•	•	•		PROJECT MANAGER AGENCY
Pack	₫.	WIRING FOR EV CHARGING	CALGreen 5.106.5.3	LTc8	Install electrical systems to provide electricity for EV chargers at 6% of spaces or per 5.106.5.3 (installation of chargers is not required.)		n/r			[
Part Column Col	E NO	RECYCLING BY OCCUPANTS	Environment Code sec.707	MRp1	Provide adequate space and equal access for storage, collection and loading of compostable, recyclable and landfill materials.		•	•		I have been retained by the project sponsor
Part	WAST DIVERS	CONSTRUCTION & DEMOLITION (C&D) WASTE MANAGEMENT	Environment Code sec.706, sec.708 & ch.14	MRp2, MRc5	Divert a minimum of 75% of total C&D debris including at least 4 material streams. For 100% of mixed C&D debris use registered transporters and registered processing facilities.	LEED MRp2, LEED MRc5	LEED MRp2, LEED MRc5	75% diversion		that all approved construction documents and construction fulfill the requirements of the San Francisco Green Building Code. It is my
	HVAC	REFRIGERANT MANAGEMENT	CALGreen 5.508.1	EAp4	Use no halons or CFCs in HVAC.	•	•	•		will be met I will notify the Department of Building Inspection if the project will, for any reason, not substantially comply with these
BRD-SAPE BUILDINGS Planning Code sec. 139	- K	LIGHT POLLUTION REDUCTION	CA Energy Code, CALGreen 5.106.8	SSc6	Comply with CA Energy Code for Lighting Zones 1-4. Comply with 5.106.8 for Backlight/Uplight/Glare.		n/r			Building Compliance Professional of Record for the project, or if I am otherwise no longer
TOBACCO SMOKE CONTROL Mealth-Code ant 1948 and 1948 an	GHBC	BIRD-SAFE BUILDINGS	90000 00 5944 049 20000 c	pilot credit	Glass facades and bird hazards facing and/or near Urban Bird Refuges may need to treat their glass for opacity.	•	•	•		
STORMWATER CONTROL PLAN PUBLIC Works Code air. 4.2 sec.146 CONSTRUCTION SITE RUNOFF Public Works Code air. 4.2 sec.146 SSp1 Submit a construction site Erosion and Sedimentation Control Plan to SFPUC for approval. ### ACOUSTICAL CONTROL AIR FILTRATION (CONSTRUCTION) CALGreen 5.507.4.1.3 EQc3 Seal permanent HVAC ducts/equipment stored onsite before installation. AIR FILTRATION (COENTRUCTION) CALGreen 5.504.1.3 EQc3 Seal permanent HVAC ducts/equipment stored onsite before installation. AIR FILTRATION (COENTRUCTION) CALGreen 5.504.1.3 EQc3 Seal permanent HVAC ducts/equipment stored onsite before installation. AIR FILTRATION (COENTRUCTION) CALGreen 5.504.1.3 EQc3 Seal permanent HVAC ducts/equipment stored onsite before installation. AIR FILTRATION (COENTRUCTION) CALGreen 5.504.1.3 EQc3 Seal permanent HVAC ducts/equipment stored onsite before installation. AIR FILTRATION (COENTRUCTION) CALGreen 5.504.1.3 EQc3 Seal permanent HVAC ducts/equipment stored onsite before installation. Provide MERV-8 filters on HVAC for regularly occupied, actively ventilated spaces. Environment Code sec.706 EQc3 During construction, meet SMACNA IAQ guidelines, provide MERV-8 filters on all HVAC. LEED EQc1 (1 pt) LEED EQc3 LEED EQc3 LEED EQc3 LEED EQc3 A// AFFIX STAMP BELOW: AFFIX STAMP BE	NE	TOBACCO SMOKE CONTROL	Health Code art.19F & art.19I, CALGreen 5.504.7	EQp2	Prohibit smoking within 25 feet of building entries, air intakes, and operable windows.	•	•	1 ⊕ N		
CONSTRUCTION SITE RUNOFF Public Works Code at 14.2 sec. 146 SSp1 Submit a construction site Erosion and Sedimentation Control Plan to SFPUC for approval. ### ACOUSTICAL CONTROL ACOUSTICAL CONTROL COLGreen 5.507.4.1-3 EQG: Comply with sound transmission limits (STC-50 exteriors near freeways/airports; STC-45 exteriors if 65db Leq at any time; STC-40 interior walls/floor-ceilings between tenants). ACOUSTICAL CONTROL AIR FILTRATION COLGreen 5.504.1-3 EQG: Seal permanent HVAC ducts/equipment stored onsite before installation. AIR FILTRATION CONSTRUCTION): CALGreen 5.504.5.3 Provide MERV-8 filters on HVAC for regularly occupied, actively ventilated spaces. Provide MERV-8 filters on HVAC for regularly occupied, actively ventilation, mixed-mode requirements. EDG: CONSTRUCTION IAQ MANAGEMENT PLAN Environment Code sec.706 EQG: During construction, meet SMACNA IAQ guidelines; provide MERV-8 filters on all HVAC.	UTION	STORMWATER CONTROL PLAN		SSc4		if applicable	if applicable	if applicable		(sign & date)
ALR FILTRATION (CONSTRUCTION) CALGreen 5.504.1-3 EQ3 Seal permanent HVAC ducts/equipment stored onsite before installation. AIR FILTRATION (OPERATIONS) CALGreen 5.504.5-3 Provide MERV-8 filters on HVAC for regularly occupied, actively ventilated spaces. ENHANCED IAQ STRATEGIES Environment Code sec.706 EQc1 Comply with entry, cross-contamination, filtration, natural ventilation, mixed-mode requirements. LEED EQc1 (1 pt) LEED EQc1 (1 pt) n/r CONSTRUCTION IAQ MANAGEMENT PLAN Environment Code sec.706 EQc3 During construction, meet SMACNA IAQ guidelines; provide MERV-8 filters on all HVAC.	POLL PREVE	CONSTRUCTION SITE RUNOFF	Public Works Code art.4.2 sec.146	SSp1	Submit a construction site Erosion and Sedimentation Control Plan to SFPUC for approval.	if project disturbs ≥5,000 sq.ft.	if project disturbs ≥5,000 sq.ft.	if project disturbs ≥5,000 sq.ft.		ALTIA GIAMI BELOW.
AR FILTRATION (OPERATIONS) ENHANCED IAQ STRATEGIES Environment Code sec.706 EQ.3 Seal permanent RVAC ducts/requipment stored on site before installation. Provide MERV-8 filters on HVAC for regularly occupied, actively ventilated spaces. ENHANCED IAQ STRATEGIES Environment Code sec.706 EQ.3 Comply with entry, cross-contamination, mixed-mode requirements. LEED EQ.1 (1 pt) LEED EQ.3 LEED EQ.3 I.EED EQ			CALGreen 5.507.4.1-3	EQc9	Comply with sound transmission limits (STC-50 exteriors near freeways/airports; STC-45 exteriors if 65db Leq at any time; STC-40 interior walls/floor-ceilings between tenants).	•	limited to envelope alterations & additions	•		
CONSTRUCTION IAQ MANAGEMENT PLAN Environment Code sec.706 EQc3 During construction, meet SMACNA IAQ guidelines; provide MERV-8 filters on all HVAC.	, AL	AIR FILTRATION (CONSTRUCTION)	CALGreen 5.504.1-3	EQc3	Seal permanent HVAC ducts/equipment stored onsite before installation.	•	•	•)		
ENHANCED IAQ STRATEGIES Environment Code sec. 706 EQC1 Comply with entry, cross-contamination, filtration, mixed-mode requirements. CONSTRUCTION IAQ MANAGEMENT PLAN Environment Code sec. 706 EQC3 During construction, meet SMACNA IAQ guidelines; provide MERV-8 filters on all HVAC. LEED EQC3 LEED EQC3 n/r	MENT TT.	AIR FILTRATION (OPERATIONS)	CALGreen 5.504.5.3		Provide MERV-8 filters on HVAC for regularly occupied, actively ventilated spaces.	•	•	•/:		
MANAGEMENT PLAN Environment Code sec. 706 EQCS During construction, meet smacha lad guidelines, provide wierv-8 liners on all hvac.	INDC	ENHANCED IAQ STRATEGIES	Environment Code sec.706	EQc1	Comply with entry, cross-contamination, filtration, natural ventilation, mixed-mode requirements.	LEED EQc1 (1 pt)	LEED EQc1 (1 pt)	n/r		
	EN	CONSTRUCTION IAQ MANAGEMENT PLAN	Environment Code sec.706	EQc3	During construction, meet SMACNA IAQ guidelines; provide MERV-8 filters on all HVAC.	LEED EQc3	LEED EQc3	n/r		
		IAQ ASSESSMENT	Environment Code sec.706	EQc4	Before occupancy, test air quality for particulates, ozone, CO, and all listed VOCs.	LEED EQc4 (2 pts)	LEED EQc4 (2 pts)	n/r		

BUREAU OF ARCHITECTURE



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Golden Gate Park Golf Clubhouse

970 47th Avenue San Francisco, CA 94121

Consultant

11.16.2020 Revisions

Checked

Drawing Title

LEED CHECKLIST

G 1.30

Project No.



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Golden Gate Park Golf Clubhouse

970 47th Avenue San Francisco, CA 94121

Consultant

No. Date Revisions

Checked


11.16.2020

Drawing Title

TITLE-24 FORMS

G 1.40

Project No.

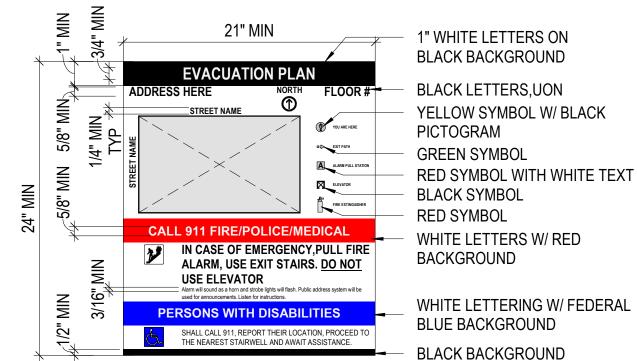


EVACUATION SIGN NOTES:

- 1. ALL EVAC SIGNS SHALL COMPLY W/ SFFD ADMIN BULLETIN 2.11 AND BE SUBMITTED BY A CONTRACTOR AS A SEPARATE PERMIT.
- 2. REVIEW BULLETIN FOR ALL SYMBOLS AND COLORS NOT REPRESENTED IN
- DRAWING ABOVE SUCH AS STAIRS, EXIT SYMBOL AND 'AREA OF REFUGE'.

 4. FLOOR PLAN SYMBOLS SHALL HAVE A MIN WIDTH, HEIGHT, DIAMETER OF 1/2".
- LEGEND SYMBOLS SHALL HAVE A MIN WIDTH, HEIGHT, AND DIAMETER OF 5/8".
 1/16" LINE THICKNESS FOR PLAN, EXIT STAIRS, & ELEVATORS.
- 7. SIGNS SHALL BE INSTALLED WITH CORRECT ORIENTATION AS VIEWED FROM OCCUPANTS PERSPECTIVE.

1 EMERGENCY EVACUATION SIGN 1 1/2" = 1'-0" DAC APPROVED RO

DAC APPROVED **R06** 2019.08.01

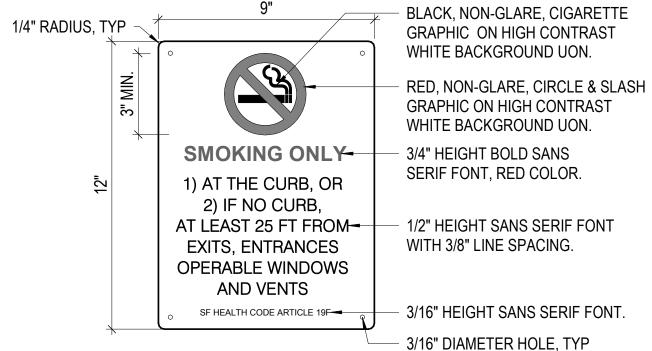

NO SMOKING SIGN NOTES:


- 1. USE STAINLESS STEEL VANDAL RESISTANT FASTENERS.
- MOUNT SIGN WITHIN 10 FEET OF EACH ENTRANCE.
- . POST 5'-0" MIN. AND 8'-0" MAX AFF.
- CHARACTERS AND BACKGROUND CONTRAST BLACK ON WHITE. USE THE FOLLOWING COLORS:

WHITE: WHITE COLOR NO. 17875 IN FEDERAL STANDARD 595B. RED: RED COLOR NO. 21105 IN FEDERAL STANDARD 595C. BLACK: NO. 17038 IN FEDERAL STANDARD 595B.

- TEXT FORMAT IS HORIZONTAL.
- 1" CLEARANCE AROUND ALL BORDERS BETWEEN EDGE OF SIGN.
 AND CHARACTERS OR NON SMOKING GRAPHIC.

NO SMOKING SIGN

DAC CUSTOM 2019.08.01

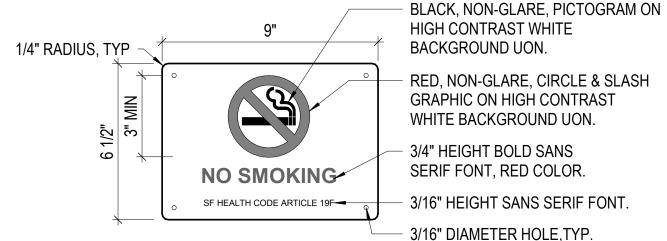

NO SMOKING SIGN NOTES:

- 1. USE STAINLESS STEEL VANDAL RESISTANT FASTENERS.
- . MOUNT SIGN WHERE NOTED ON DRAWINGS.
- 3. POST 5'-0" MIN AND 8'-0" MAX AFF.
- CHARACTERS AND BACKGROUND CONTRAST BLACK ON WHITE.
 USE THE FOLLOWING COLORS:

WHITE: WHITE COLOR NO. 17875 IN FEDERAL STANDARD 595B.
RED: RED COLOR NO. 21105 IN FEDERAL STANDARD 595C.
BLACK: NO. 17038 IN FEDERAL STANDARD 595B.

- TEXT FORMAT IS HORIZONTAL.
- 6. 1" CLEARANCE AROUND ALL BORDERS BETWEEN EDGE OF SIGN. AND CHARACTERS OR NON SMOKING GRAPHIC.

NO SMOKING SIGN - SECONDARY

3" = 1'-0"

DAC CUSTOM 2019.08.01

Original Sheet Size: 22"x34"

BUREAU OF ARCHITECTURE



Ron Alameida - City Architect

Julia Laue - Principal Architect / Bureau Manager


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Consultant

11.16.2020



PM

Noah Levy
PA

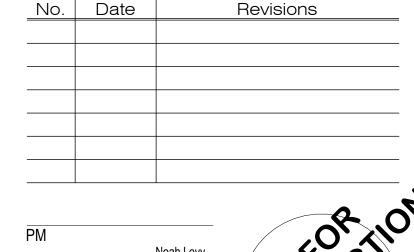Paul DeFreitas

Drawn

Author

Checked

Drawing Title

MISCELLANEOUS SIGNAGE

Sheet No.

G 3.13

As indicated

Project No.

1804

Scale:

LANDSCAPE GENERAL NOTES AND ABBREVIATIONS & INDEX

GENERAL NOTES

ALL WORK SHALL BE COMPLETED IN A THOROUGH AND WORKMANLIKE MANNER.

ALL WORK TO BE PERFORMED SHALL CONFORM TO ALL APPLICABLE CODES AND ORDINANCES OF GOVERNMENTAL AGENCIES HAVING JURISDICTION OVER THE PROJECT.

PROTECT ALL UTILITIES, IMPROVEMENTS, STRUCTURES AND STREET CURB/SIDEWALK AND RESTORE TO NEW CONDITION AT NO ADDITIONAL COST TO THE CITY IF DAMAGED DURING THE COURSE OF WORK.

COORDINATE ALL WORK TO PREVENT CONFLICTS BETWEEN TRADES AND REPORT CONFLICTS OR INCONGRUITIES BETWEEN NEW IMPROVEMENTS AND/OR EXISTING FACILITIES TO THE CITY REPRESENTATIVE IMMEDIATELY.

THE CONTRACTOR IS RESPONSIBLE FOR THE COORDINATION AND INSTALLATION OF ALL PLUMBING AND ELECTRICAL ITEMS TO BE INSTALLED AS A PART OF THIS WORK.

CLEAR AND REMOVE ALL ORGANIC MATTER, DEBRIS AND RUBBISH FROM WITHIN THE LIMIT OF WORK. CONTRACTOR SHALL DISPOSE OF SAID MATERIAL IN A LEGAL MANNER AS HIS PROPERTY.

IN ADDITION TO THESE DRAWINGS, REFER TO CCSF STANDARD SPECIFICATIONS.

DEMOLITION NOTES

PROTECT ALL SITE ELEMENTS TO REMAIN.

PROVIDE CONSTRUCTION FENCING AT LIMIT OF WORK LINE THROUGHOUT CONSTRUCTION PERIOD. SEE SPEC # 015000 FOR MORE INFORMATION.

ALL MATERIALS SHALL BE DISPOSED OF IN A LEGAL MANNER AS CONTRACTOR'S PROPERTY.

PRIOR TO THE COMMENCEMENT OF WORK, A THOROUGH SITE REVIEW OF ALL EXISTING PLANT MATERIAL DESIGNATED TO BE REMOVED SHALL BE CONDUCTED WITH THE LANDSCAPE ARCHITECT. OBTAIN AUTHORIZATION FROM LANDSCAPE ARCHITECT AND RECREATION AND PARK STAFF PRIOR TO DEMOLITION OF ANY EXISTING PLANT MATERIAL

LAYOUT NOTES

VERIFY ALL DIMENSIONS IN THE FIELD PRIOR TO BEGINNING CONSTRUCTION AND REPORT ANY DISCREPANCIES TO THE CITY REPRESENTATIVE PRIOR TO PROCEEDING.

WRITTEN DIMENSIONS ON DRAWINGS SUPERSEDE SCALE DIMENSIONS.

ALL DIMENSIONS ARE TO BE MEASURED HORIZONTALLY.

VERIFY LOCATION AND ELEVATIONS OF UTILITY VAULTS AND OTHER COVERS AND REPORT ANY CONFLICTS OR DISCREPANCIES TO THE CITY REPRESENTATIVE.

PLACE EXPANSION JOINTS WHERE ALL HORIZONTAL PAVING ABUTS A VERTICAL SURFACE AND AS SHOWN ON PLANS. JOINTS SHALL BE 3/8" PRE-MOLDED ASPHALTIC FIBER MATERIAL.

THE CONTRACTOR SHALL STAKE ALL PAVED AREAS AND FOOTINGS FOR REVIEW BY THE CITY REPRESENTATIVE BEFORE FINAL CONSTRUCTION.

GRADING NOTES

VERIFY ALL GRADES IN THE FIELD BEFORE PROCEEDING WITH WORK, INCLUDING EXISTING IMPROVEMENTS; LOCATIONS AND ELEVATIONS OF AREA DRAINS.

EXISTING GRADES SHOWN ARE APPROXIMATE AND SHALL BE FIELD VERIFIED. ALL DISCREPANCIES SHALL BE REPORTED TO THE CITY REPRESENTATIVE IMMEDIATELY.

THE CONTRACTOR SHALL BE RESPONSIBLE FOR POSITIVE SURFACE DRAINAGE IN ALL PAVING AND PLANTING AREAS. ALL GROUND SURFACES SHALL BE FINISHED TO A SMOOTH AND CONTINUOUS GRADE, DRAINING AND FREE OF STANDING WATER.

PROVIDE A SMOOTH TRANSITION BETWEEN EXISTING AND NEW GRADES IN PLANTING AREAS. WHERE NEW PAVEMENT ABUTS NEW PAVEMENT, FINISH GRADES SHALL BE FLUSH, UNLESS OTHERWISE NOTED. EASE TOP AND TOE OF ALL SLOPES TO PROVIDE SMOOTH TRANSACTIONS BETWEEN GROUND PLANES.

THE CITY REPRESENTATIVE RESERVES THE RIGHT TO MAKE ADJUSTMENTS IN THE FINISHED GRADES AS THE WORK PROGRESSES.

ELEVATIONS ARE BASED ON CITY AND COUNTY OF SAN FRANCISCO DATUM, UNLESS OTHERWISE NOTED.

PLANTING NOTES

SEE STANDARD SPECIFICATIONS, SECTION 32 90 00 "PLANTING", FOR ADDITIONAL PLANTING INFORMATION.

CONTRACTOR SHALL REVIEW ALL PLANT MATERIAL ON SITE WITH CITY REPRESENTATIVE AND SHALL INSTALL MATERIAL ONLY AFTER OBTAINING APPROVAL FROM THE CITY REPRESENTATIVE. LOCATIONS SHOWN ON PLANS ARE DIAGRAMMATIC ONLY.

THE CITY REPRESENTATIVE RESERVES THE RIGHT TO MAKE SUBSTITUTIONS, LAYOUT CHANGES AND DELETIONS IN THE PLANTING SCHEME AS THE WORK PROGRESSES.

UNLESS OTHERWISE NOTED, ALL GROUNDCOVER AND SHRUBS SHALL BE SPACED TRIANGULARLY.

ALL NEWLY PLANTED GROUND COVER AND SHRUB AREAS TO RECEIVE 3" MIN. COMPACTED, SHREDDED BARK U.O.N. AND CARDBOARD, SEE SPECIFICATIONS.

RESTORATION OF LANDSCAPE AREAS

RESTORE ALL EXISTING PAVING, WALLS, FENCES, PLANTING DISTURBED BY UTILITY TRENCHING, TREE REMOVAL, OR STAGING AREA TO PRECONSTRUCTION CONDITION AS DIRECTED BY THE CITY REPRESENTATIVE.

RESTORE ALL DISTURBED LANDSCAPE AREAS WITHIN THE LIMIT OF WORK AND ALL LANDSCAPE AREAS DISTURBED BY CONSTRUCTION ACTIVITIES AND STAGING, AS FOLLOWS: THE DISTURBED LANDSCAPE AREAS SHALL BE WEEDED, CULTIVATED, FINE GRADED FLUSH TO ADJACENT FINISH GRADE WITH NO VOIDS, DEPRESSIONS OR MOUNDS, PLANTED AND MAINTAINED THROUGHOUT THE CONSTRUCTION PERIOD.

THE CITY REP. IN COORDINATION WITH RECREATION & PARK STAFF SHALL INSPECT THE PREPARATION OF DISTURBED LANDSCAPE AREAS PER THESE NOTES AND THE CONTRACTOR SHALL MAKE ADJUSTMENTS AS DIRECTED BY THE CITY REPRESENTATIVE.

ABBREVIATIONS

AD	AREA DRAIN		
ALIGN.	ALIGNMENT		
BFG	BELOW FINISH GRADE		
CCSF	CITY & COUNTY OF SAN FRANCE	ISCO	
C, E	CENTER LINE		
CB	CATCH BASIN		
CLR.	CLEAR	(N)	NEW
	CONCRETE	N	NORTHING
CONT.	CONTINUOUS	N.I.C.	
C.J.	CONTROL JOINT	NO., #	NUMBER
DIA, Ø	DIAMETER	N.T.S.	NOT TO SCALE
DWG	DRAWING	NKE	NO KNOWN EQUAL
(E)	EXISTING	O.C.	ON CENTER
È	EASTING	O.D.	OUTSIDE DIAMETER
EA	EACH	P.A.	PLANTING AREA
E.F.	EACH FACE	POB	POINT OF BEGINNING
E.J.	EXPANSION JOINT	R, RAD.	RADIUS
EQ	EQUAL	R/R	REMOVE/REPLACE
•	EACH WAY	SD	STORM DRAIN
F.G.	FINISH GRADE	SAD	SEE ARCHITECTURAL DRAWINGS
FOC	FACE OF CURB	SSD	SEE STRUCTURAL DRAWINGS
FOW	FACE OF WALL	SIM.	SIMILAR
	FOOTING	S.J.	SCORE JOINT
	GALVANIZED	SPECS.	SPECIFICATIONS
G.M.		ST.	STREET
JT.	JOINT	TYP.	TYPICAL
L.O.W.	LIMIT OF WORK	U.O.N.	UNLESS OTHERWISE NOTED
MAX.	MAXIMUM	V.I.F.	VERIFY IN FIELD
MIN.	MINIMUM	W/	WITH
MH	MANHOLE		FLUSH OR ALIGNED

LANDSCAPE ARCHITECTURE SHEET INDEX

L0.0	LANDSCAPE NOTES AND ABBREVIATIONS
L1.0	DEMOLITION PLAN
L2.0	LAYOUT & MATERIALS PLAN
L3.0	GRADING PLAN
L4.0	IRRIGATION PLAN
L4.1	IRRIGATION LEGEND & NOTES
L5.0	PLANTING PLAN
L5.1	PLANTING DETAILS
L6.0 - L6.3	CONSTRUCTION DETAILS

BUILDING DESIGN AND CONSTRUCTION DIVISION

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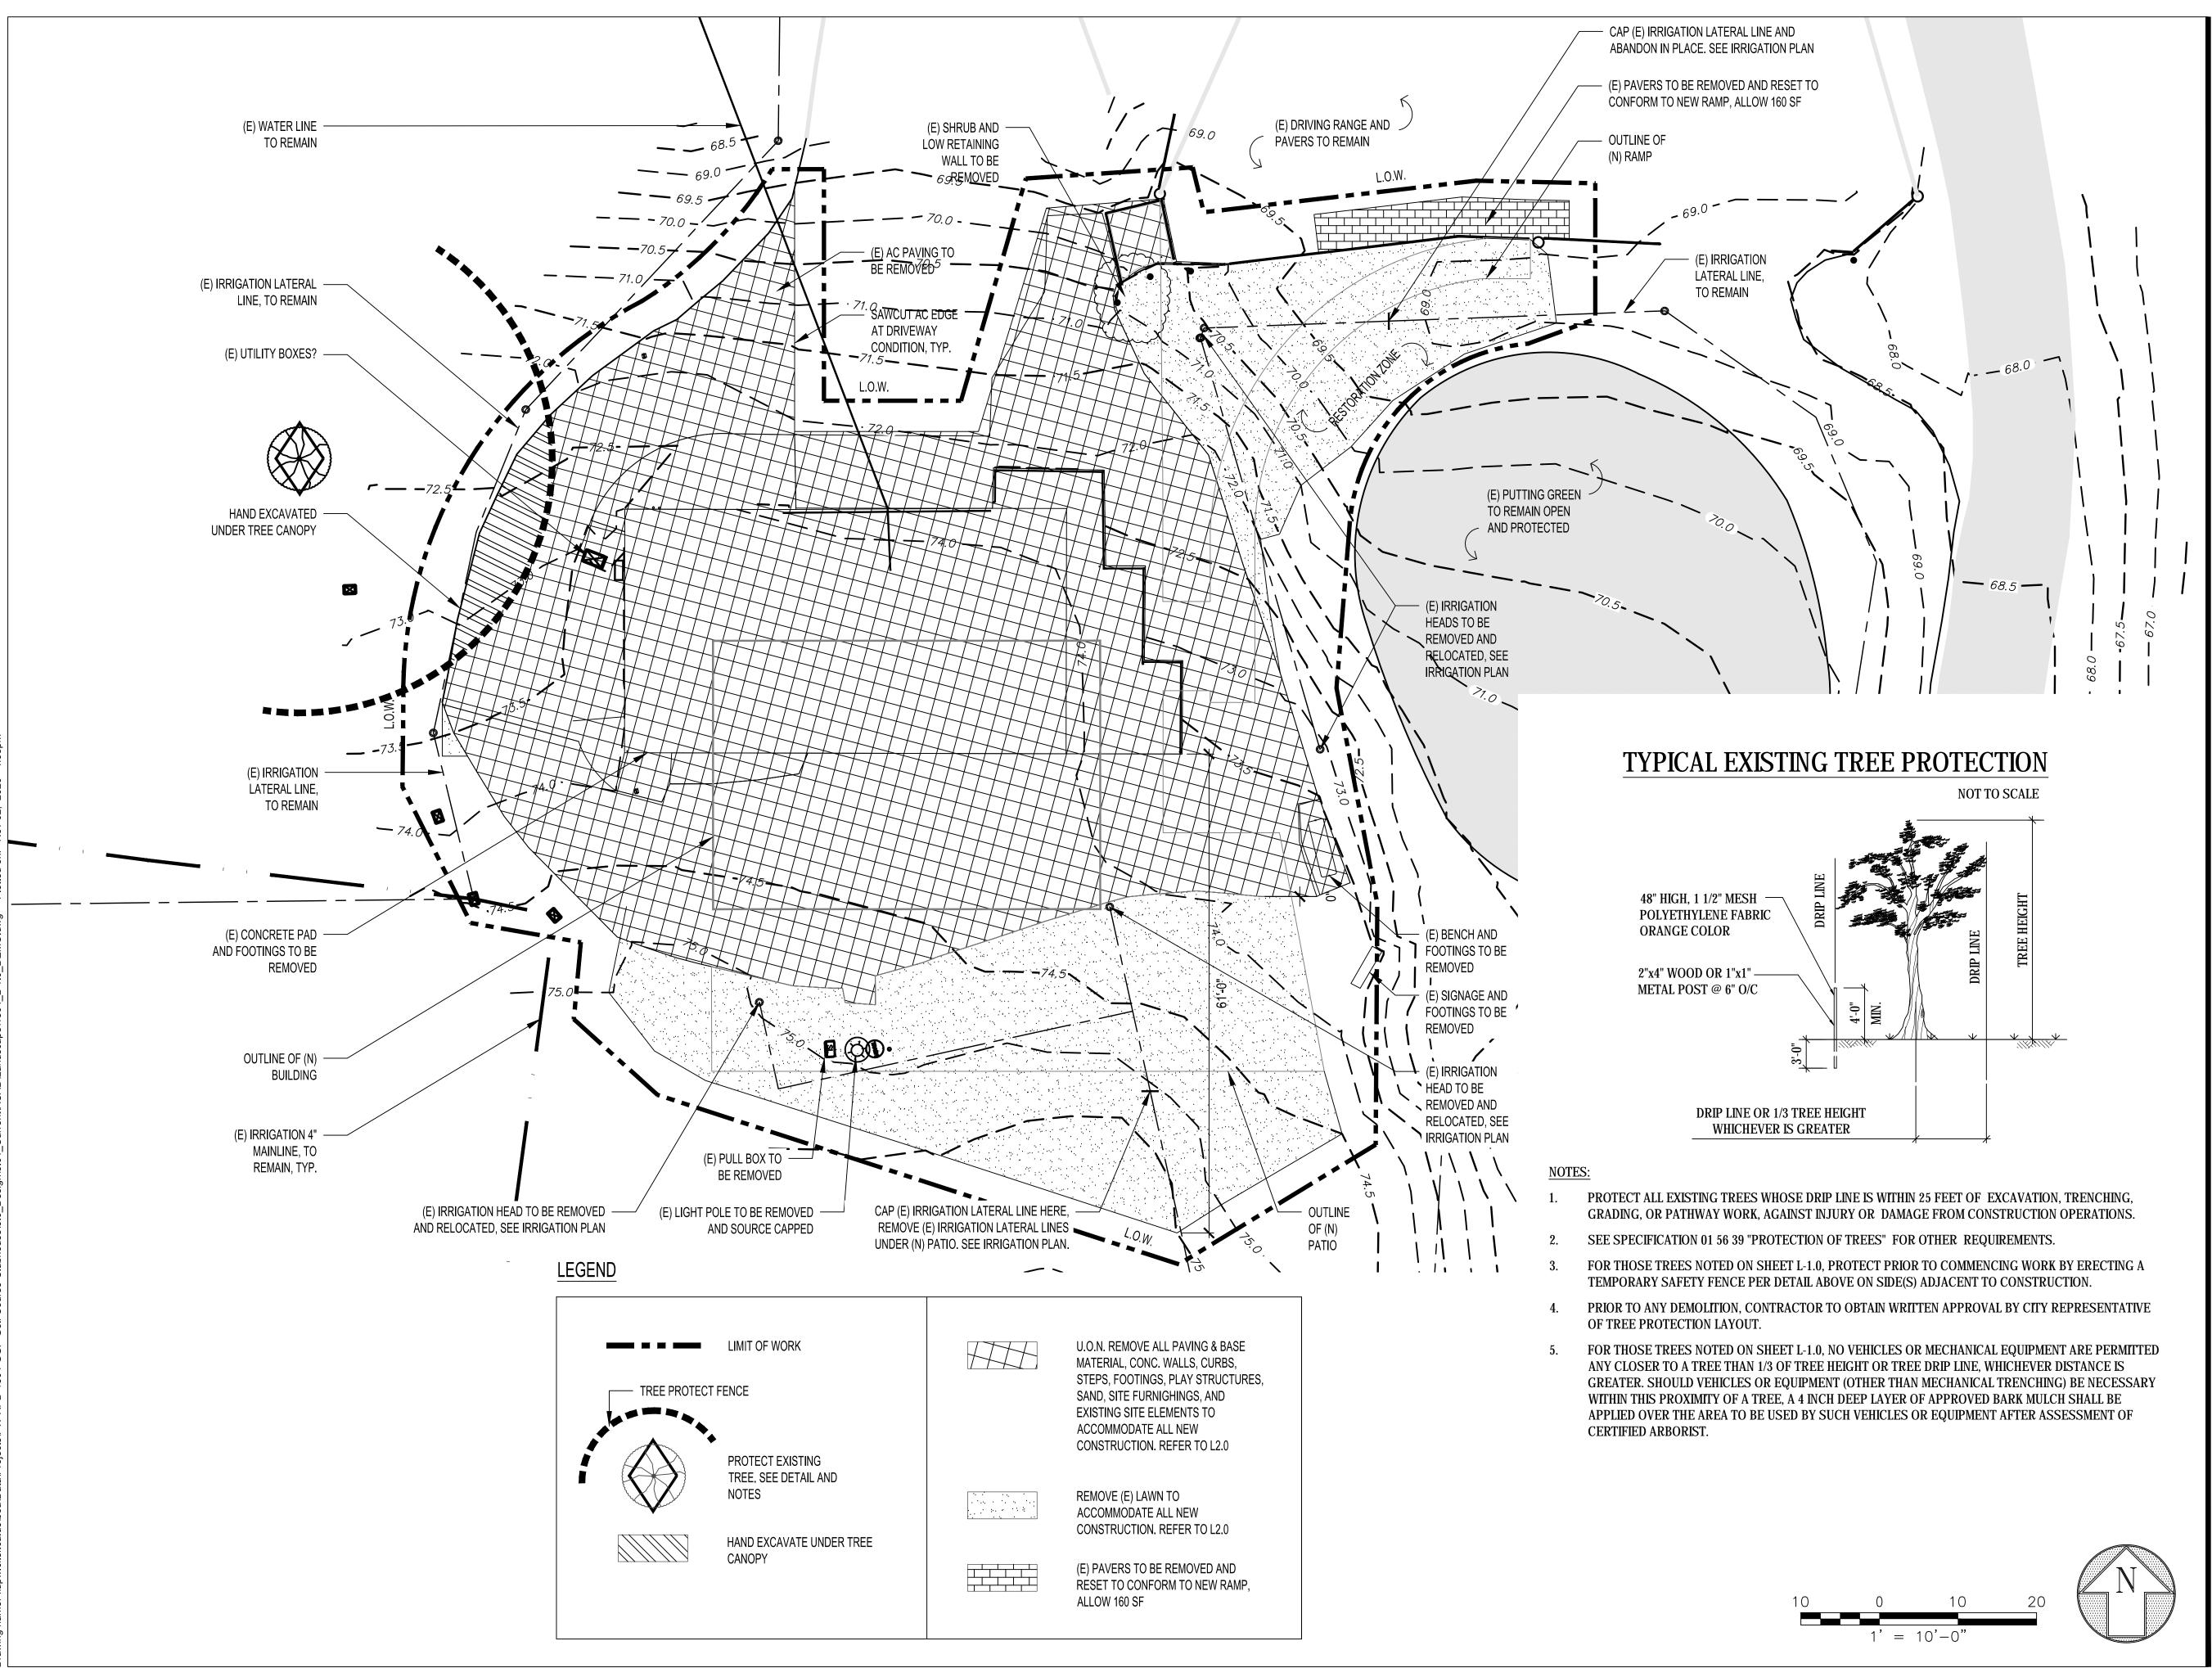
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LANDSCAPE GENERAL NOTES, **ABBREVIATIONS & INDEX**

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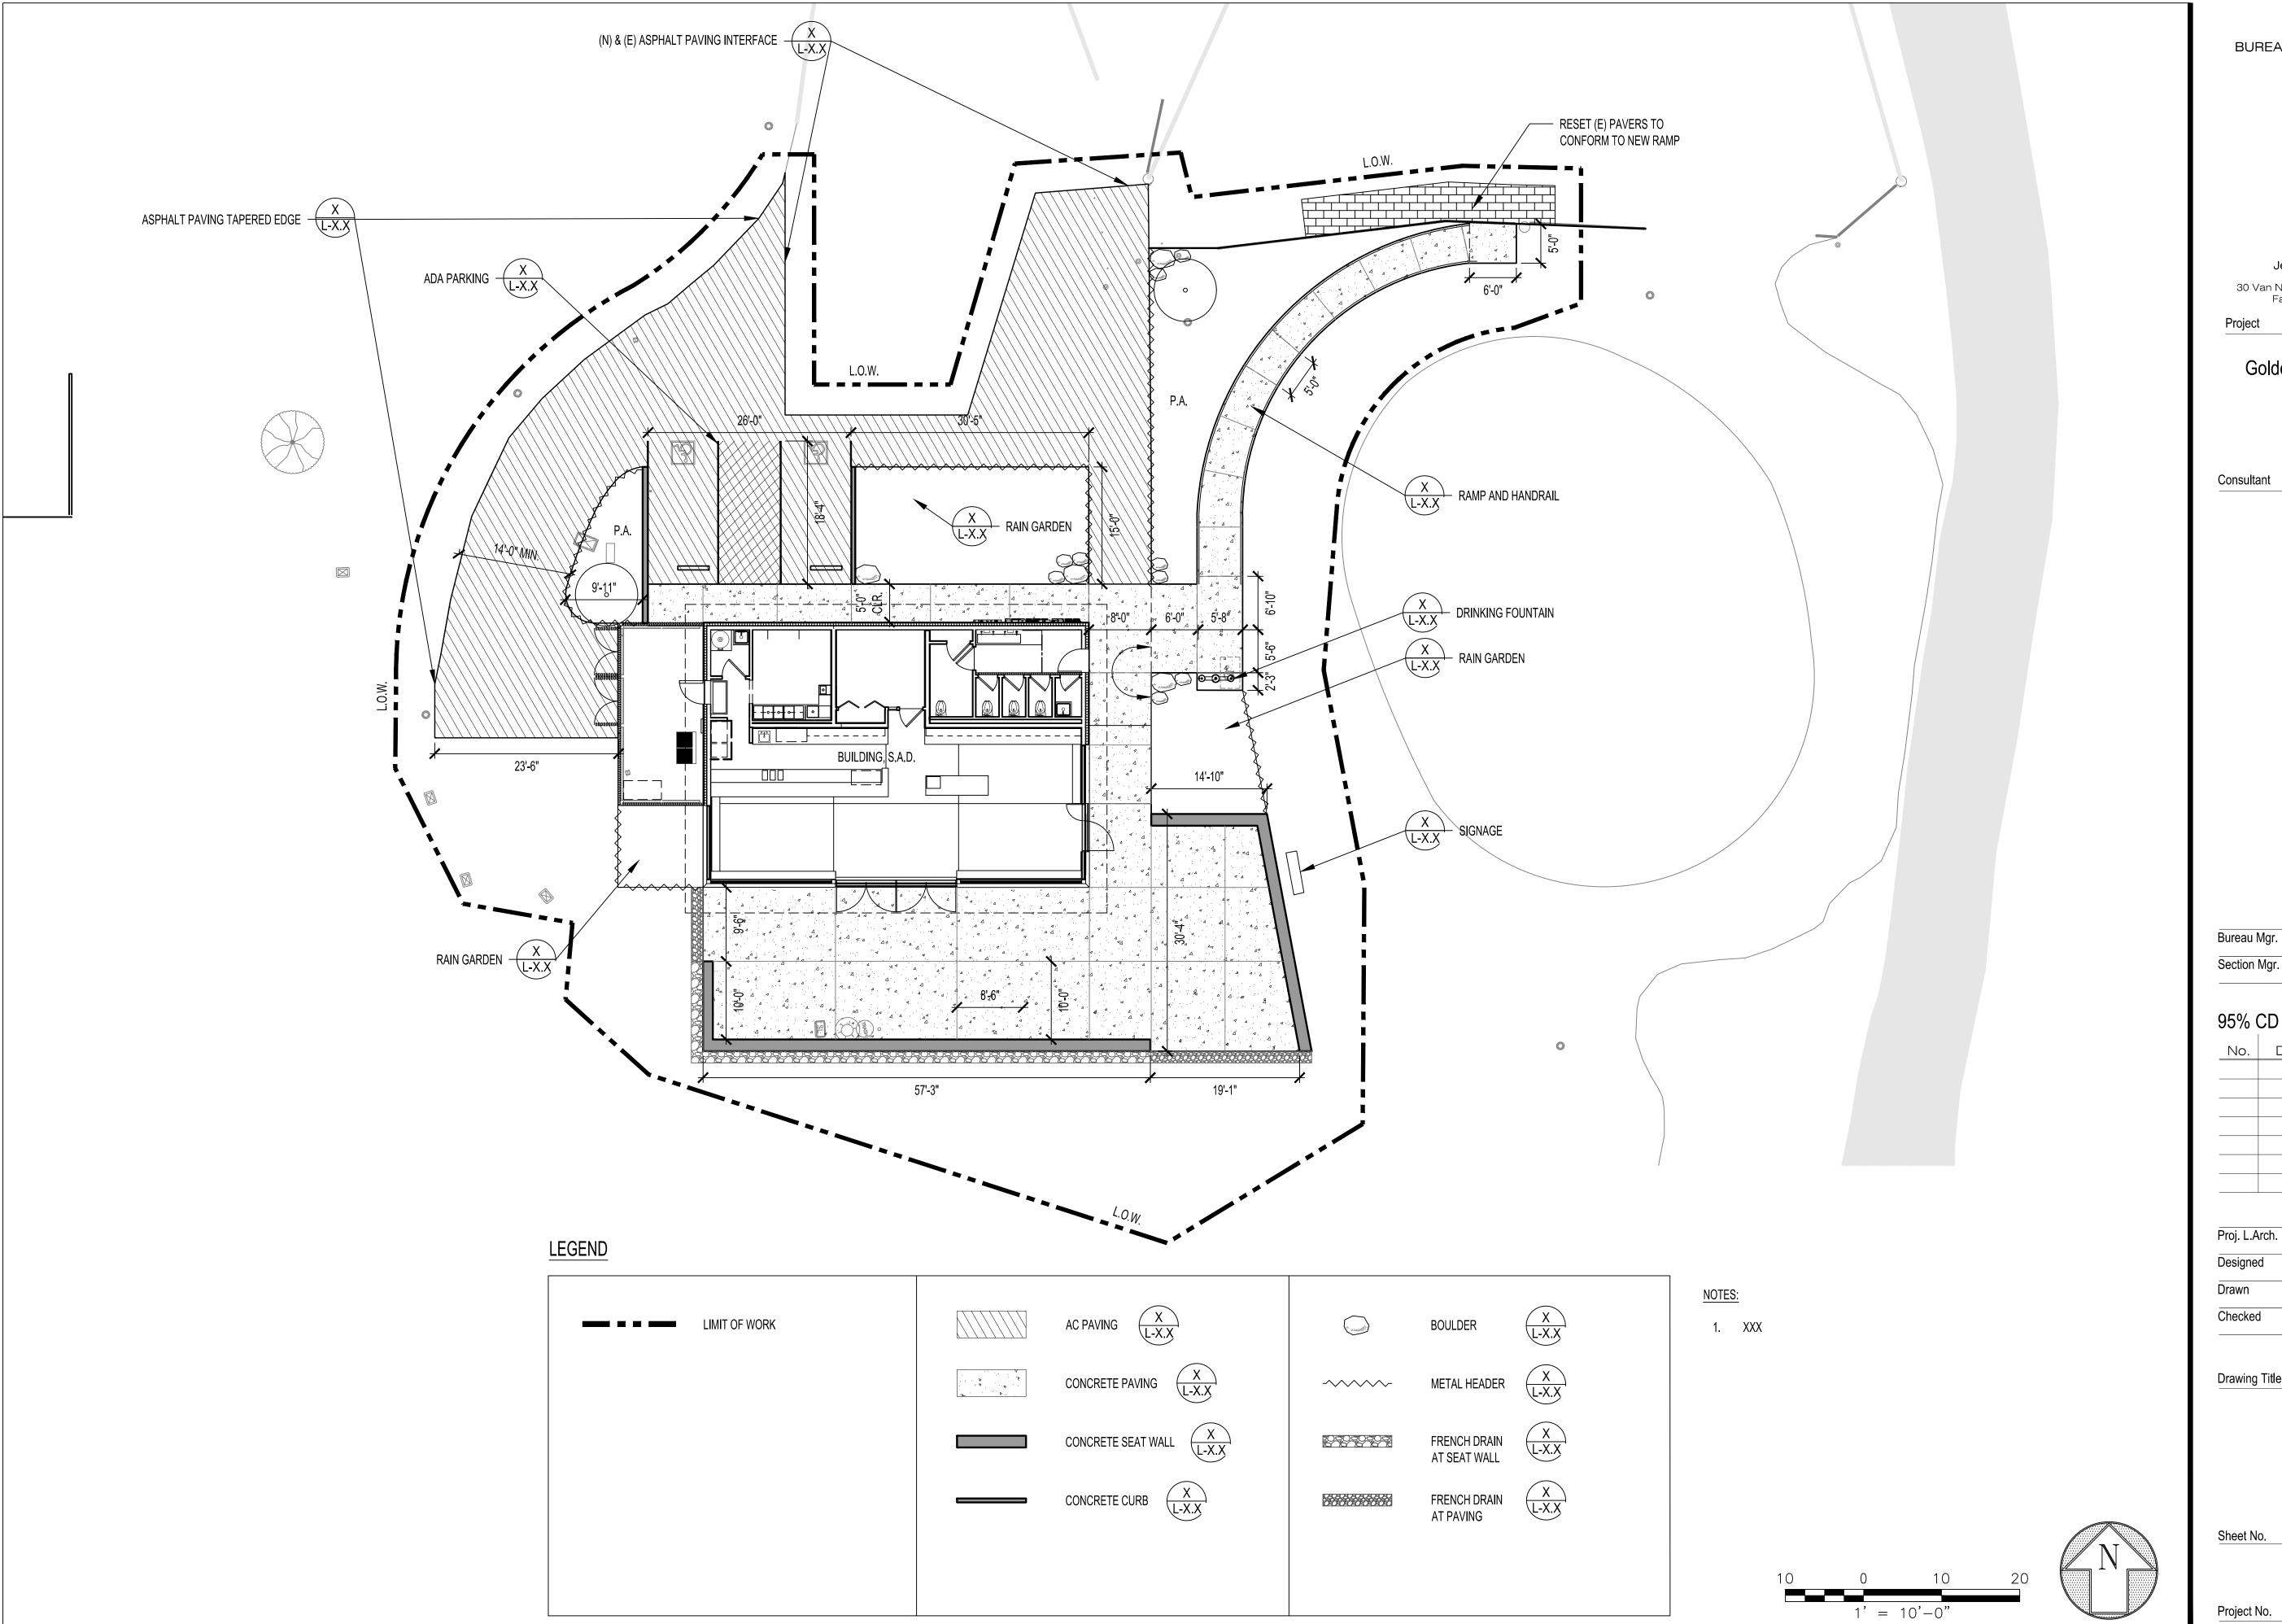
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DEMOLITION PLAN

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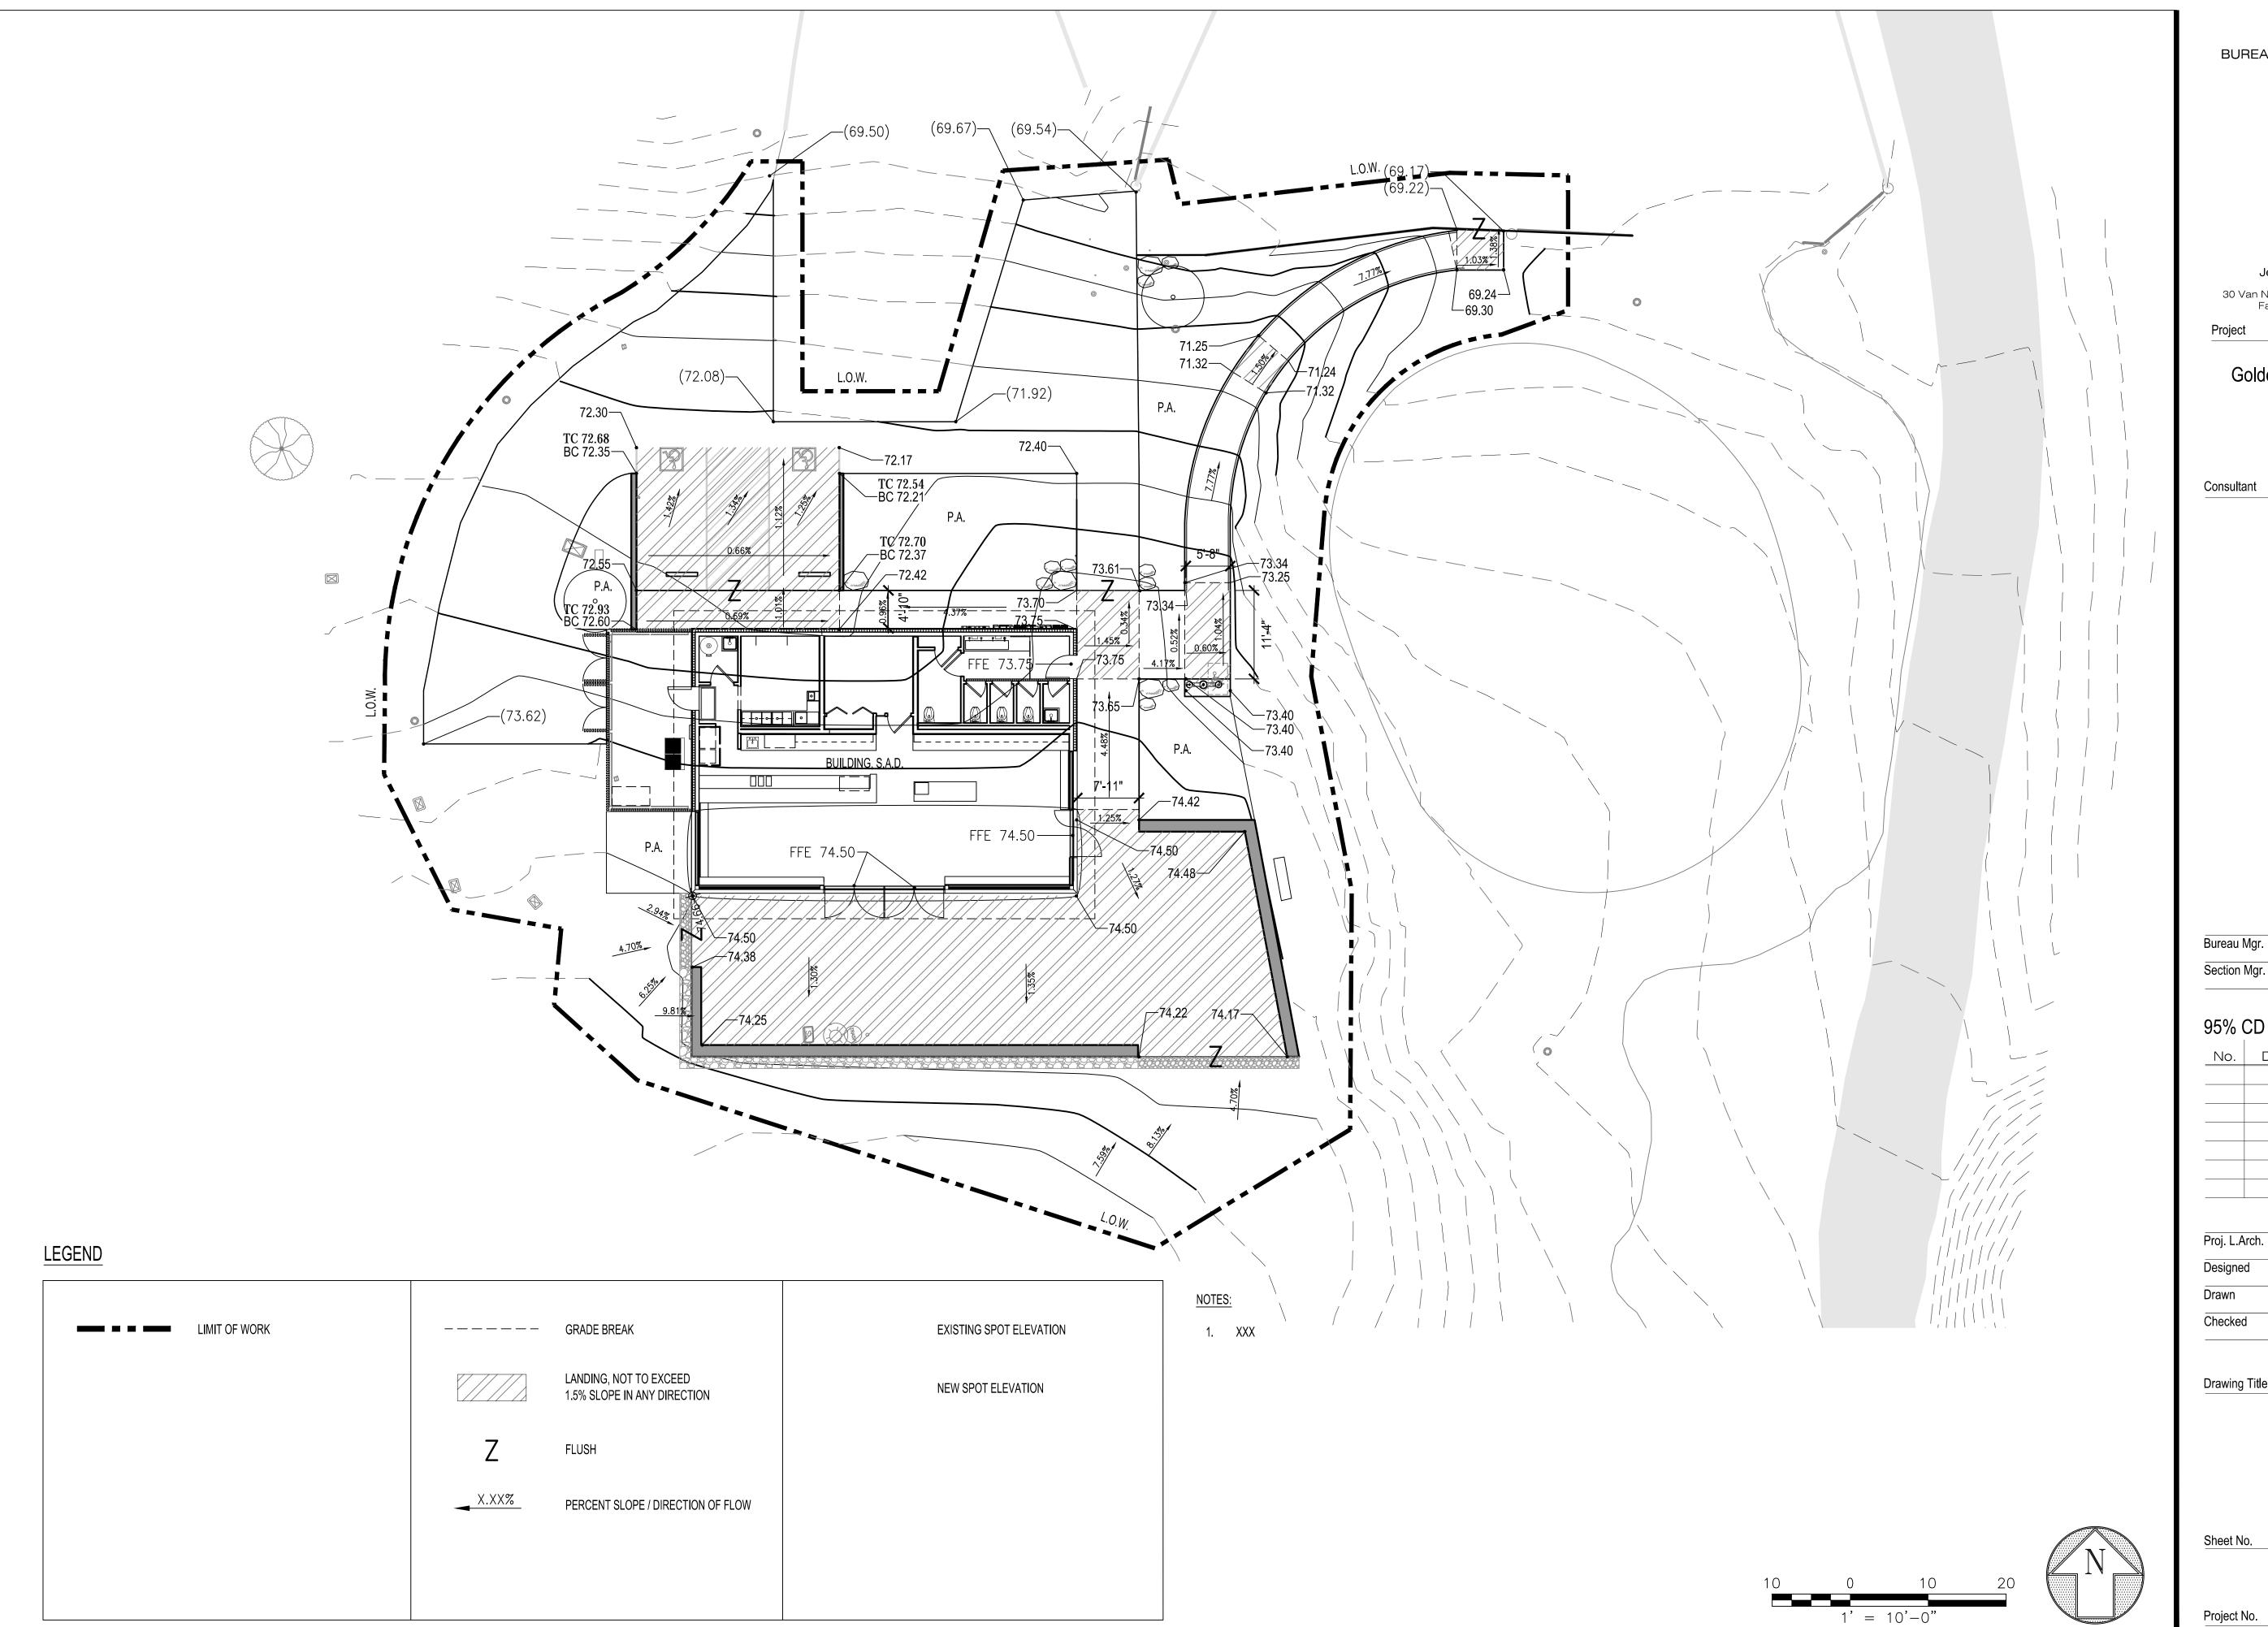
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LAYOUT & MATERIALS PLAN

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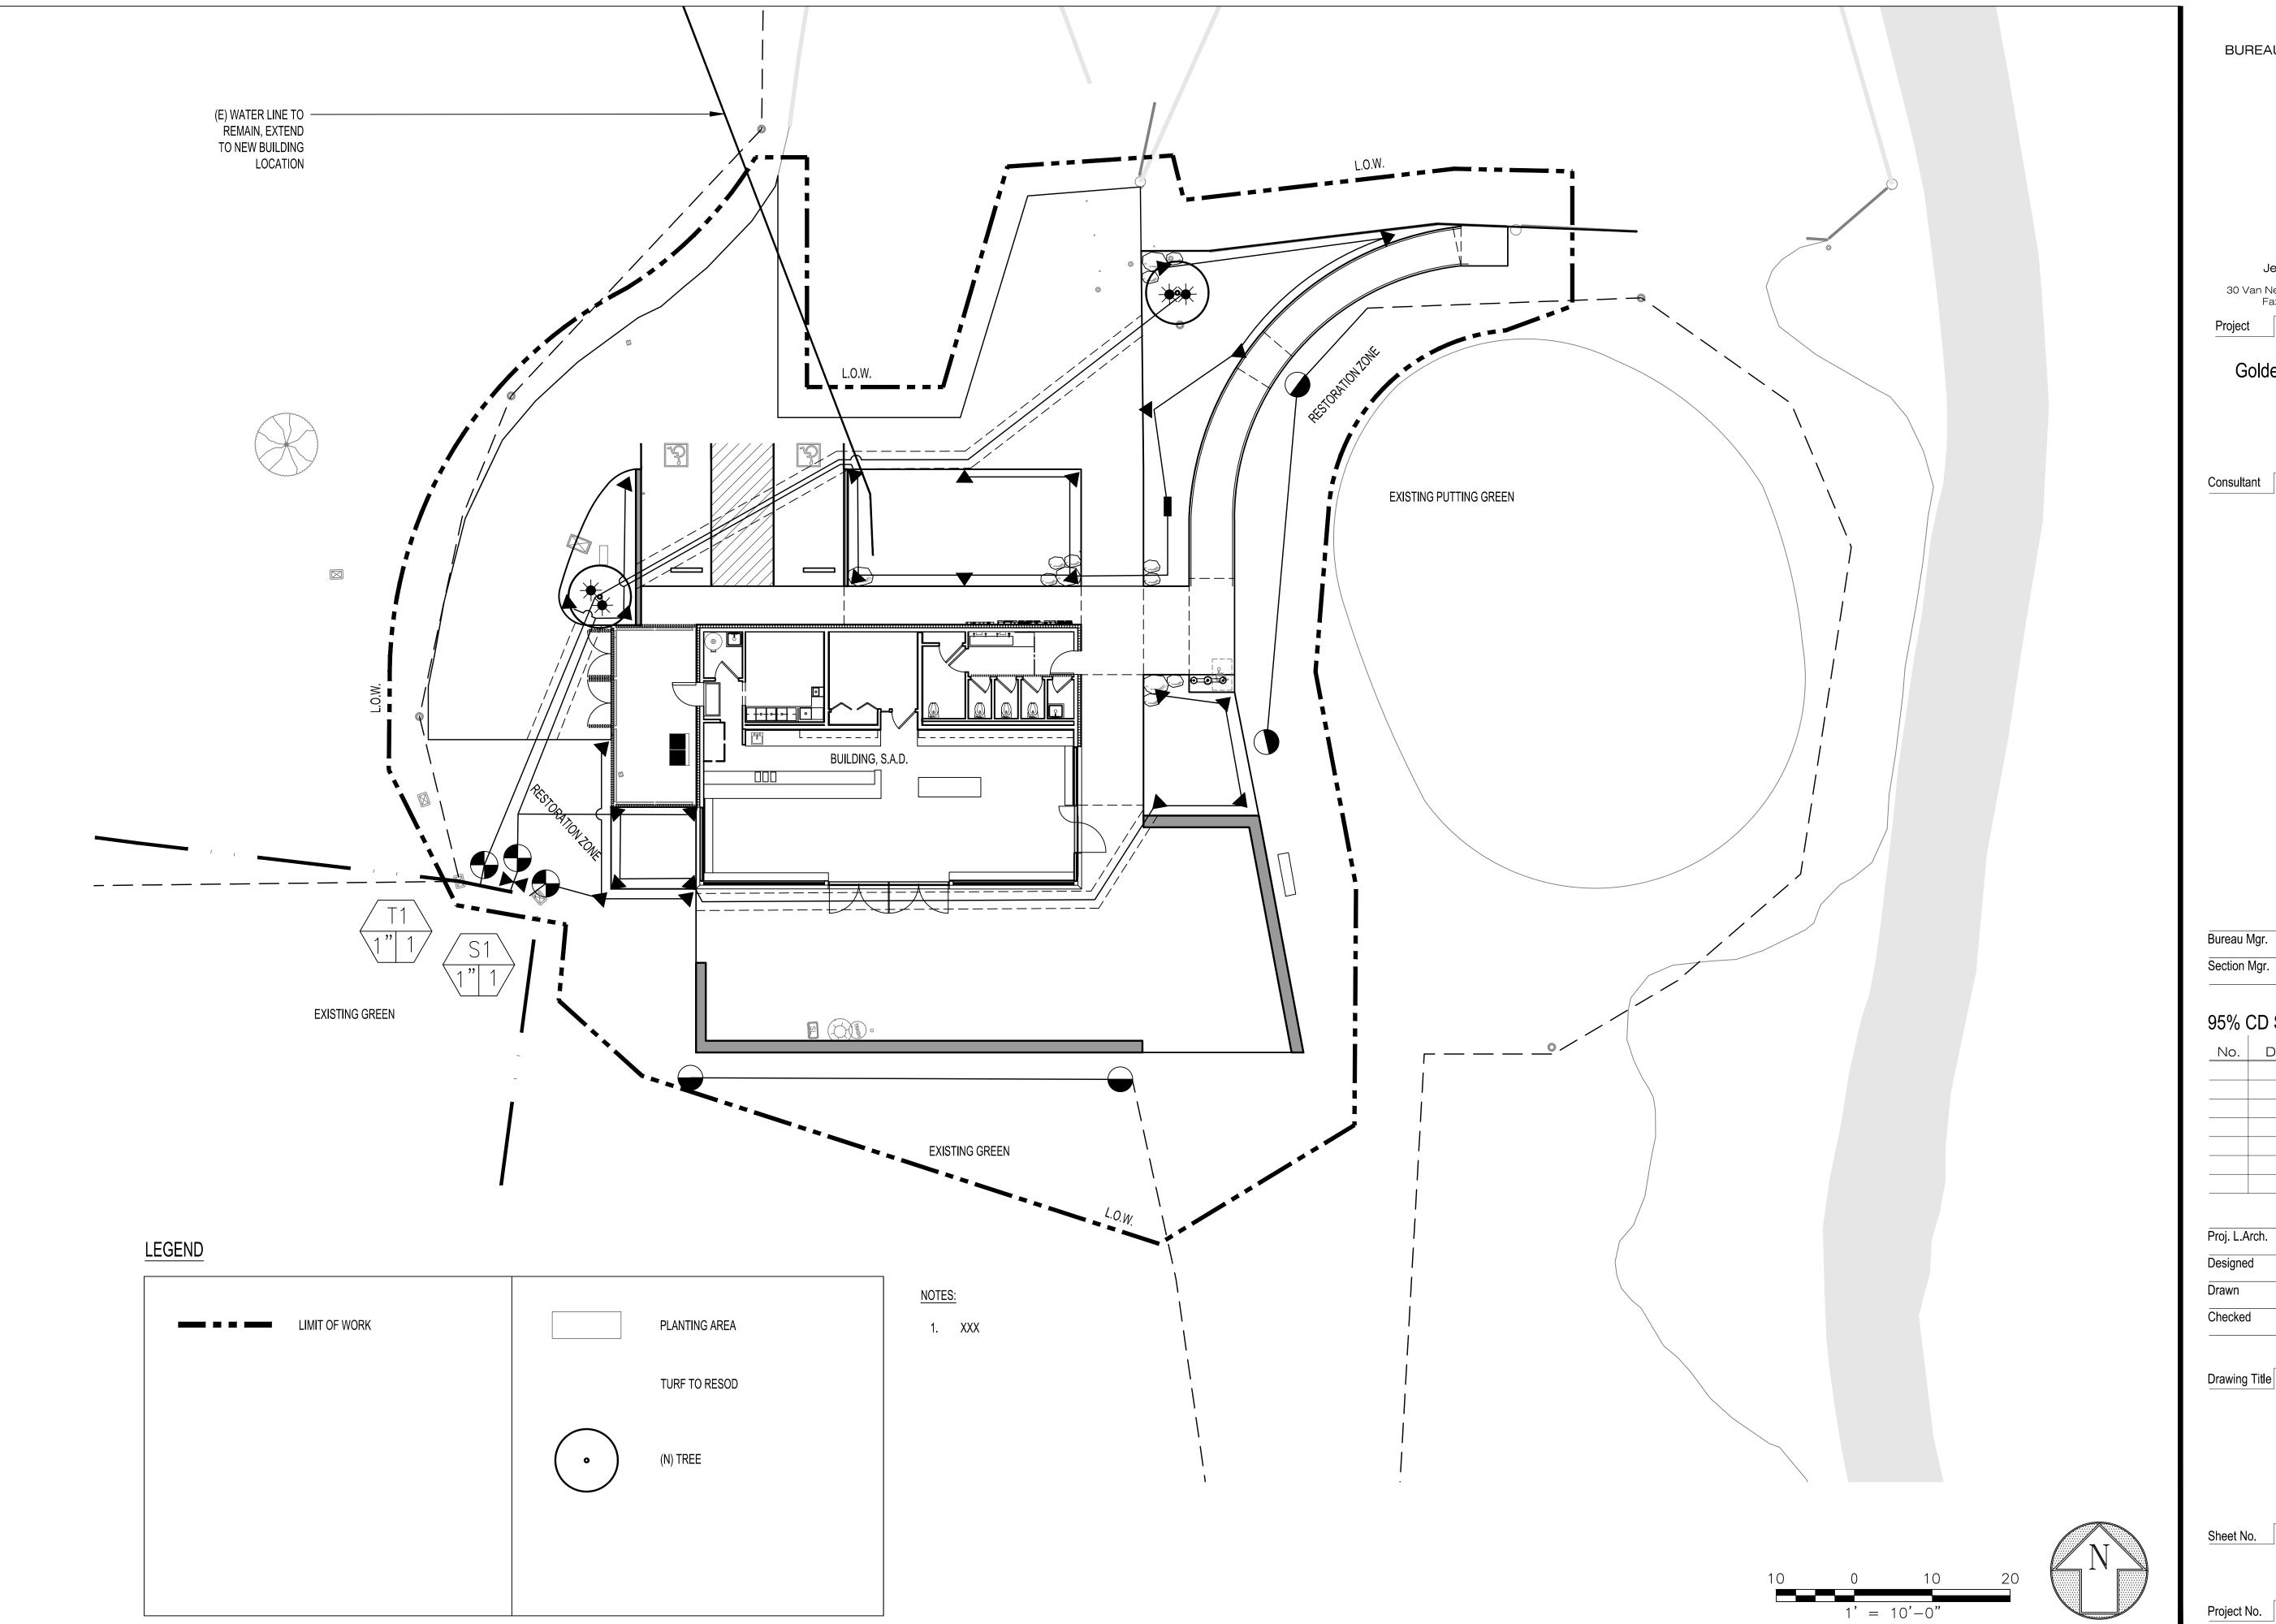
Drawing Title

GRADING PLAN

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IRRIGATION PLAN


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IRRIGATION LEGEND



SYMBOL	MANUF.	DESCRIPTION	GPM	EQUAL
	_	NEW MAINLINE, HDPE, 2" DIAMETER PLACE AT 24" DEPTH BELOW FINISH GRADE. WHERE MAINLINE CROSSES PATHWAY, PROVIDE HDPE PIPE SLEEVE, SIZED 2 SIZES LARGER THAN MAINLINE	_	
	_	LATERAL LINE SCH 40 PVC, SIZE LATERALS PER LATERAL PIPING SCHEDULE— PLACE AT 18" DEPTH BELOW FINISH GRADE	_	
	_	IRRIGATION LINE SLEEVING, SCH 80 PVC (UNDER PAVING)	_	
•	HUNTER	HQ44LRC QUICK COUPLER— 1" YELLOW W/ LOCKABLE CAP	_	BUCKNER/ RAINBIRD
	HUNTER	IBV-FS-AS-ADJ BRASS VALVE, SIZE AS INDICATED	_	NO KNOWN EQUAL
M	NIBCO	GATE VALVE: T-113, LINE SIZE	_	NO KNOWN EQUAL
•	HUNTER	MP ROTATOR MP 1000-90-180-360 PROS-12 - PRS40-CV	Q = 0.21 H = 0.42 F = 0.84	NO KNOWN EQUAL
•	HUNTER	I-20-06-SS-PRB	3.0	NO KNOWN EQUAL
*	HUNTER	HUNTER ROOT WATERING SYSTEM (RWS), INSTALL 2 PER TREE50 GPM BUBBLER	0.5000	NO KNOWN EQUAL

LATERAL PIPE S	SIZING SCHEDULE
GPM	PIPE SIZE (SCH 40 PVC) DOWNSTREAM OF RCV
8 OR LESS	3/4" ø
13	1" ø
23	1 1/4" ø
32	1 1/2" ø
53	2" ø
74	2 1/2" ø
116 OR MORE	3" ø

IRRIGATION PIPING DOWNSTREAM OF THE REMOTE CONTROL UNIT SHALL BE SIZED PER THE CHART ABOVE WHEN NOT INDICATED ON THE PLAN DRAWINGS. REFER TO THE IRRIGATION LEGEND FOR SPRINKLER FLOW RATES (GPM). NO PIPING DOWNSTREAM OF THE REMOTE CONTROL VALVE TO THE SPRINKLER SHALL BE SIZED SMALLER THAN THE SPRINKLER THREADED INLET SIZE.

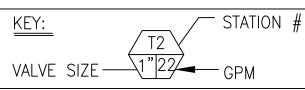IRRIGATION NOTES

- 1. THESE NOTES AND IRRIGATION PLAN GOVERN IRRIGATION INSTALLATION ONLY AND ARE NOT INTENDED TO GOVERN OTHER WORK.
- 2. VERIFY LOCATIONS OF POINT OF CONNECTION AND MAIN LINES, PARTICULARLY IN RELATION TO THE PROPOSED METER PRIOR TO COMMENCEMENT OF WORK. ANY DISCREPANCY BETWEEN THE DRAWINGS AND FIELD CONDITIONS WHICH AFFECTS IRRIGATION LAYOUT SHALL BE BROUGHT TO THE ATTENTION OF THE CITY REPRESENTATIVE PRIOR TO THE INSTALLATION OF ANY PIPE. THE CONTRACTOR IS RESPONSIBLE FOR THE INSTALLATION OF AN IRRIGATION SYSTEM THAT PROVIDES 100% COMPLETE, HEAD TO HEAD COVERAGE TO ALL PLANTED AREAS. THE WORK OF THE CONTRACT SHALL INCLUDE ADJUSTMENTS TO THE SYSTEM INDICATED, INCLUDING QUANTITIES OF PIPING, HEADS, NOZZLES & OTHER EQUIPMENT, AS NECESSARY TO ASSURE COMPLETE COVERAGE WITHOUT ADDITIONAL COST TO THE CONTRACT.
- 3. THE PLANS INDICATE A 100% NEW IRRIGATION SYSTEM UTILIZING A (N) 2" IRRIGATION METER. THE SYSTEM WAS CALCULATED FOR 40-70 PSI. ALERT THE CITY REPRESENTATIVE IF THIS PRESSURE DIFFERS FROM THE SITE CONDITION DOWNSTREAM OF THE BACKFLOW PREVENTER.
- 4. ALERT THE CITY REPRESENTATIVE PRIOR TO TRENCHING, DEMO AND REMOVAL OF ANY PARTS OF THE EXISTING IRRIGATION SYSTEM FOR THE PURPOSE OF SALVAGING EXISTING HEADS AND USABLE EQUIPMENT. SALVAGE EQUIPMENT AT THE DIRECTION OF THE CITY REPRESENTATIVE. ABANDON EXISTING UNDERGROUND PORTIONS OF THE IRRIGATION SYSTEM IN PLACE AS REQUIRED, REMOVE AND DISPOSE OF UNDERGROUND EQUIPMENT WHERE CONFLICTS OCCUR AND DISPOSE OFFSITE PER LOCAL CODES AND AS THE CONTRACTOR'S OWN PROPERTY.
- 5. THE IRRIGATION DRAWINGS ARE DIAGRAMMATIC AND DO NOT SHOW EXACT LOCATIONS OF PIPING, VALVES OR CONTROL LINES. INSTALL THESE ITEMS PARALLEL TO AND AS CLOSELY AS POSSIBLE TO CURBS, HEADERS OR PAVING EDGES AND WITHIN PLANTED AREAS UNLESS OTHERWISE INDICATED, REFER TO IRRIGATION DETAILS. VERIFY IN FIELD THE EXACT LOCATIONS OF VALVE BOXES, GATE VALVES AND QUICK COUPLERS WITH THE CITY REPRESENTATIVE PRIOR TO INSTALLATION.
- 6. IRRIGATION HEAD LOCATIONS ARE INDICATED AS ACCURATELY AS POSSIBLE ON THE DRAWINGS. INSTALL HEADS AS INDICATED BY THE CENTERLINE OF THE SYMBOL AND IN ACCORDANCE WITH INSTALLATION DETAILS AND MANUFACTURER'S RECOMMENDATIONS.
- 7. COORDINATE WORK WITH ALL APPROPRIATE TRADES FOR THE INSTALLATION OF PIPING, PIPE SLEEVES AND ELECTRICAL CONDUIT.
- 8. INSTALL ALL OTHER CONTROL WIRING IN SCH 40 PVC SLEEVING OF SUFFICIENT SIZE FOR EASY INSERTION AND REMOVAL.
- 9. INSTALL EACH SOLENOID VALVE IN A SEPARATE VALVE BOX PER DETAIL.
- 10. POP-UP SPRINKLER HEIGHT: INSTALL 12" IN GROUND COVER/ SHRUB AREAS, 6" IN LAWN AREAS.
- 11. THE IRRIGATION SYSTEM HAS BEEN DESIGNED FOR 40-45 PSI AND A MAXIMUM GPM OF 33. NOTIFY THE CITY REPRESENTATIVE IMMEDIATELY, IF THERE ARE DISCREPANCIES.
- 12. PROVIDE TEMPORARY FENCING AS AS REQUIRED DURING TRENCHING AND CONSTRUCTION FOR SAFETY OF PUBLIC PER CCSF STANDARD SPECIFICATIONS. ALERT CITY REPRESENTATIVE PRIOR TO CONSTRUCTION.
- 13. ALL NEW AND RELOCATED TREES SHALL RECEIVE BUBBLER IRRIGATION PER THE SPECIFICATIONS AND DRAWINGS.
- 14. CONTRACTOR TO REPAIR ANY PART OF THE IRRIGATION SYSTEM TO REMAIN THAT IS DAMAGED DURING CONSTRUCTION.
- 15. IRRIGATION PIPING DOWNSTREAM OF THE REMOTE CONTROL VALVE SHALL BE SIZED PER THE LATERAL PIPE SIZING SCHEDULE.
- 16. REFER TO THE IRRIGATION LEGEND FOR SPRINKLER FLOW RATES (GPM). NO PIPING DOWNSTREAM OF THE REMOTE CONTROL VALVE TO THE SPRINKLER SHALL BE SIZED SMALLER THAN THE SPRINKLER THREADED INLET

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IRRIGATION LEGEND & NOTES


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LH

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VC

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Drawing Title


PLANTING PLAN

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L5.0
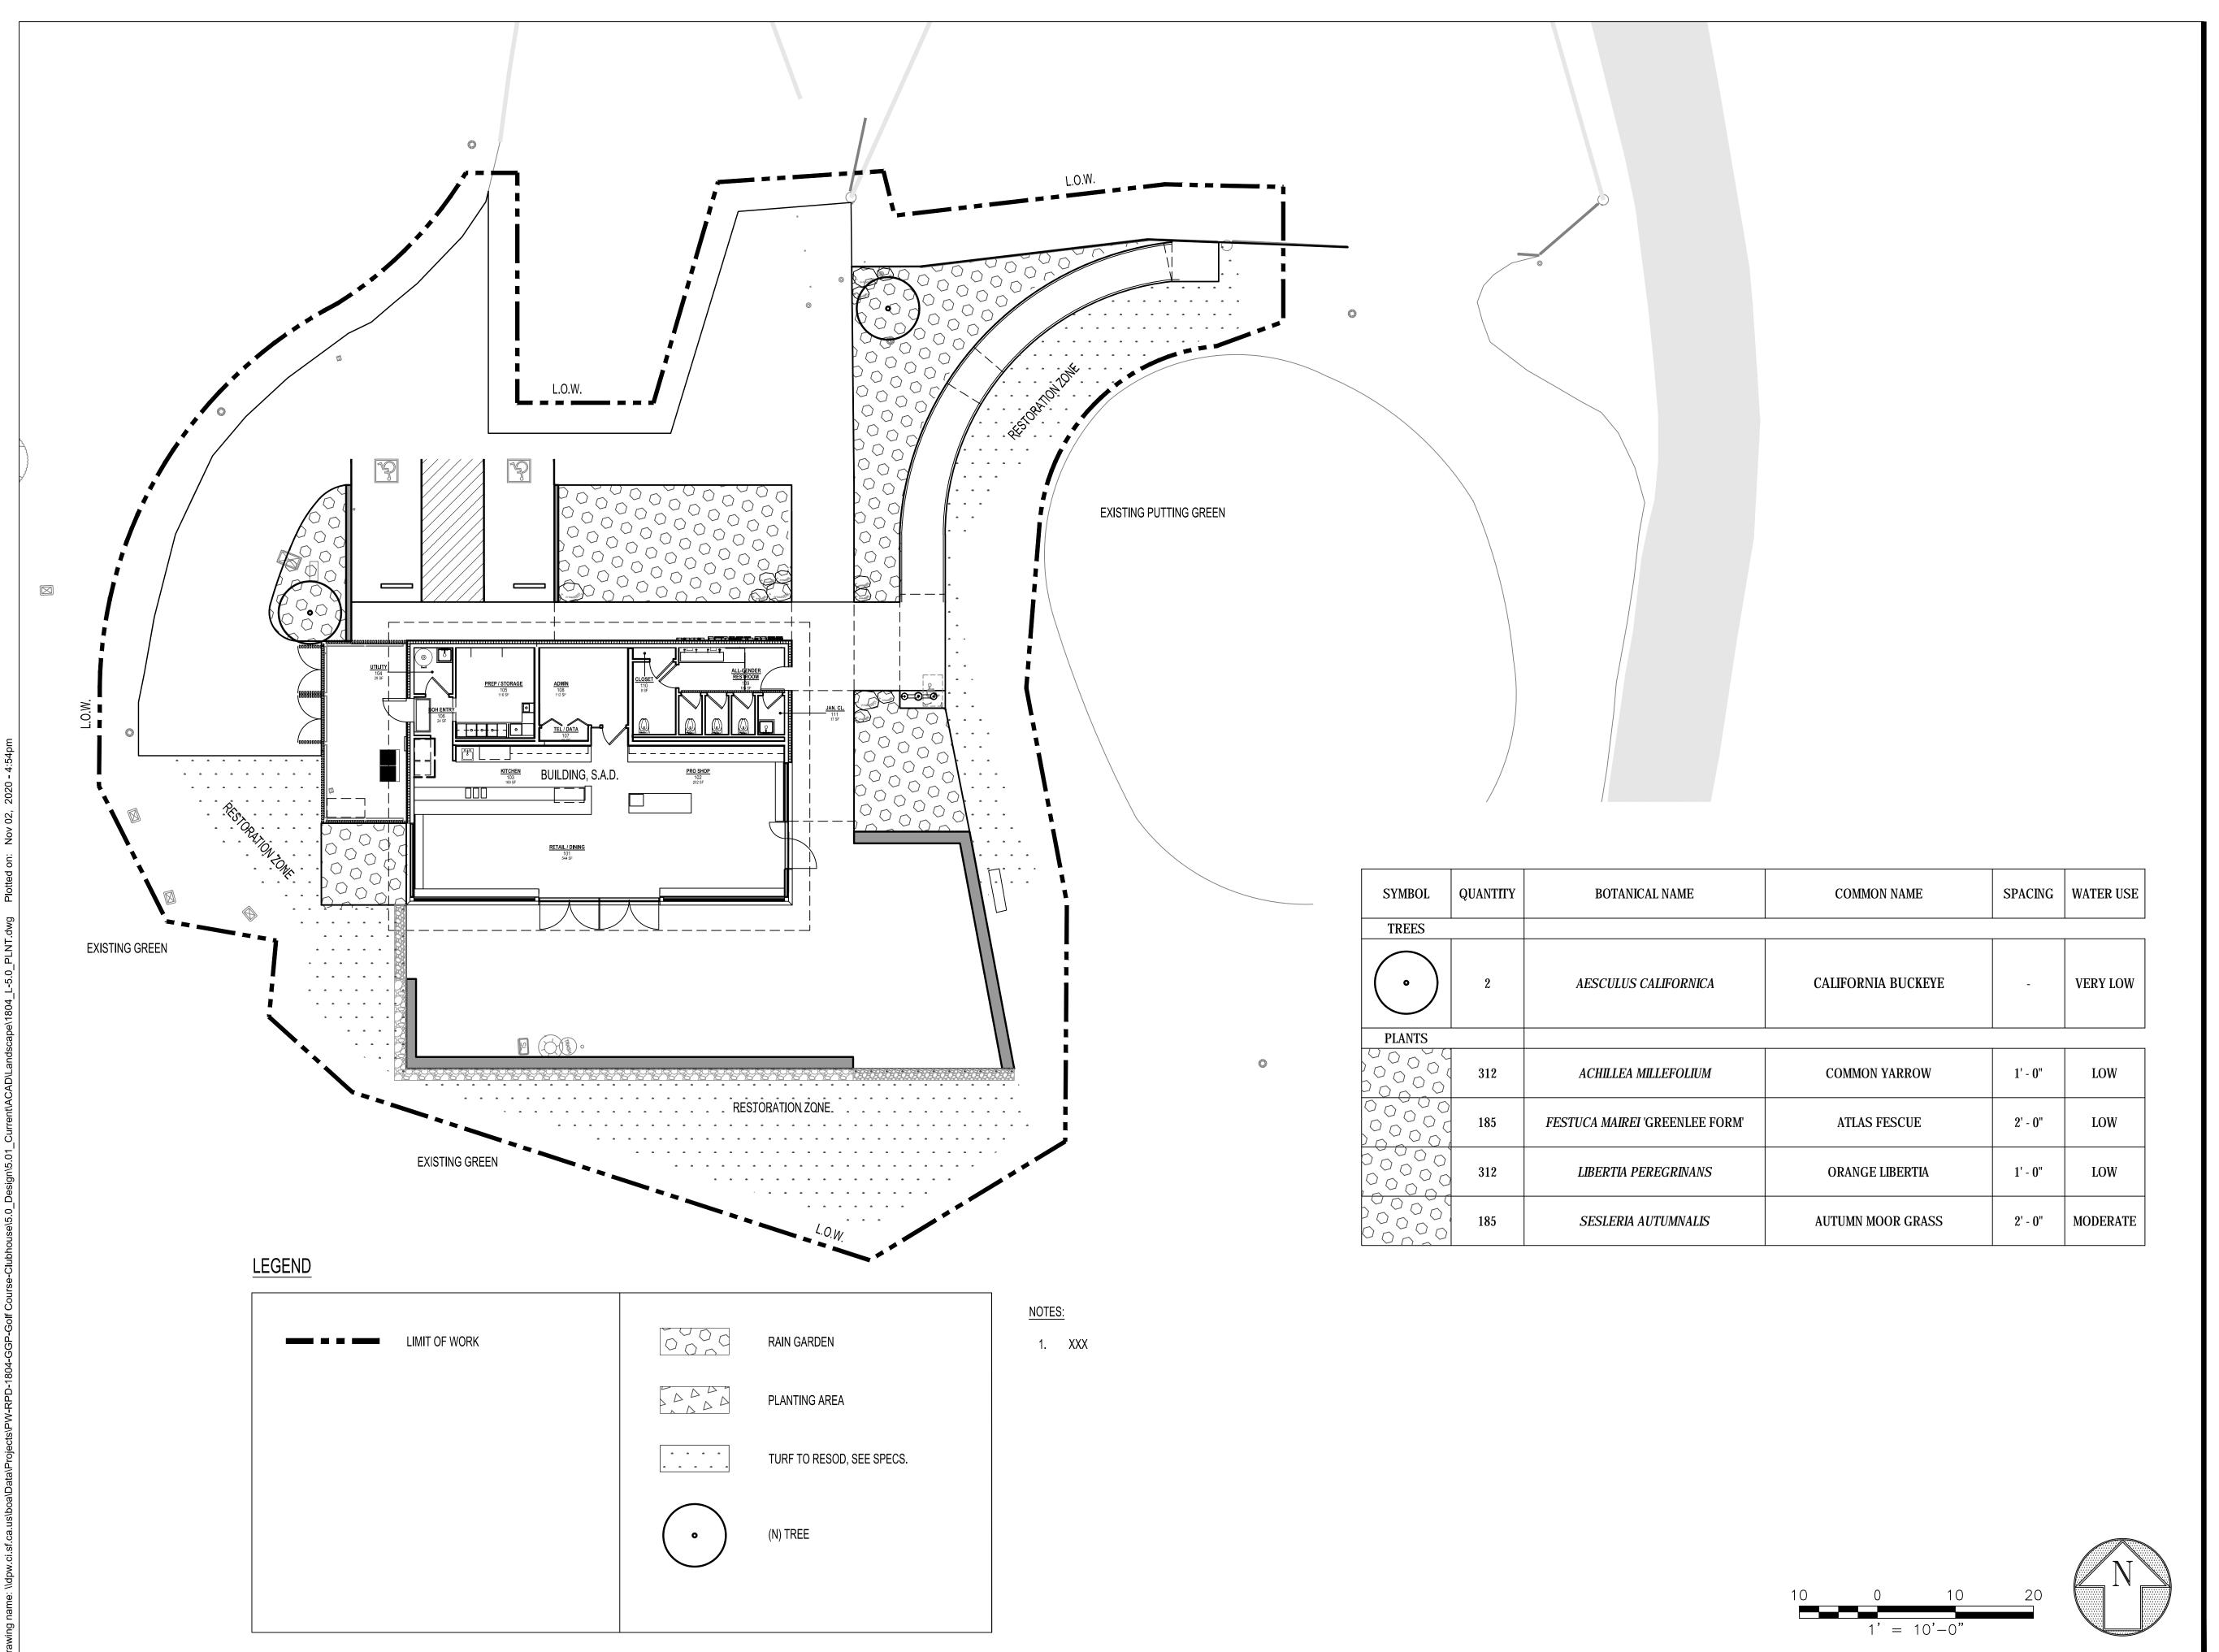
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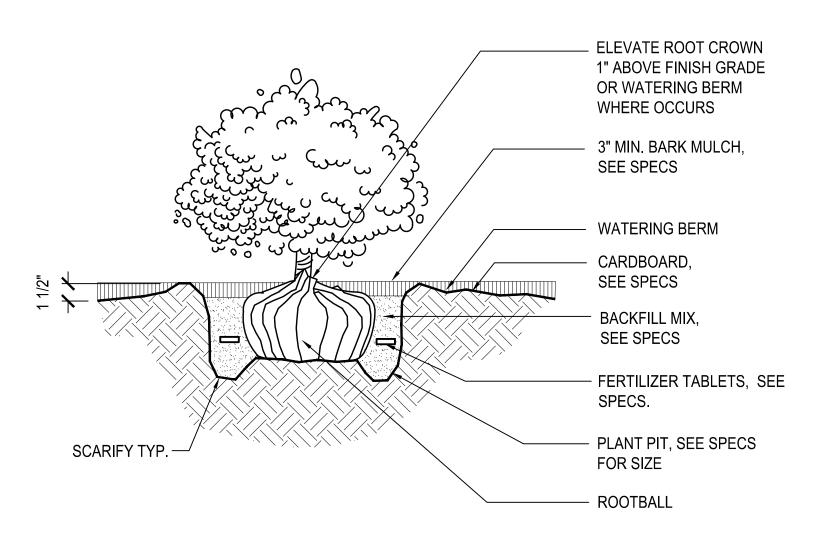
1804



- 2. FINAL STAKING TO BE APPROVED BY CITY REP.
- 3. STAKES AND STRAPS TO BE PAINTED BLACK

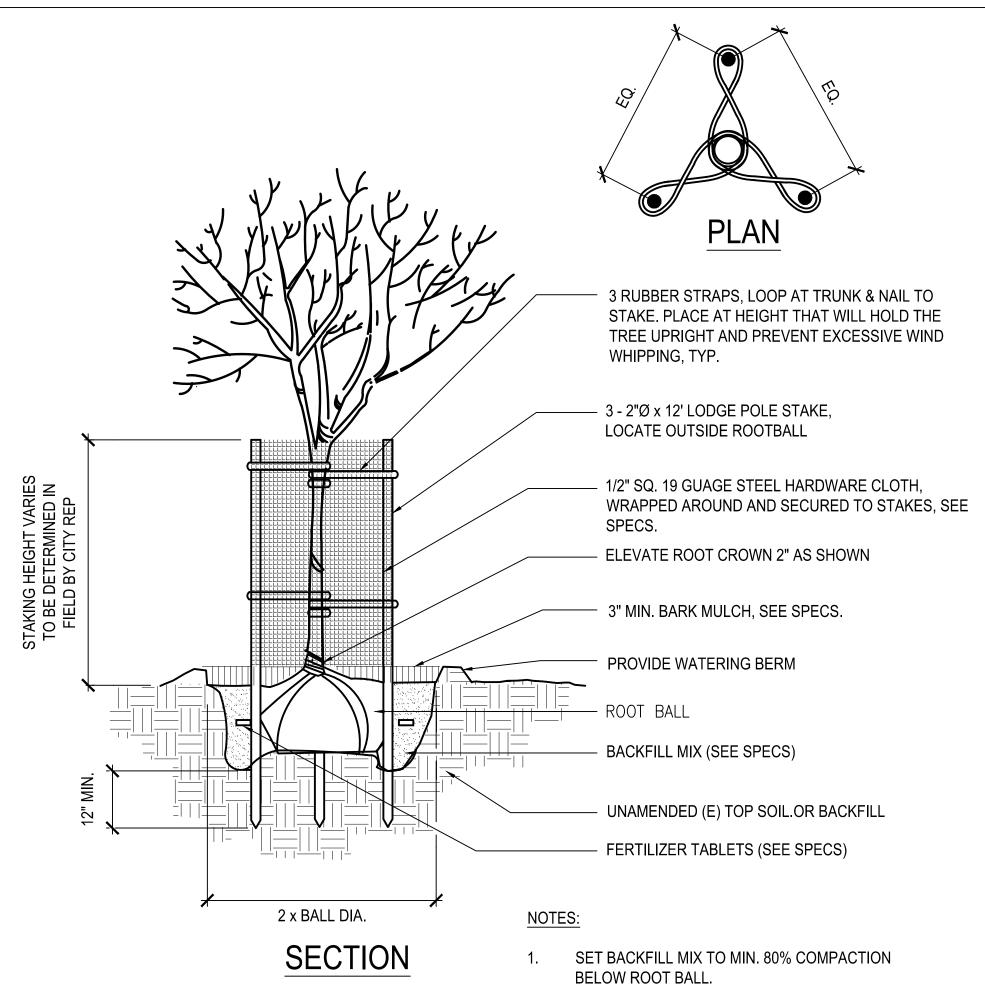
TREE PLANTING & STAKING

NOT TO SCALE



SHRUB PLANTING

NOT TO SCALE

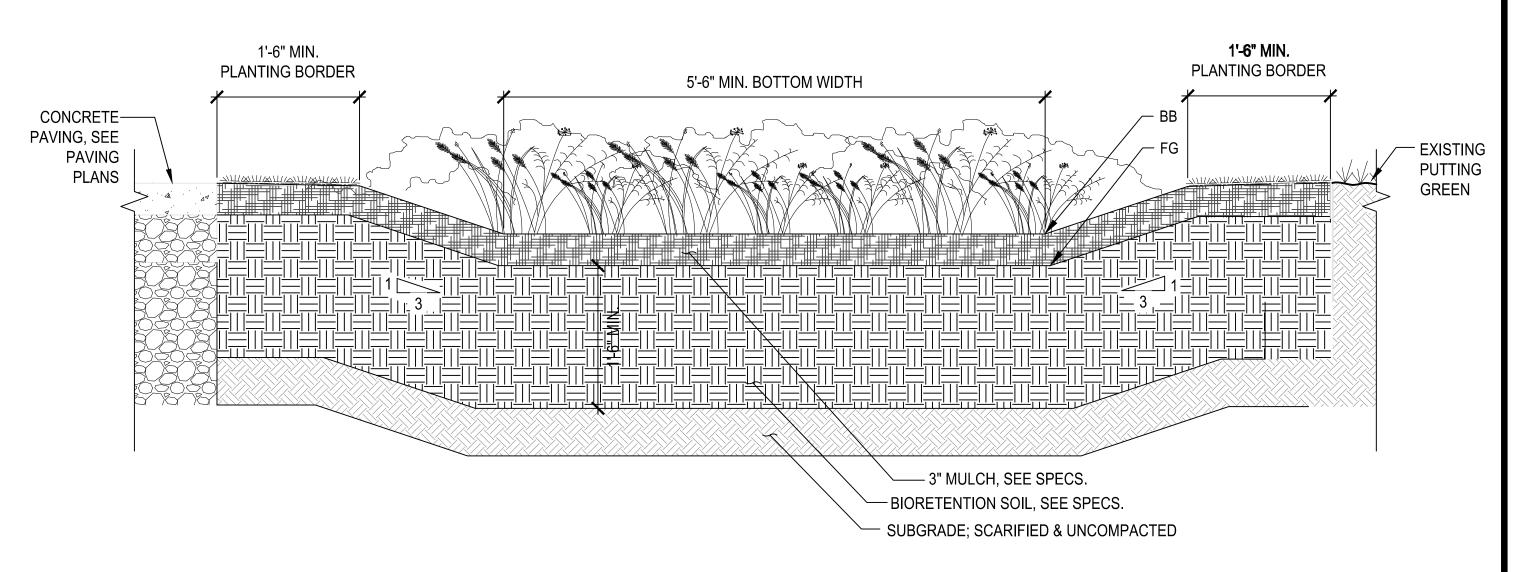

CONSTRUCTION NOTES:

- 1. AVOID COMPACTION OF EXISTING SUBGRADE BELOW PLANTER.
- 2. SCARIFY SUBGRADE TO A DEPTH OF 6 INCHES (MIN) IMMEDIATELY PRIOR TO PLACEMENT OF BIORETENTION SOIL.

GENERAL UTILITY NOTES:

- 1. EXISTING UTILITY LINES MUST BE SLEEVED AND MARKED WITH UTILITY MARKING TAPE OR RELOCATED. INCLUDE MEASURES TO PREVENT PREFERENTIAL FLOW INTO UTILITY TRENCHES (E.G., WATER STOP, TRENCH BLOCK, OR TRENCH COLLAR).
- 2. ABANDONED UTILITIES WITHIN FOOTPRINT OF FACILITY AND OBSERVED DURING CONSTRUCTION MUST BE REMOVED. COORDINATE WITH MUNICIPAL OR PRIVATE OWNER AND CITY REPRESENTATIVE.

X RAIN GARDEN

SCALE:

N.T.S.

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Designed LH

Proj. L.Arch.

Designed

LH

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VC

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PLANTING DETAILS

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L5.1

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GROUND COVER PLANT, TYP.

4" MIN. FROM EDGE OF PLANTING AREA

EDGE OF PLANTING AREA, SEE
LAYOUT PLANS

NOTE:

FOR GROUND COVER SPACING
DISTANCE "X", SEE PLANT LIST.

TRUNKS, WHERE OCCURS

GROUND COVER PLANTING

NOT TO SCALE

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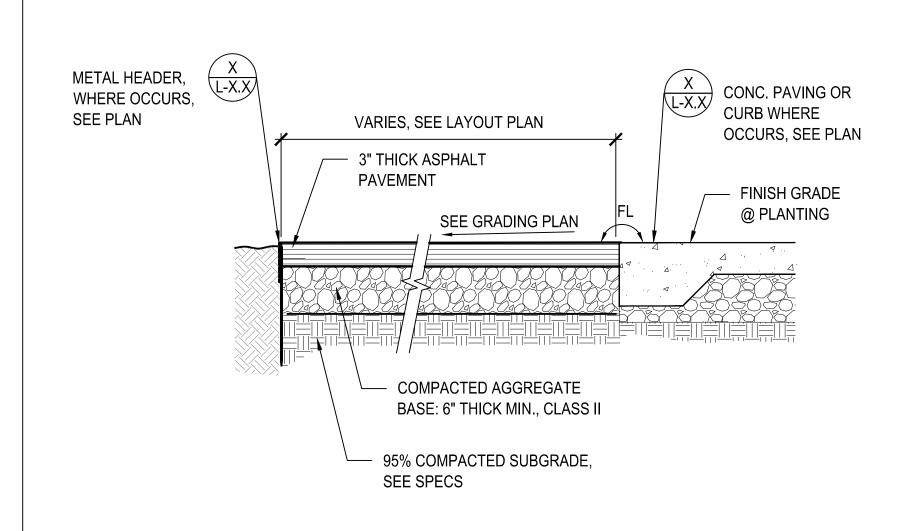
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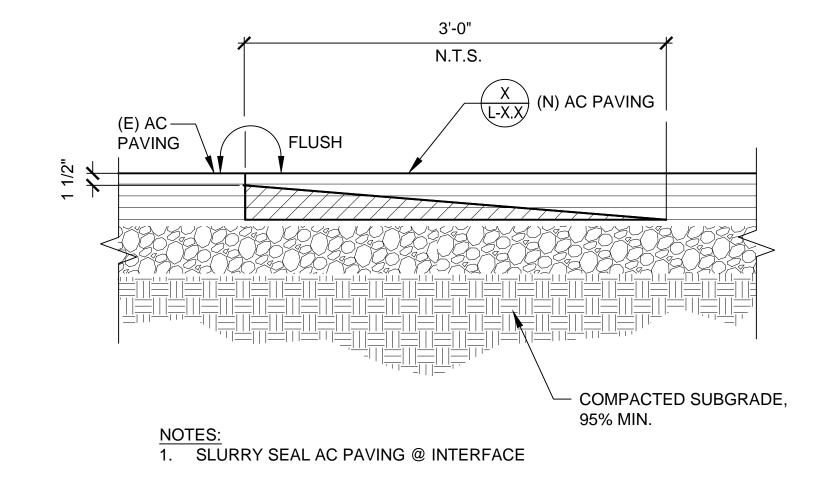
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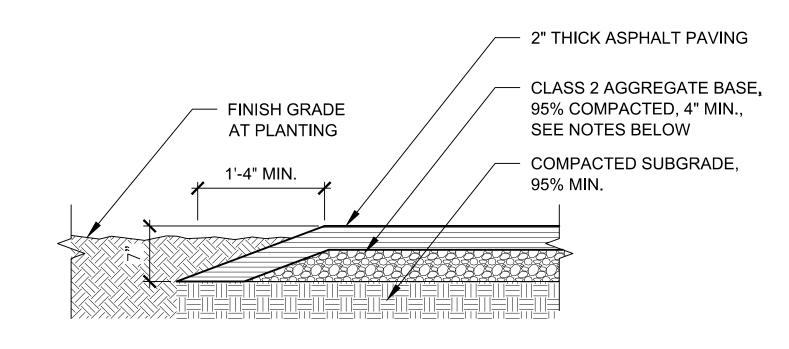
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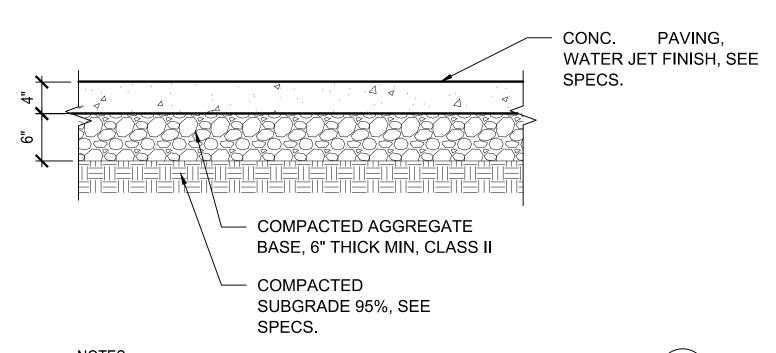




TAPERED EDGE AT MAINTENANCE ROAD








1. PLACE EXPANSION JOINTS WHERE PAVING ABUTS ALL VERTICAL SURFACES L-X.X

2. PROVIDE A FIELD SAMPLE FOR MOCK UP, MIN. 3' SQUARE, TO BE APPROVED BY A CITY REPRESENTATIVE.

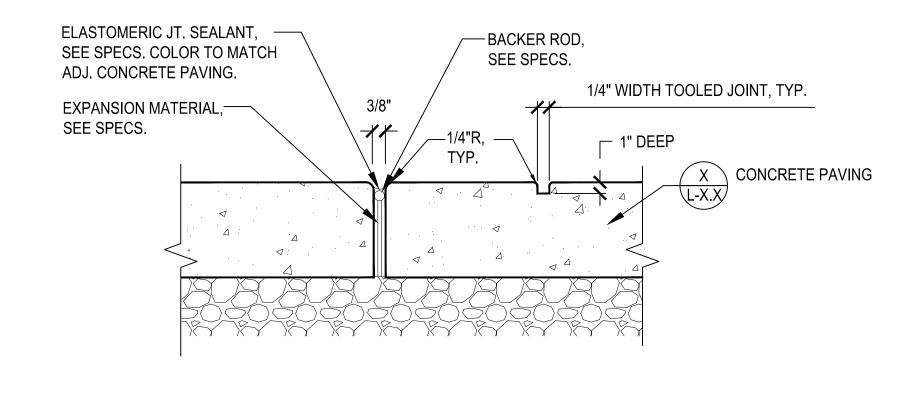


SCALE:

SCALE:

1" = 1'-0"

1. PLACE EXPANSION JOINTS WHERE PAVING ABUTS ALL VERTICAL SURFACES.

(X)(E) & (N) ASPHALT PAVING INTERFACE

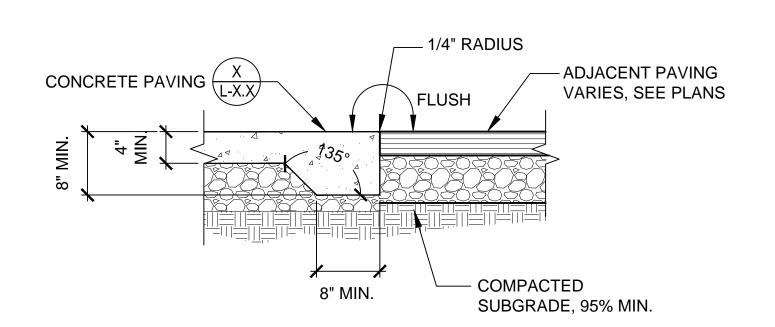

THICKENED CONCRETE EDGE

SCALE: 1" = 1'-0"

X CONCRETE PAVING


(X) CONCRETE CURB


SCALE: 1" = 1'-0"

SCALE:

1" = 1'-0"

SCALE:

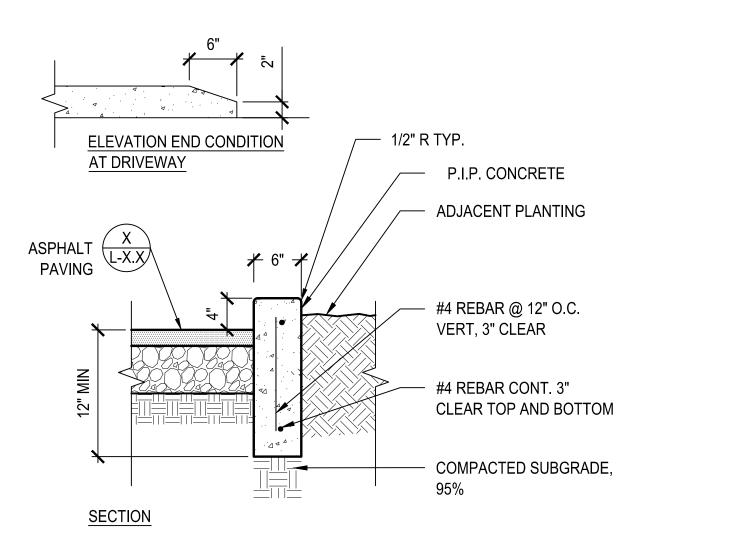

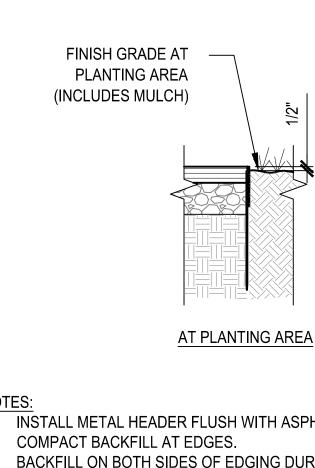

EXPANSION & SCORE JOINTS

- INSTALL METAL HEADER FLUSH WITH ASPHALT AT ALL CONDITIONS.
- BACKFILL ON BOTH SIDES OF EDGING DURING INSTALLATION LEAVING NO MORE THAN TWO SECTIONS UNSUPPORTED AT A TIME.
- 4. INSTALL STEEL EDGING WITH STAKE POCKETS FACING ASPHALT EDGE.
- SECURE STEEL EDGING WITH 15" MANUFACTURED STEEL STAKES AT EVERY
- JOINT AND EQUALLY SPACE 5 PER 16' SHEET, SEE SPECS. 6. ALLOW FOR 3" MULCH AT FG OF PLANTING AREA.

(X) METAL HEADER

SCALE: 1" = 1'-0"

Original Sheet Size: 22"x34"

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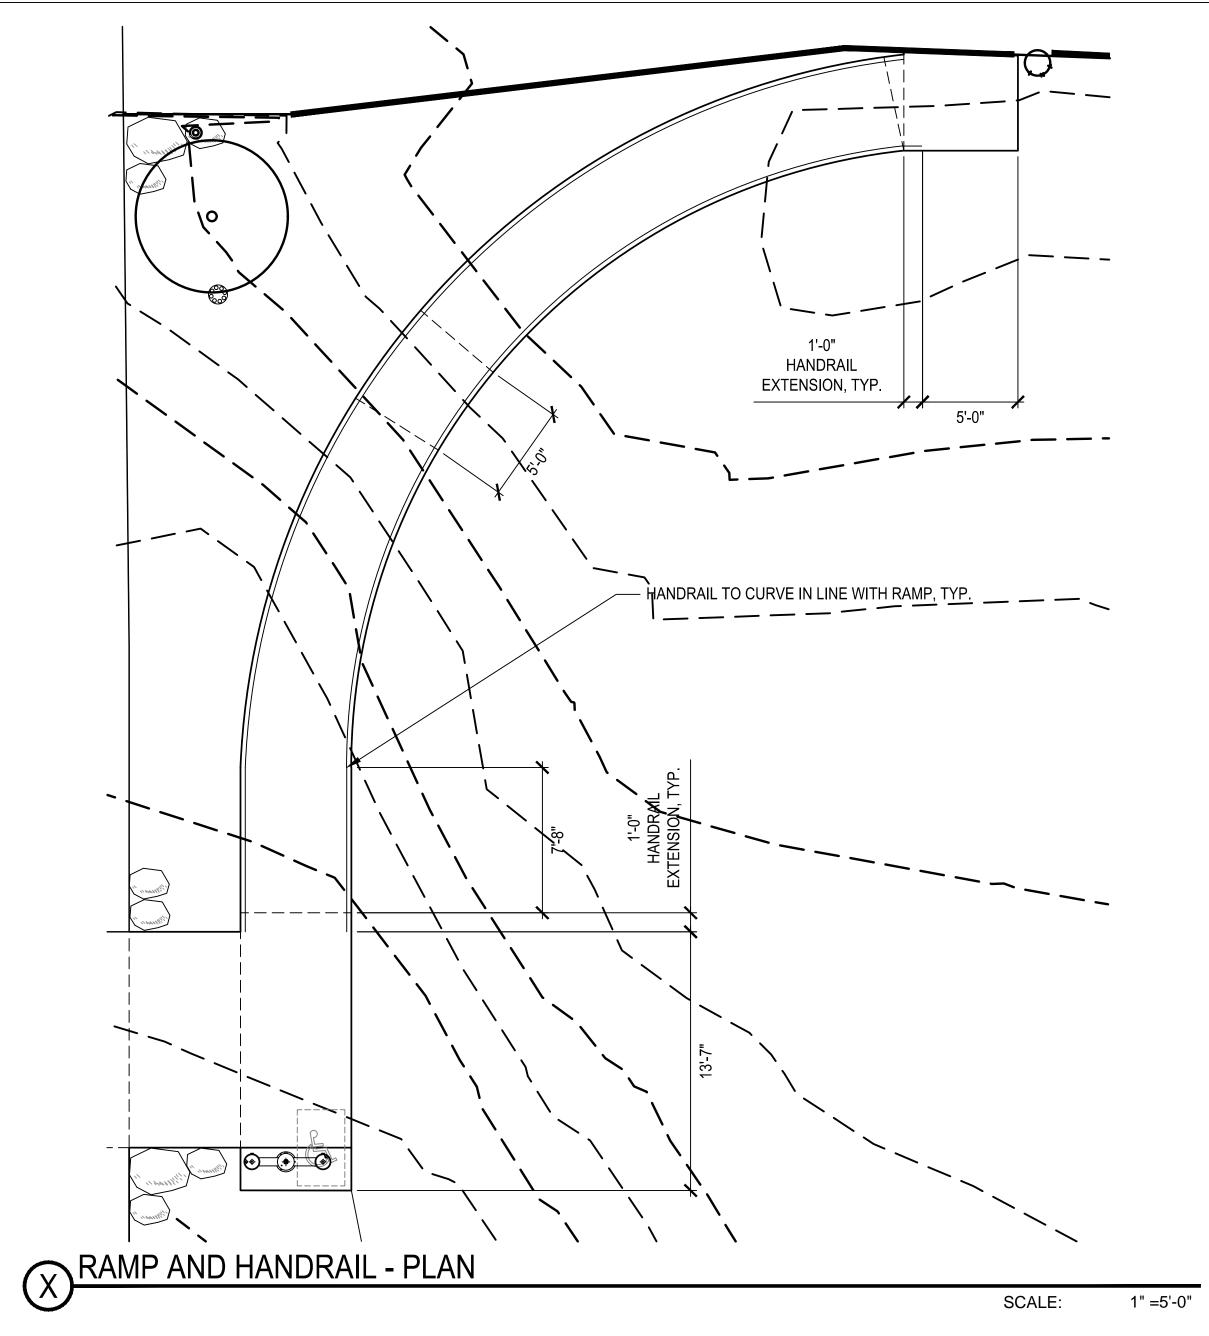
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LANDSCAPE CONSTRUCTION DETAILS


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- GRIND AND WELD SMOOTH — HANDRAIL, 1-1/2" GALV. PIPE, - HANDRAIL, 1-1/2" GALV. PIPE, 1 1/2" 1 1/2" SEE SPECS. SEE SPECS. 3/4" 3/16" 3/16" WELD PLATE TO BOTTOM OF PIPE – HANDRAIL: 3/4" GALV. PLATE, - HANDRAIL: 3/4" GALV. PLATE, 1-1/2" WIDE WITH SEMICIRCLE 1-1/2" WIDE WITH SEMICIRCLE TOP END CUT-OUT AT TOP END A-1. END ELEV. A-2. CROSS SECTION B. INTERMEDIATE POST DETAIL A. END POST DETAIL SPACED EQUALLY. 5'-0" O.C. MAX SPAN 2. SUBMIT HANDRAILS SHOP DRAWINGS FOR CITY REPRESENTATIVE'S APPROVAL.

SCALE:


1" =1'-0"



(X) RAMP AND HANDRAIL - SECTION

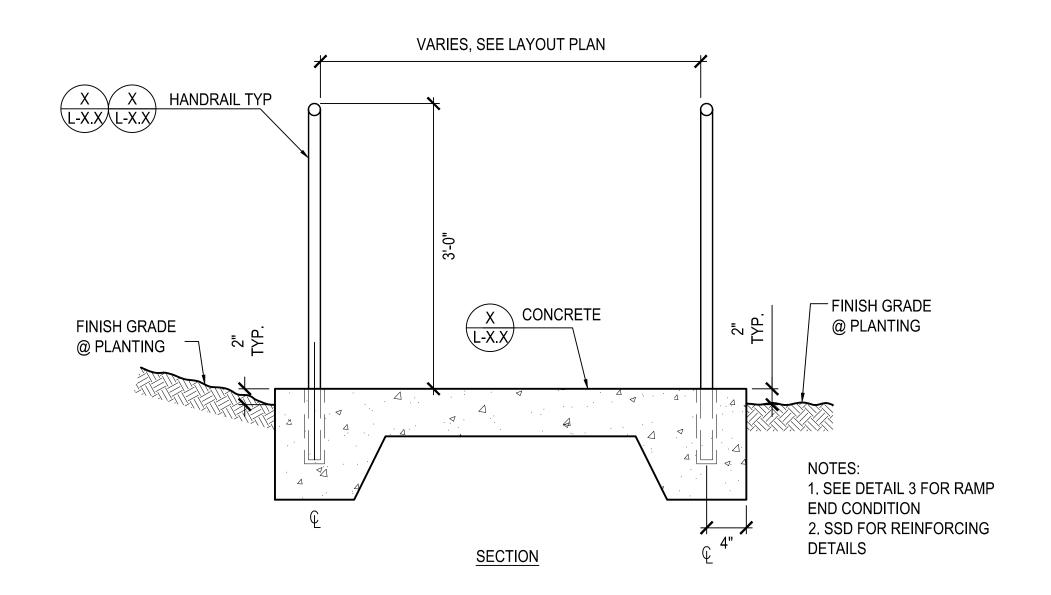SCALE:

1" =1'-0"

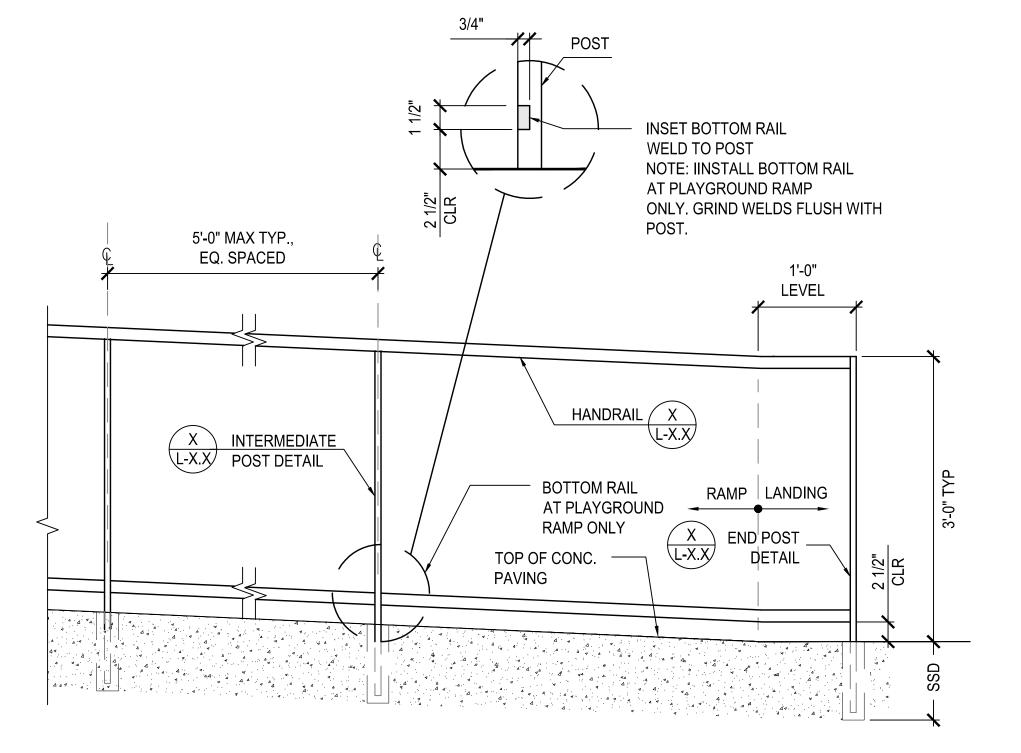

NOTE:

1. SUBMIT HANDRAILS SHOP DRAWINGS FOR CITY REPRESENTATIVE'S APPROVAL.

(X) RAMP RAIL END CONDITION

SCALE: 1" =1'-0"

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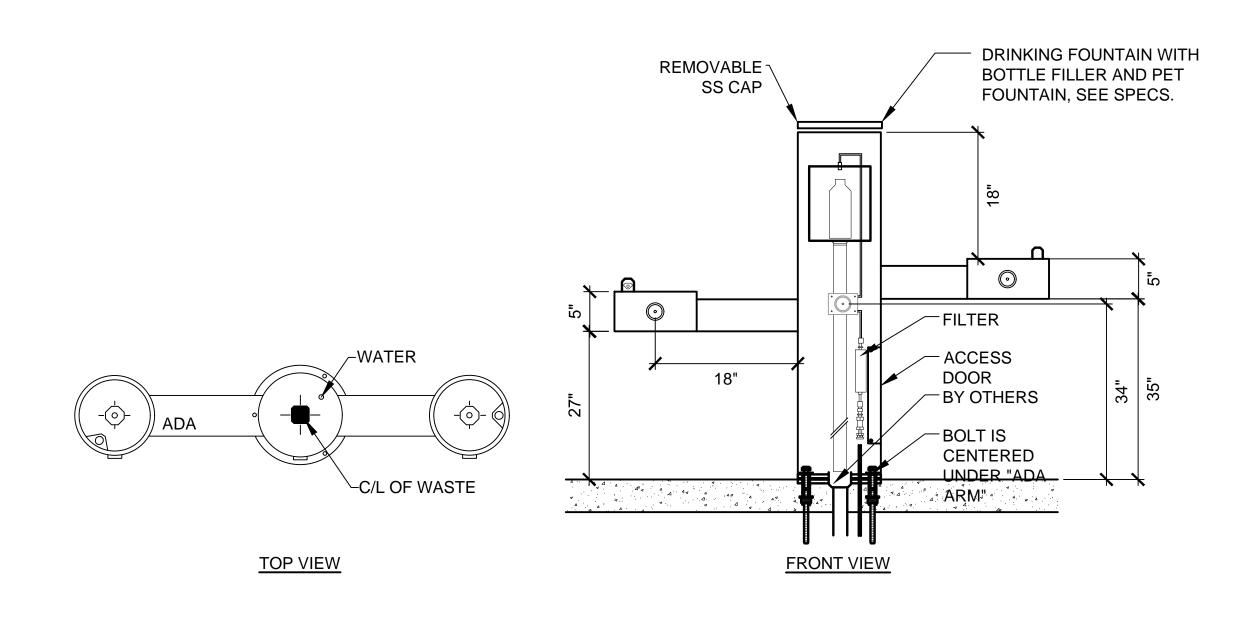
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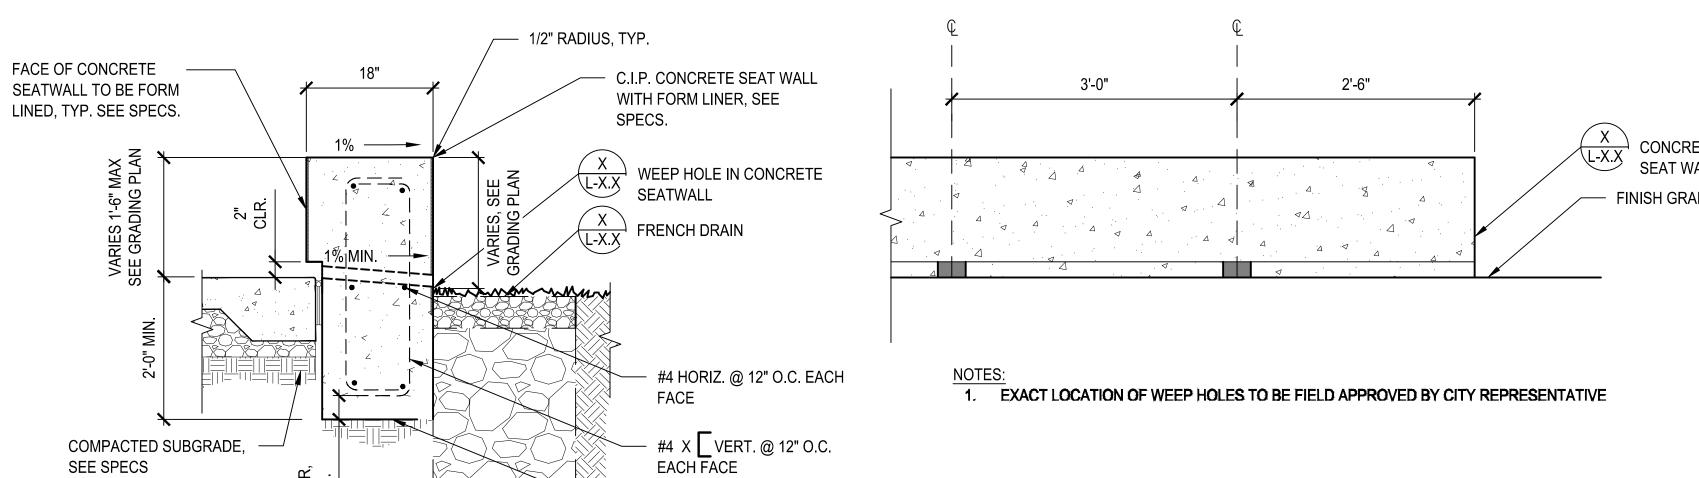
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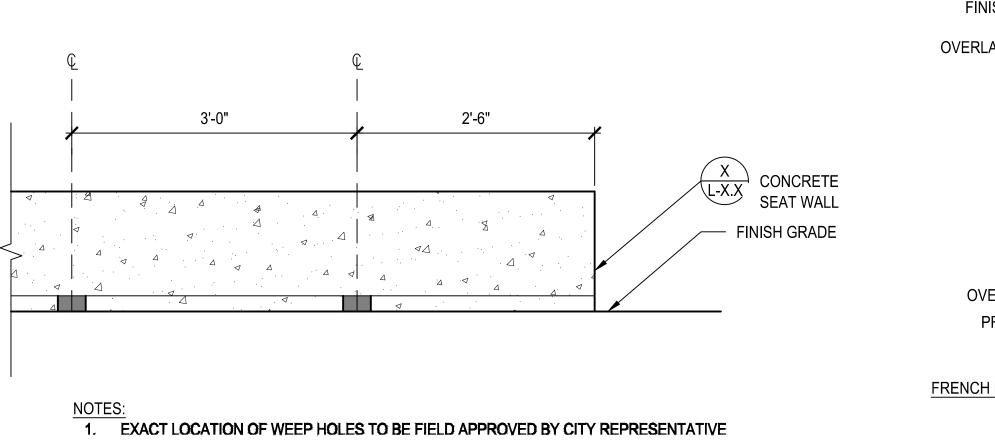


- 1. SEE MECHANICAL DRAWINGS FOR WATER SUPPLY LINE AND DRAIN LINE CONNECTION
- 2. EXACT LOCATION OF DRINKING FOUNTAIN TO BE FIELD APPROVED BY CITY REPRESENTATIVE.
- 3. INSTALLATION TO BE COMPLETED IN ACCORDANCE WITH MANUFACTURER'S SPECIFICATIONS.




CONCRETE FOOTING






1" = 1'-0"



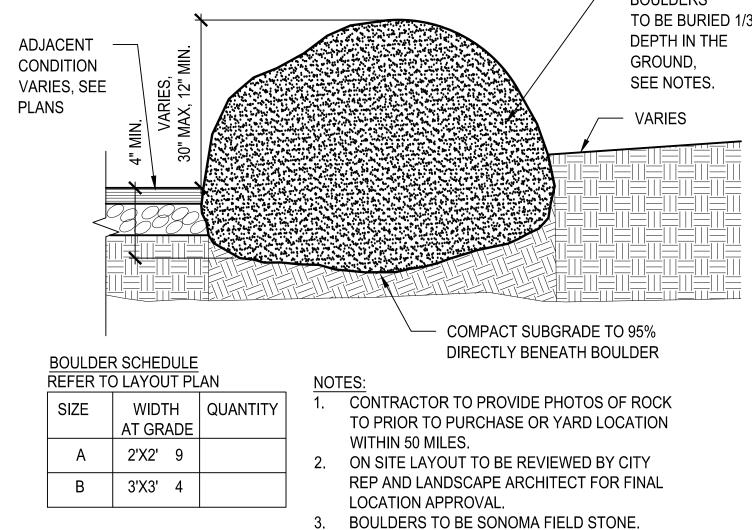

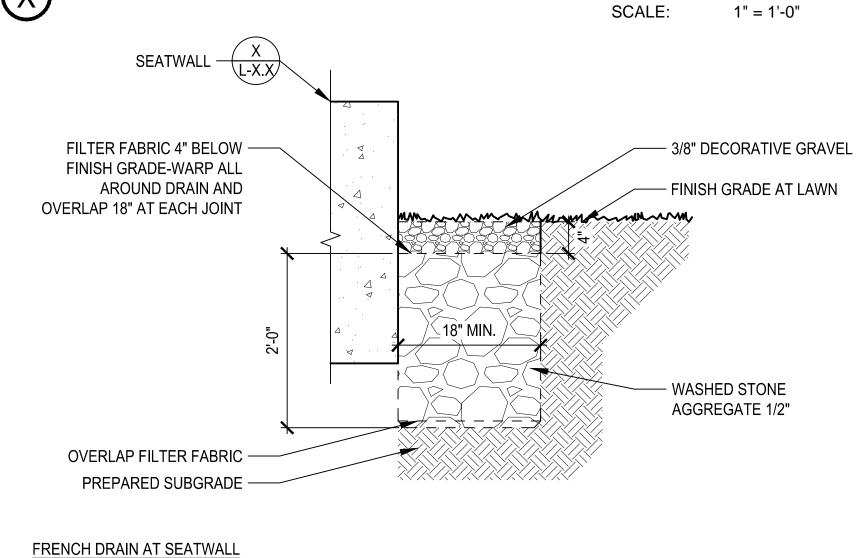

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LANDSCAPE CONSTRUCTION DETAILS

Sheet No. L-6.2 AS NOTED Project No. 1804

FRENCH DRAIN AT PAVING - WITH METAL COVER

CONCRETE WALL SCALE:

COMPACTED SUBGRADE,

SEE SPECS

WEEP HOLE IN CONCRETE SEATWALL ELEVATION

SCALE: 1" = 1'-0"

SCALE: 1" = 1'-0"

Original Sheet Size: 22"x34"

BOULDERS TO BE BURIED 1/3

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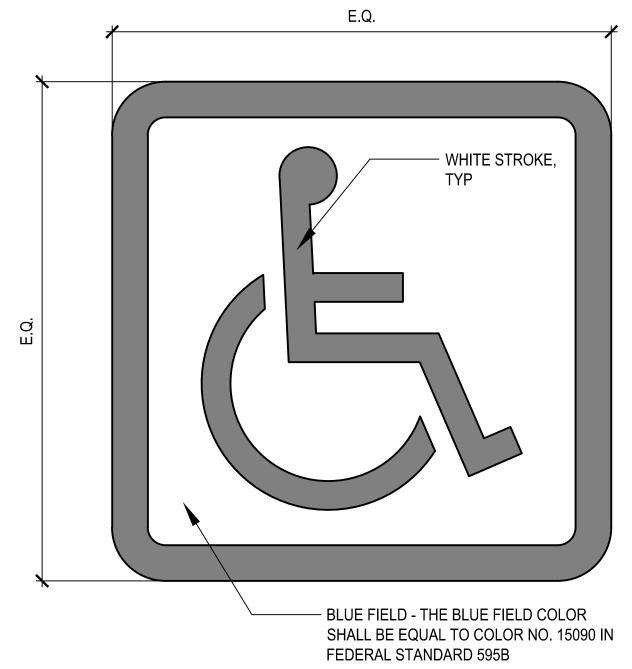
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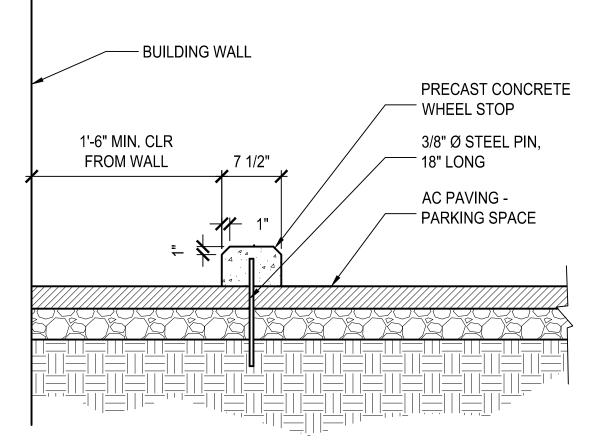
Consultant

Bureau Mgr. Section Mgr.


95% CD SET 11/02/20 Revisions



INTERNATIONAL SYMBOL OF SCALE: N.T.S.




CROSS SECTION

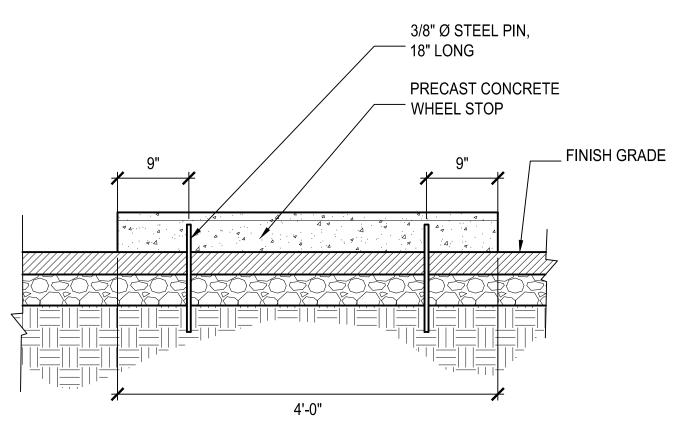


LONGITUDINAL ELEVATION

WHEEL STOP SCALE: 1"=1'-0" CAD FILE: WheelStop

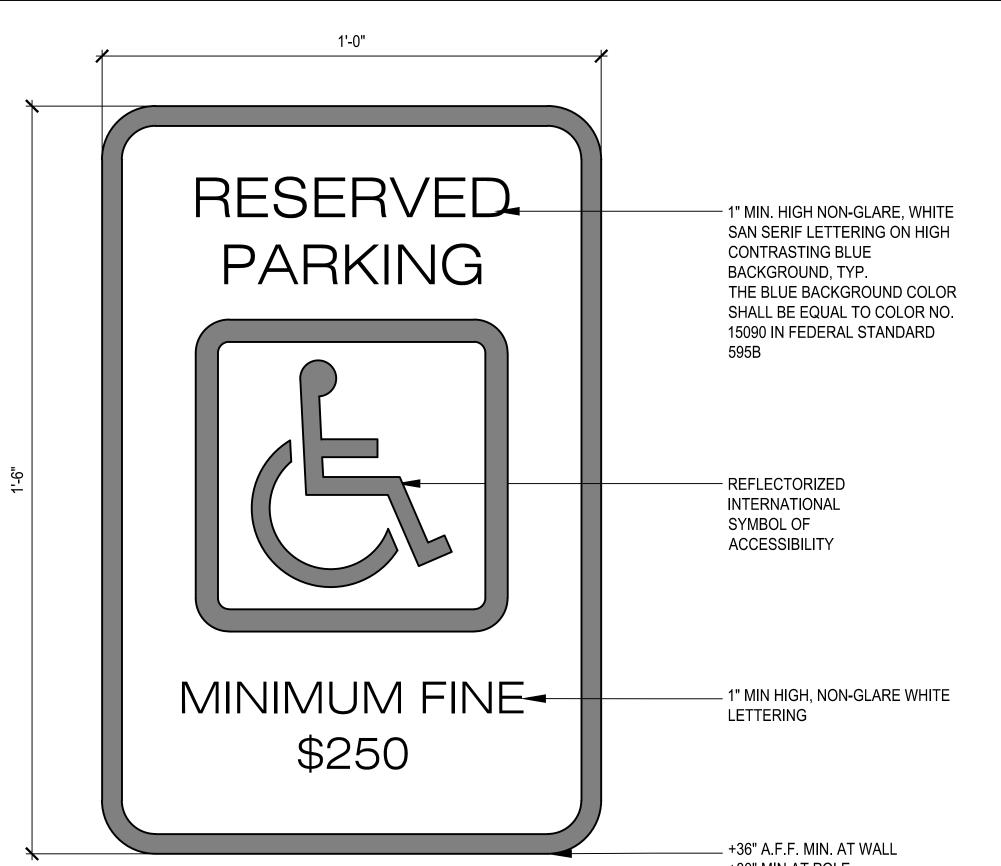

PICAL ACCESSIBLE PARKING STALL SIGN

SCALE: N.T.S.

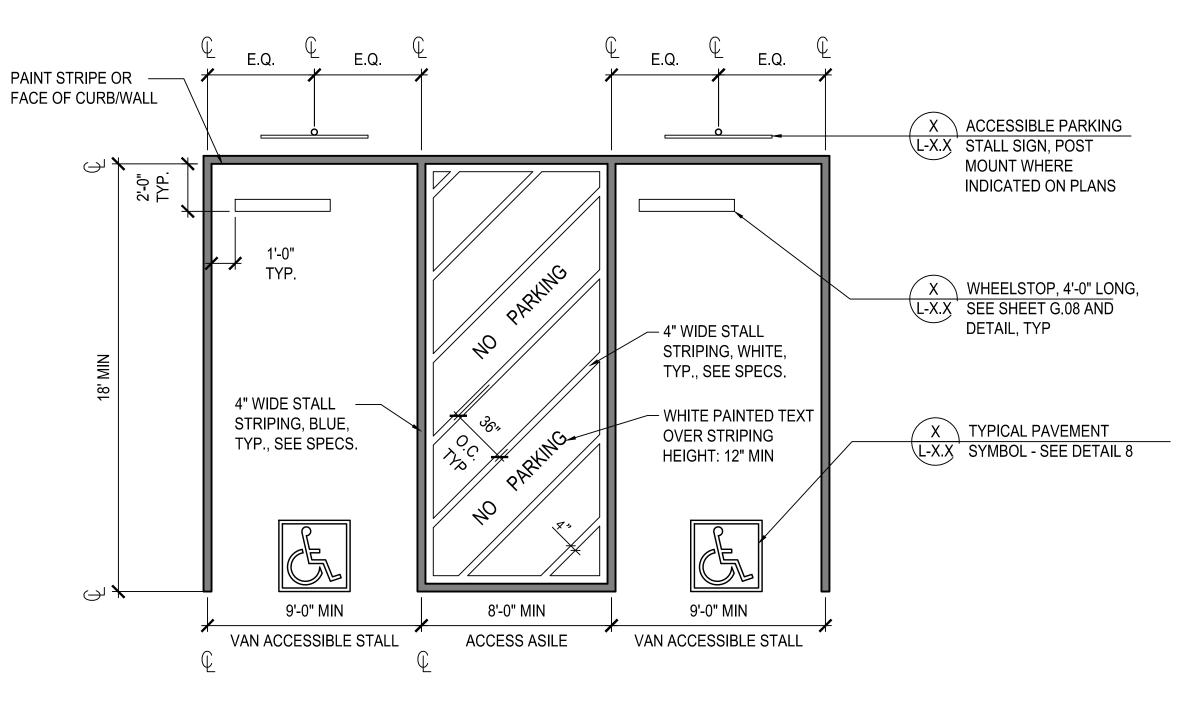

SLOPE SHALL NOT EXCEED 1:48 FOR PARKING AREAS AND ACCESS AISLES

(X) ACCESSIBLE PARKING


SCALE:

N.T.S.

LANDSCAPE CONSTRUCTION DETAILS

Sheet No. L-6.3 AS NOTED Project No. 1804

Original Sheet Size: 22"x34"

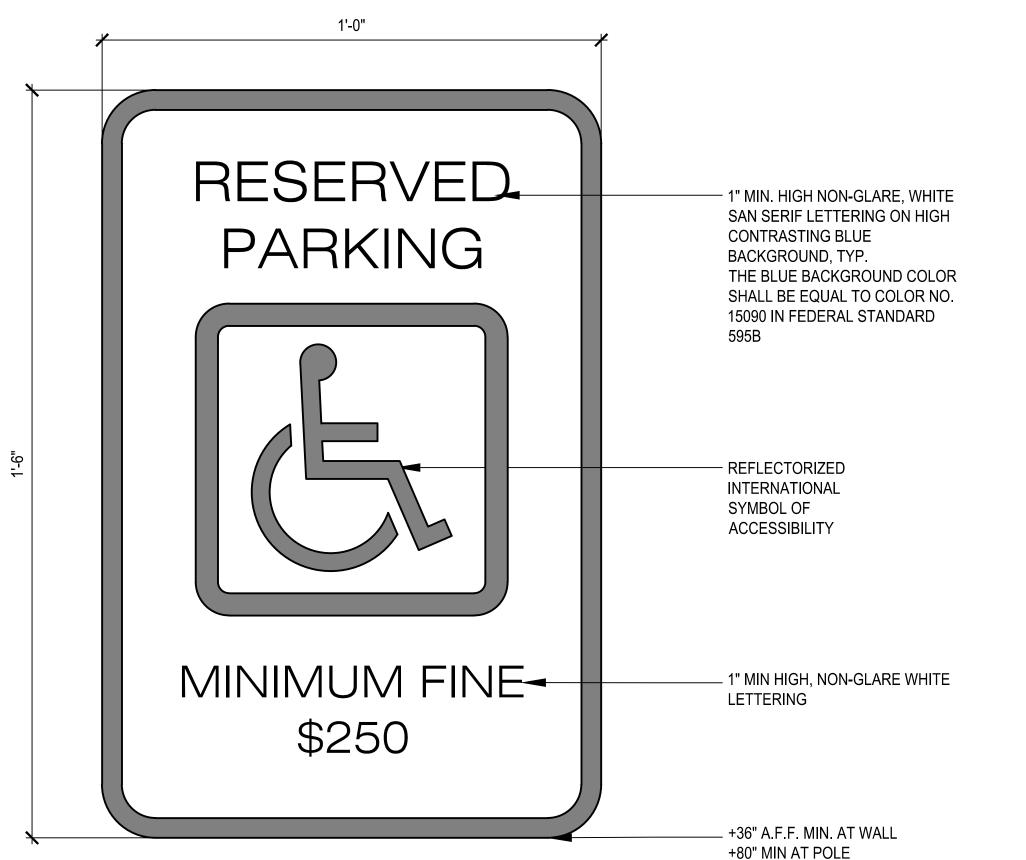

Bureau Mgr. Section Mgr.

BUILDING DESIGN AND CONSTRUCTION DIVISION

BUREAU OF LANDSCAPE ARCHITECTURE

Ron Alameda - City Architect

Jennifer Cooper - Bureau Manager

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970 47th Avenue


San Francisco, CA 94121

Consultant

95% CD SET 11/02/20 Revisions

Proj. L.Arch. Designed Drawn Checked

Drawing Title

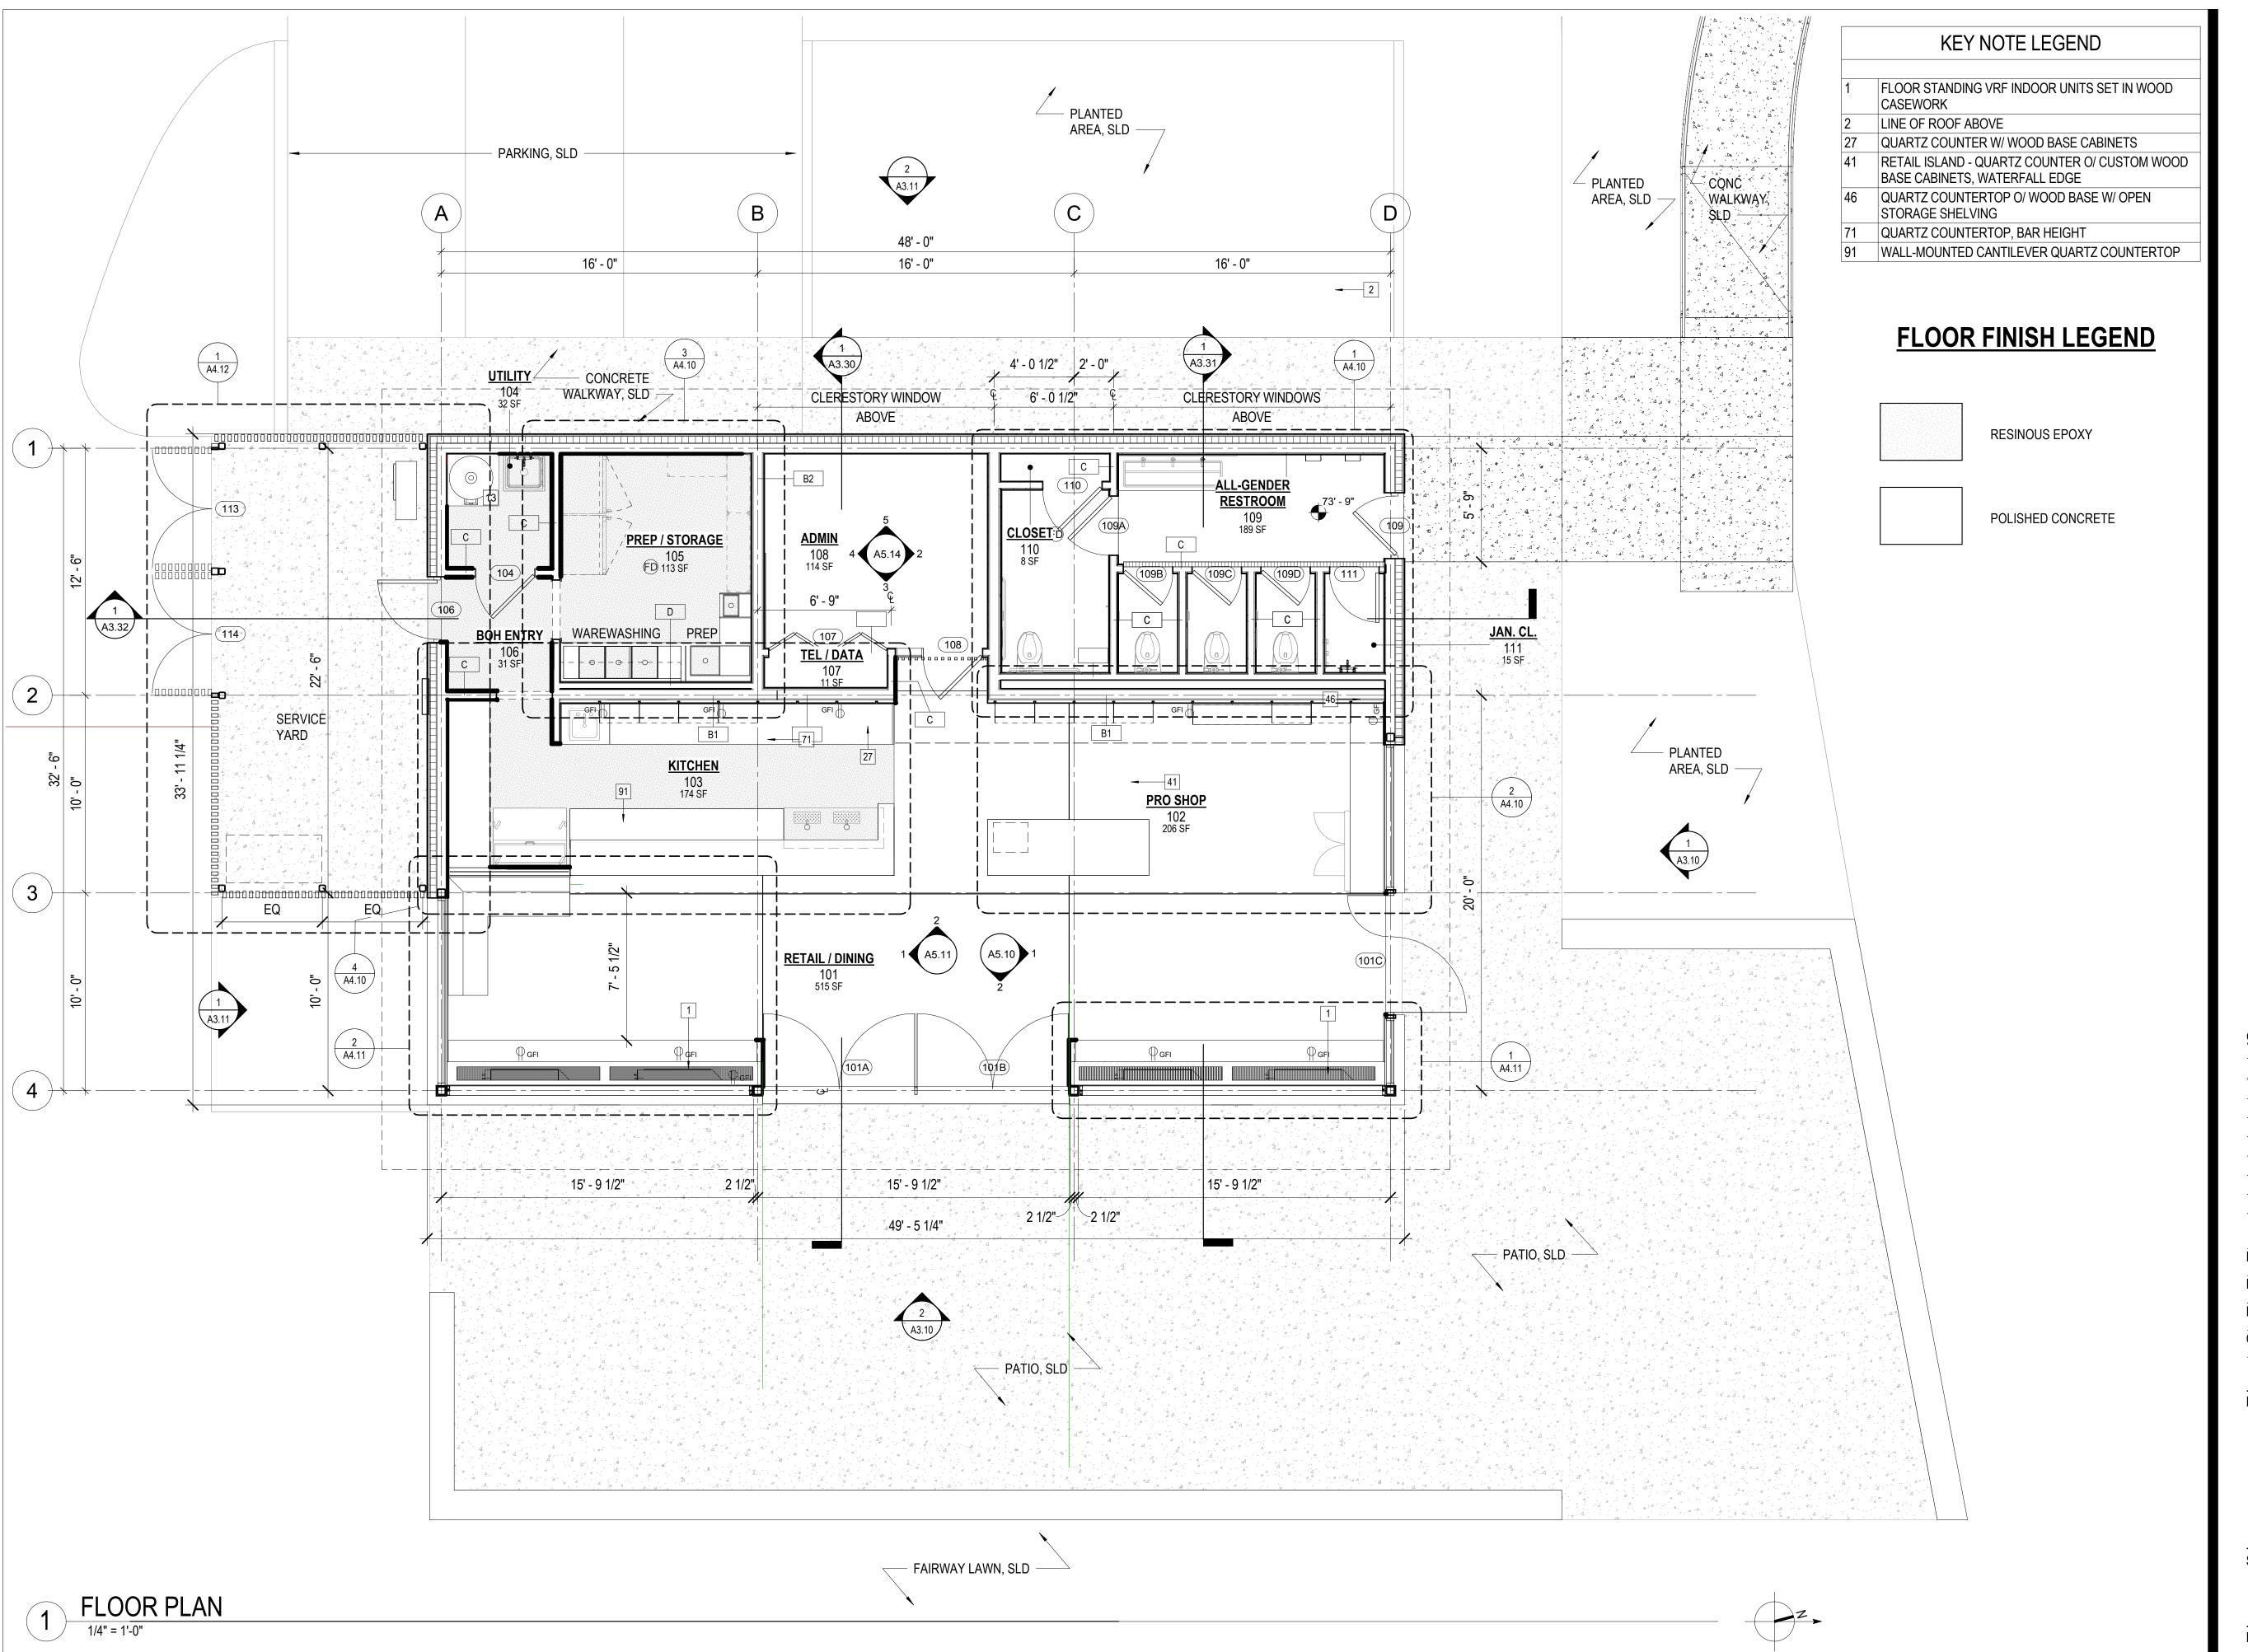

BUREAU OF ARCHITECTURE



Ron Alameida - City Architect

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Consultant

No. Date Revisions

11.16.2020

Checked


Drawing Title

FLOOR PLAN

A2.10

As indicated

Project No.

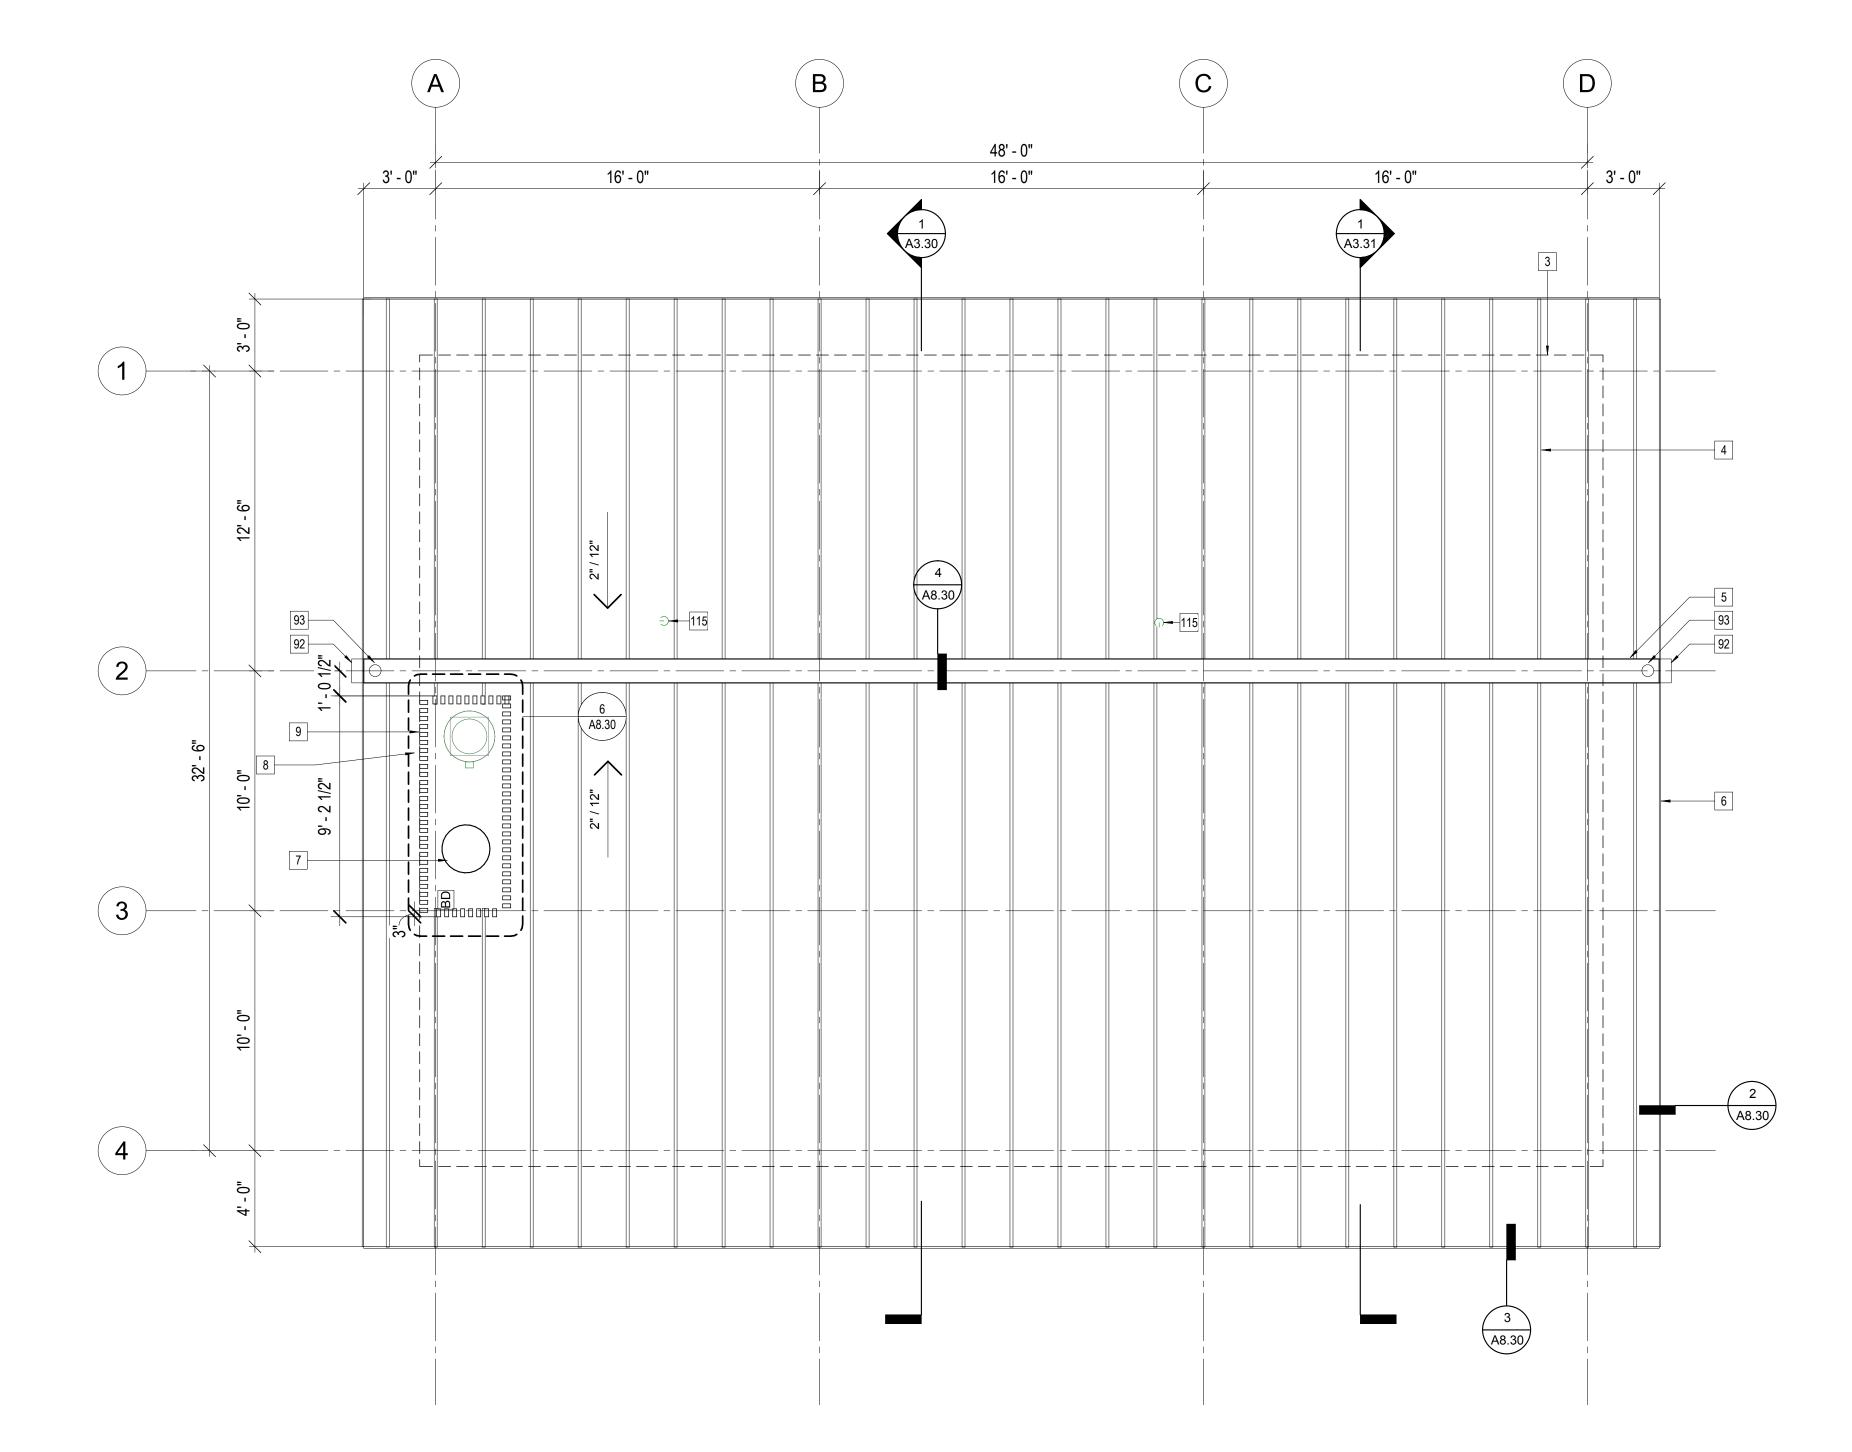

KEY NOTE LEGEND

LINE OF BUILDING FOOTPRINT BELOW STANDING SEAM MTL ROOF

ALUM BOX GUTTER W/ LEAF SCREEN

ALUM FASCIA CLADDING AT EAVES, TYP ALL SIDES

RANGE HOOD EXHAUST FAN ON CURB

GRAVITY RELIEF VENT ON CURB

SLATTED CEDAR ROOF SCREEN ENCLOSURE GUTTER SCUPPERED OVERFLOW

93 CAST BRONZE GUTTER TO 3"Ø COPPER RWL TO BELOW

115 PLUMBING VENT, TYP X2, SPD

BUREAU OF ARCHITECTURE



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Revisions

Checked

Drawing Title

ROOF PLAN


A2.20

1/4" = 1'-0"

1804

ROOF PLAN

1/4" = 1'-0"

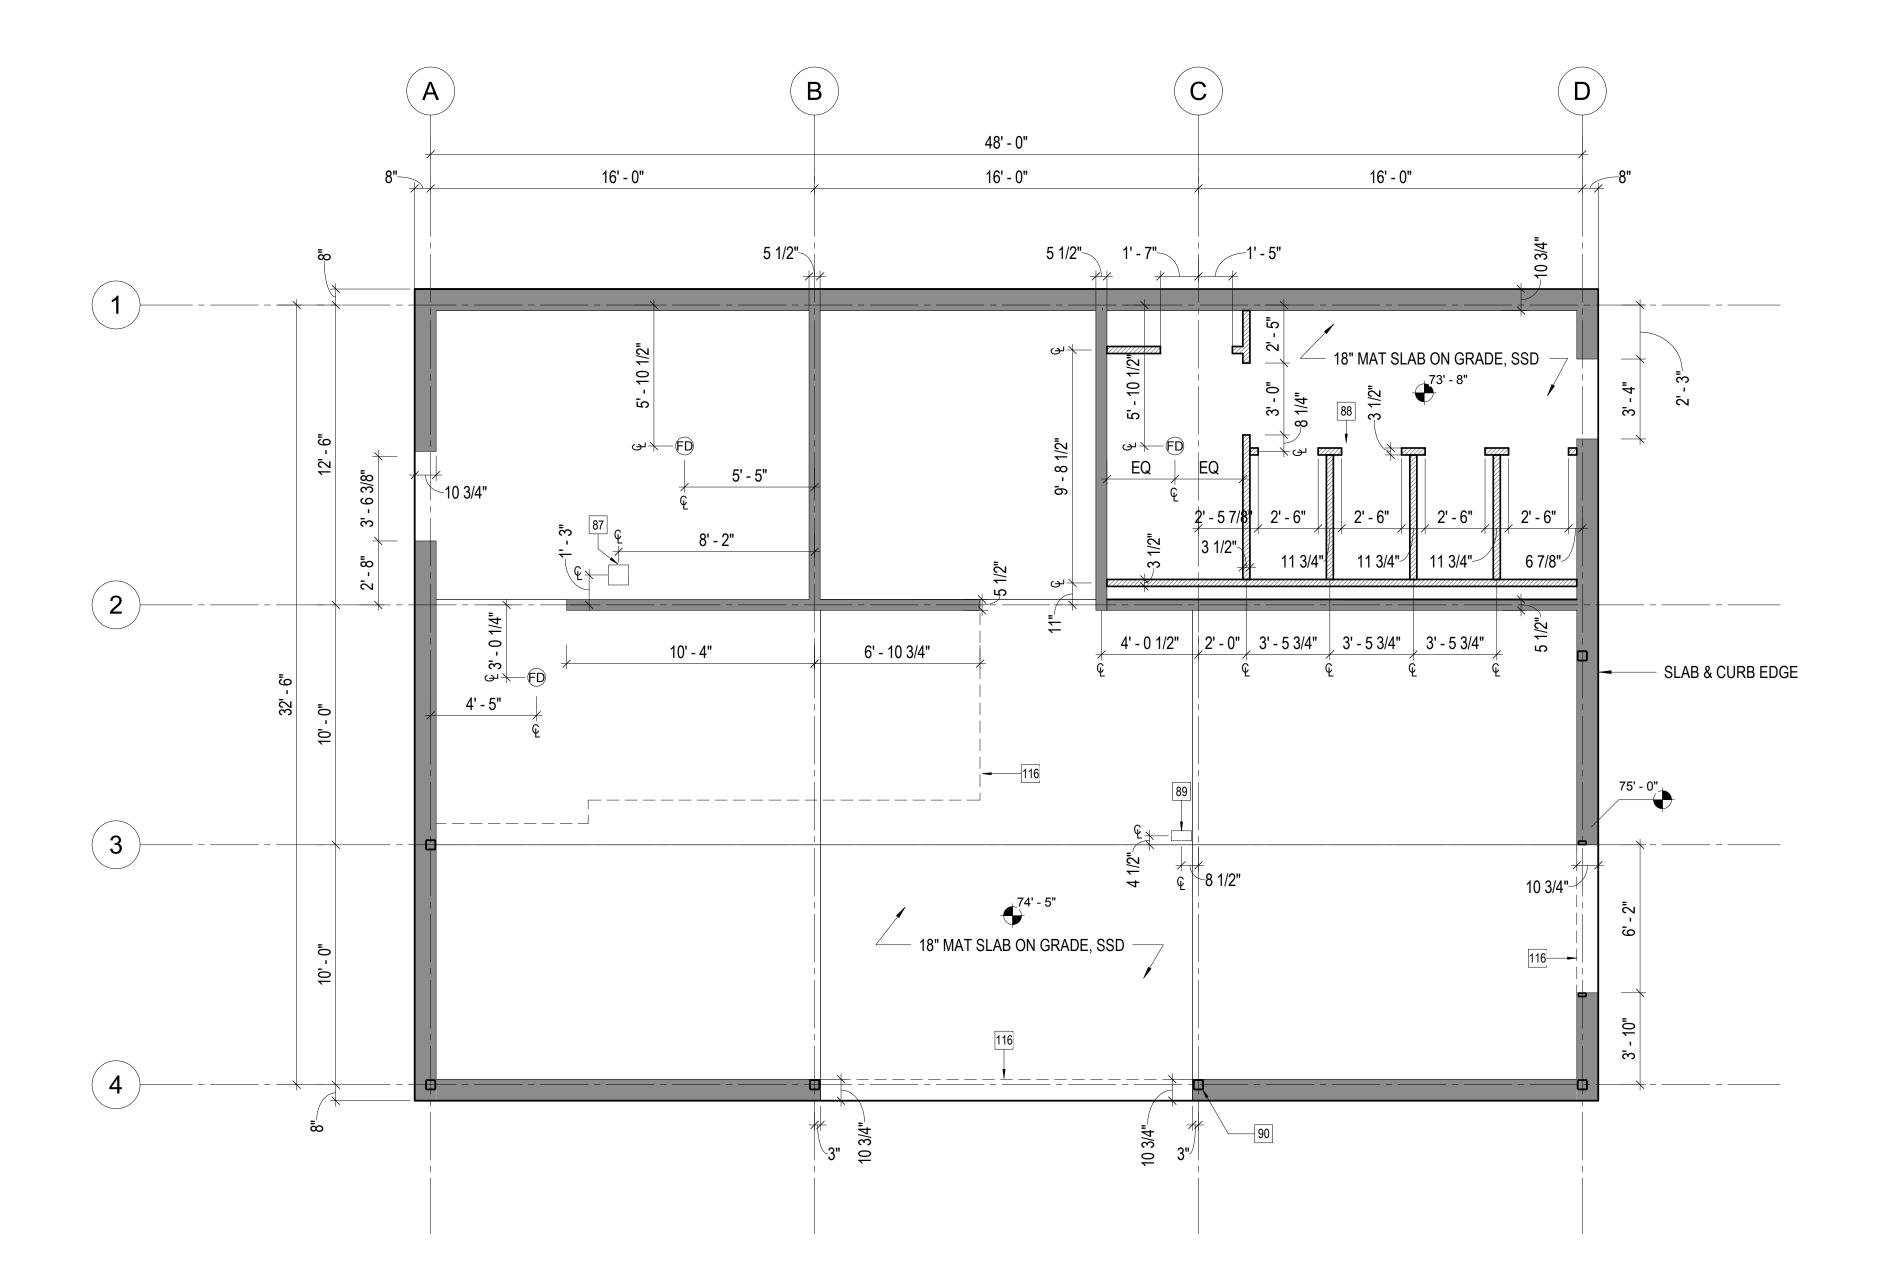

CONCRETE CURB, ELEVATION @ +75' - 0"



3-1/2" WIDE CONCRETE CURB, ELEVATION @ +74' - 3"

SLAB PLAN LEGEND

SLAB PLAN
1/4" = 1'-0"

BUREAU OF ARCHITECTURE



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Revisions

Drawn Checked

Drawing Title


SLAB PLAN

Sheet No. A2.30

Project No.

1804

As indicated

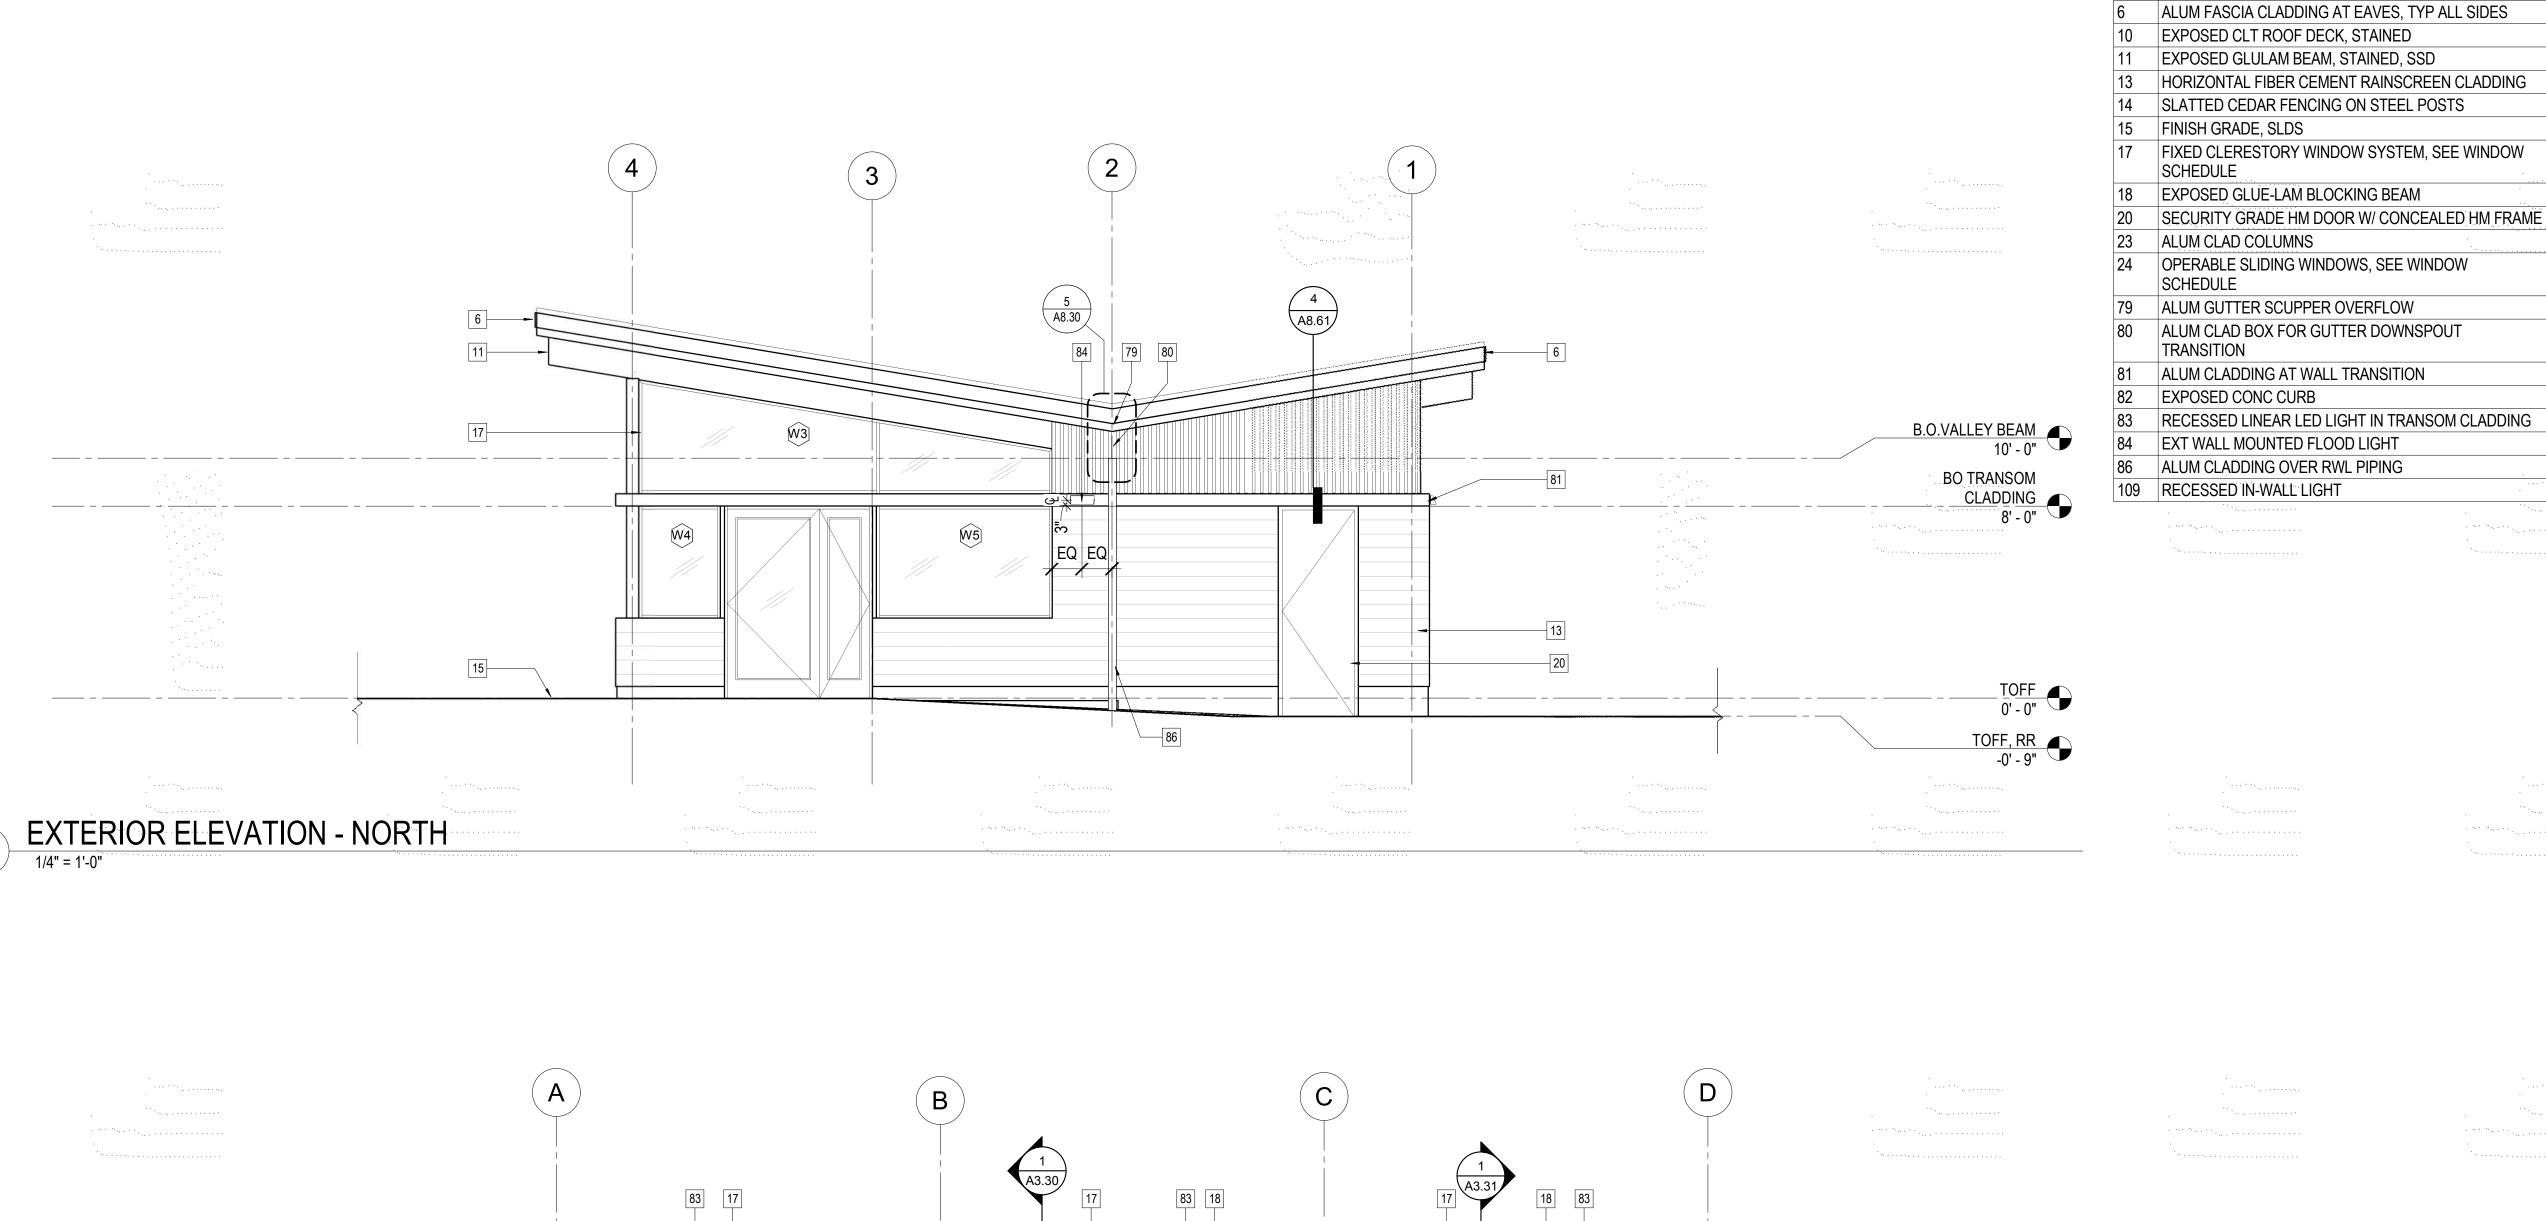

BUREAU OF ARCHITECTURE KEY NOTE LEGEND



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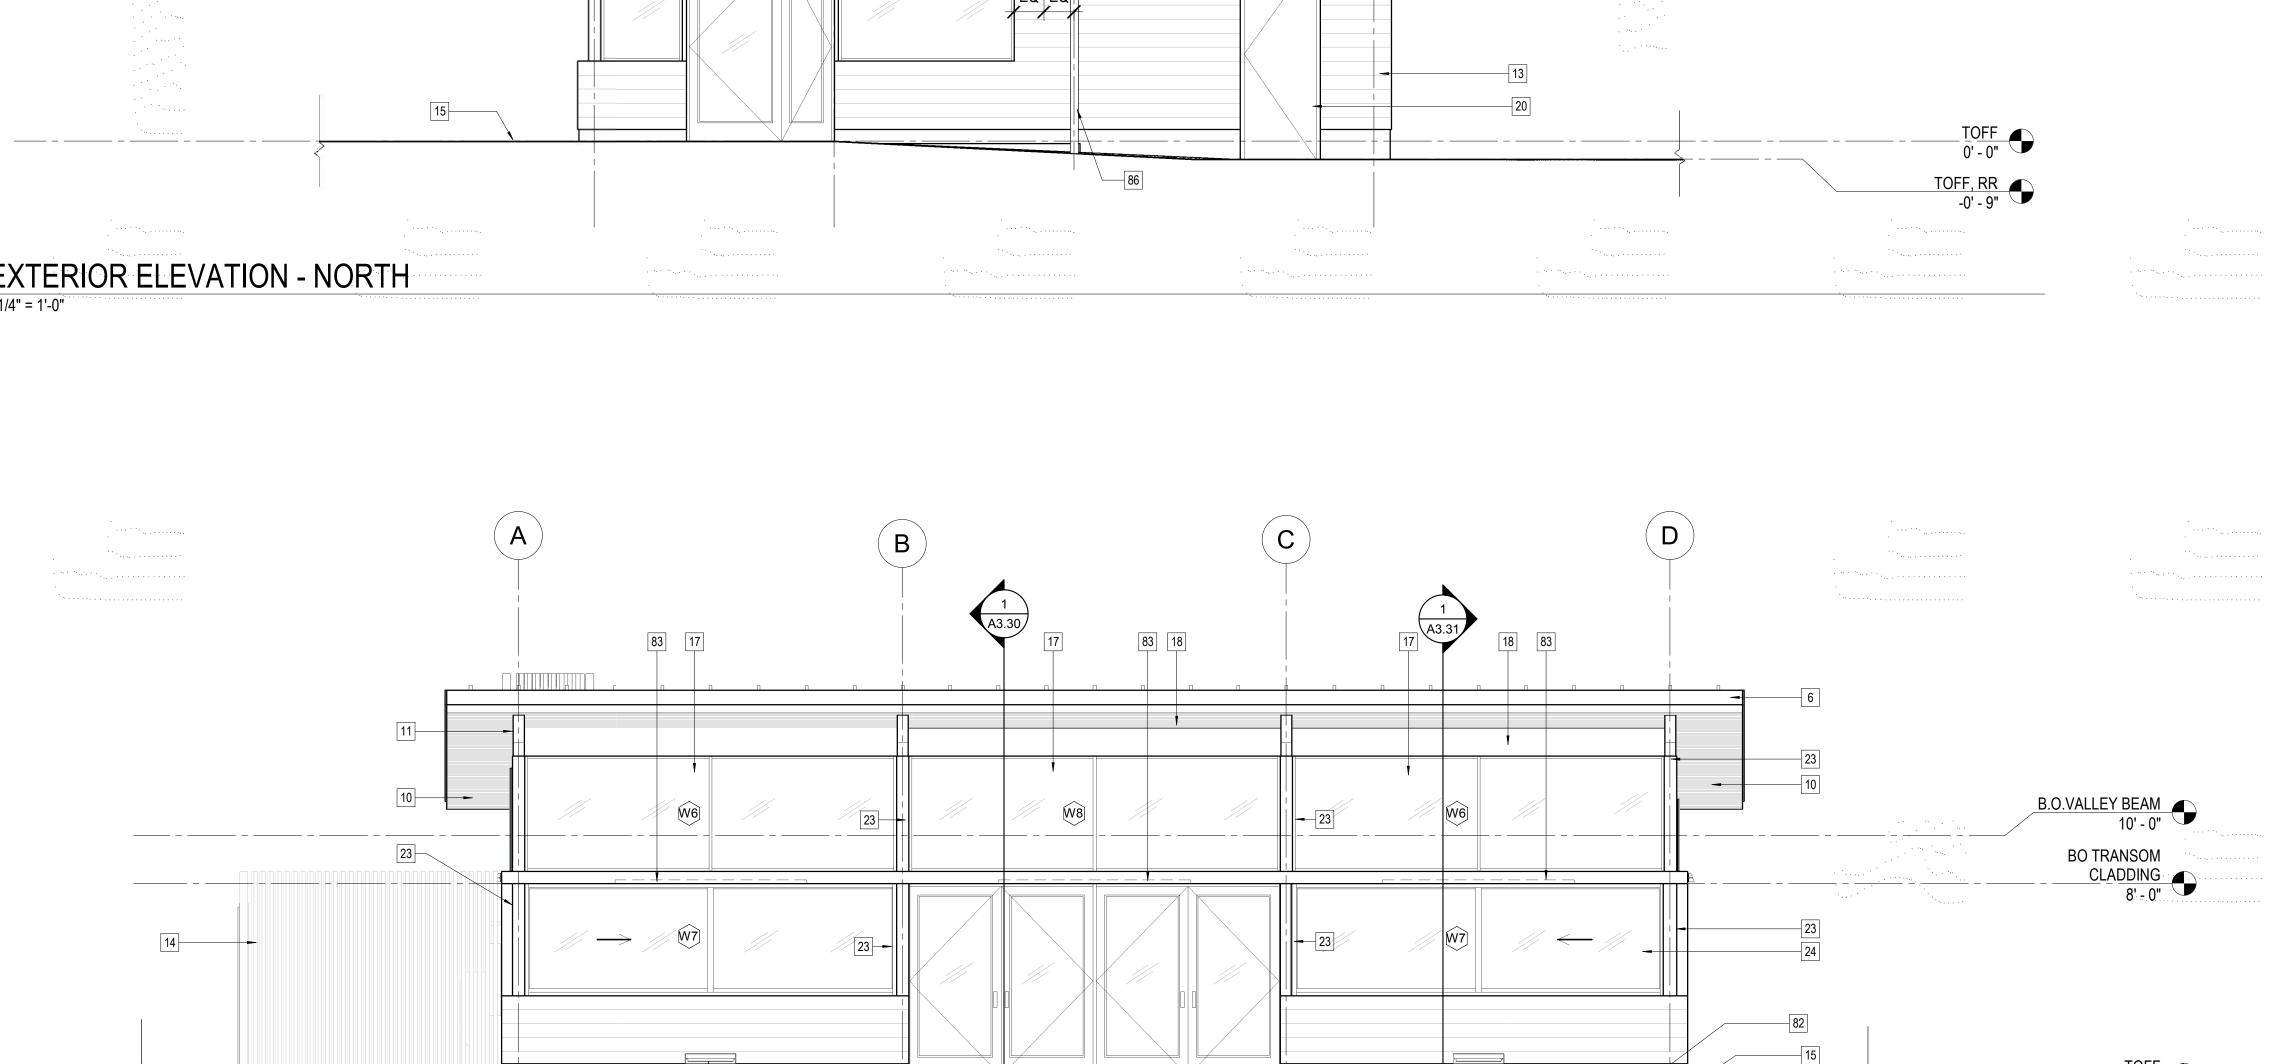
11.16.2020 Revisions No. Date Checked


Drawing Title

EXTERIOR BUILDING **ELEVATIONS_NORTH & EAST**

A3.10 1/4" = 1'-0"

Project No.



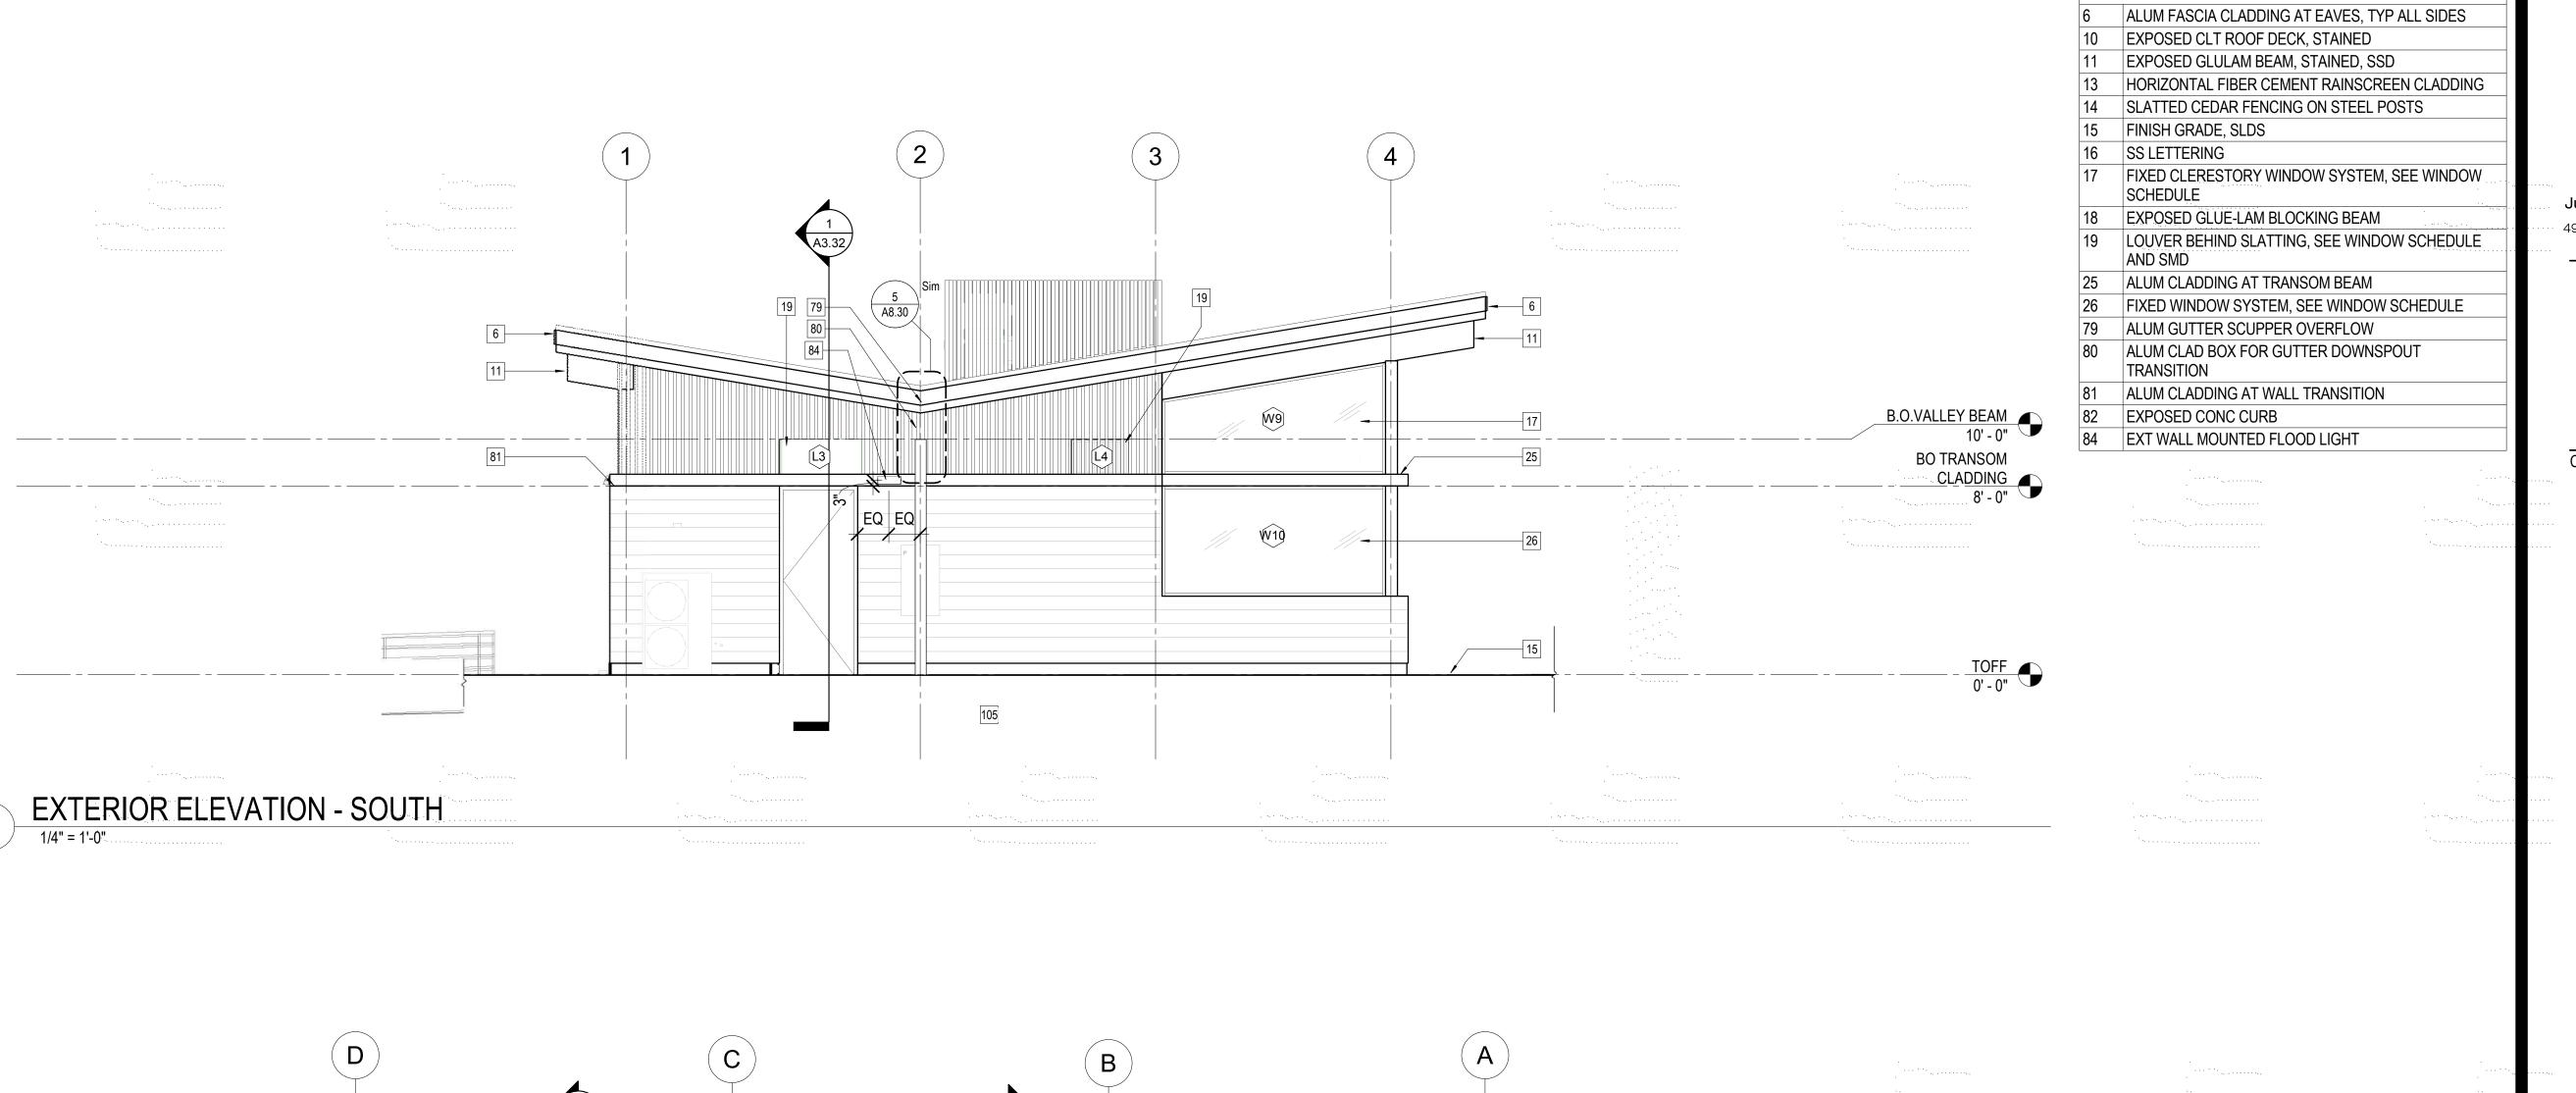

KEY NOTE LEGEND

BUREAU OF ARCHITECTURE



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11.16.2020 Revisions No. Date

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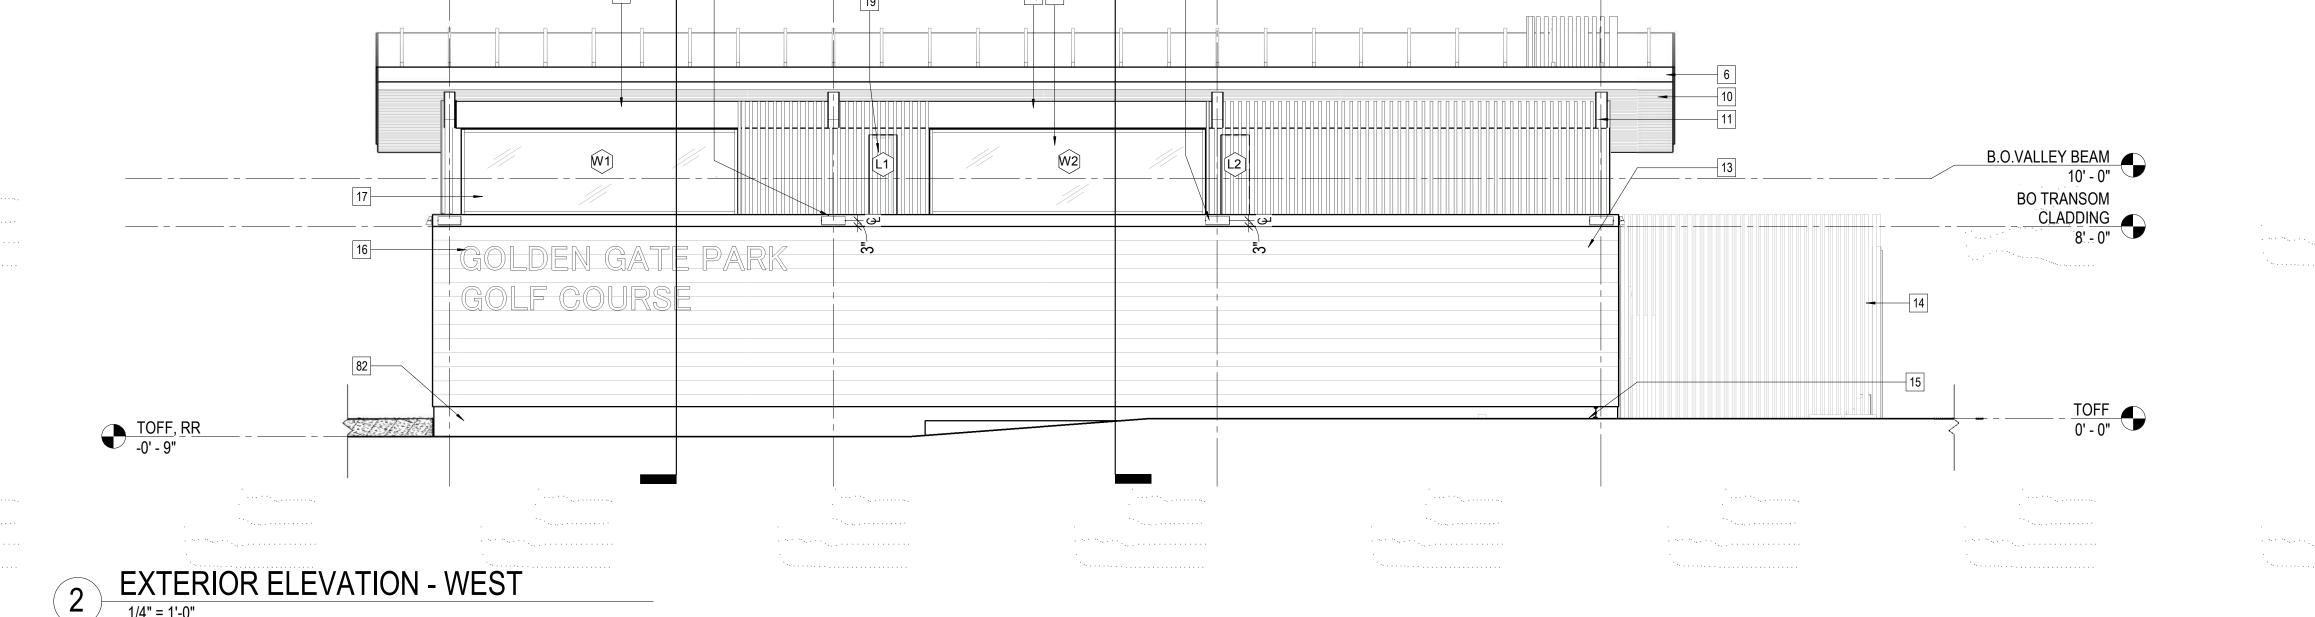
Drawing Title

EXTERIOR BUILDING **ELEVATIONS_SOUTH & WEST**

A3.11

1/4" = 1'-0"

Project No.



11 EXPOSED GLULAM BEAM, STAINED, SSD

17 FIXED CLERESTORY WINDOW SYSTEM, SEE WINDOW SCHEDULE

26 FIXED WINDOW SYSTEM, SEE WINDOW SCHEDULE | 54 | SS HANDWASH SINK W/ SIDE SPLASH GUARDS, DROP INTO COUNTERTOP

67 GLASS SNEEZE GUARD ON COUNTER

70 FIN FLOOR, SEE ROOM FINISH SCHEDULE

71 QUARTZ COUNTERTOP, BAR HEIGHT 72 GLULAM BEAM SHAPED AT EAVE

73 PATIO PAVING, SLD


74 PATIO DOORS, SEE DOOR SCHEDULE

| 75 | HSS SPANDREL BEAM, MTL CLAD, SSD

76 STANDING SEAM ALUM ROOF

78 WOOD SLAT CLAD BULKHEAD @ HOOD 96 BUILT-IN WOOD BANQUETTE

106 TILE CLAD WALL, BEYOND

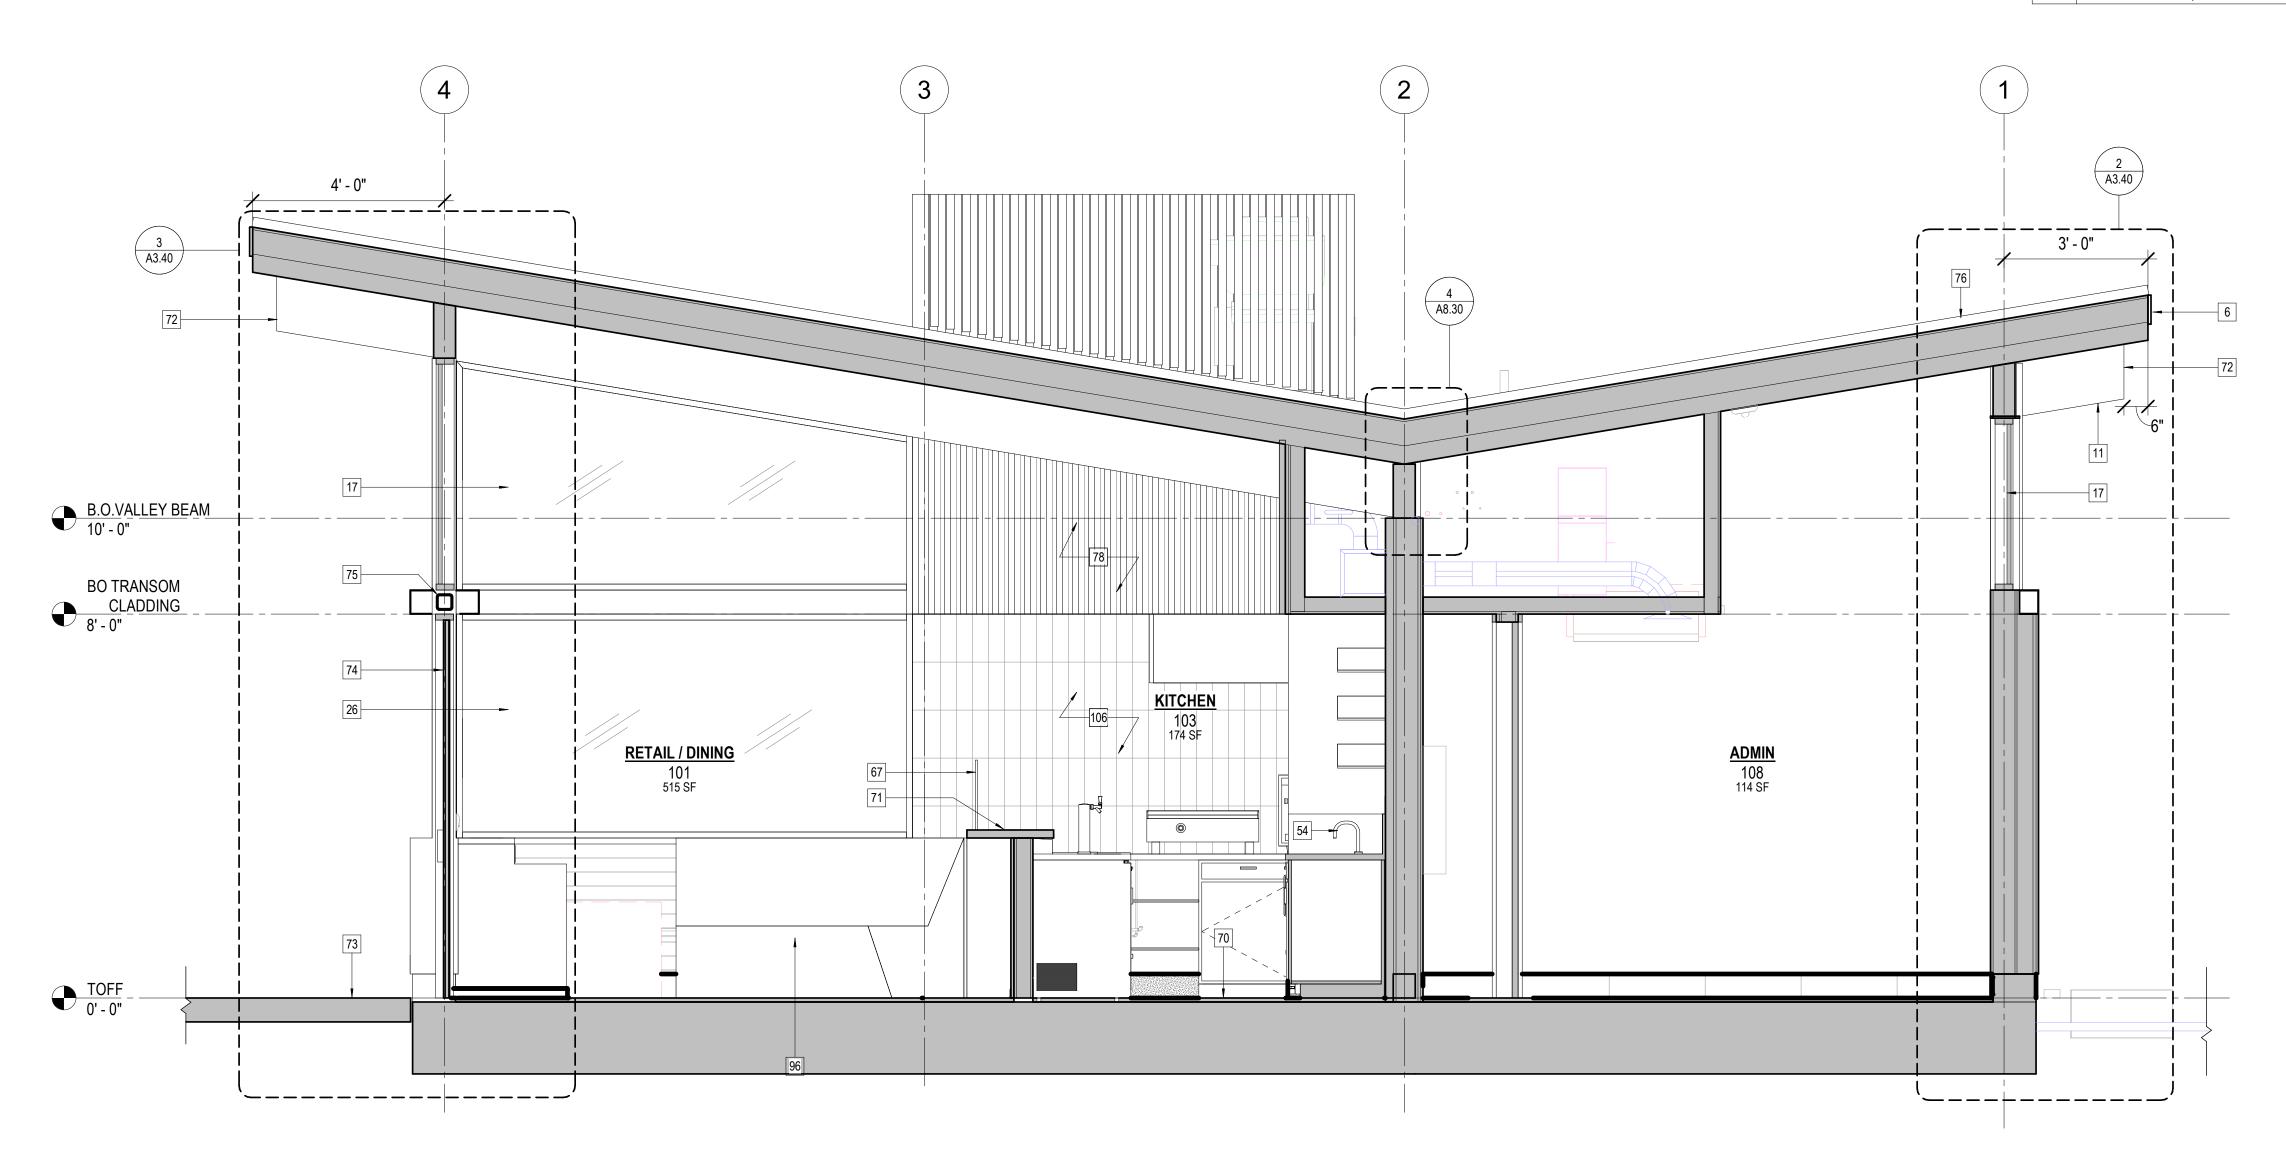

BUILDING SECTION - THROUGH ADMIN
1/2" = 1'-0"

BUREAU OF ARCHITECTURE



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Drawn

Checked

Drawing Title

BUILDING SECTIONS

A3.30

1/2" = 1'-0"

BUILDING SECTION - THROUGH RESTROOM

1/2" = 1'-0"

BUREAU OF ARCHITECTURE



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No. Date Revisions

Checked

Drawing Title

BUILDING SECTIONS

A3.31

1/2" = 1'-0"

KEY NOTE LEGEND 110 EXHAUST LOUVER 111 CLEANABLE ACT TILE CEILING

BUREAU OF ARCHITECTURE




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No. Date

Checked

Drawing Title

BUILDING SECTIONS

A3.32

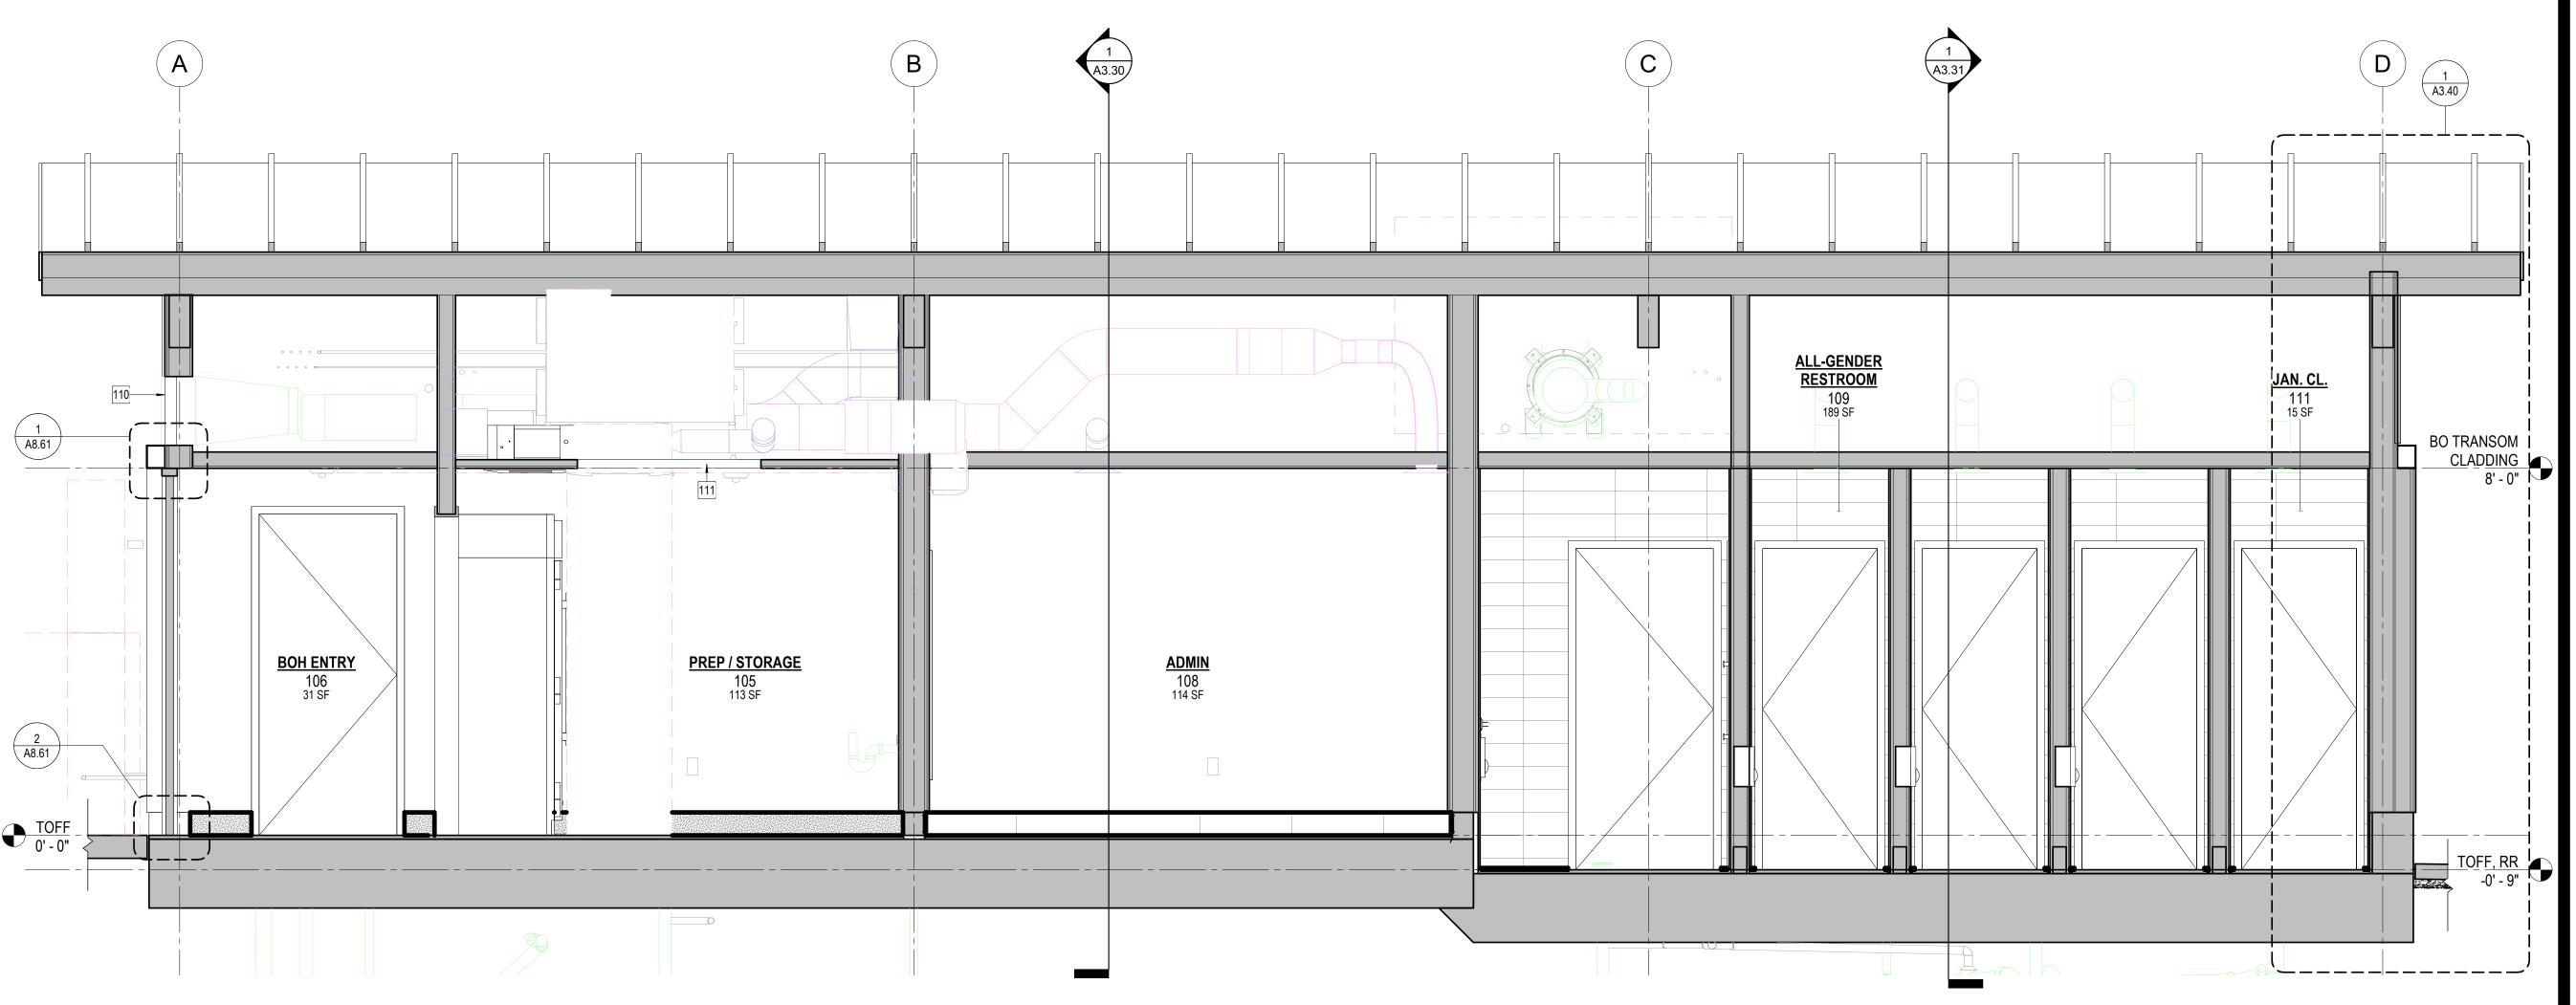1/2" = 1'-0"


11.16.2020

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Project No.

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LONGITUDINAL BUILDING SECTION -THROUGH ADMIN



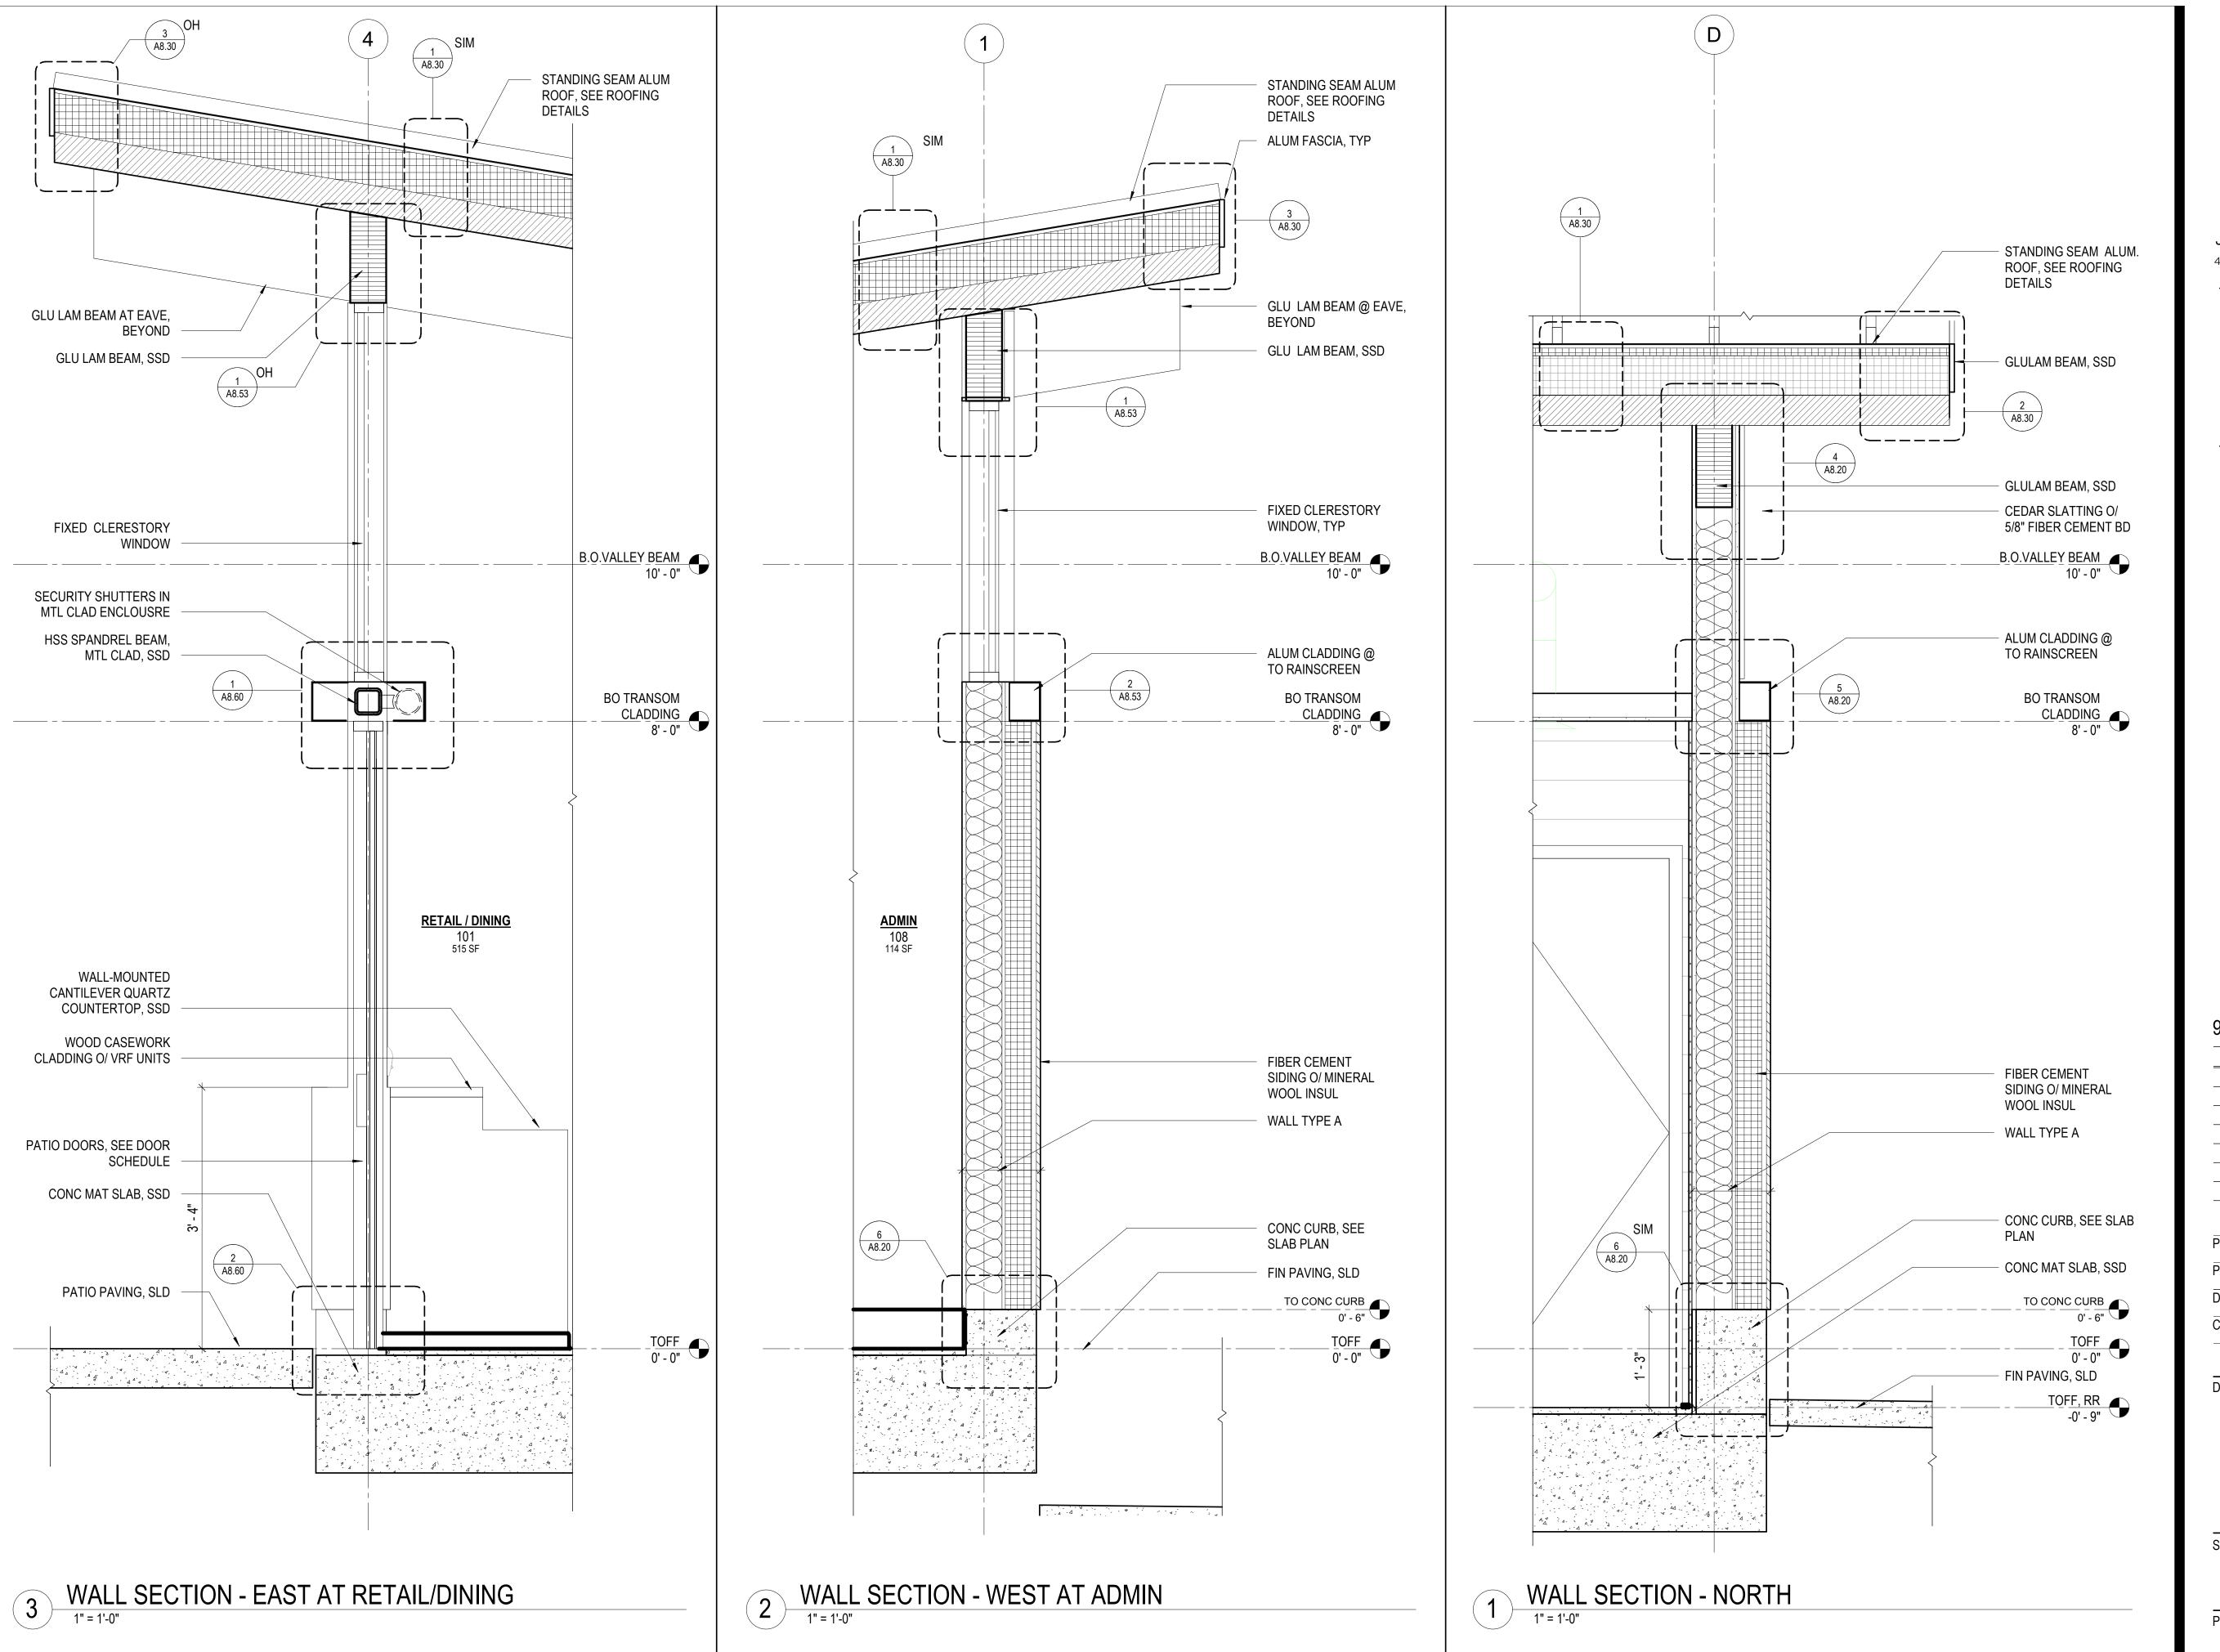

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No. Date Revisions

11.16.2020

Drawn Checked

Drawing Title


WALL SECTIONS

Sheet No.

A3.40

1" = 1'-0"

Project No.

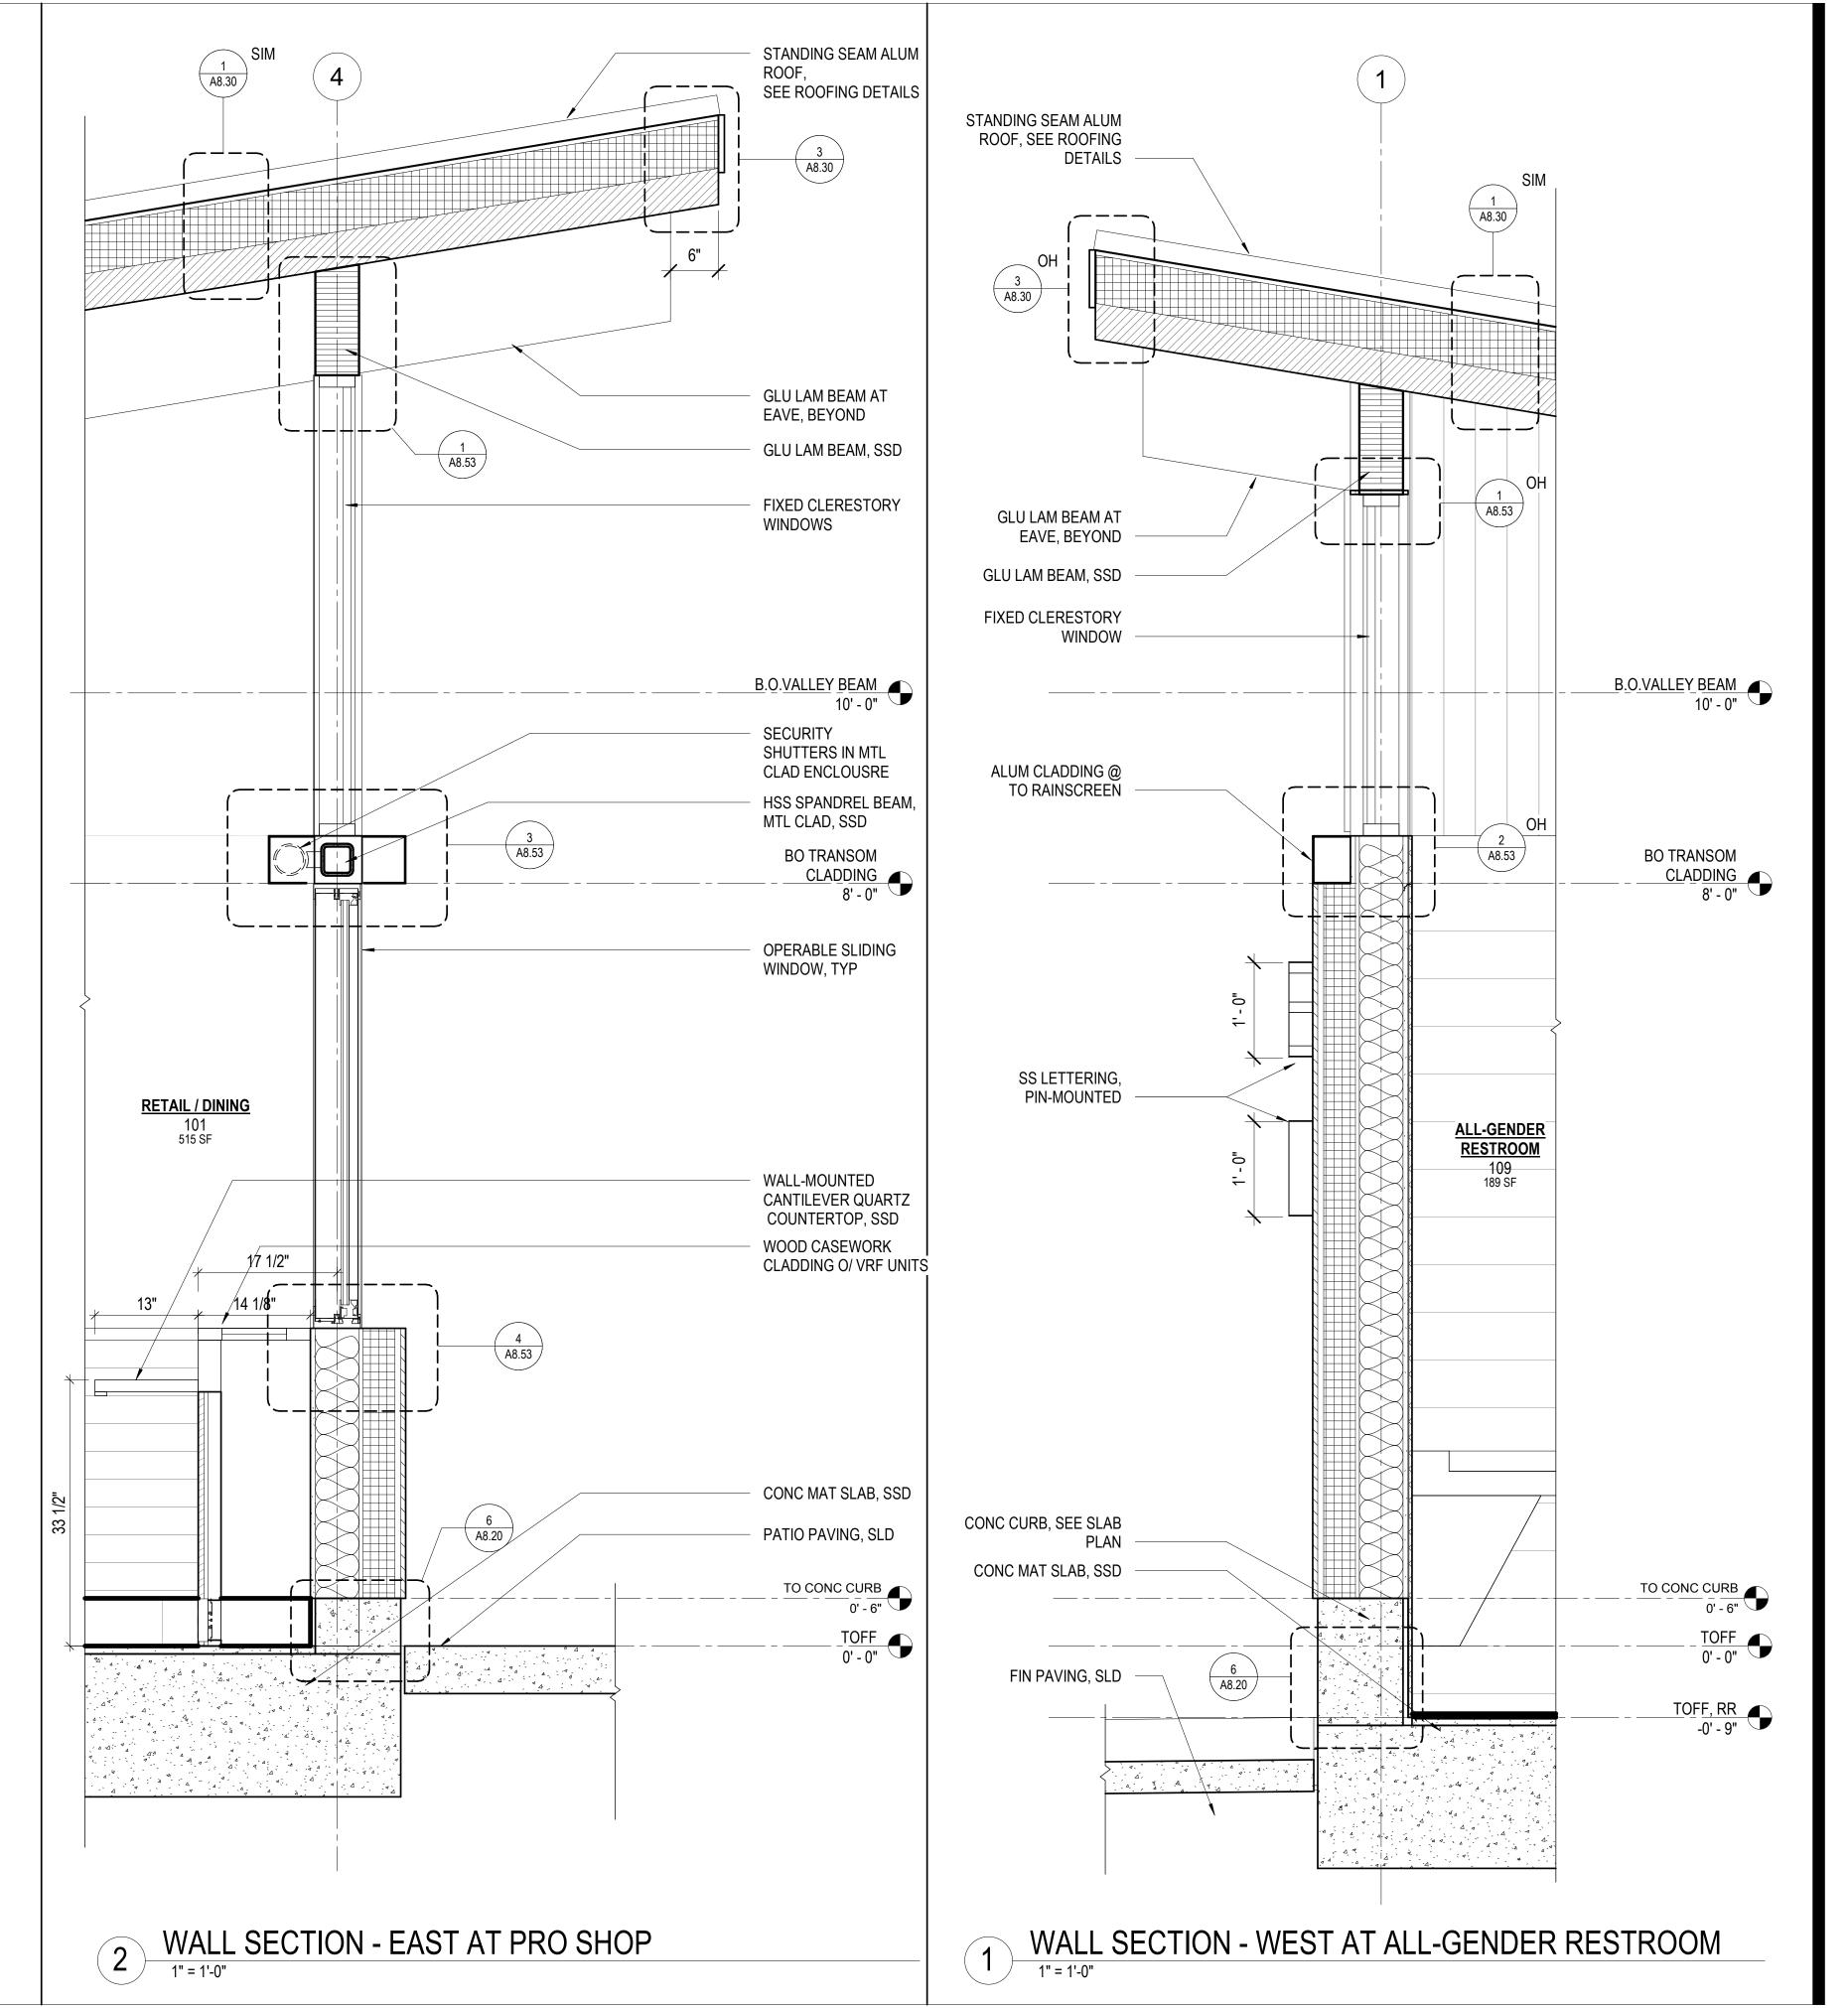



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Consultant

No. Date Revisions

Paul DeFreitas Drawn Checked

11.16.2020

Drawing Title


WALL SECTIONS

Sheet No.

A3.41 1" = 1'-0"

Project No.

1804

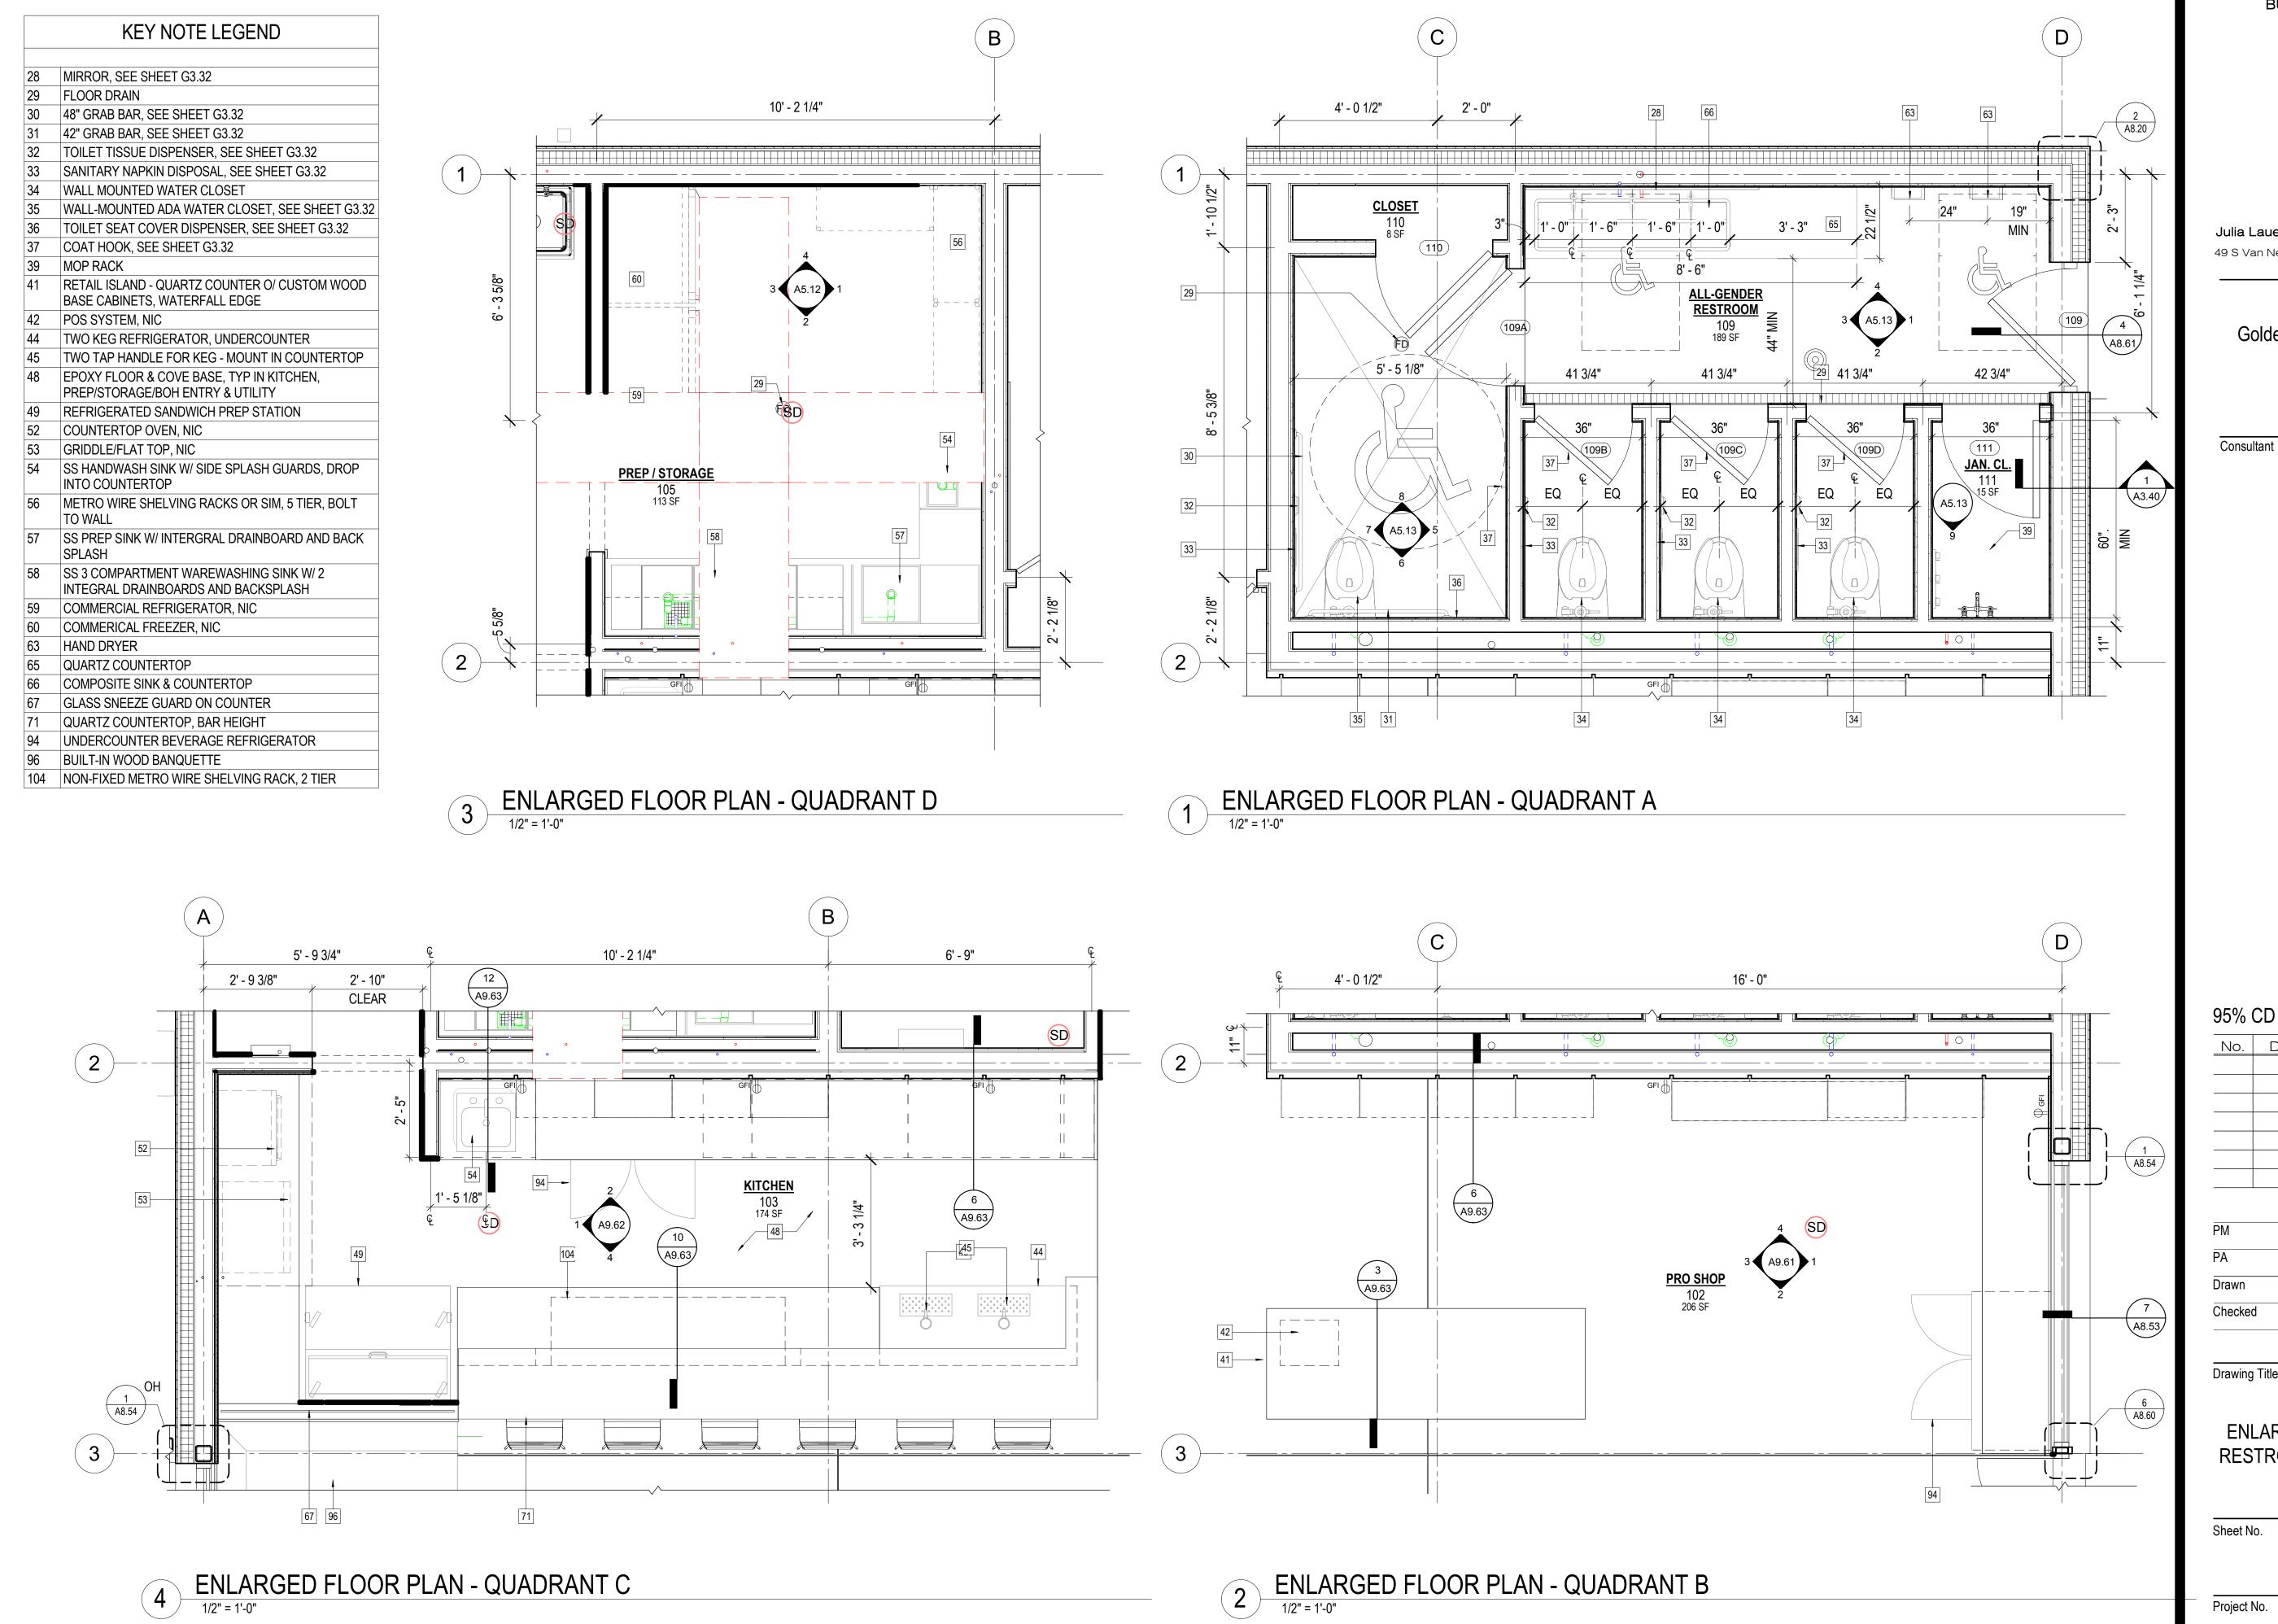



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Revisions No. Date Paul DeFreitas

11.16.2020

Drawing Title


ENLARGED FLOOR PLANS_PREP, RESTROOM, KITCHEN & PRO SHOP


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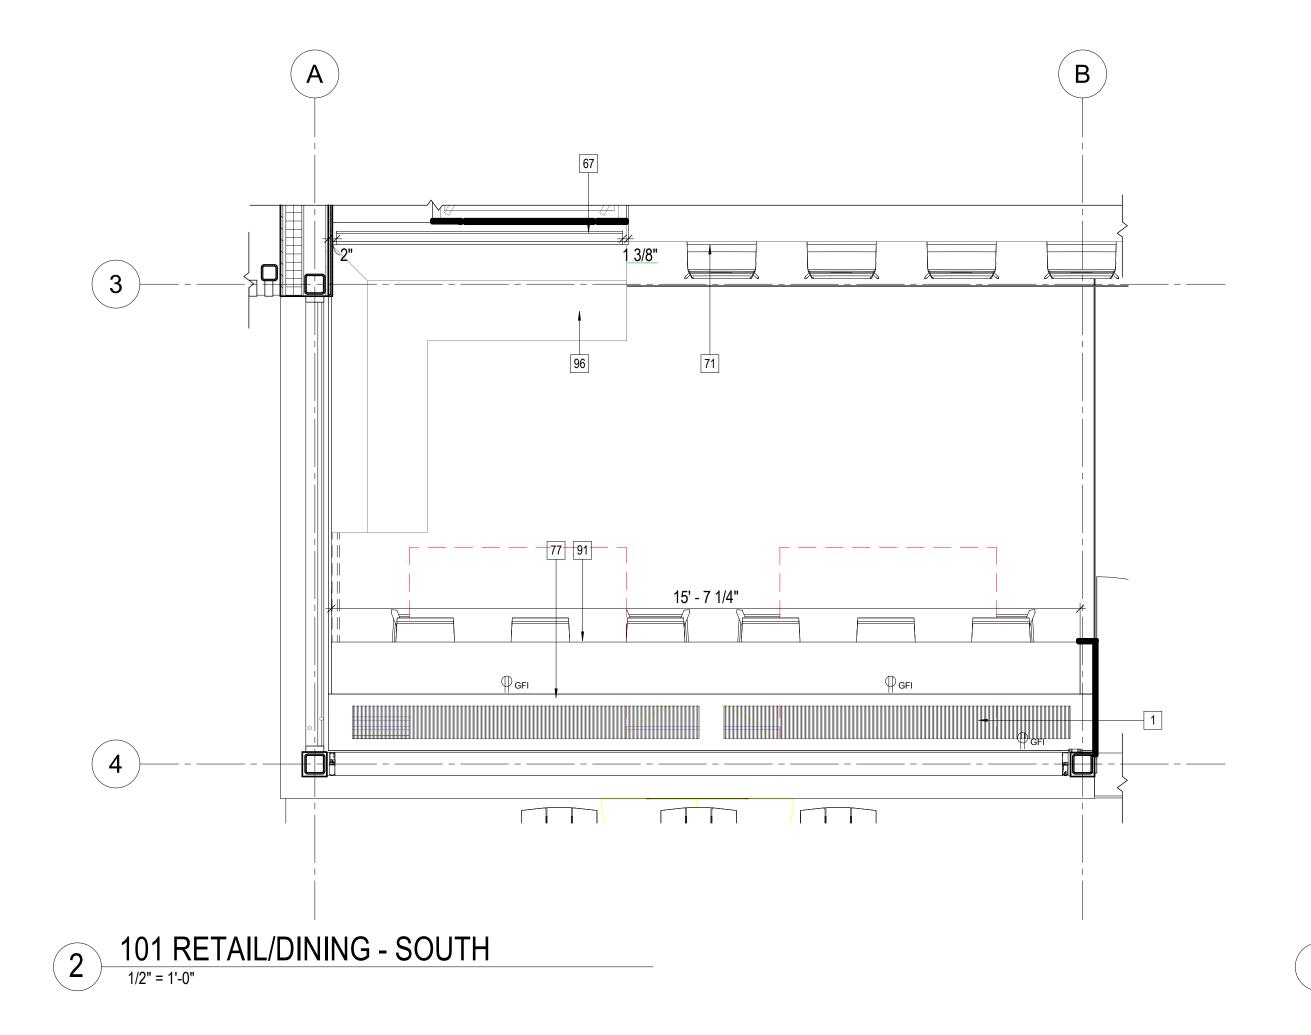
A4.10


1/2" = 1'-0"

1804



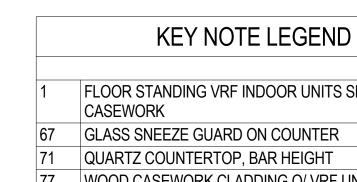

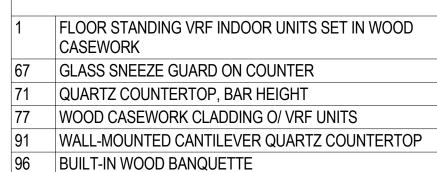

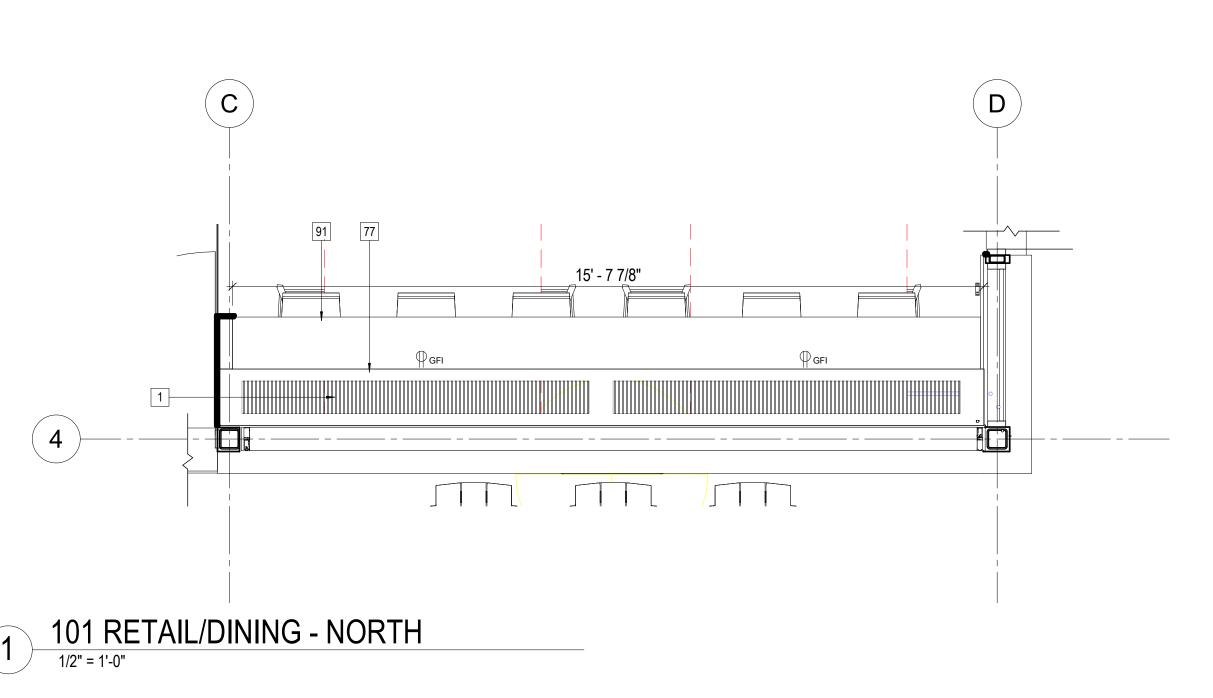



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Project Status

11.16.2020

No.	Date	Revisions
-		

Checked

Drawing Title


ENLARGED FLOOR PLANS_RETAIL/DINING


A4.11

Project No.

1804

1/2" = 1'-0"

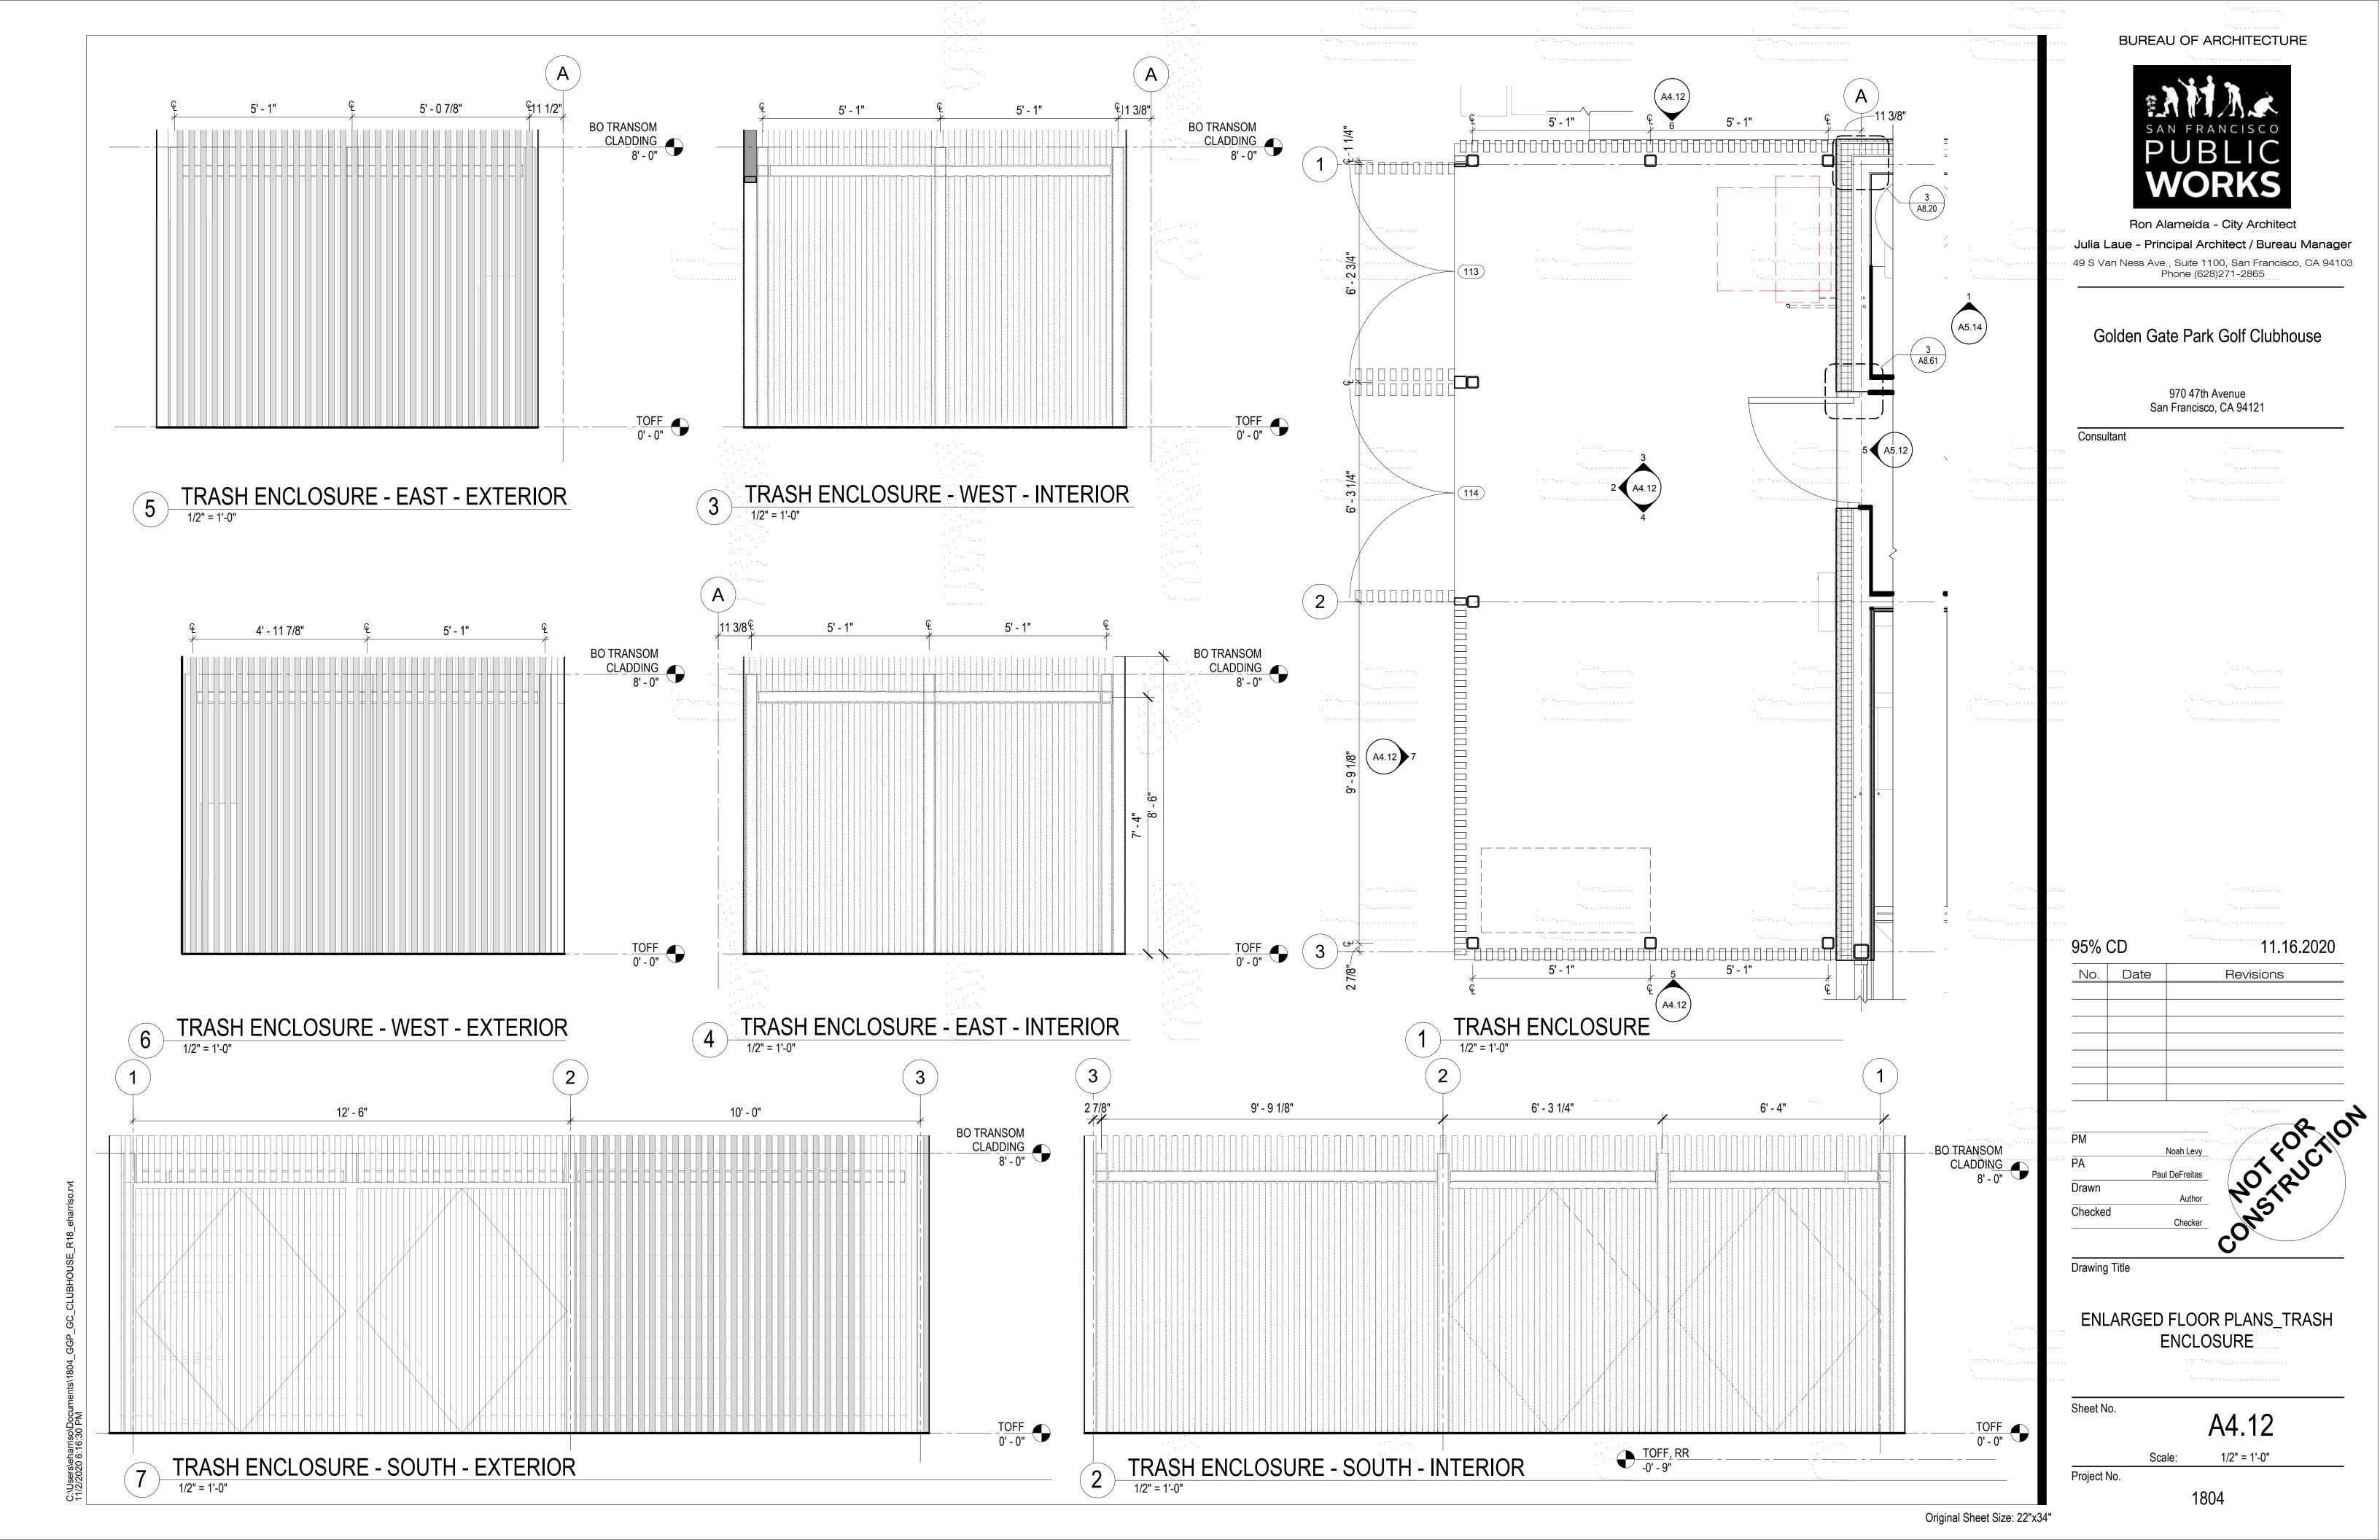

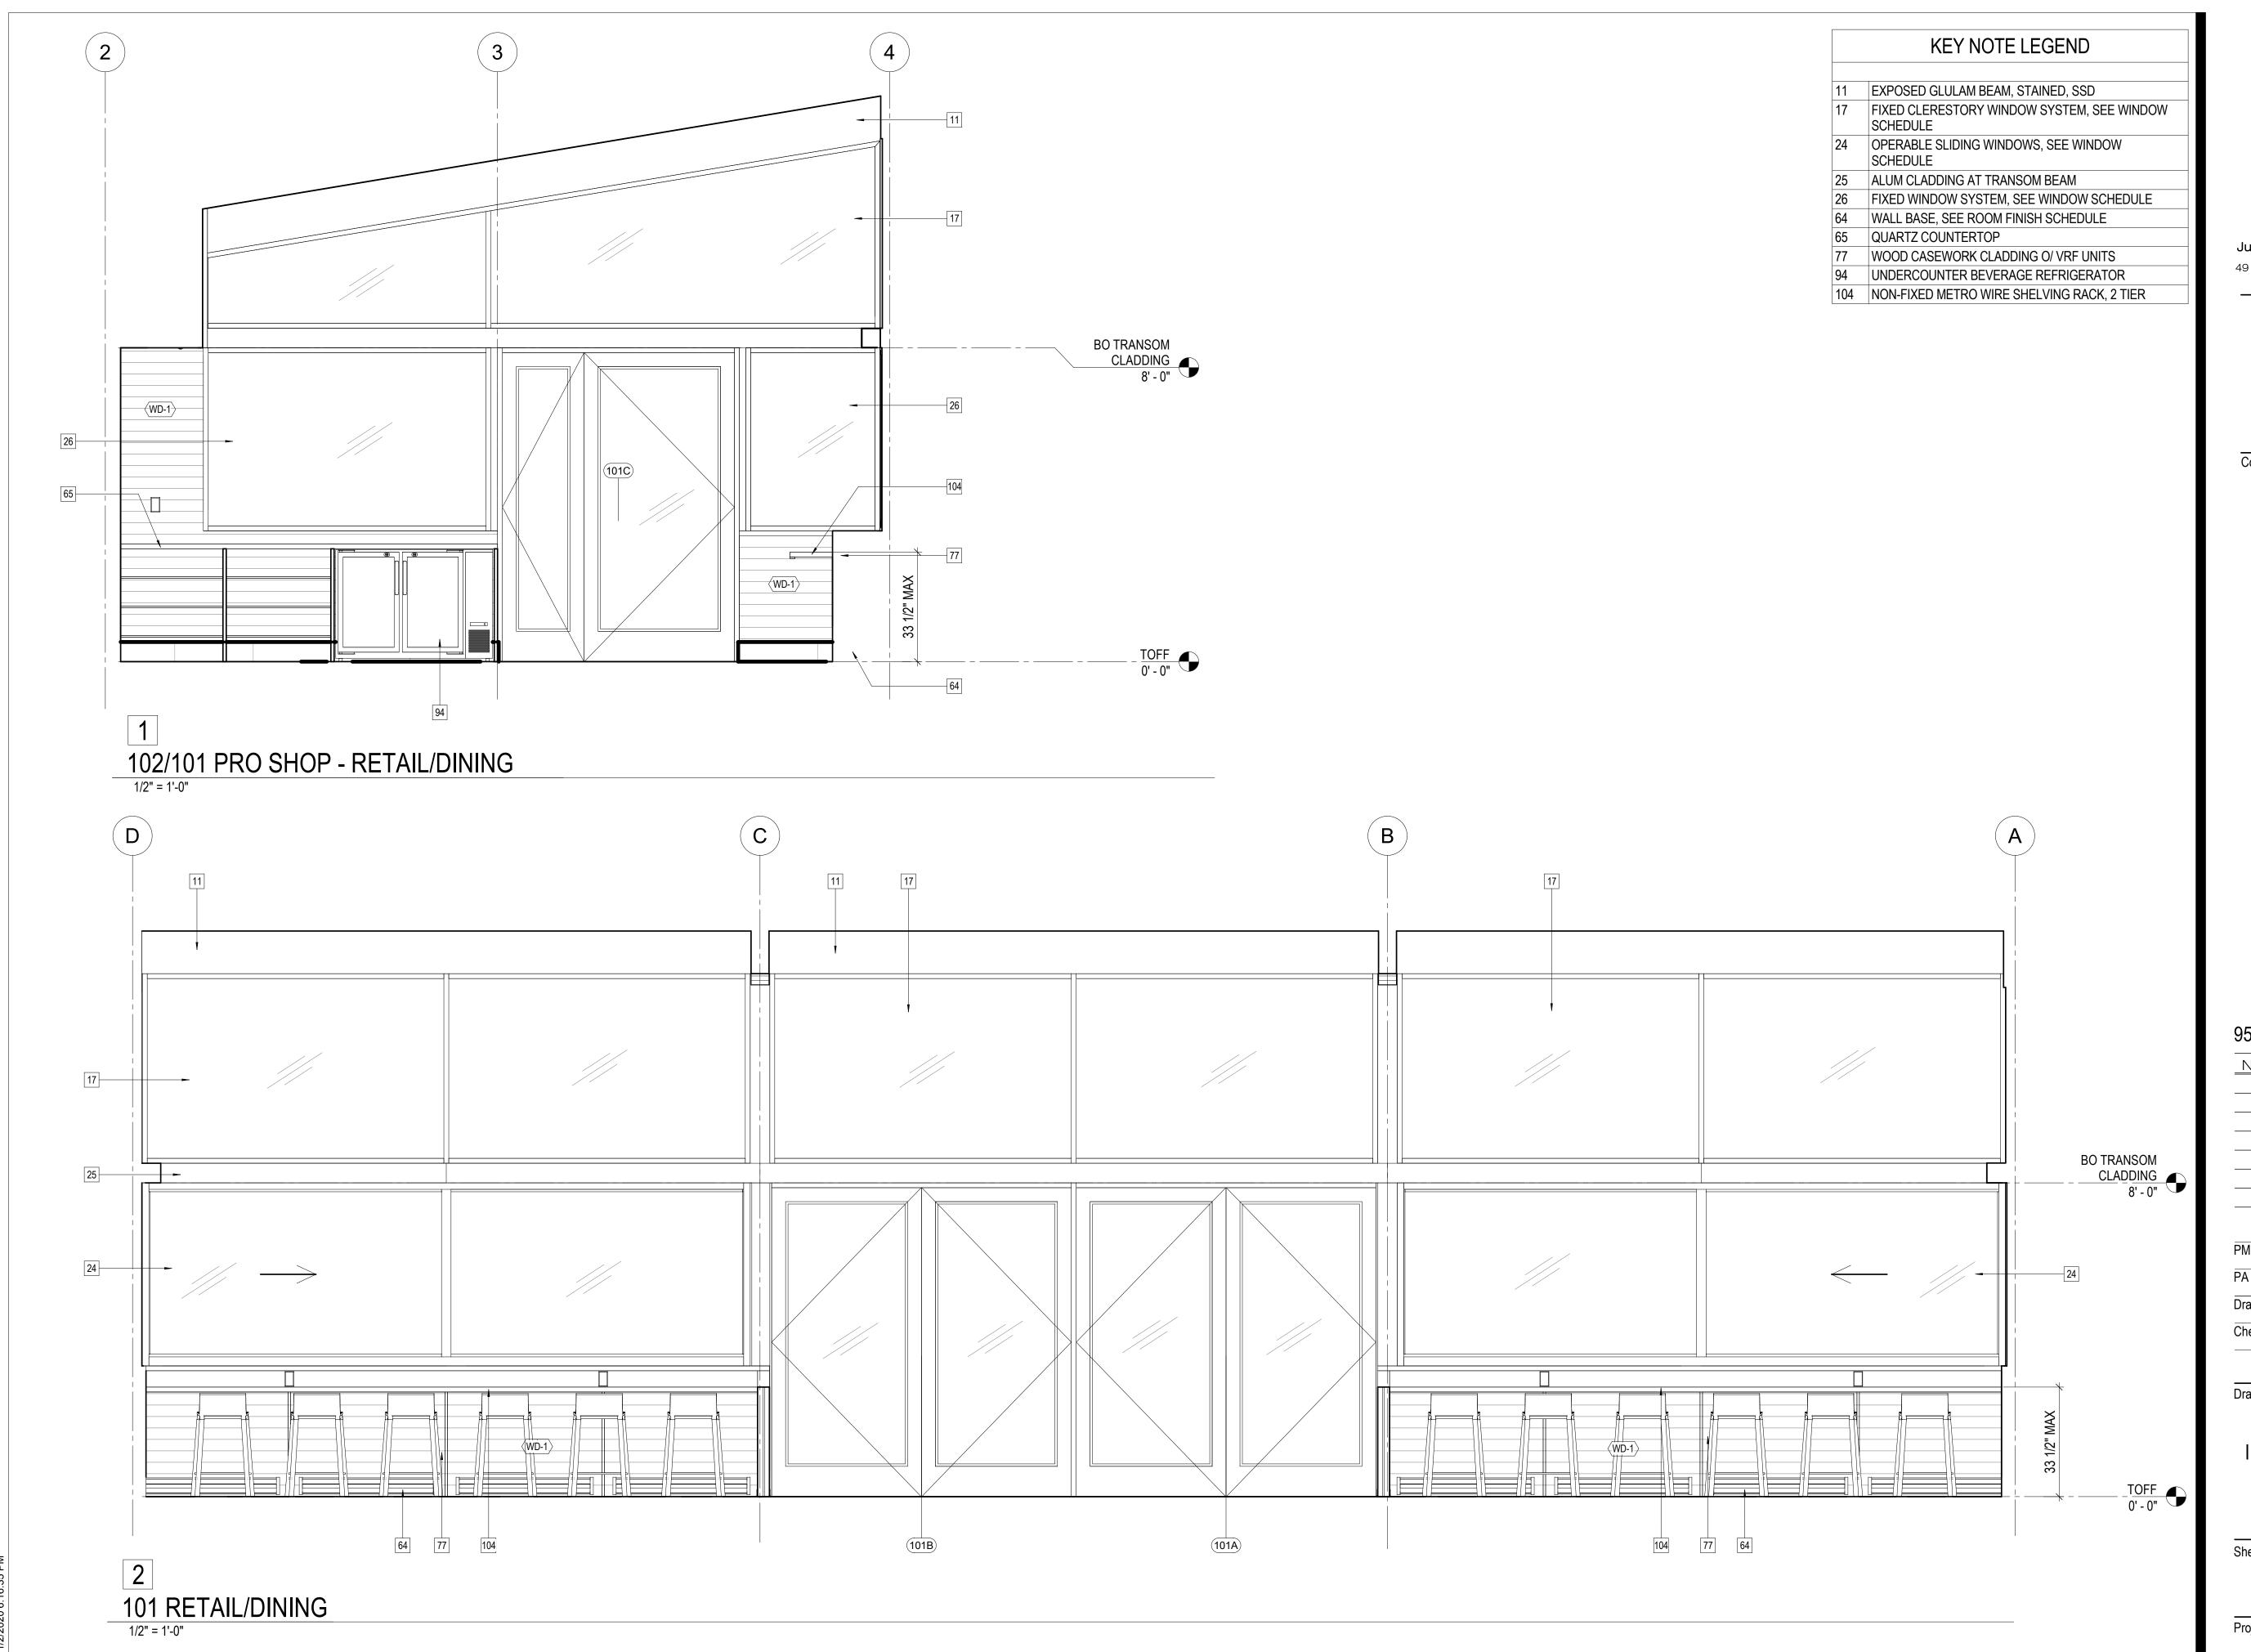



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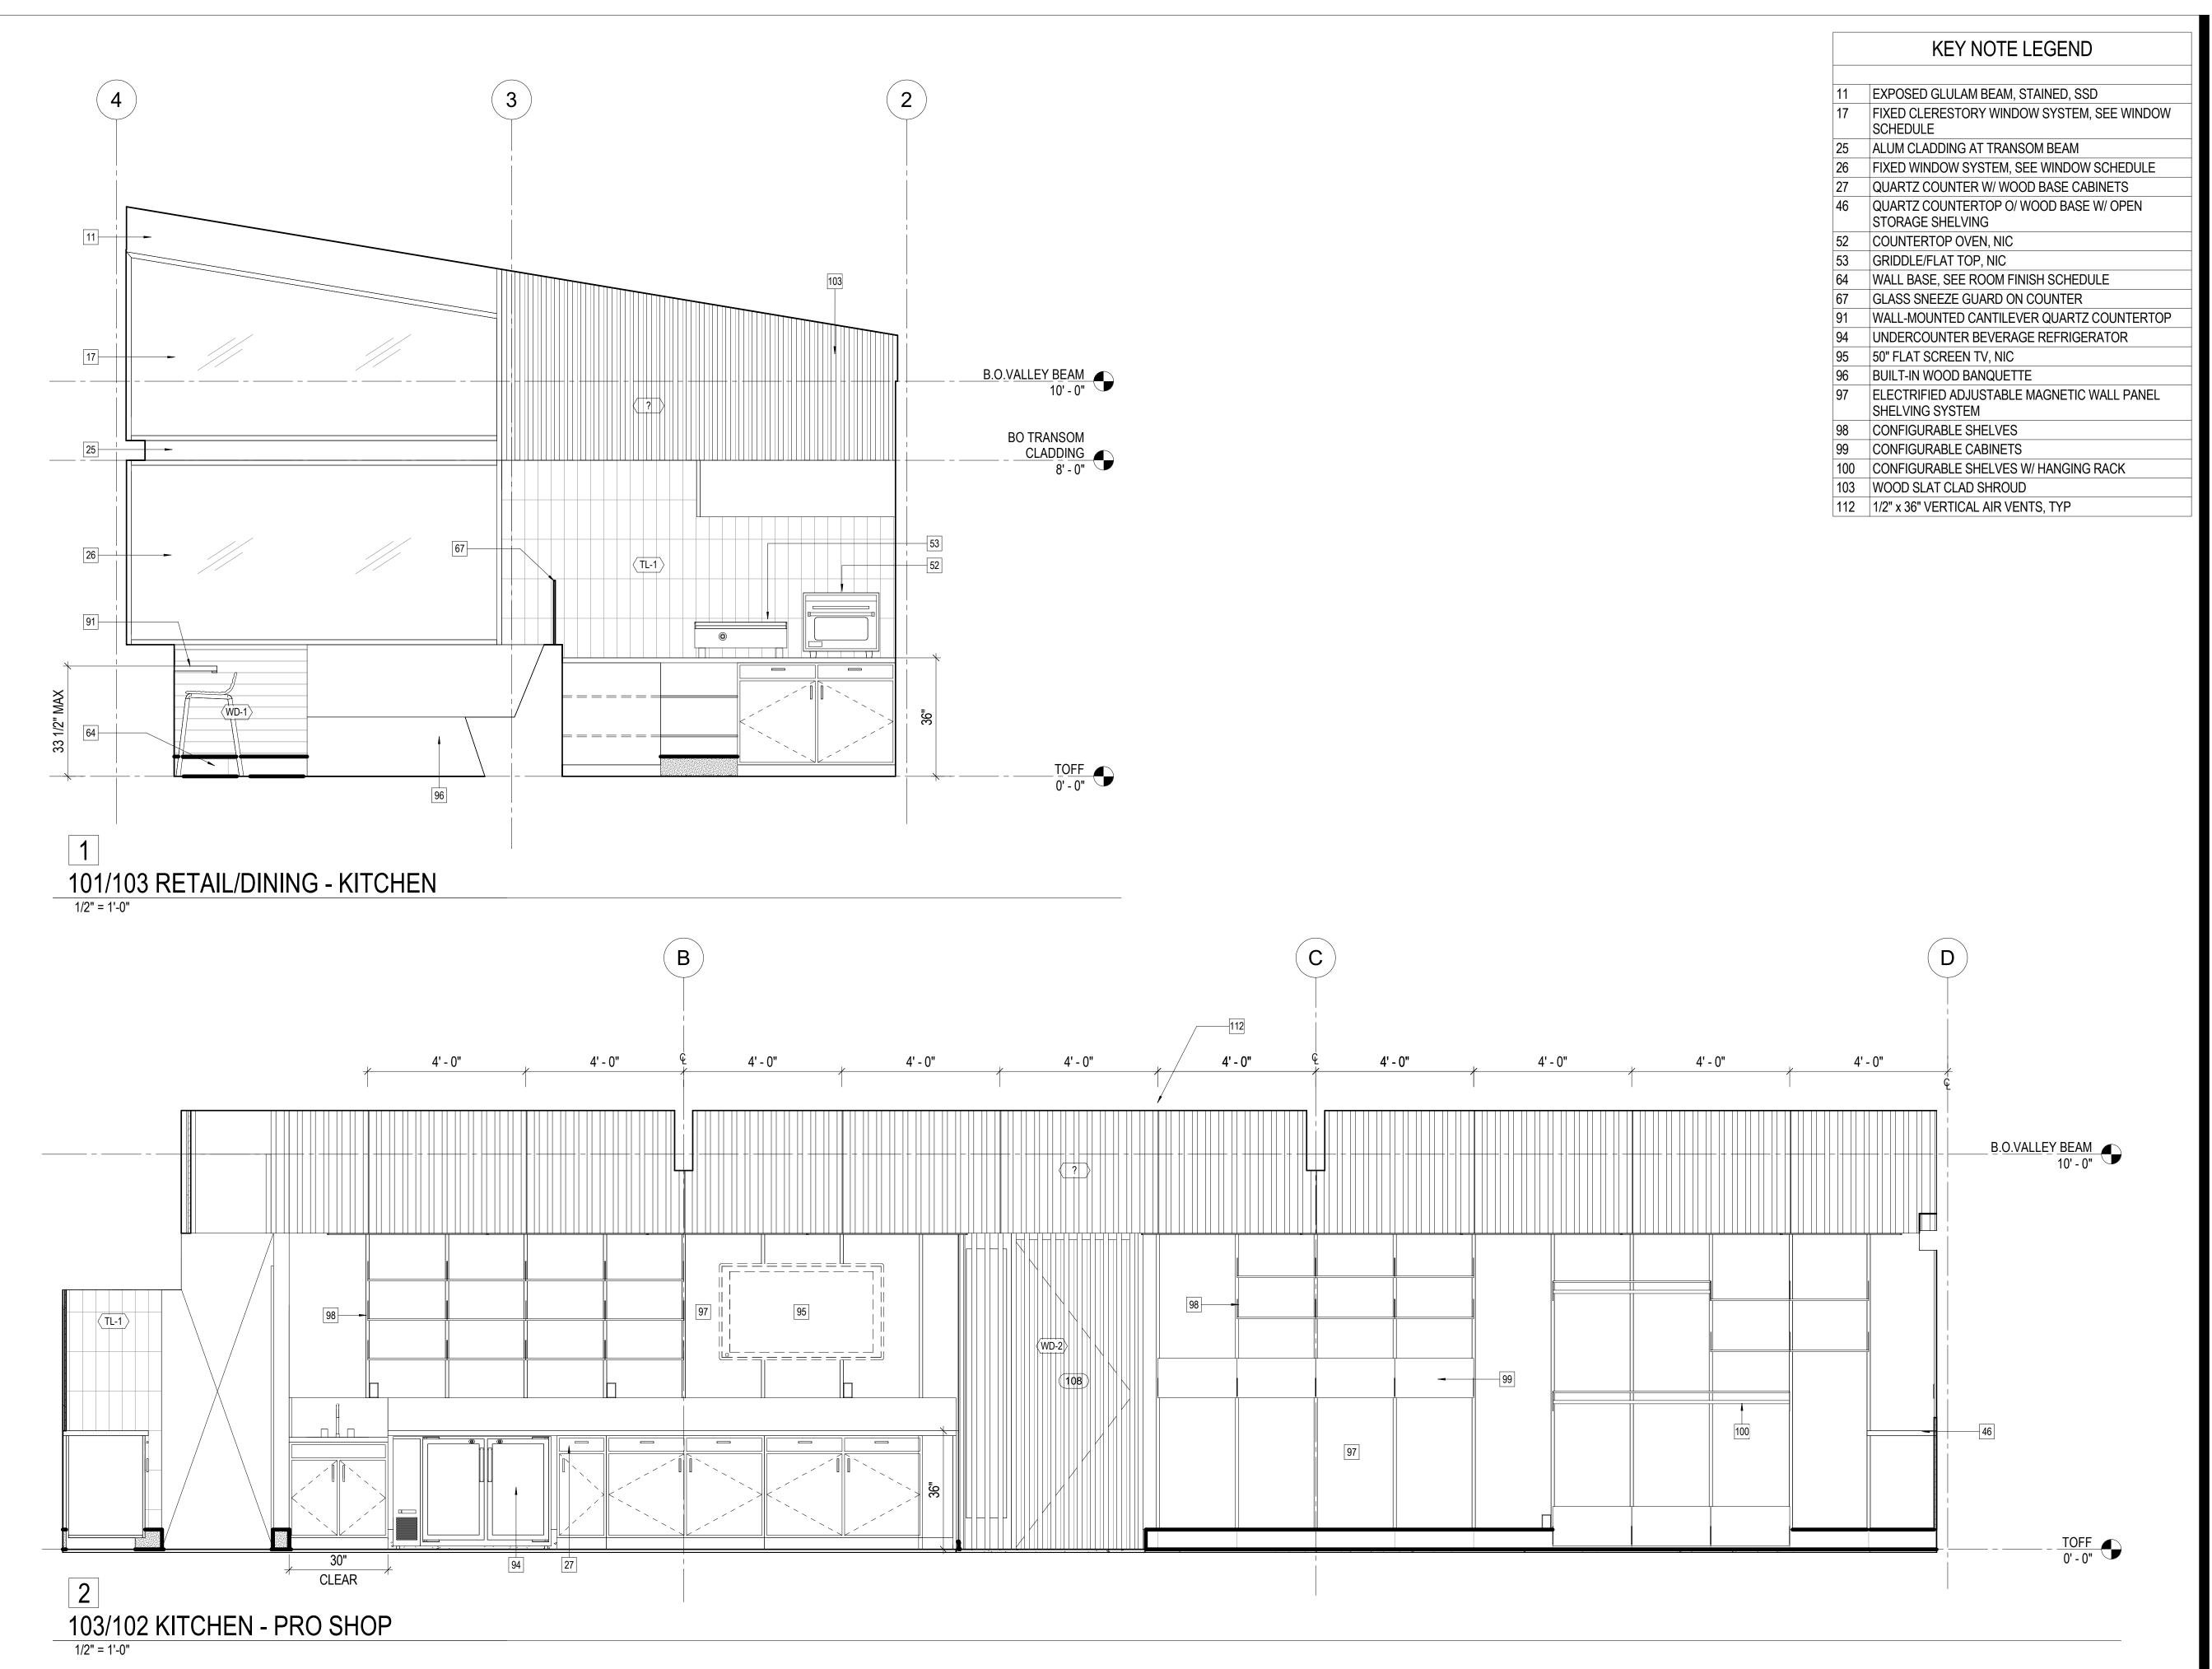
Drawing Title

INTERIOR ELEVATIONS - KITCHEN AND PROSHOP_NORTH & EAST

A5.10

1/2" = 1'-0"

Project No.





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Consultant

Project Status 11.16.2020

No. Date Revisions

No. Date Revisions

PM

Noah Levy
PA

Paul DeFreitas

Drawn

Author

Checked

Noah Levy

ul DeFreitas

Author

Checker

Drawing Title


INTERIOR ELEVATIONS - KITCHEN AND PROSHOP_SOUTH & WEST


Sheet No.

A5.11

1/2" = 1'-0"

Project No.

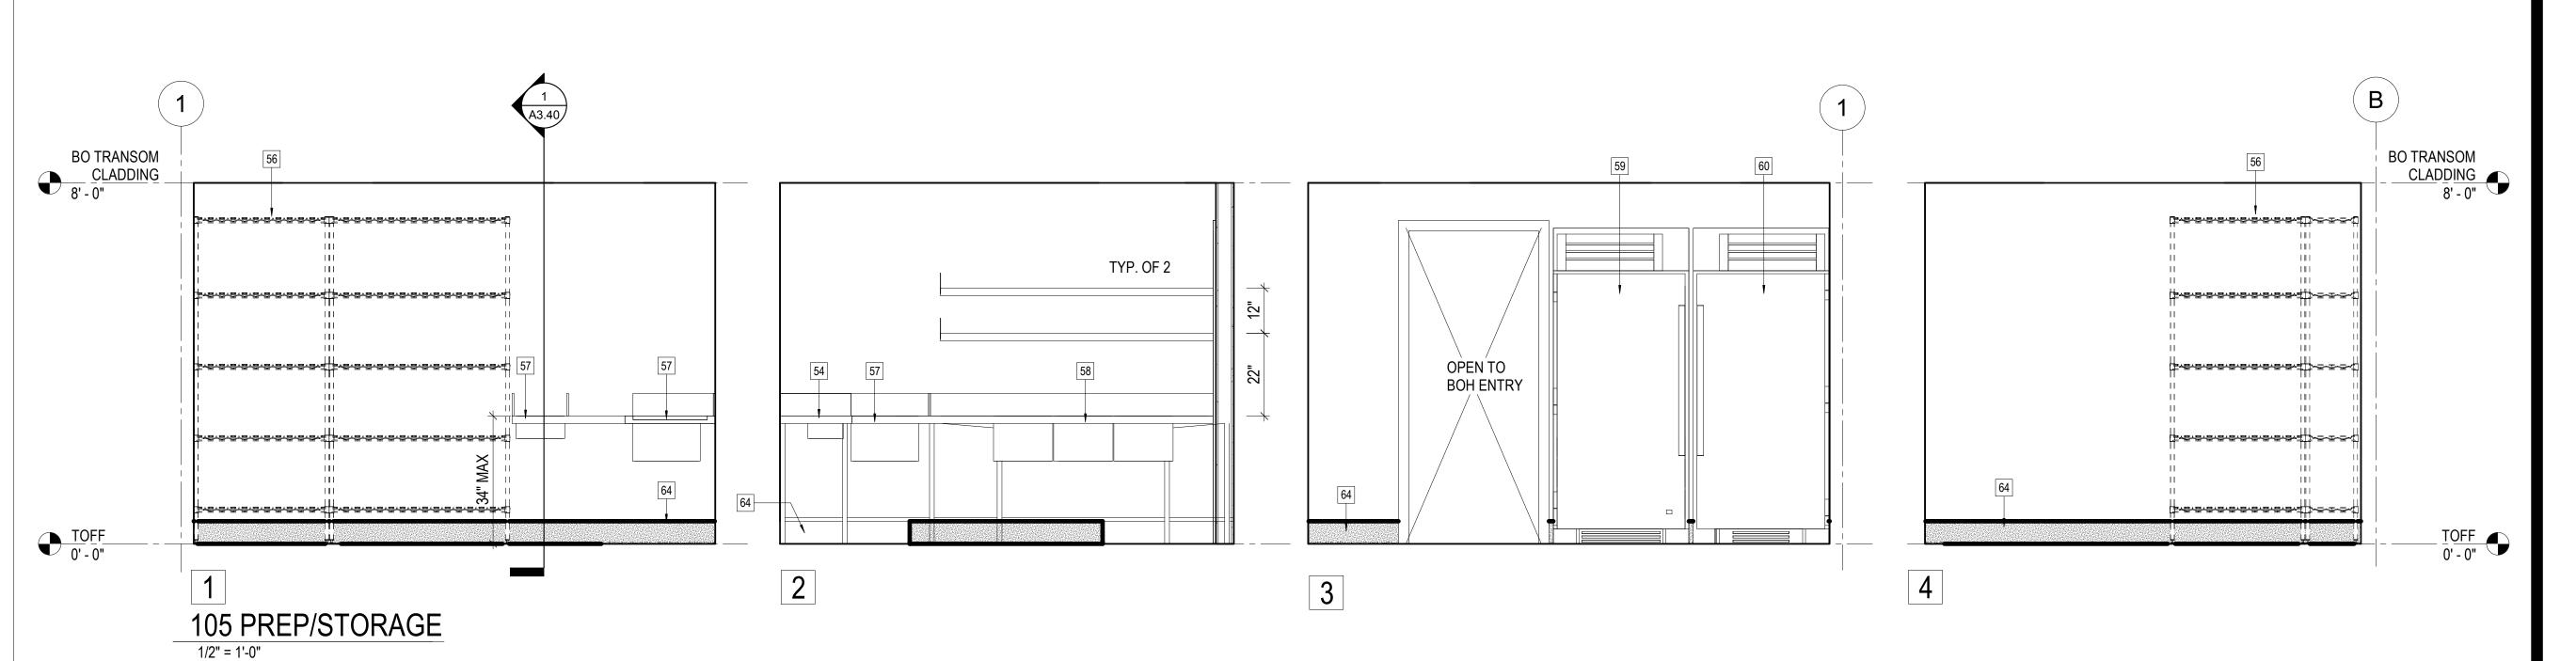

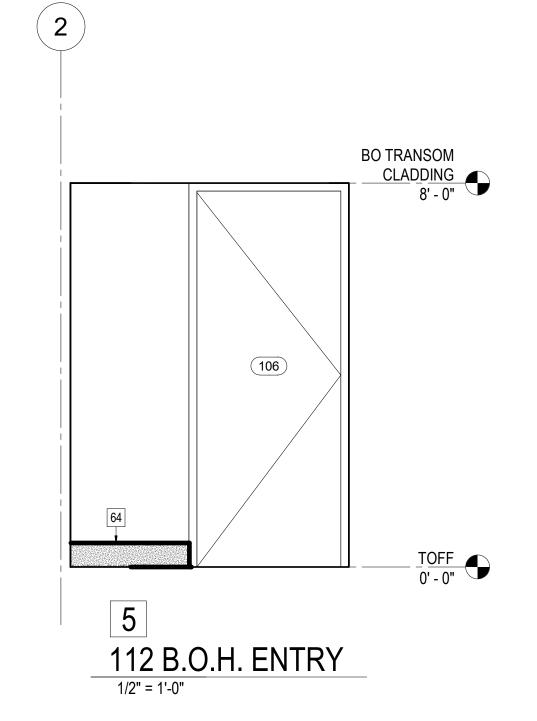



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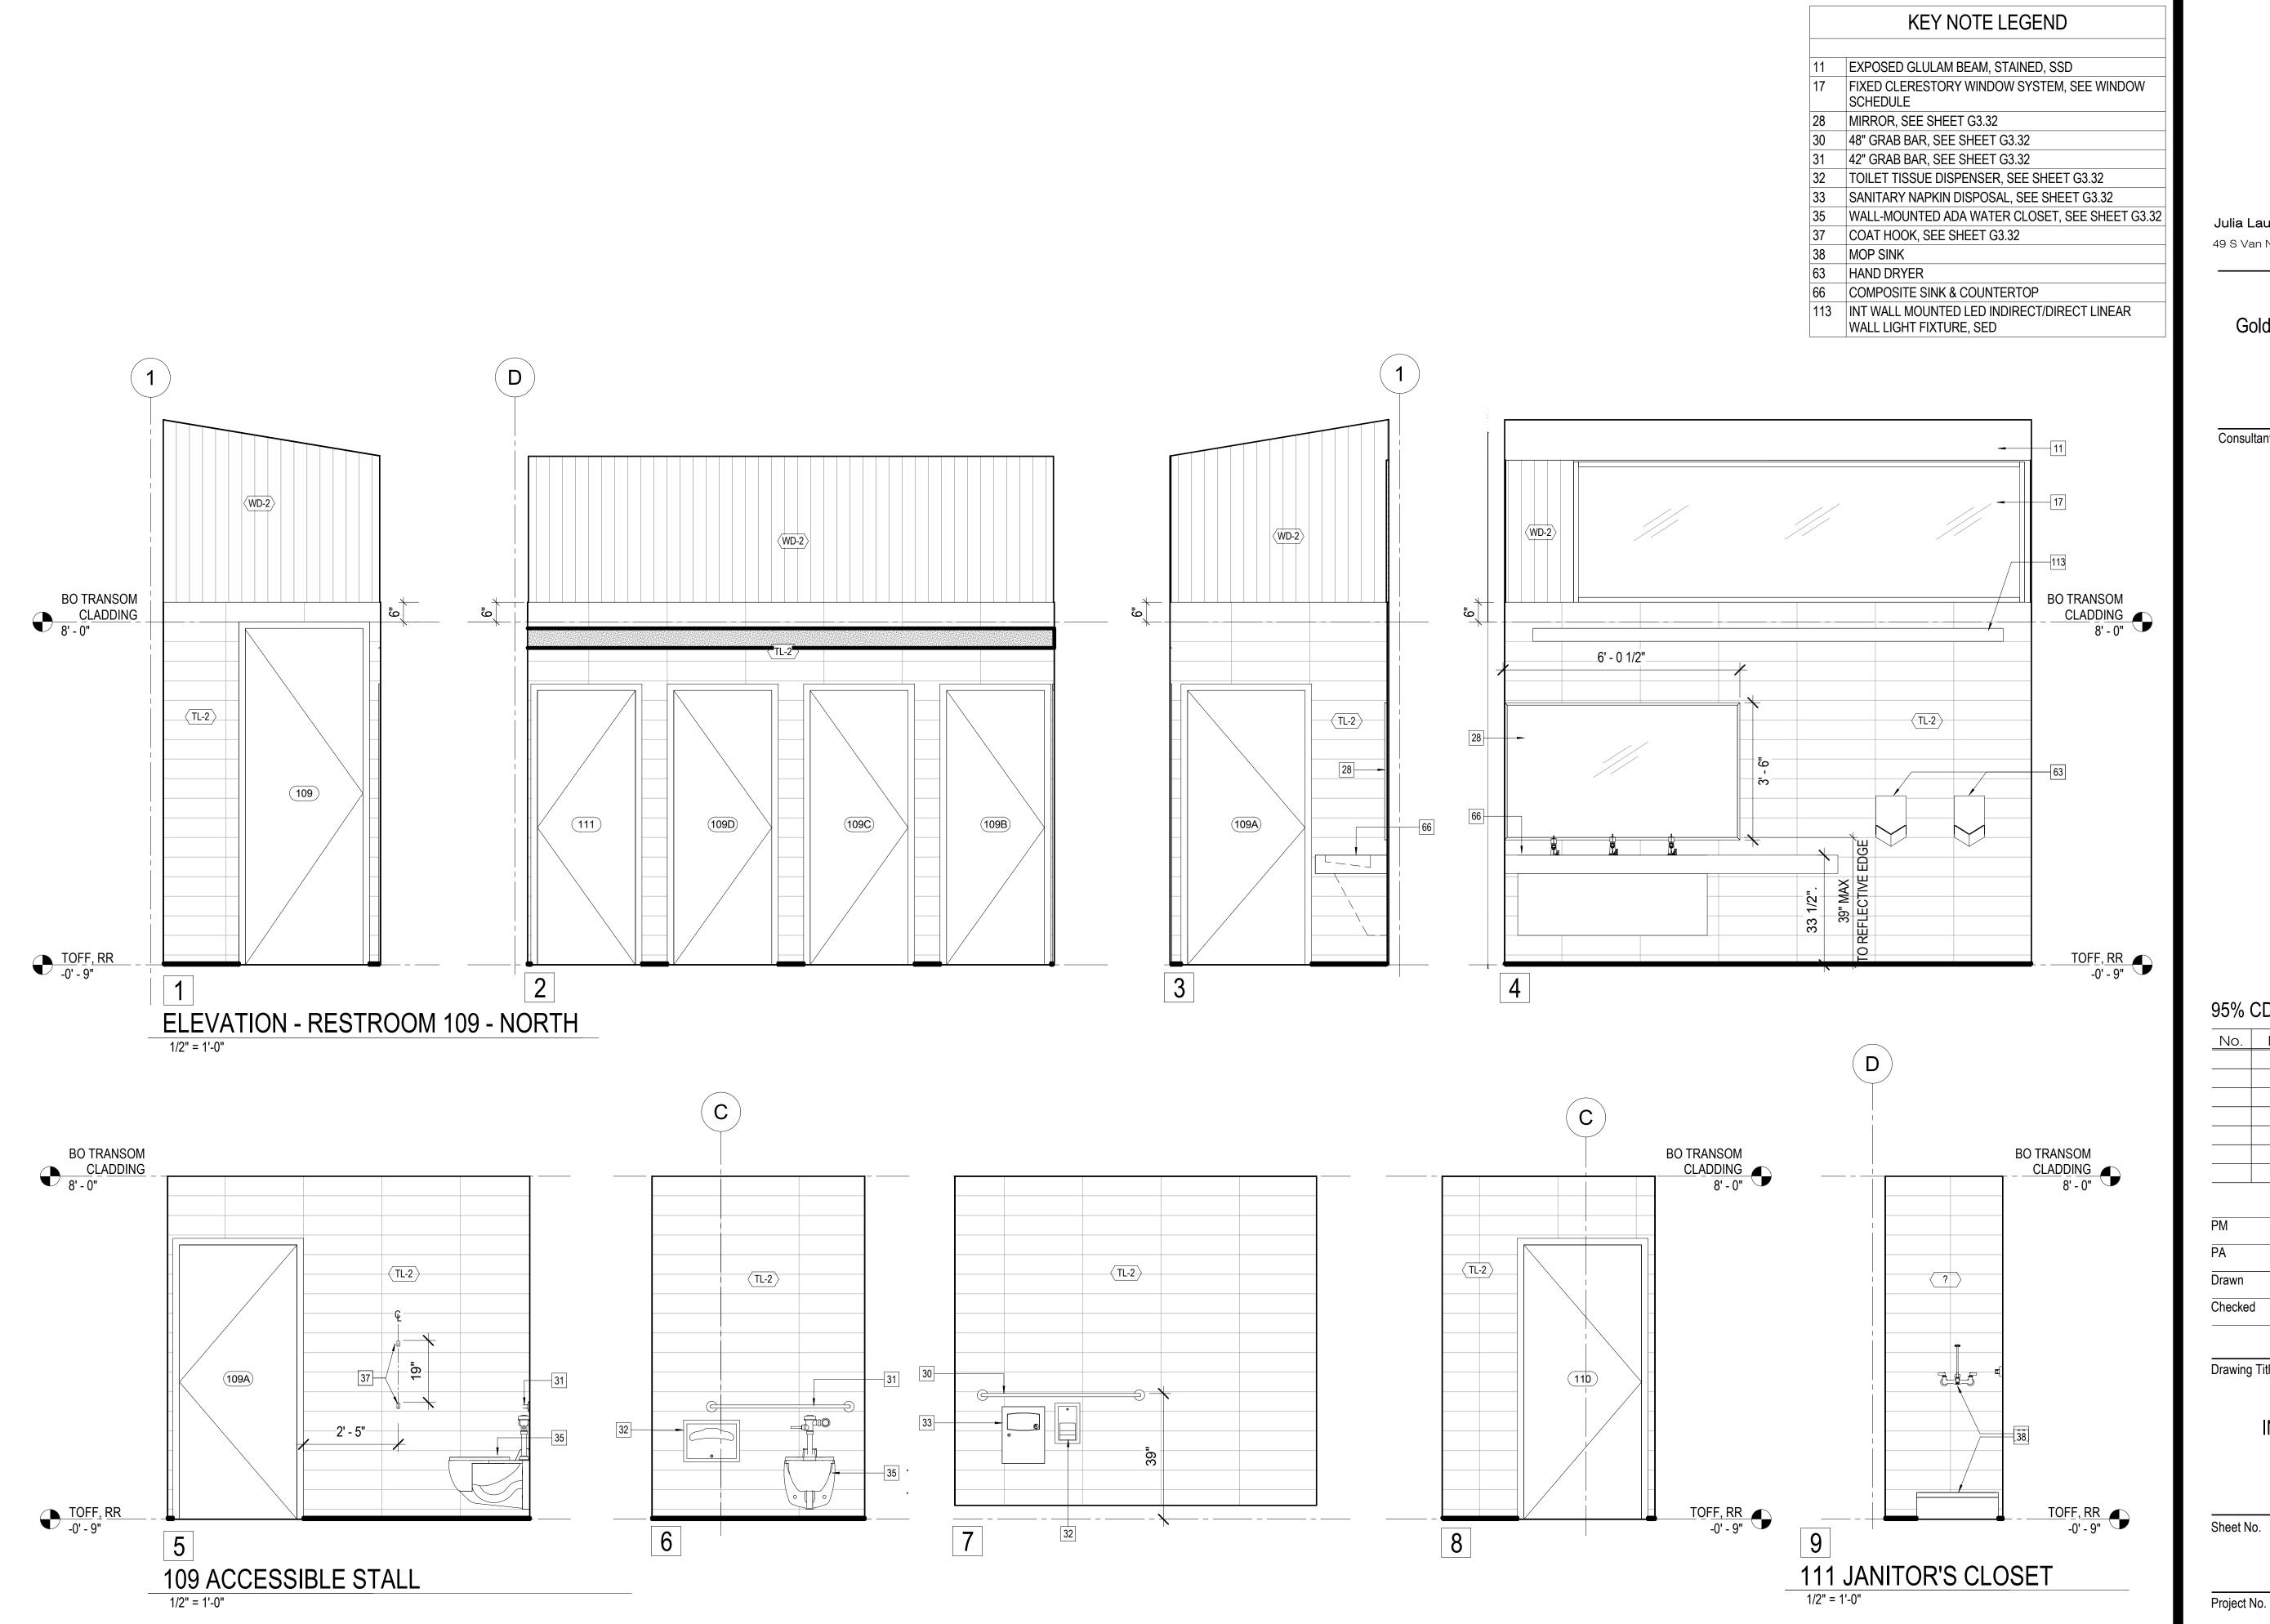
Drawing Title

INTERIOR ELEVATIONS - BOH

A5.12

1/2" = 1'-0"

Project No.





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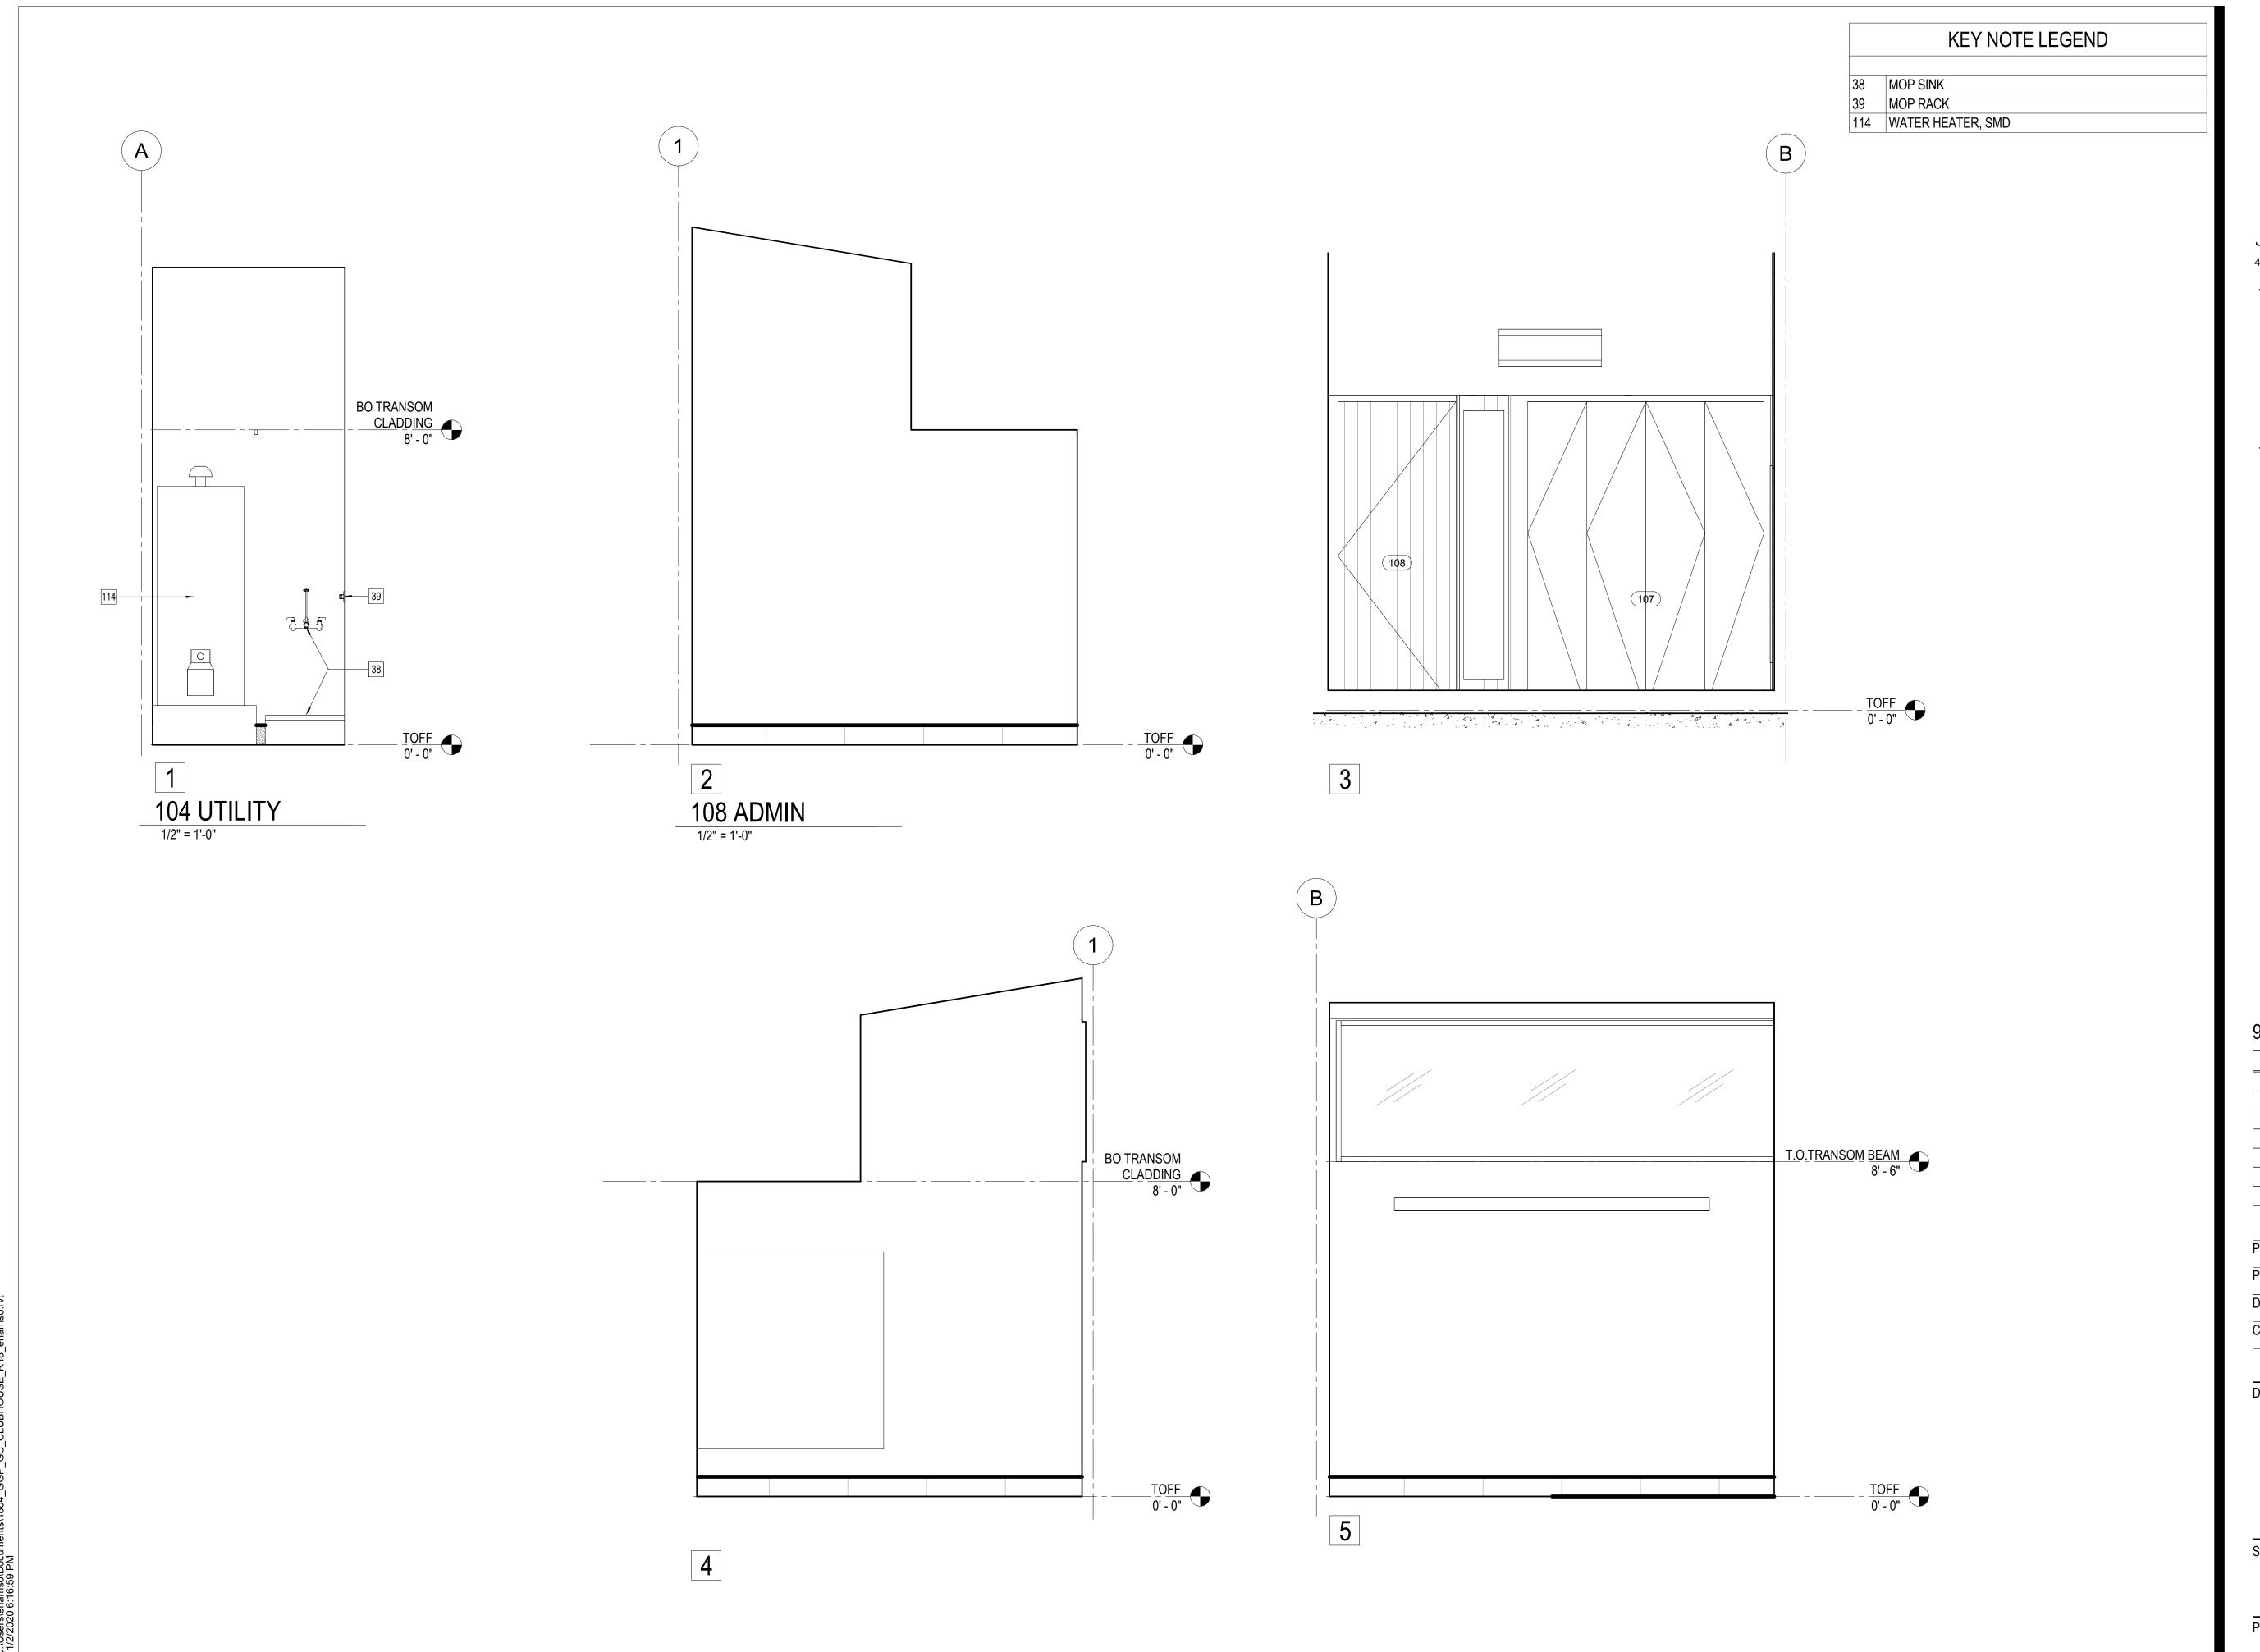
Drawing Title

INTERIOR ELEVATIONS -RESTROOMS

Sheet No.

A5.13

1/2" = 1'-0"





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Drawing Title

INTERIOR ELEVATIONS - ADMIN AND UTILITY

A5.14

1/2" = 1'-0"

Project No.



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Consultant

PM Noah Levy PA Paul DeFreitas Drawn

Drawing Title

Checked

REFLECTED CEILING PLAN


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A6.10

As indicated


Project No.

1804

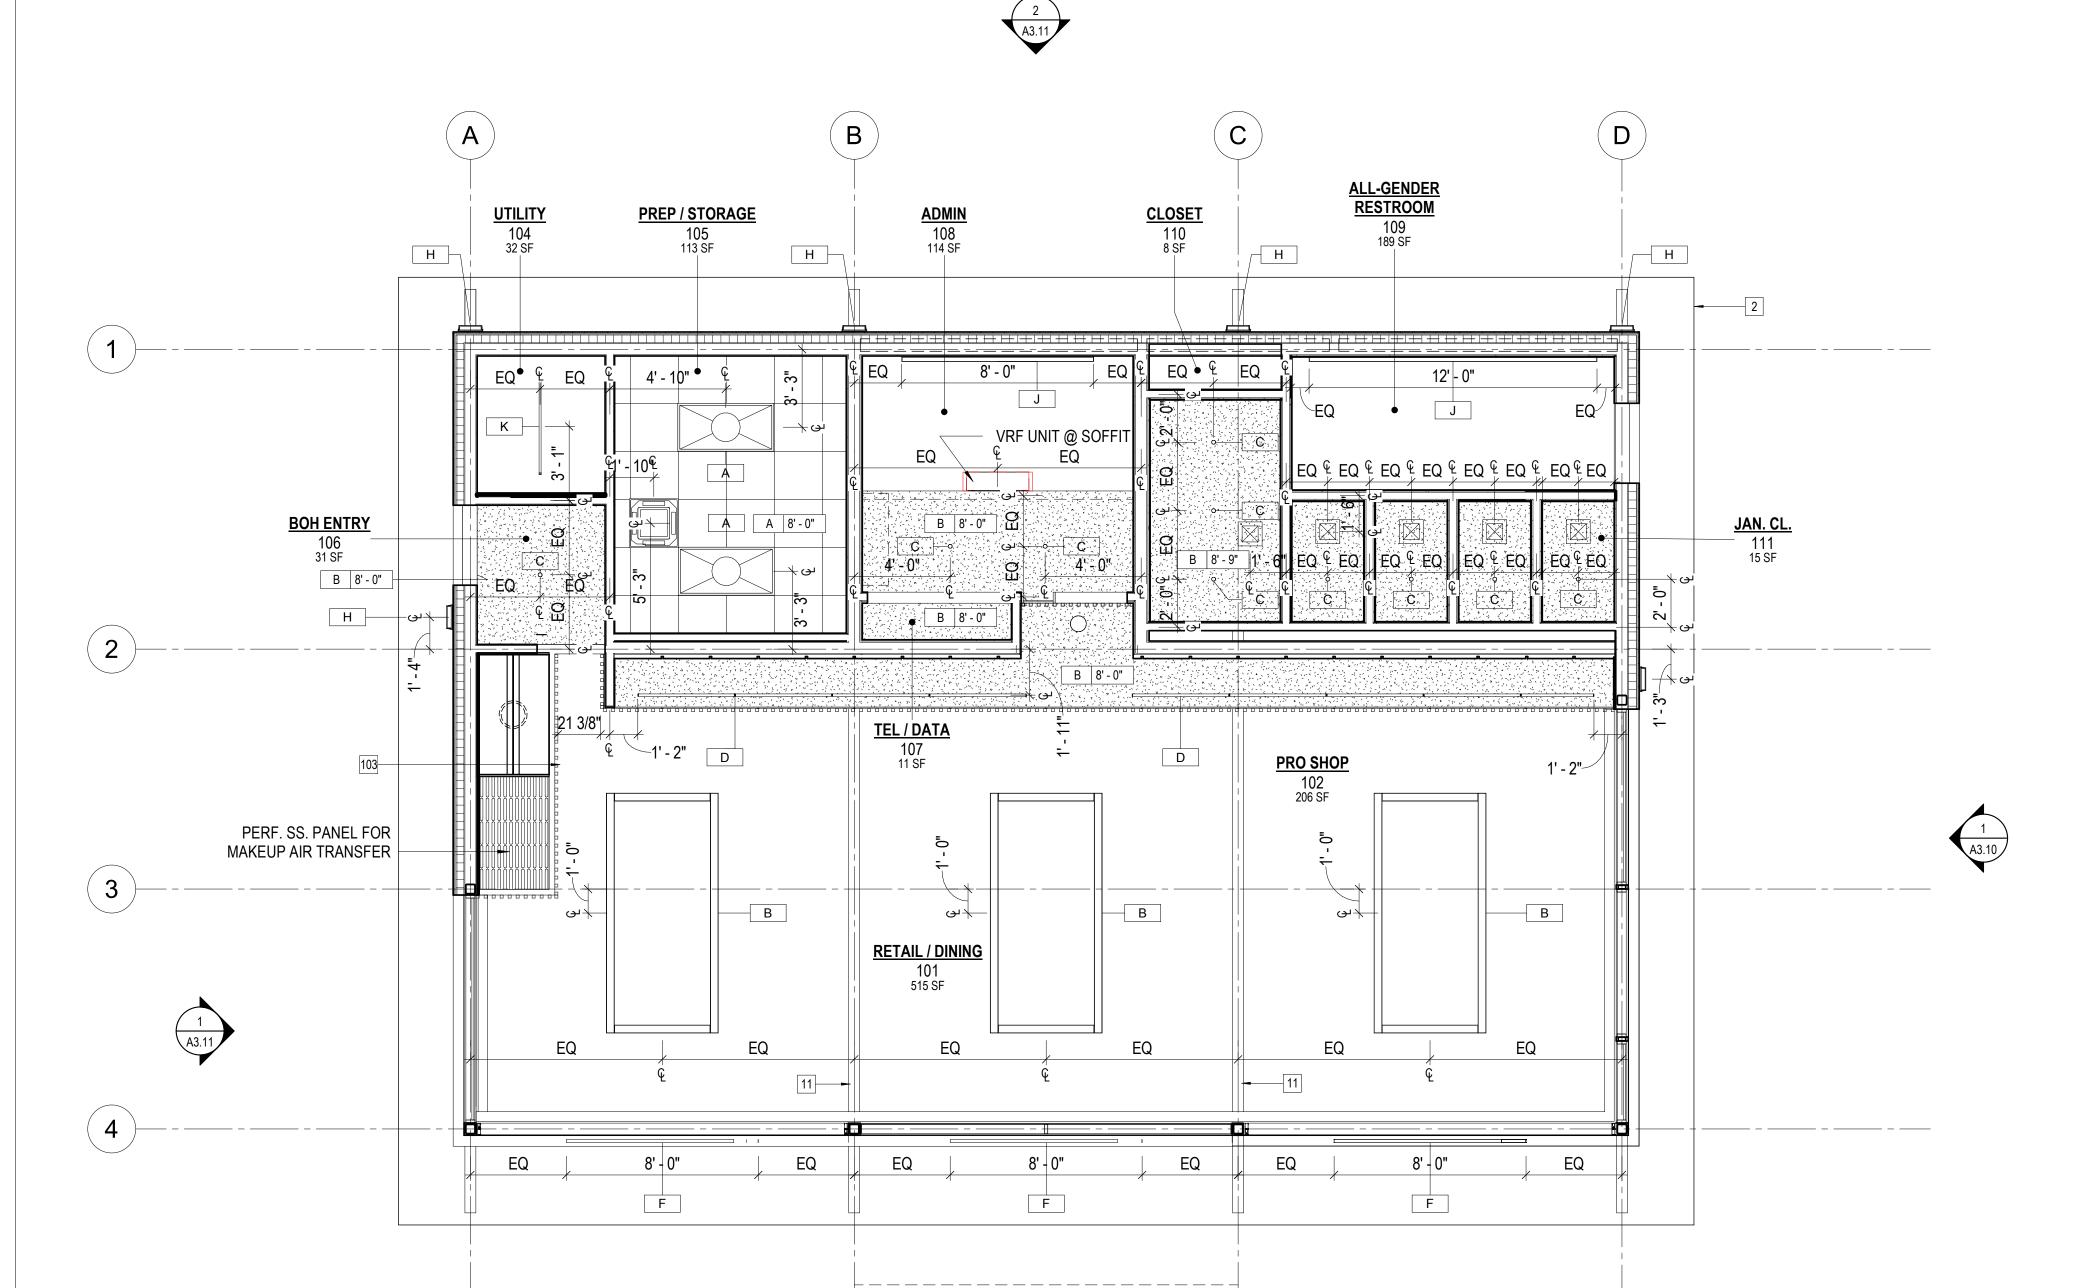


REFLECTED CEILING PLAN LEGEND

TYPE A -SUSPENDED 24" X 24" COMMERCIAL KITCHEN ACOUSTICAL CEILING TILE

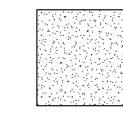

TYPE B-SUSPENDED GYPSUM BOARD CEILING ON WOOD CEILING JOISTS

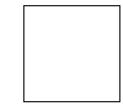

EXPOSED TO CLT & GLULAM BEAMS ABOVE



VRF CEILING CASSETTE, SMD

LIGHTING FIXTURE LEGEND

TYPE A

2'x4' LED TROFFER, SED

TYPE B

LED INDIRECT/DIRECT RECTANGULAR PENDANT @ 8'-0" AFF 4'x10', SED

2" Ø LED DOWNLIGHT, SED

TYPE C

TYPE D

0

SURFACE MOUNTED ASYMMETRIC LED WALL WASH MICRO PROFILE,

TYPE F

RECESSED LED EXTERIOR STRIP IN TRANSOM BEAM CLADDING, SED

TYPE H

EXTERIOR WALL MOUNTED LED AREA LIGHT, SED

TYPE J

INTERIOR WALL MOUNTED LED INDIRECT/DIRECT LINEAR WALL LIGHT @ 6" BELOW CLERESTORY WINDOW SILL, SED



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Drawn

Paul DeFreitas Checked

Drawing Title

EXTERIOR WALL DETAILS


Sheet No. A8.20

Scale:

Project No.

1804

3" = 1'-0"

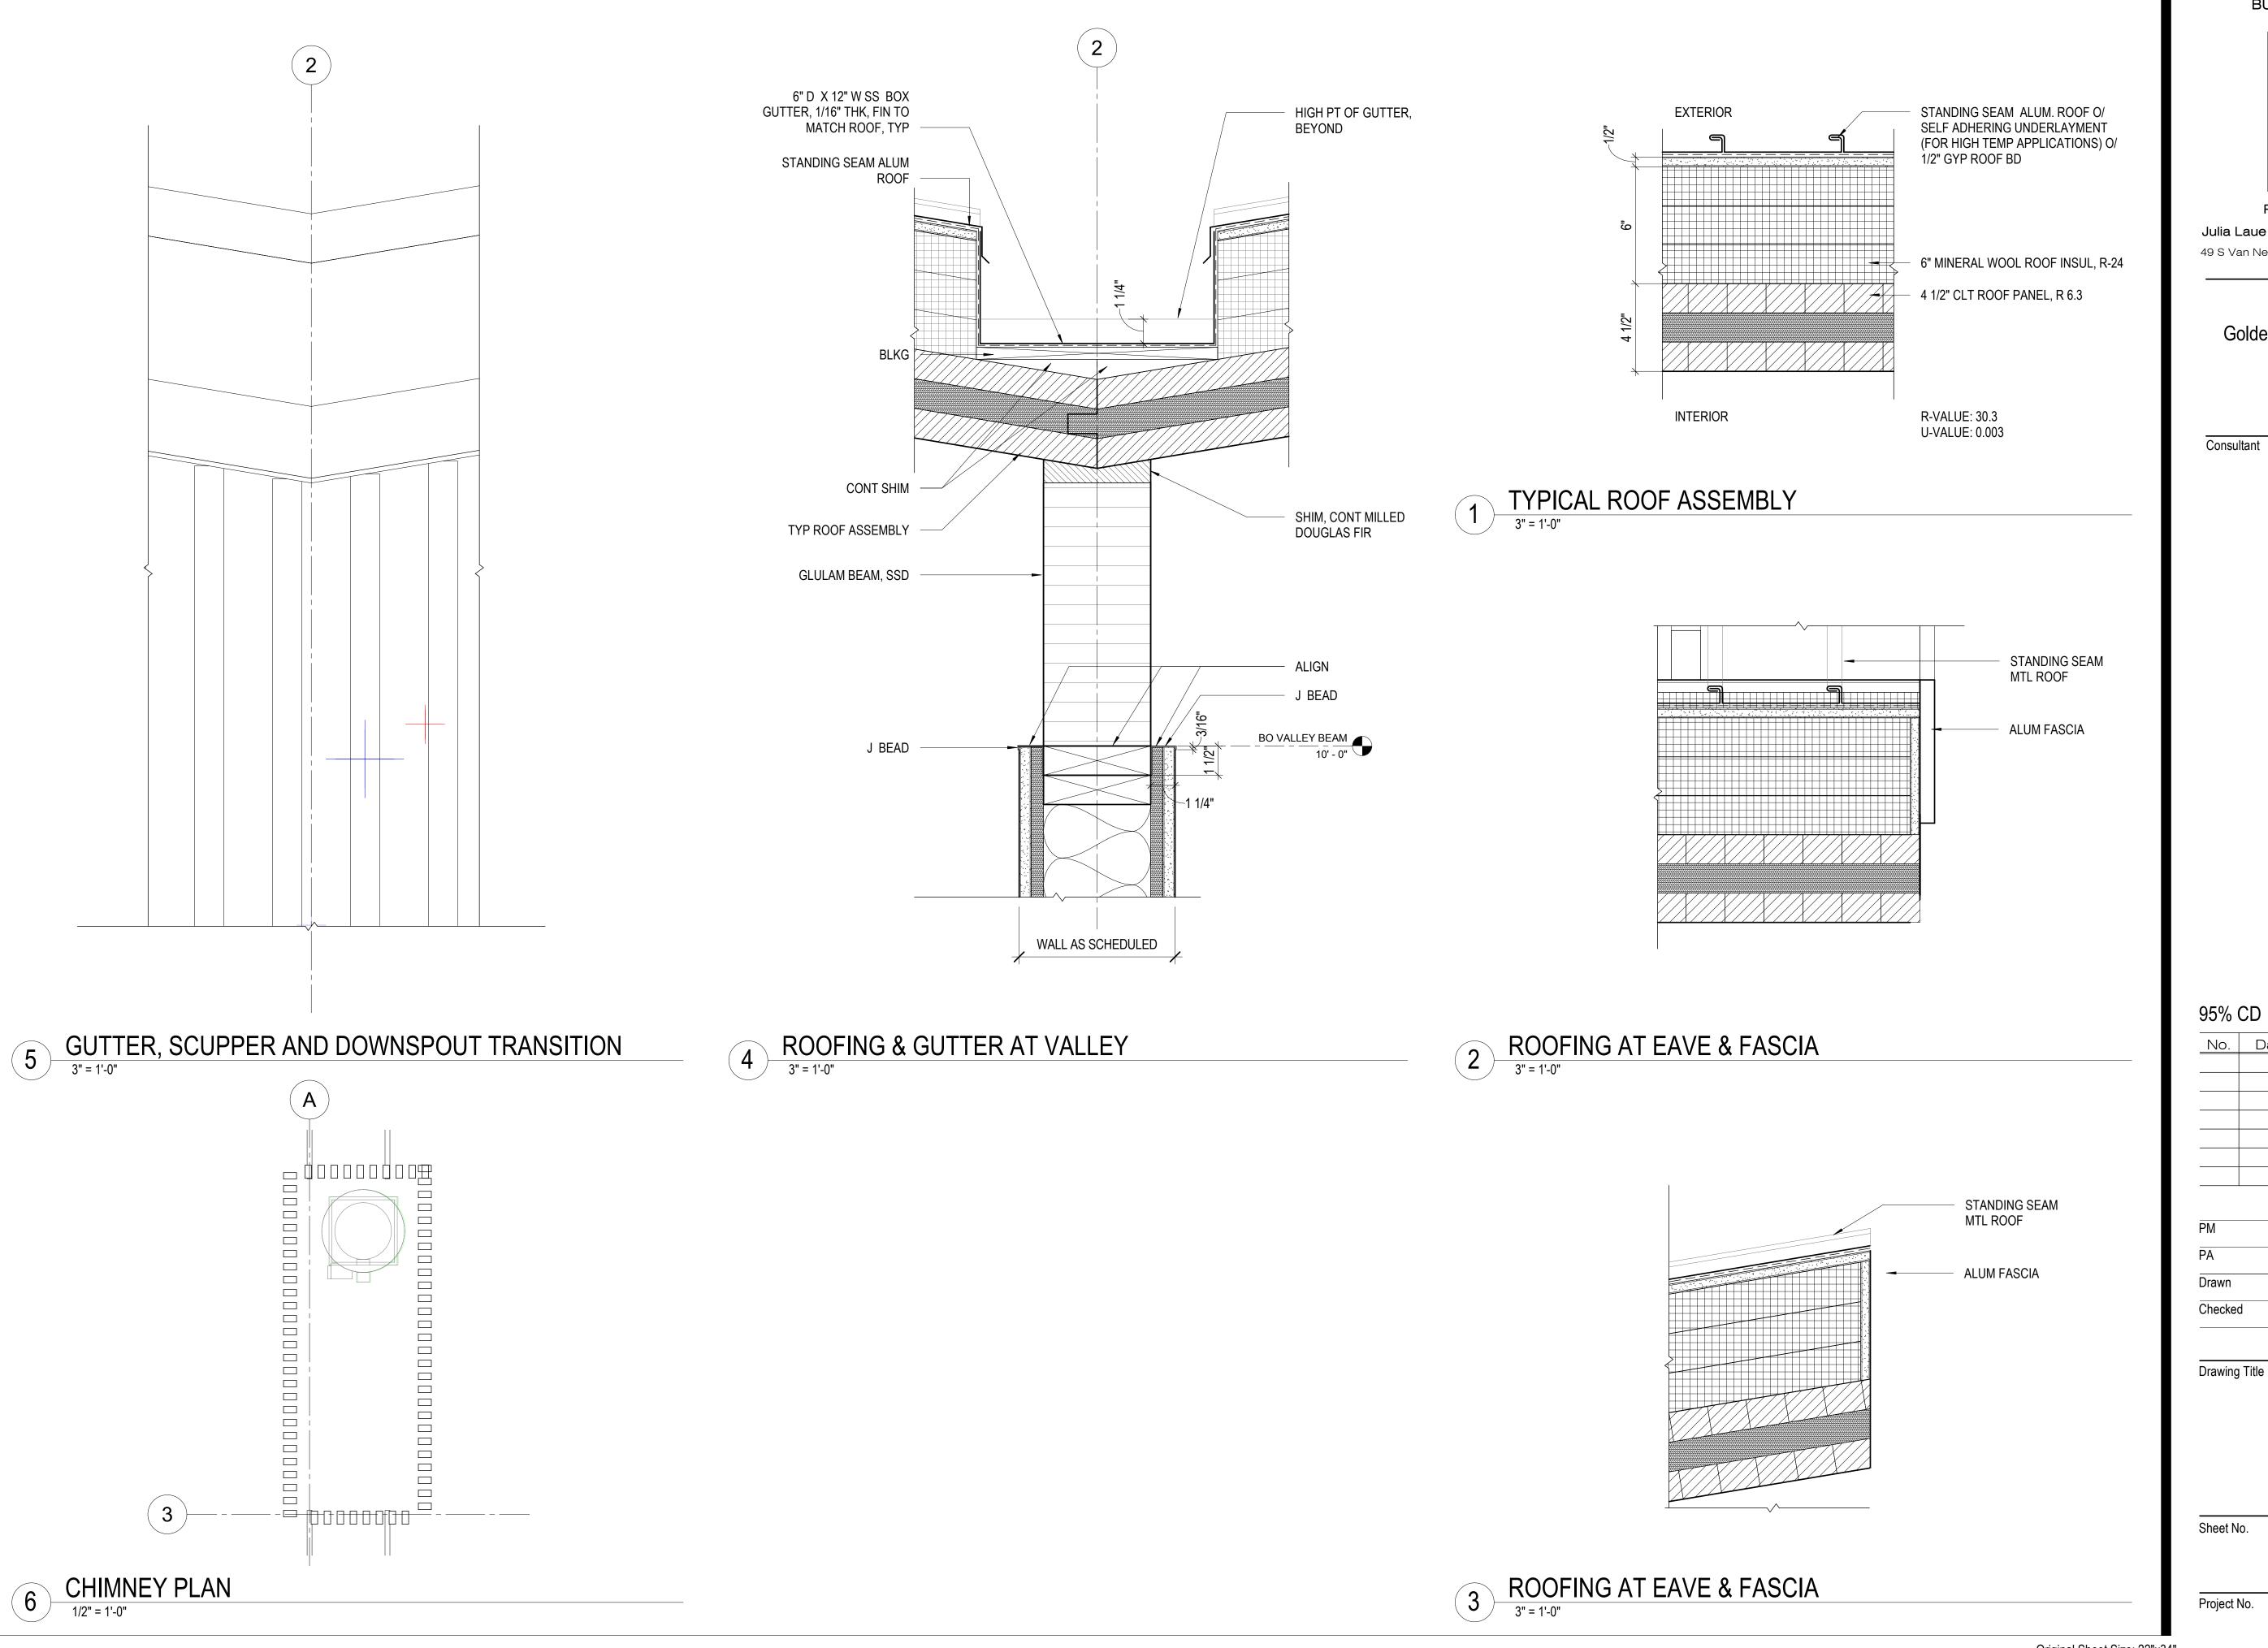



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ROOFING DETAILS

A8.30

As indicated

Project No.

1804



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Paul DeFreitas Checked

Drawing Title

EXTERIOR WINDOW AND LOUVER SCHEDULE_WEST NORTH

A8.51

1/2" = 1'-0"

Project No.



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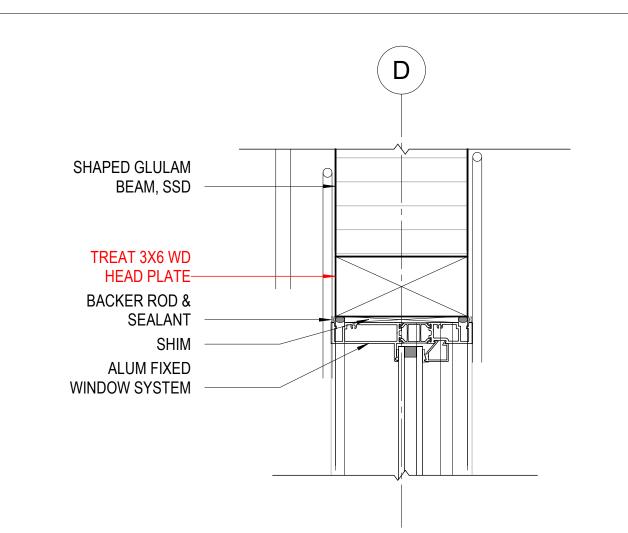
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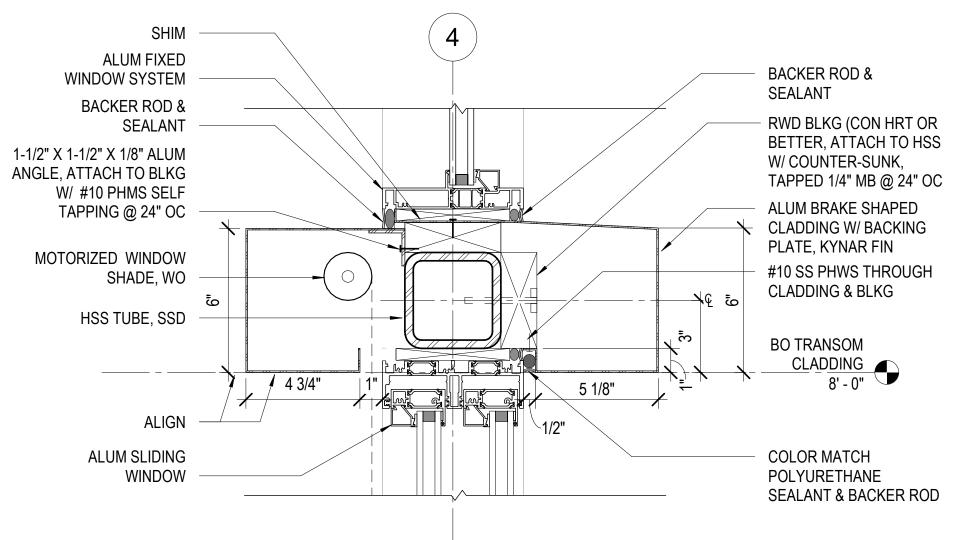
EXTERIOR WINDOW AND LOUVER SCHEDULE - EAST SOUTH


A8.52

1/2" = 1'-0"

Project No.





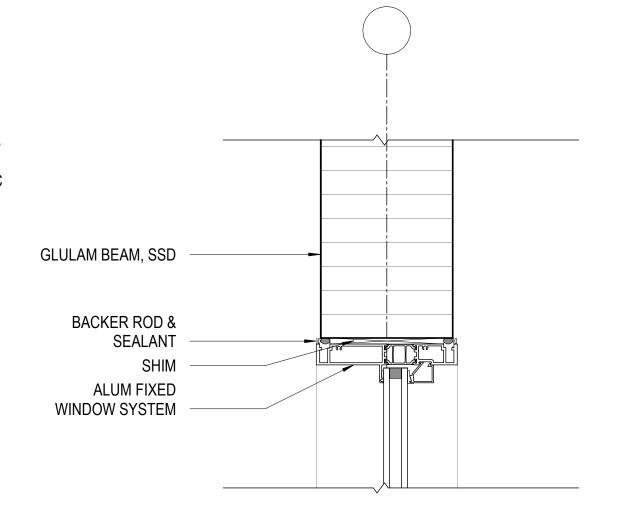

CLERESTORY HEAD DETAIL AT SLOPED GLULAM BEAM 3" = 1'-0"

D

BACKER ROD &

RWD BLKG (CON HRT OR

BETTER, ATTACH TO HSS

TAPPED 1/4" MB @ 24" OC

W/ COUNTER-SUNK,

ALUM BRAKE SHAPED

PLATE, KYNAR FIN

CLADDING & BLKG

COLOR MATCH

POLYURETHANE

CLADDING W/ BACKING

#10 SS PHWS THROUGH

BO TRANSOM

CLADDING 8' - 0"

SEALANT

ALUM FIXED

SEALANT

WINDOW SYSTEM

1-1/2" X 1-1/2" X 1/8"

ATTACH TO BLKG W/

BACKER ROD &

ALUM ANGLE,

#10 PHMS SELF

MOTORIZED


HSS TUBE, SSD

ALIGN

TAPPING @ 24" OC

WINDOWN SHADE, WO

CLERESTORY SILL/ OPERABLE WIN. HEAD AT TRANSOM

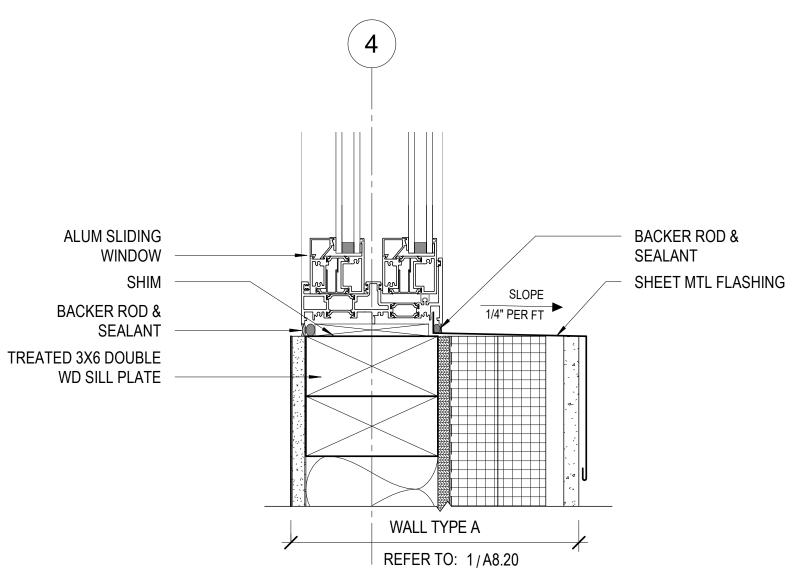


SEALANT & BACKER ROD CLERESTORY SILL/FIXED WINDOW HEAD AT TRANSOM

5 1/8"

[\]1/2"

OPERABLE WINDOW SILL

CLERESTORY WINDOW HEAD DETAIL

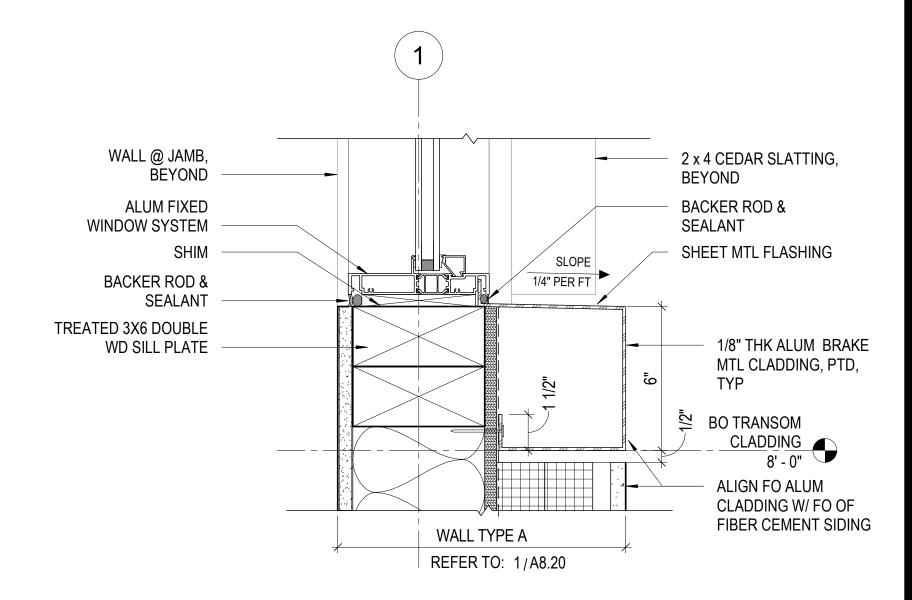

CLERESTORY WINDOW SILL DETAIL

BUREAU OF ARCHITECTURE



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No. Date Revisions

Drawn Checked

11.16.2020

Drawing Title


EXTERIOR WINDOW DETAILS

Sheet No. A8.53


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1804


3" = 1'-0"

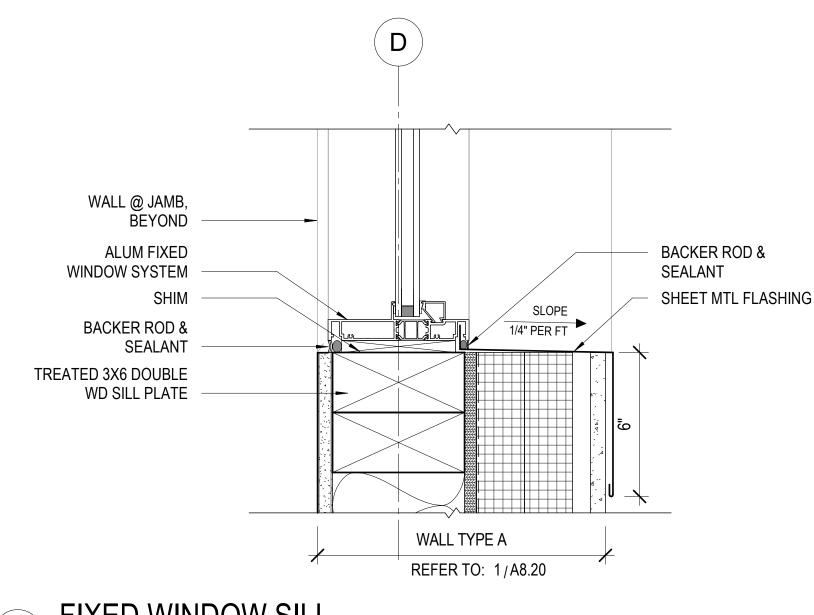


FIXED WINDOW SILL

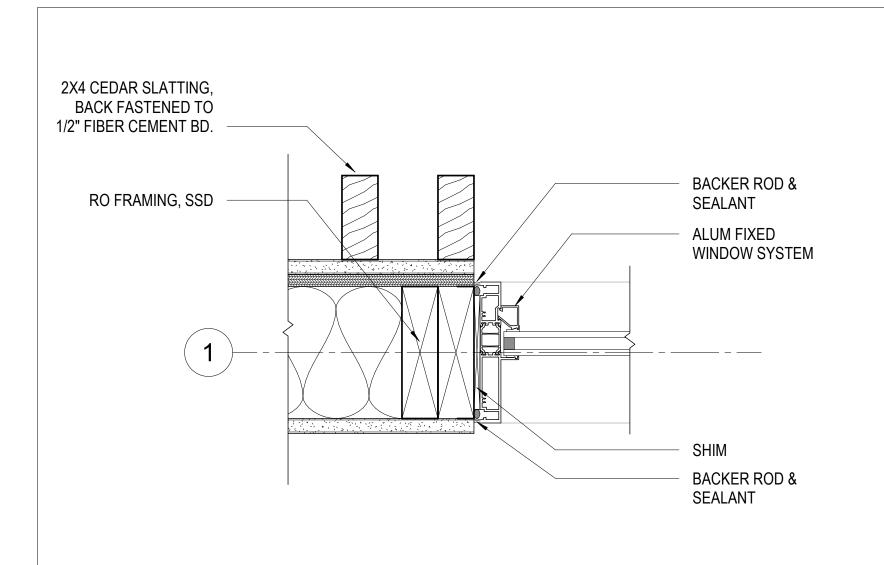


CLERESTORY WINDOW JAMB DETAIL AT SLATS

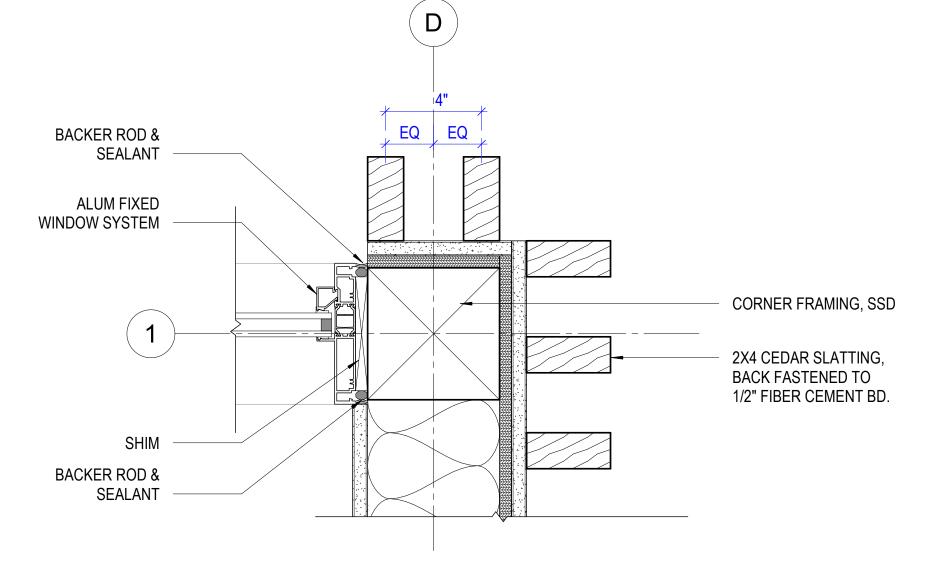


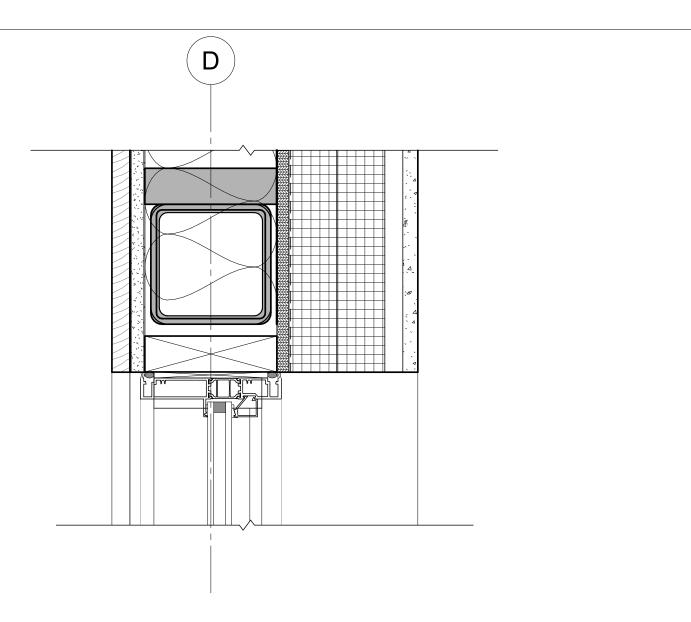

CLERESTORY WINDOW JAMB AT CORNER & SLATS


FIXED WINDOW JAMB DETAIL AT WALL

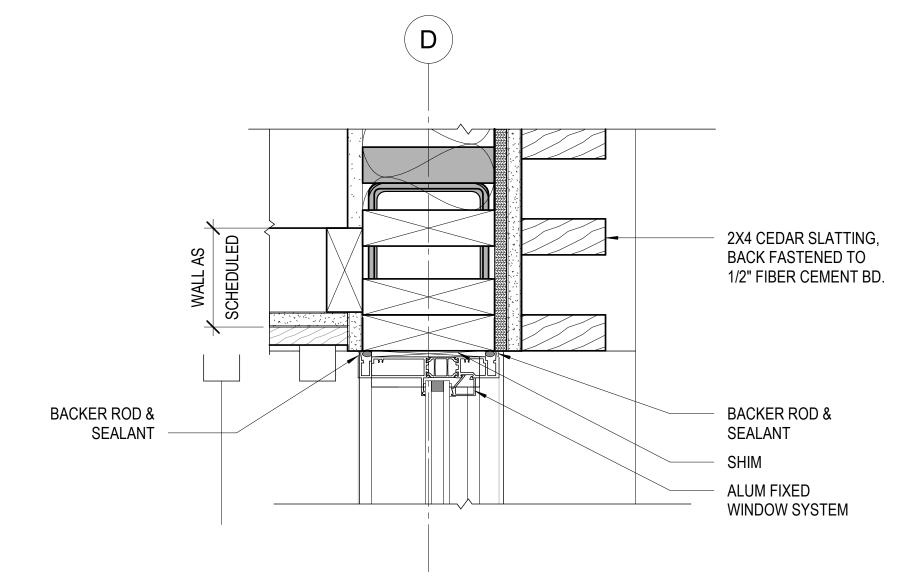

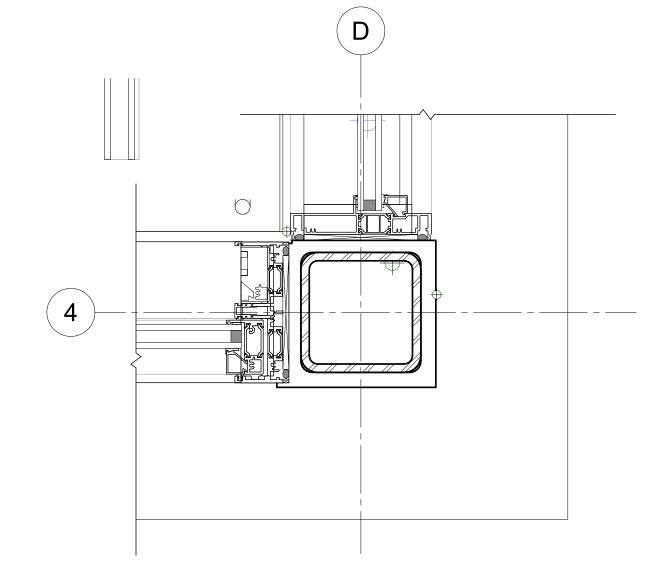


FIXED WINDOW JAMB DETAIL AT SLATS

PLAN DETAIL AT FIXED & OPERABLE WINDOW CORNER
3" = 1'-0"

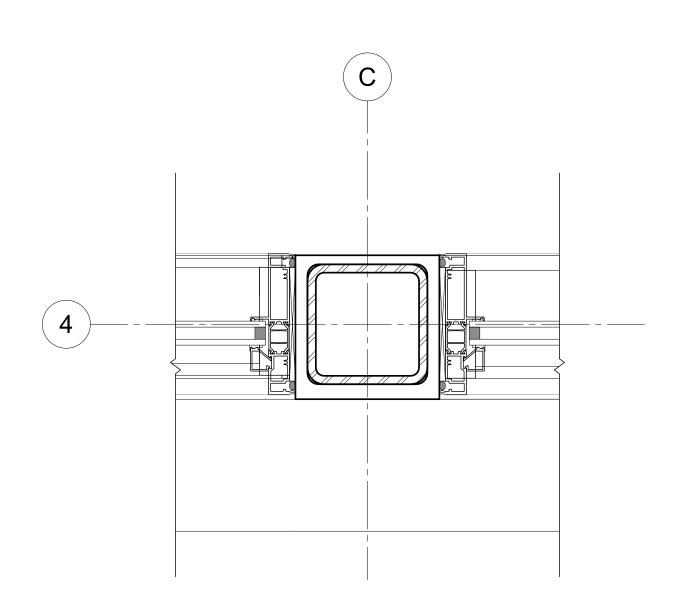

CLERESTORY WINDOW JAMB AT HSS COLUMN

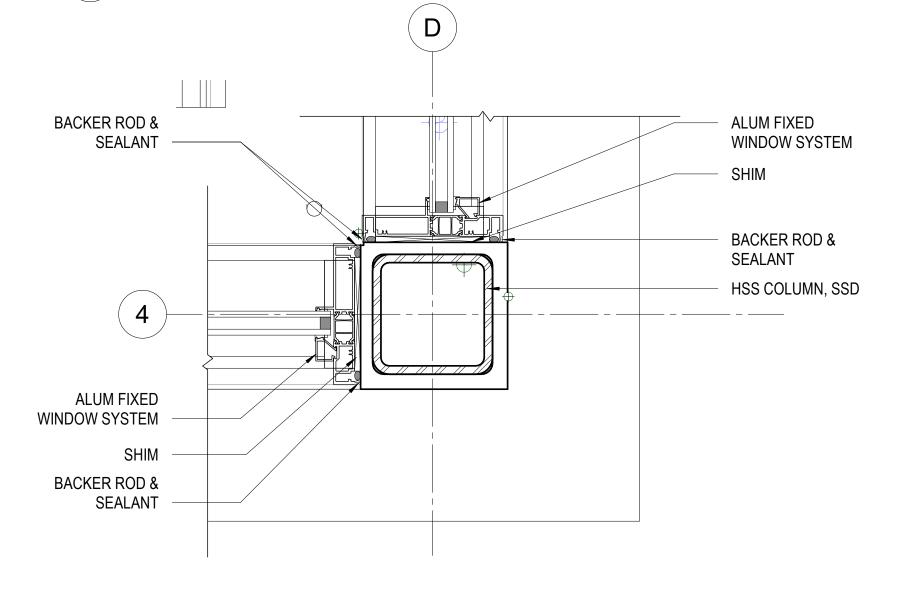

5 PLAN DETAIL AT CLERESTORY WINDOW CORNER
3" = 1'-0"

BUREAU OF ARCHITECTURE



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970 47th Avenue San Francisco, CA 94121

Consultant

11.16.2020

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Drawn Checked


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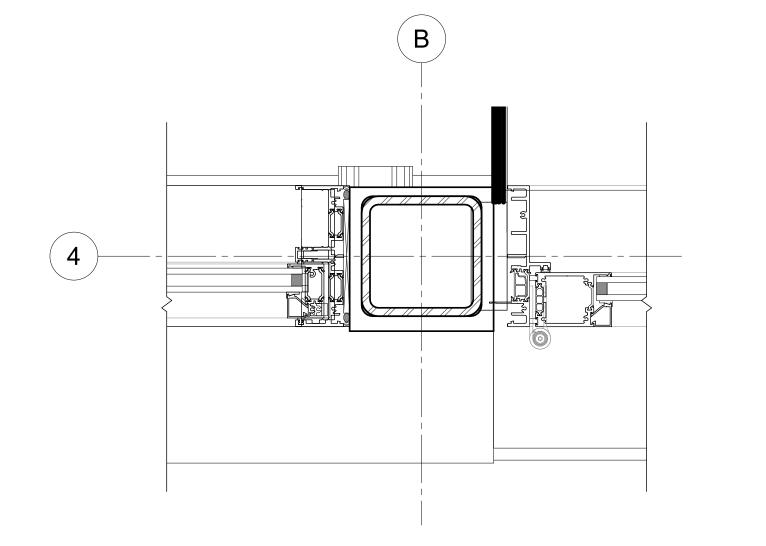
EXTERIOR WINDOW PLAN DETAILS


A8.54

3" = 1'-0"

Project No.



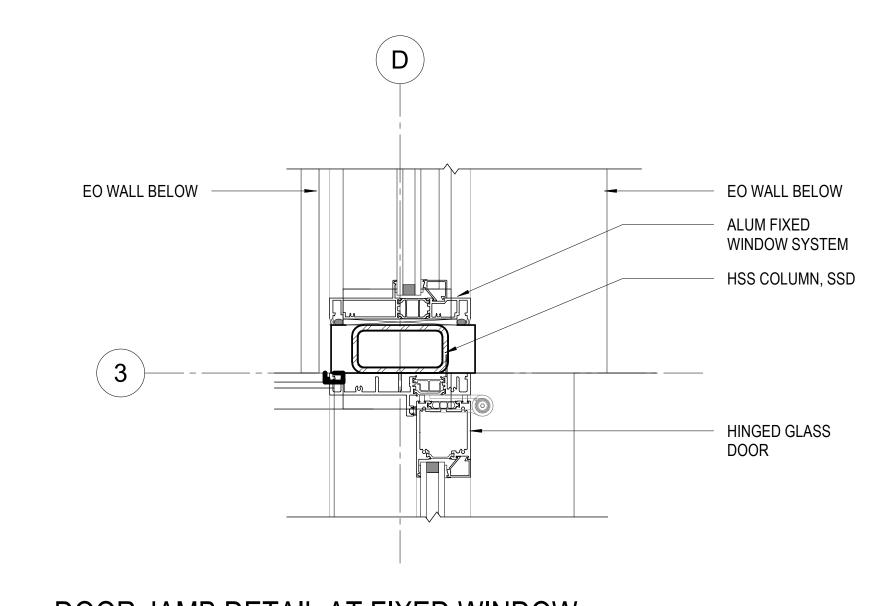


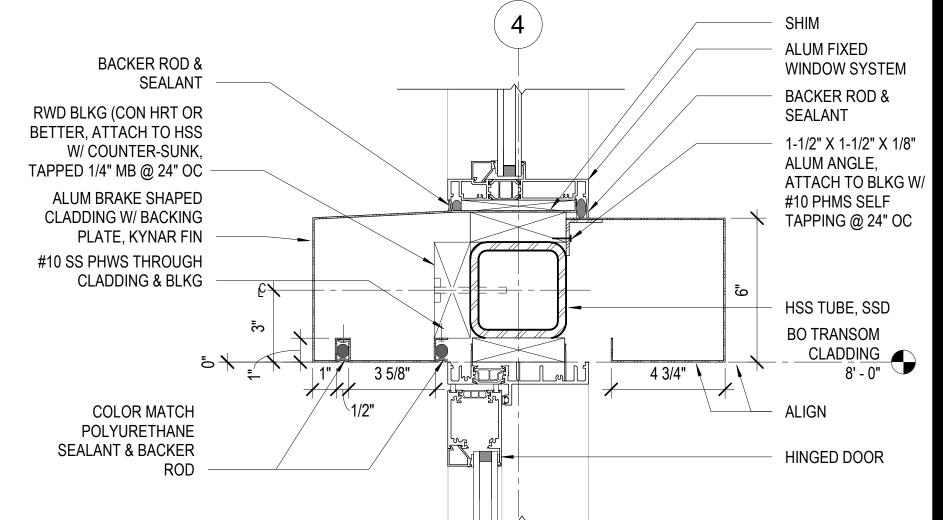









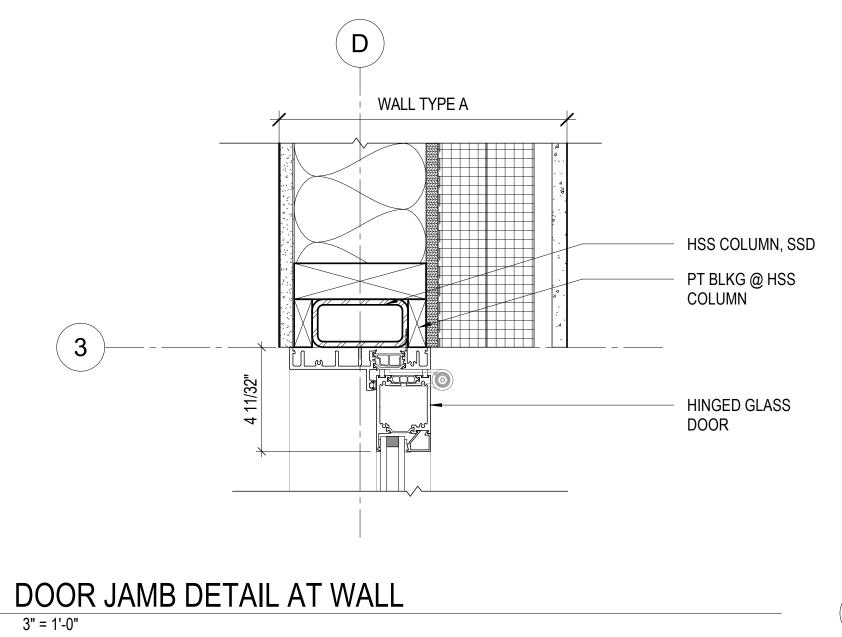


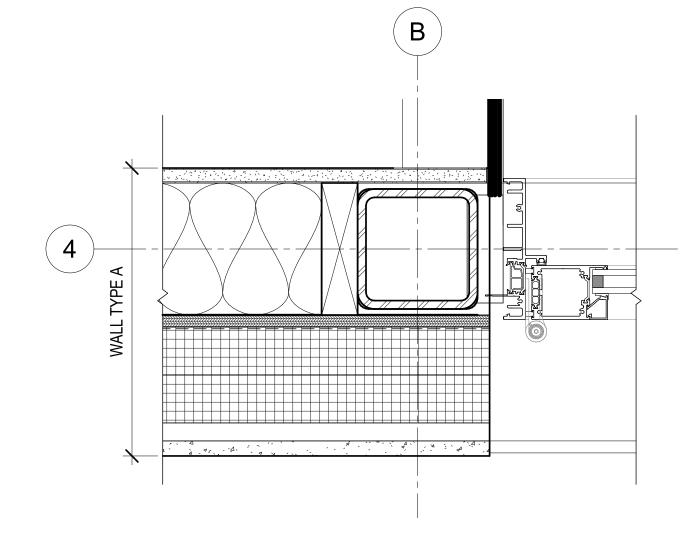



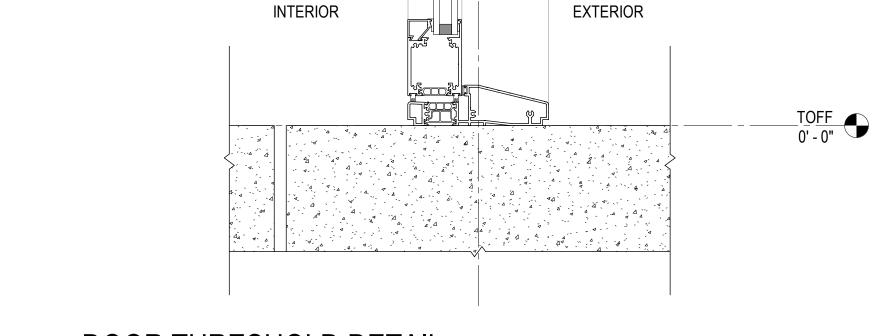

DOOR THRESHOLD DETAIL

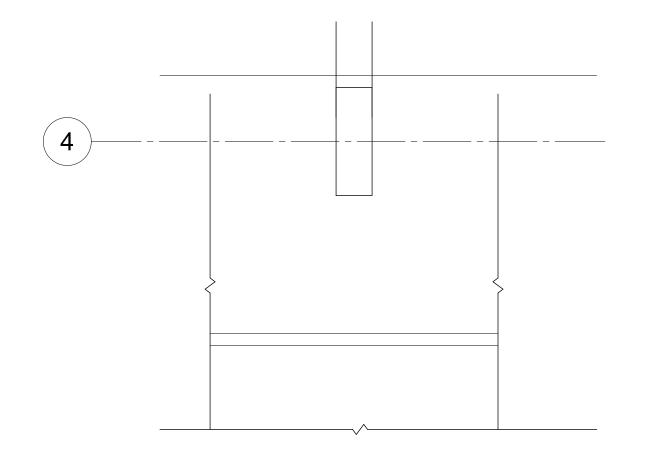

PATIO DOOR PLAN DETAIL AT VERTICAL MULLION

3" = 1'-0"

11.16.2020 Revisions

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Drawing Title

Checked

EXTERIOR DOOR DETAILS


A8.60 3" = 1'-0" Project No.

Original Sheet Size: 22"x34"


HEAD DETAIL AT HOLLOW METAL DOOR & SLATTING

EXTERIOR INTERIOR (1) LAYER OF WRB, WRAP INTO RO 1/2" CDX EXT PLYWD SHEATHING 5/8" TYPE X GYP BD 1/8" THK ALUM BRAKE MTL CLADDING, PTD, TYP TREATED DBL HEAD PLATE, SSD **BO TRANSOM** CLADDING 8' - 0" ALIGN EO CLADDING W/ EO FIBER CEMENT SIDING BEYOND HM DOOR FRAME, MOUNT THROUGH BLKG HM DOOR TO WALL FRAMING 1 15/16"___

HEAD DETAIL AT HOLLOW METAL DOOR & LOUVER

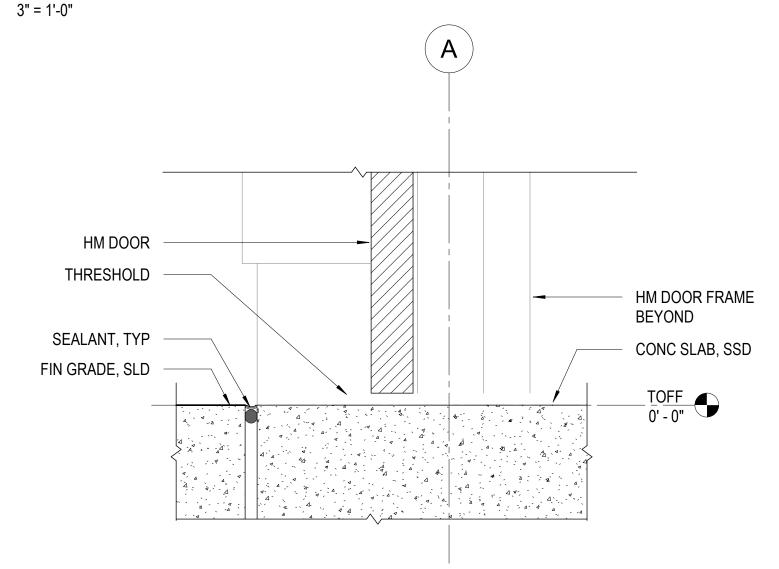

THRESHOLD AT HOLLOW METAL DOOR

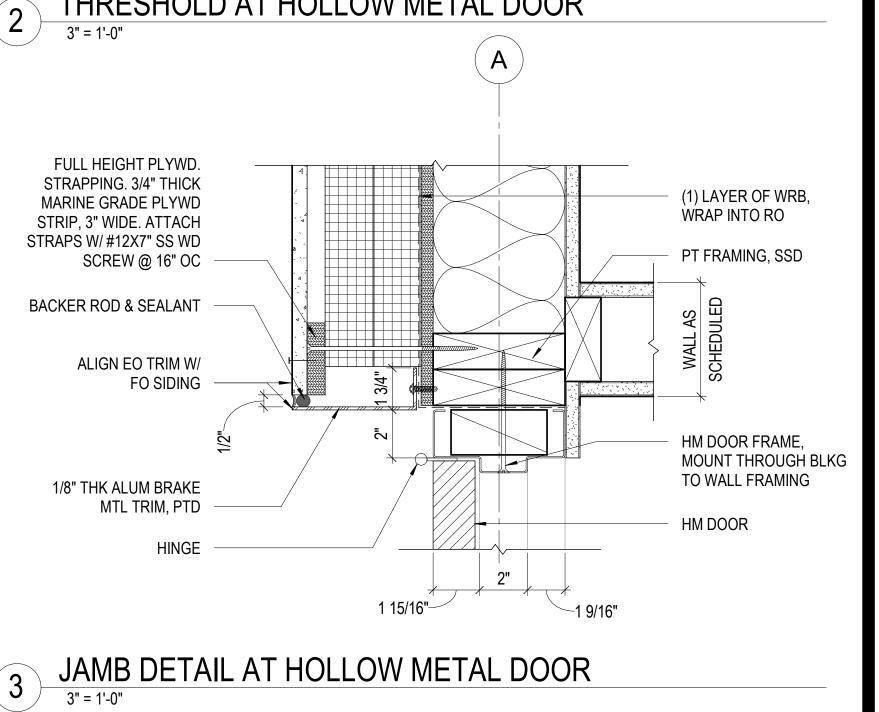

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Drawn Checked

Drawing Title

EXTERIOR DOOR DETAILS

Sheet No.

A8.61

3" = 1'-0"


Scale: Project No.

1804

FINISH AND WALL BASE, TBD 5/8" TYPE X GYPSUM BOARD, BOTH SIDES *PROVIDE 5/8" MOISTURE RESISTANT TYPE X GYP. AT WET AREAS 2X4 WOOD STUD FRAMING AT 16" O.C. TREATED 2X4 SILL PLATE, **BOLTED TO FOUNDATION AT** 24" O.C. CONTINUOUS ACOUSTICAL SEALANT, BOTH SIDES CONCRETE SLAB

WALL TYPE C - INTERIOR PARTITION

3" = 1'-0"

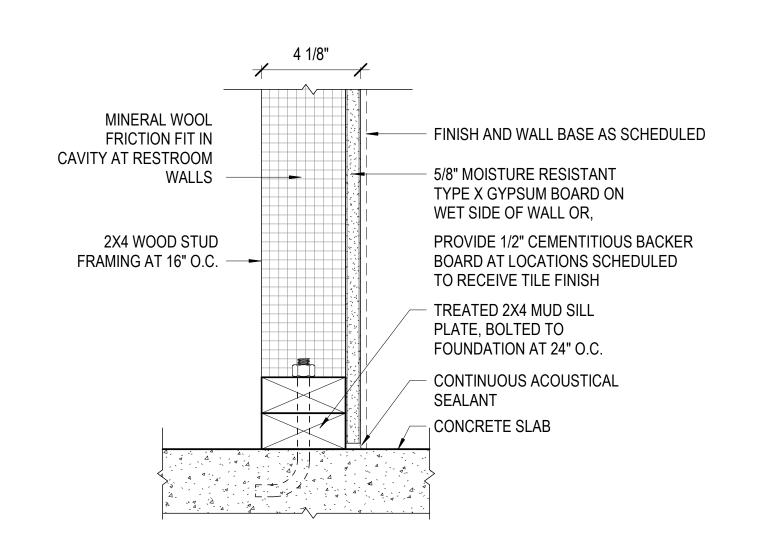

WALL TYPE D - CHASE WALL

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11.16.2020 No. Date Revisions

Drawn

Drawing Title

Checked

PARTITION SCHEDULE, PARTITION **DETAILS**

Sheet No.

A9.10

3" = 1'-0"

Project No.

1804

Scale:

COMMENTS

SIGNAGE

SIDELITE

GROUP


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DOOR SCHEDULE

FINISH

THICKNESS | MATERIAL |

0' - 1 3/4"

0' - 1 3/4"

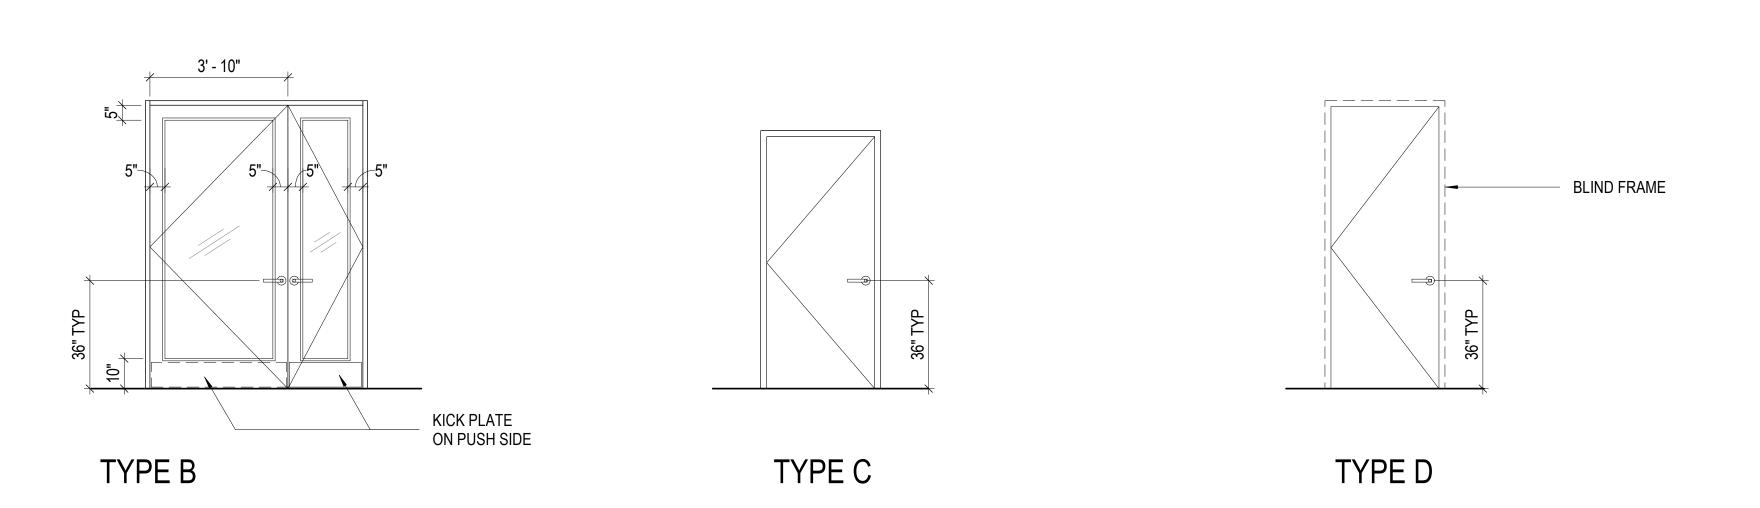0' - 1 3/4"

0' - 2"

0' - 2"

0' - 1 1/2"

0' - 2"

0' - 2"

ALUM

ALUM

ALUM

WOOD

WOOD

FRAME

HEAD

1/A8.60

1/A8.60

1/A8.60

1/A8.61

4/A8.61

DETAIL

JAMB

3/A8.60, 4/A8.60, 5/A8.60

3/A8.60, 4/A8.60, 5/A8.60

6/A8.60, 7/A8.60

3/A8.61

3/A8.61

THRESHOLD

2/A8.60

2/A8.60

2/A8.60

2/A8.61

2/A8.61

DOOR

WIDTH

5' - 11"

0' - 0"

3' - 0"

3' - 4"

6' - 0"

3' - 0"

3' - 4"

3' - 0"

2' - 6"

2' - 6"

2' - 6"

3' - 0"

2' - 6"

6' - 0"

6' - 0"

7' - 7 11/16" | 7' - 10 1/2"

7' - 7 11/16" | 7' - 10 1/2"

FINISH

SIZE

HEIGHT

7' - 10 1/2"

0' - 0"

7' - 0"

8' - 0"

7' - 10"

7' - 10"

8' - 9"

7' - 0"

7' - 0"

7' - 0"


7' - 0"

7' - 0"

7' - 0"

7' - 0"

7' - 0"

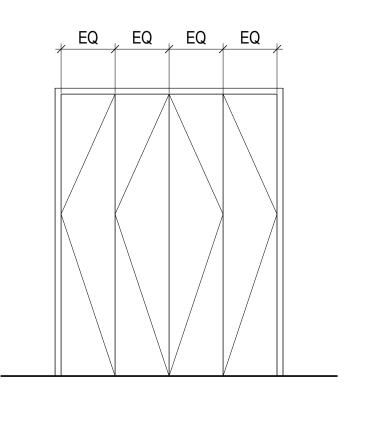

DOOR

NUMBER

101D

104

108

109

DESCRIPTION

EXTERIOR ALUM FRAME GLASS DOOR

EXTERIOR ALUM FRAME GLASS DOOR

EXTERIOR ALUM FRAME GLASS DOOR

FLUSH DOOR

EQ

TYPE A

EQ

EXTERIOR FLUSH DOOR

EXTERIOR FLUSH DOOR

113 EXTERIOR SLATTED PAIR GATE

114 EXTERIOR SLATTED PAIR GATE

FOUR PANEL BI-FOLD DOOR

DOOR TYPE

Α

52

63

KICK PLATE

ON PUSH SIDE

MATERIAL

ALUM/GLASS

ALUM/GLASS

ALUM/GLASS

HM

HM

WOOD

HM

HM

HM


HM

HM

HM

CEDAR SLATTING

CEDAR SLATTING

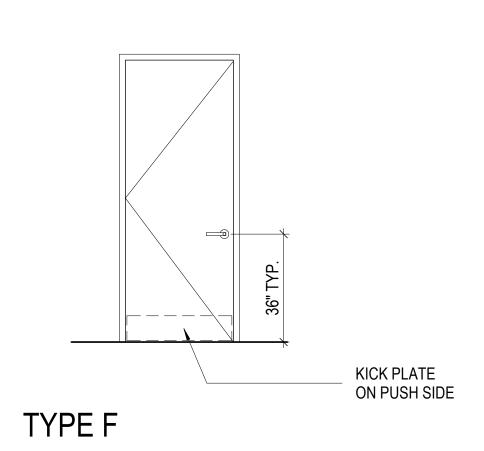

DOOR TYPE LEGEND

TYPE E

PM
Noah Levy
PA
Paul DeFreitas
Drawn
Checked
Checker

11.16.2020

Revisions


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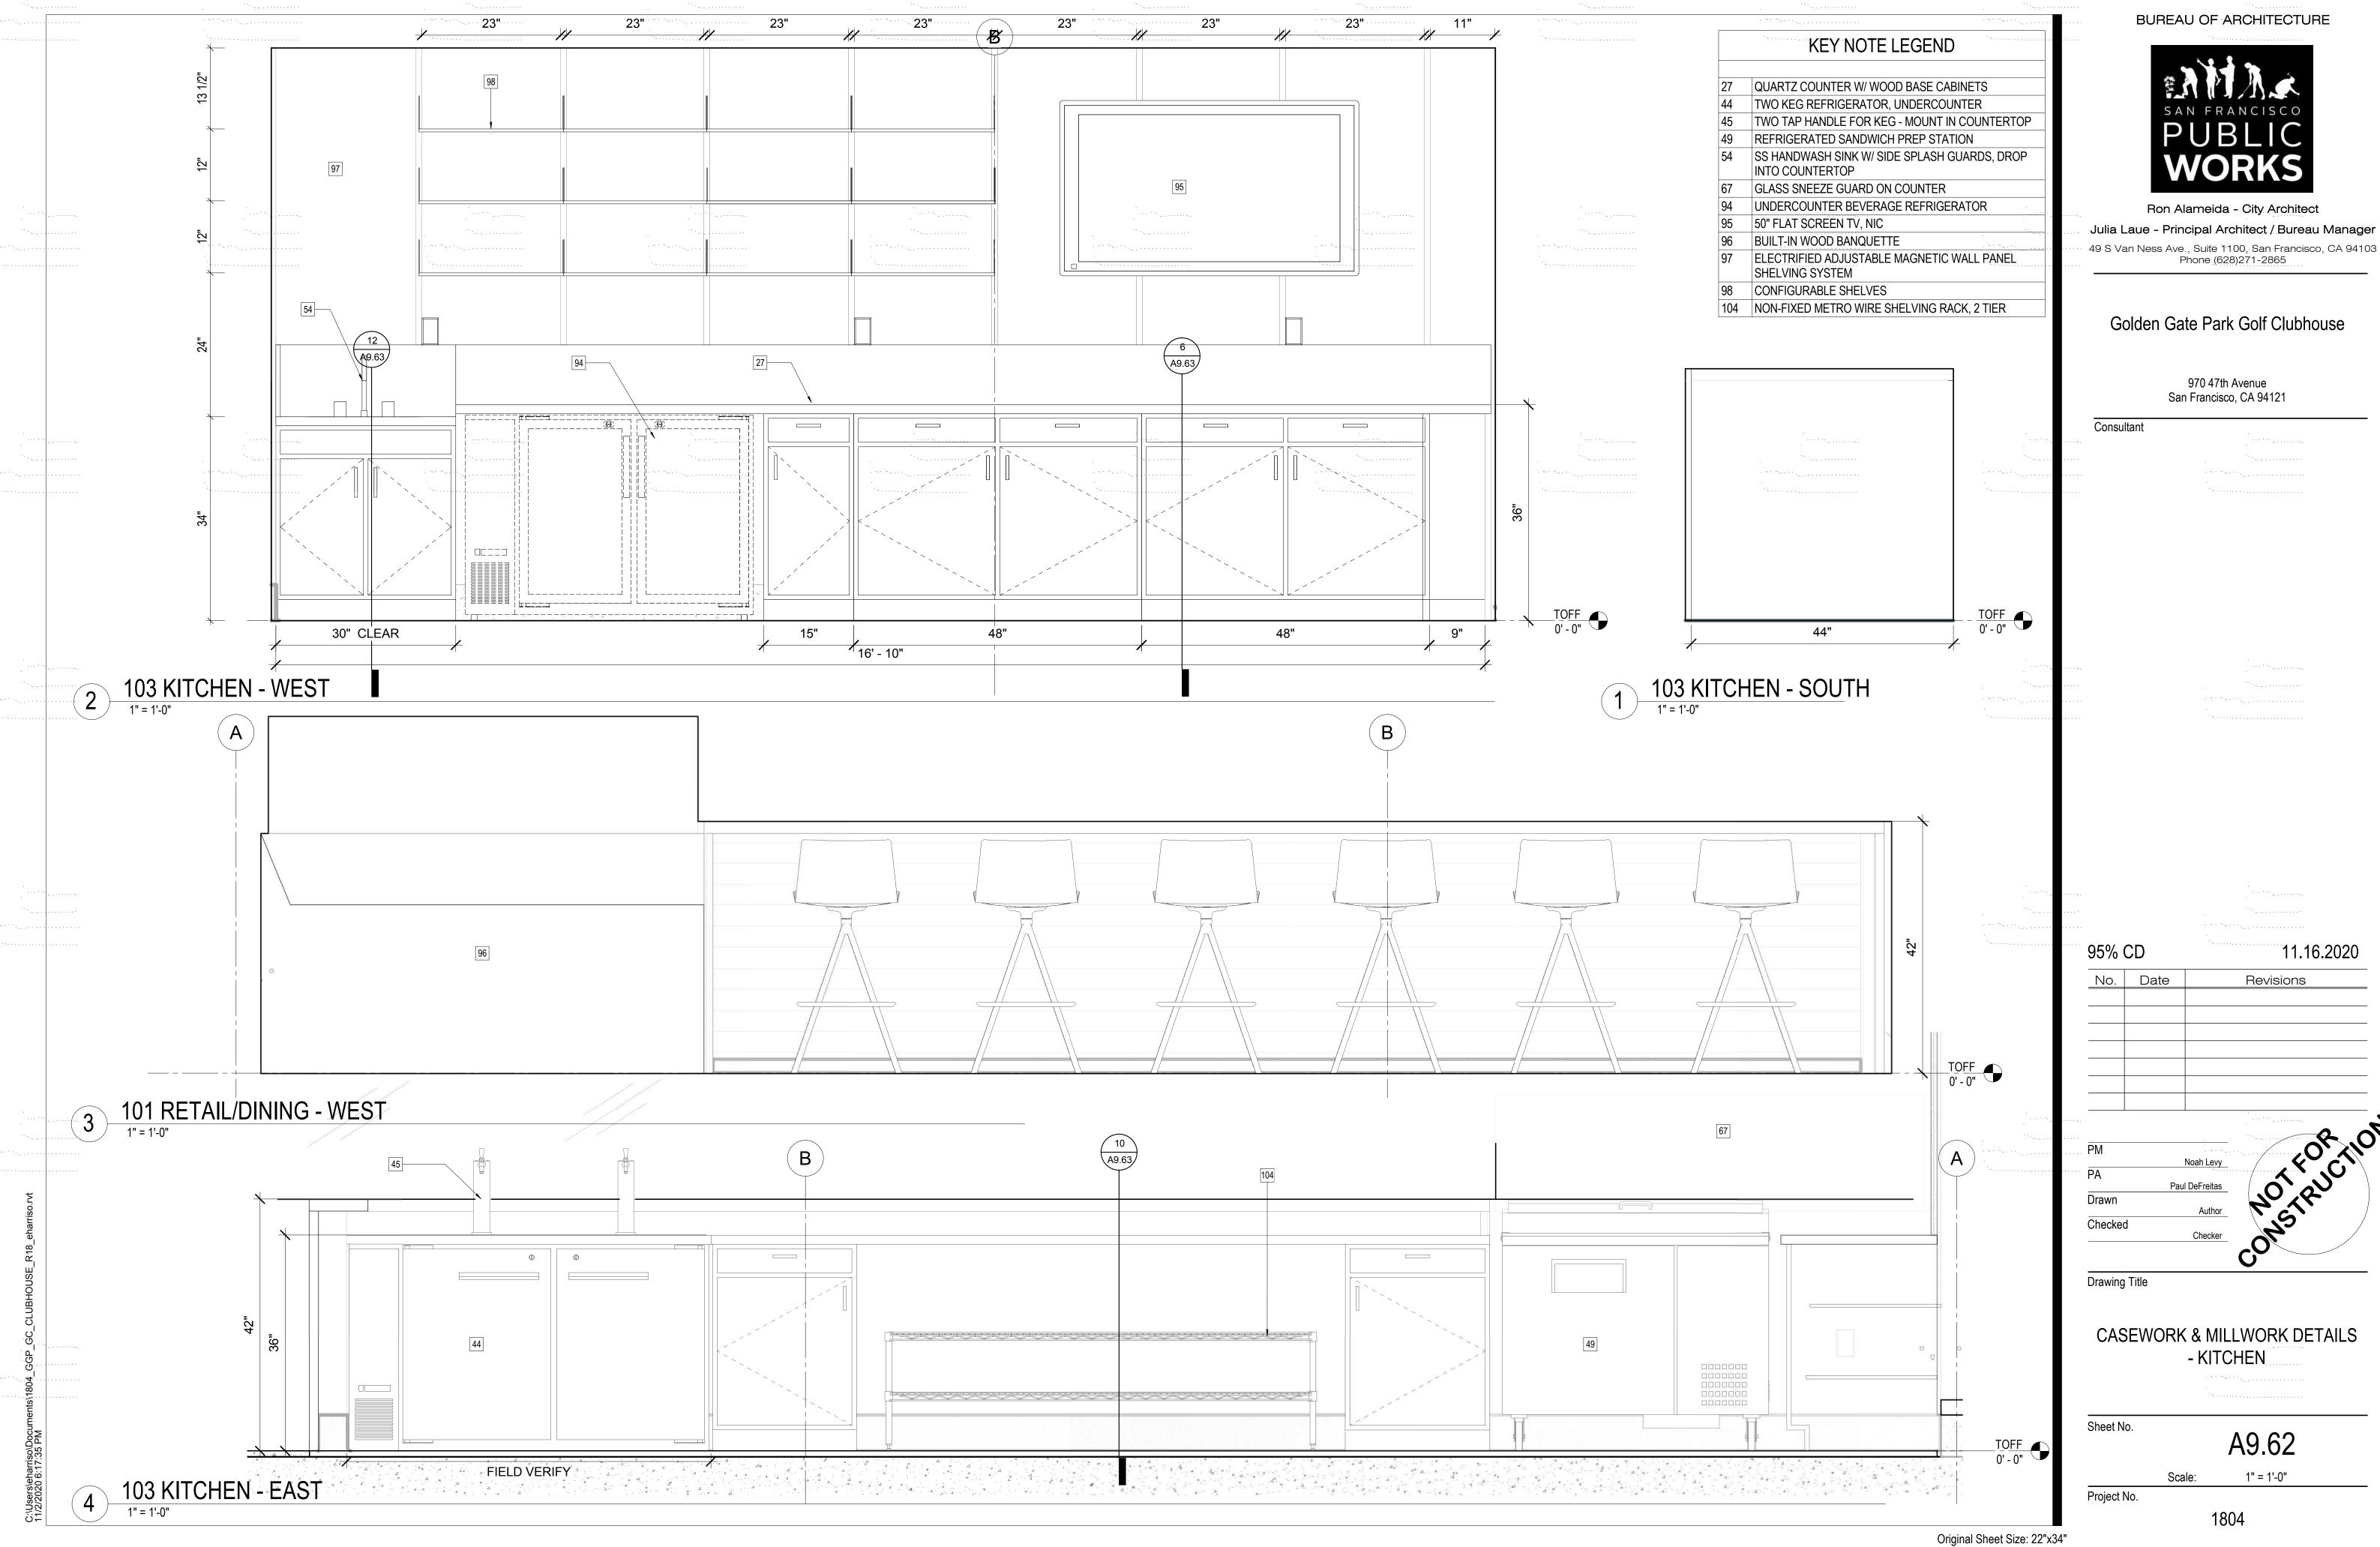
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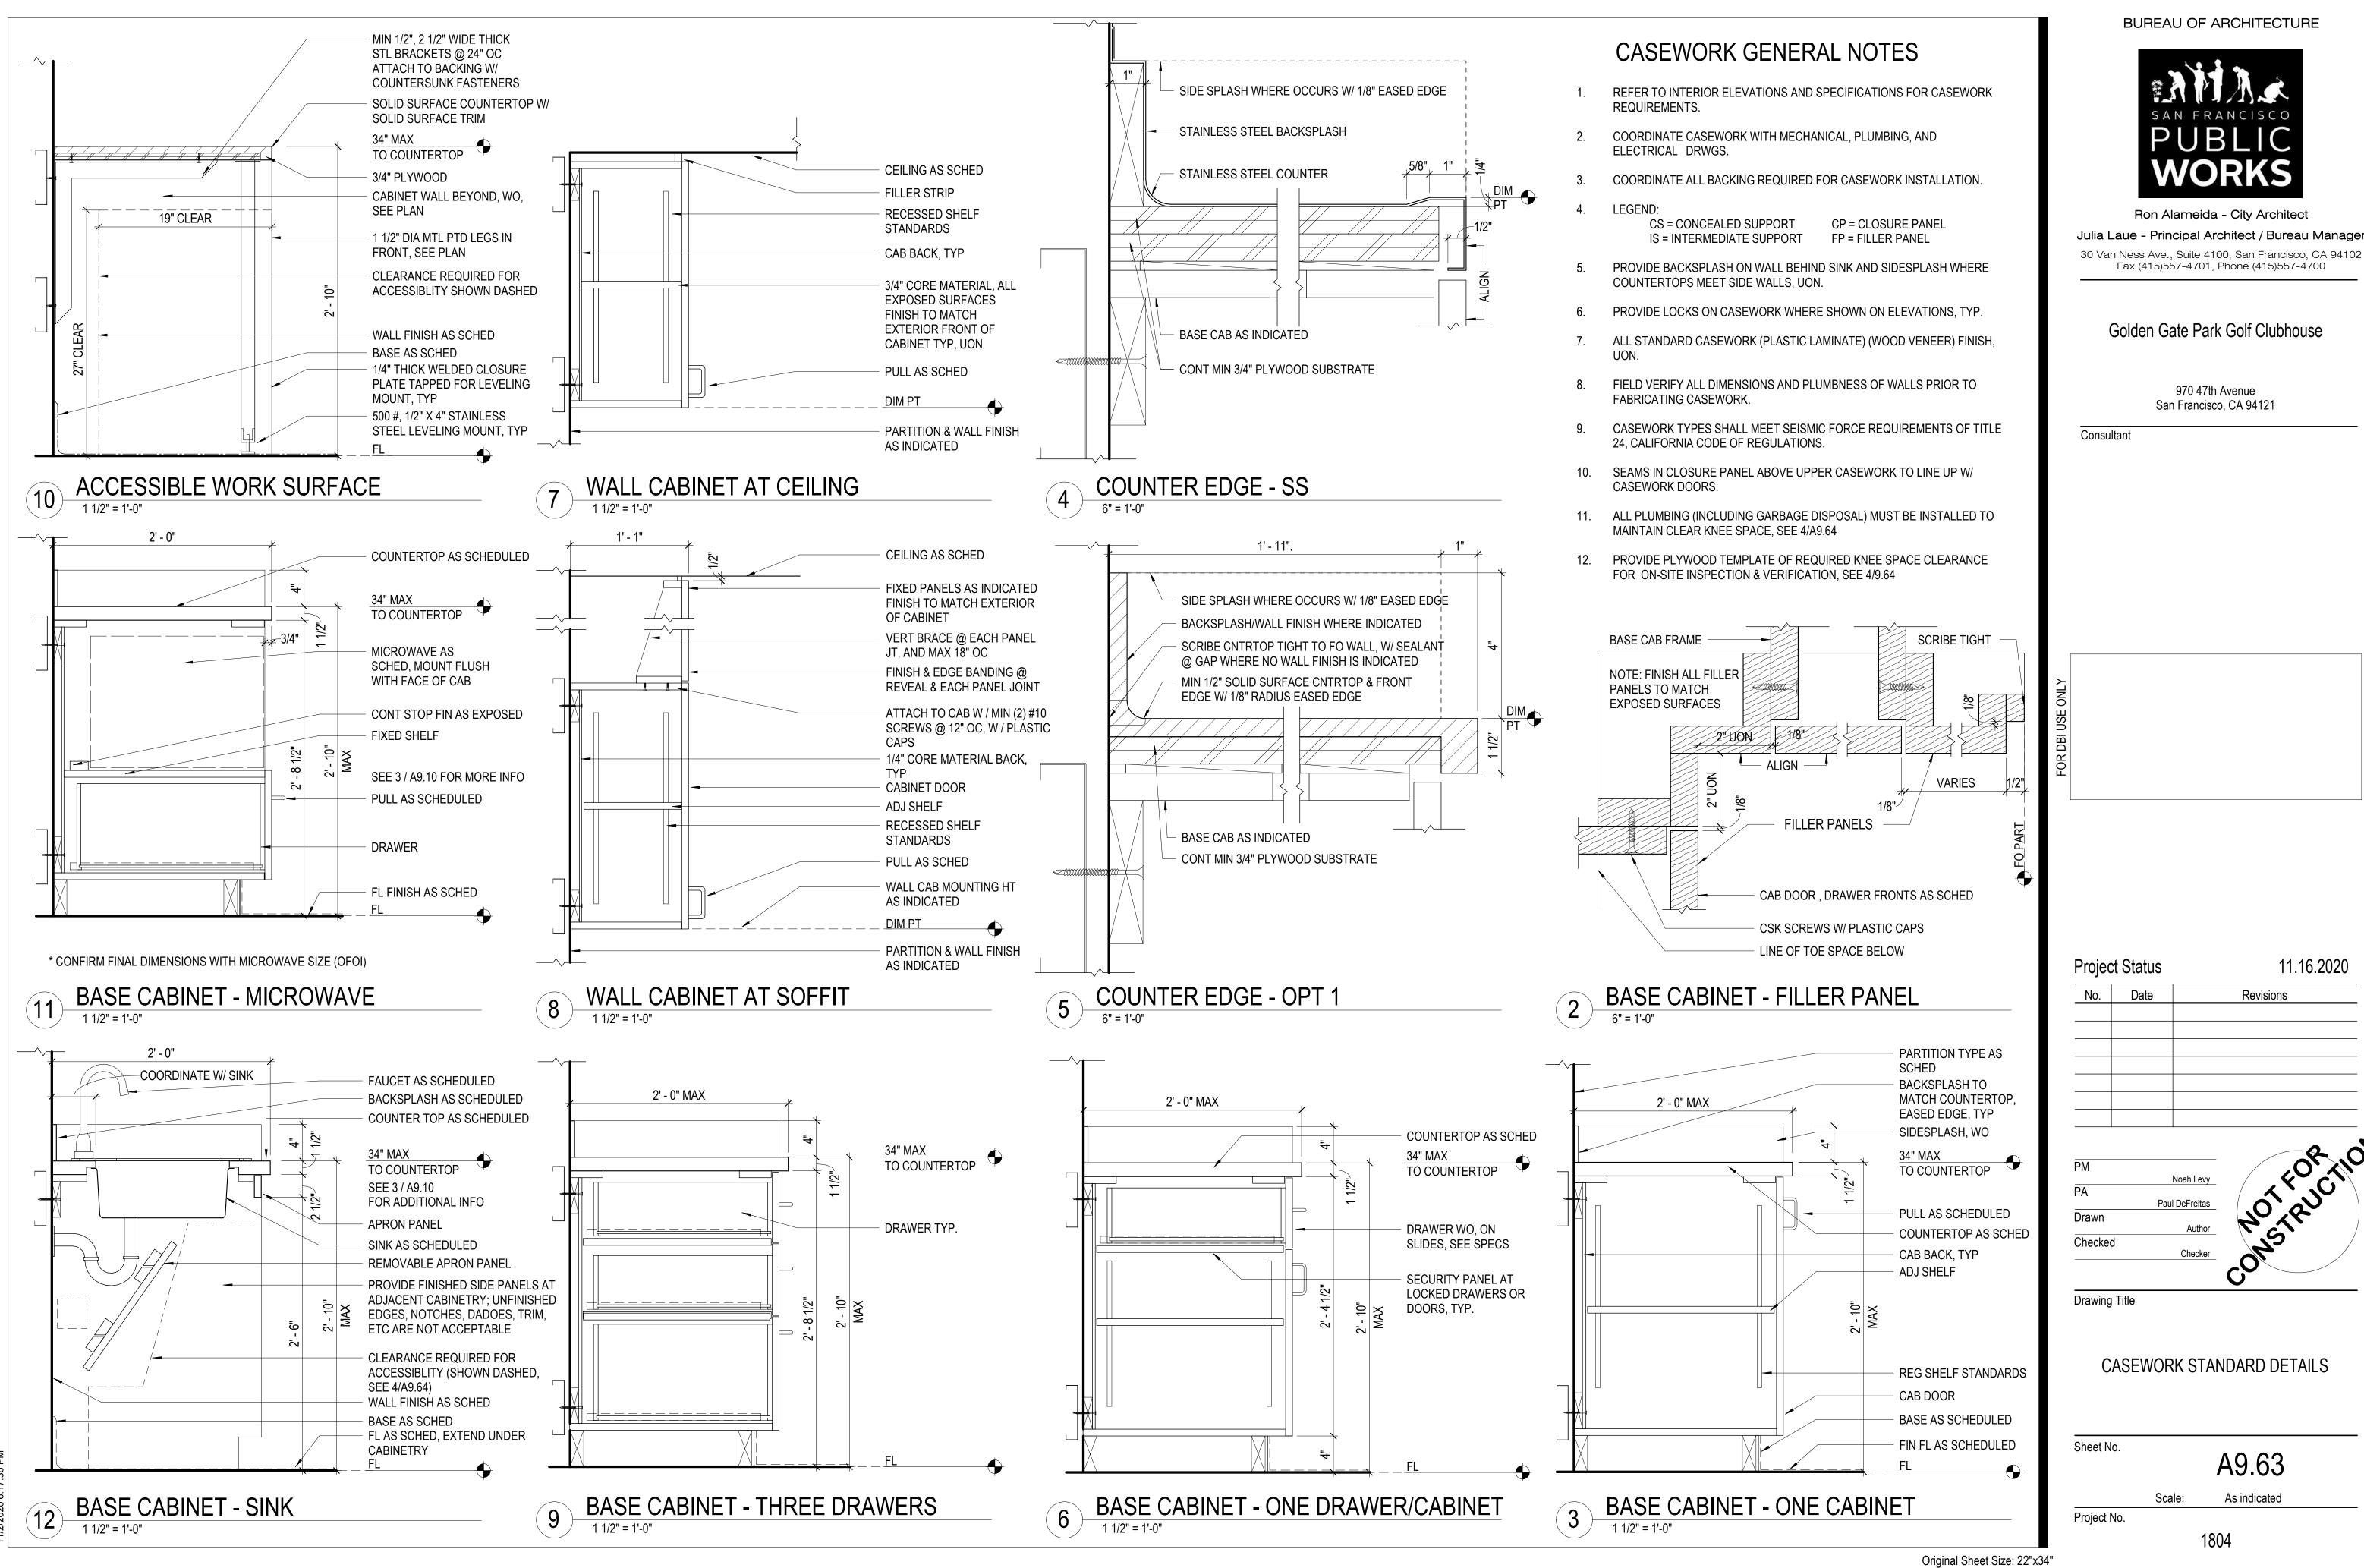
No. Date

DOOR SCHEDULE AND OTHER INTERIOR OPENINGS

t No.		A9.40	
	Scale:	3/8" = 1'-0"	





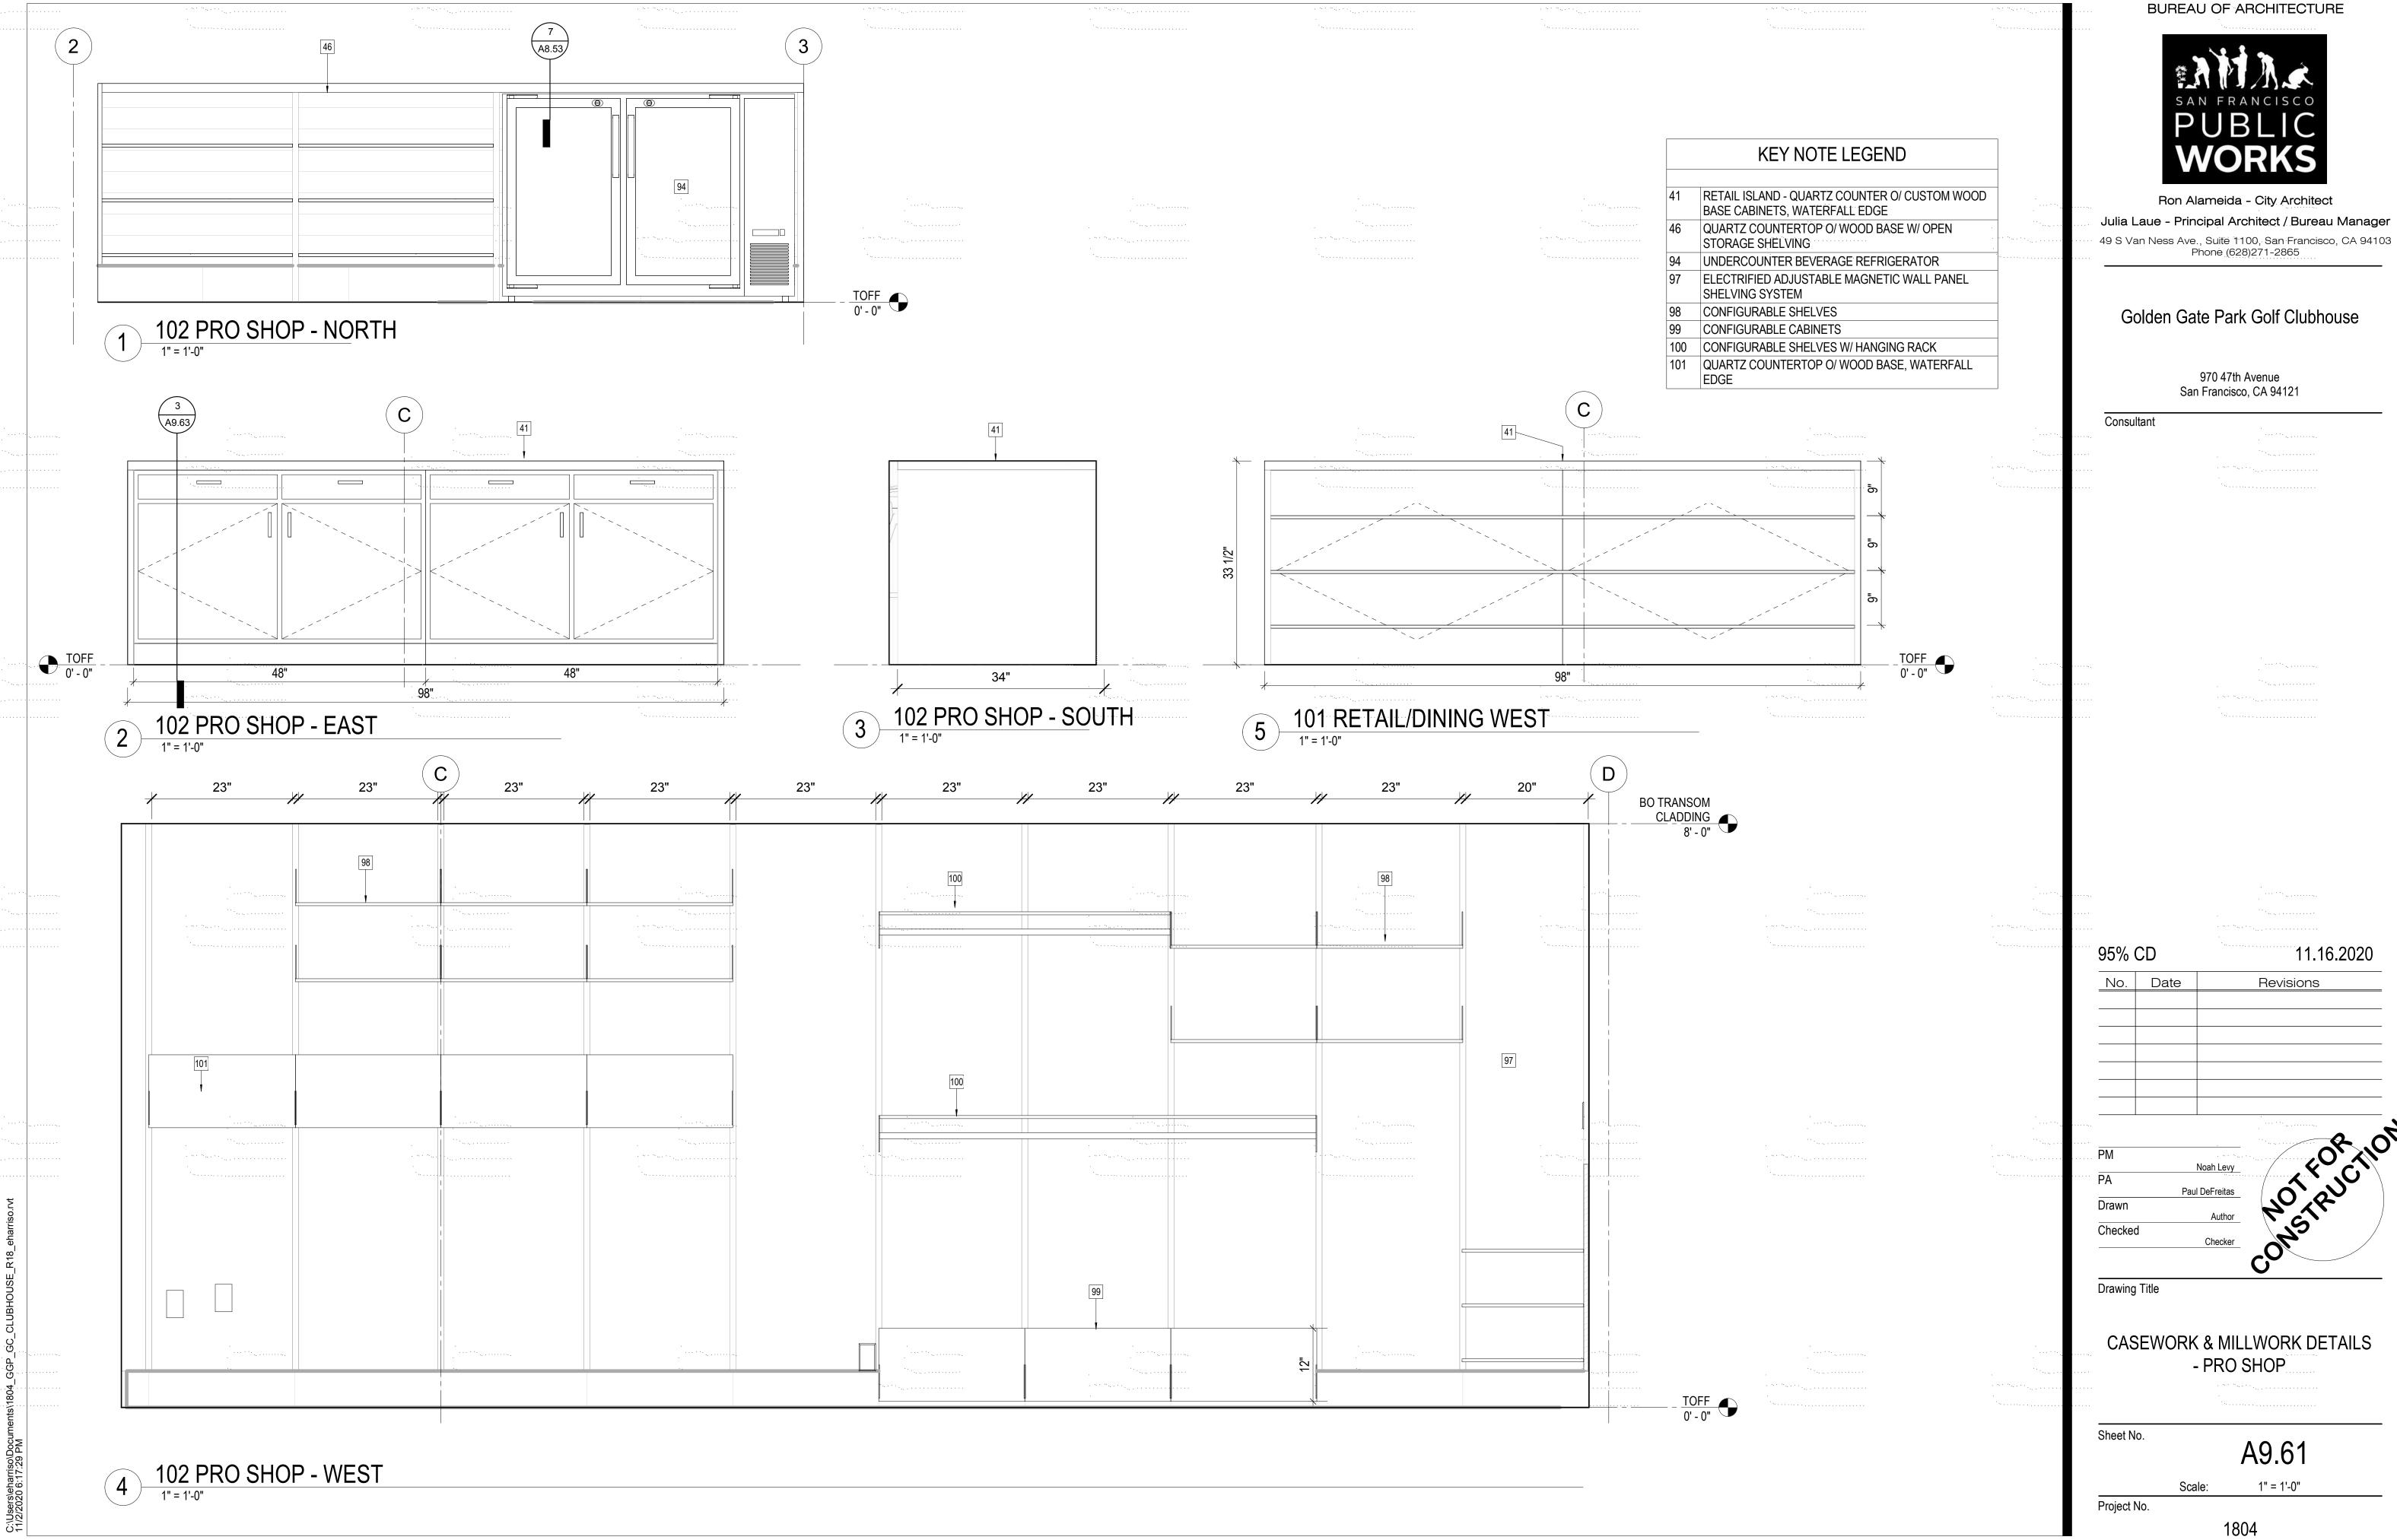

30 Van Ness Ave., Suite 4100, San Francisco, CA 94102

CABINET DOOR BOTTOM OF

WALL CAB DOOR

6

CABINET DRAWER

CABINET PULL LOCATION DIAGRAM

BUREAU OF ARCHITECTURE



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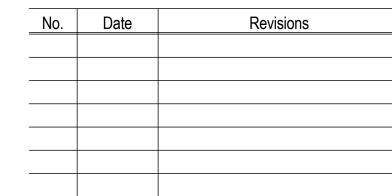
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Consultant

Project Status

11.16.2020



Drawn

Paul DeFreitas Checked

Drawing Title

CASEWORK STANDARD DETAILS

Sheet No.

A9.64 As indicated

Scale: Project No.

1804

ELEVATION AT TYP. CASEWORK 1" = 1'-0"

SEE ELEV

SEE ELEV __

CASEWORK WIDTH

Original Sheet Size: 22"x34"

SPECIFIED

FULL HEIGHT CASEWORK

1 1/2" = 1'-0"

