## **BOARD OF APPEALS, CITY & COUNTY OF SAN FRANCISCO**

| Appeal of                               | Appeal No. <b>21-019</b> |
|---|--------------------------|
| CYNTHIA YEE,                            | )                        |
| Appellant(s)                            | )                        |
|   | )                        |
| VS.                                     | )                        |
|   |                          |
| DEPARTMENT OF BUILDING INSPECTION,      | )                        |
| PLANNING DEPARTMENT APPROVAL Respondent | <del></del> -            |

# **NOTICE OF APPEAL**

**NOTICE IS HEREBY GIVEN THAT** on March 17, 2021, the above named appellant(s) filed an appeal with the Board of Appeals of the City and County of San Francisco from the decision or order of the above named department(s), commission, or officer.

The substance or effect of the decision or order appealed from is the ISSUANCE on March 8, 2021 to Ricky Dung, of a Site Permit (horizontal & vertical addition; addition to the rear of existing 2-story building) at 2019 23rd Avenue.

### **APPLICATION NO. 2018/08/30/8786**

# FOR HEARING ON May 5, 2021

| Address of Appellant(s):   | Address of Other Parties:   |
|--|---|
| Cynthia Yee, Appellant(s)<br>2015 23rd Avenue<br>San Francisco, CA 94116 | Ricky Dung, Carol Zhen, Determination Holder(s)<br>c/o Ronald Yu, Agent for Determination Holder(s)<br>Yuflux Engineering<br>5418A Geary Boulevard<br>San Francisco, CA 94121 |



Date Filed: March 17, 2021

# CITY & COUNTY OF SAN FRANCISCO BOARD OF APPEALS

# PRELIMINARY STATEMENT FOR APPEAL NO. 21-019

I / We, Cynthia Yee, hereby appeal the following departmental action: ISSUANCE of Site Permit No.

2018/08/30/8786 by the Department of Building Inspection which was issued or became effective on:

March 8, 2021, to: Ricky Dung and Carol Zhen, for the property located at: 2019 23rd Avenue.

# **BRIEFING SCHEDULE:**

The Appellant may, but is not required to, submit a one page (double-spaced) supplementary statement with this Preliminary Statement of Appeal. No exhibits or other submissions are allowed at this time.

Appellant's Brief is due on or before: 4:30 p.m. on **April 15, 2021**, **(no later than three Thursdays prior to the hearing date)**. The brief may be up to 12 pages in length with unlimited exhibits. It shall be double-spaced with a minimum 12-point font. An electronic copy should be emailed to: <a href="mailto:boardofappeals@sfgov.org">boardofappeals@sfgov.org</a>, julie.rosenberg@sfgov.org socott.sanchez@sfgov.org and ryu@yuflux.com.

Respondent's and Other Parties' Briefs are due on or before: 4:30 p.m. on **April 29, 2021**, **(no later than one Thursday prior to hearing date)**. The brief may be up to 12 pages in length with unlimited exhibits. It shall be doubled-spaced with a minimum 12-point font. An electronic copy should be emailed to: <a href="mailto:boardofappeals@sfgov.org">boardofappeals@sfgov.org</a>, julie.rosenberg@sfgov.org scott.sanchez@sfgov.org and cynthiasyee@gmail.com.

The Board's physical office is closed to the public and hard copies of the brief do NOT need to be submitted.

#### Only photographs and drawings may be submitted by the parties at the hearing.

Hearing Date: **Wednesday**, **May 5**, **2021**, **5:00 p.m.**, via Zoom. Information for access to the hearing will be provided before the hearing date.

All parties to this appeal must adhere to the briefing schedule above, however if the hearing date is changed, the briefing schedule MAY also be changed. Written notice will be provided of any change to the briefing schedule.

In order to have their documents sent to the Board members prior to hearing, **members of the public** should email all documents of support/opposition no later than one Thursday prior to hearing date by 4:30 p.m. to <a href="mailto:boardofappeals@sfgov.org">boardofappeals@sfgov.org</a>. Please note that names and contact information included in submittals from members of the public will become part of the public record. Submittals from members of the public may be made anonymously.

**Please note** that in addition to the parties' briefs, any materials that the Board receives relevant to this appeal, including letters of support/opposition from members of the public, are distributed to Board members prior to hearing. All such materials are available for inspection on the Board's website at www.sfgov.org/boaYou may also request a copy of the packet of materials that are provided to Board members at a cost of 10 cents per page, per S.F. Admin. Code Ch. 67.28.

### The reasons for this appeal are as follows:

See attachment to the preliminary Statement of Appeal.

Appellant or Agent (Circle One):

Signature: Via Email

Print Name: Cynthia Yee

Yee Family 2015 23<sup>rd</sup> AVE San Francisco, CA 94116

March 16, 2021

To Whom It May Concern:

We are writing to file a Permit Appeal regarding the project at 2019 23<sup>rd</sup> AVE (Permit No: 0210218-138-OL / Application Number: 2018 0830 8786-S). We recently received a Notification of Structural Addition on March 8, 2021. After viewing the most recent submitted plans at the Records Management Division, we noticed that the plans submitted and approved were not the ones we had agreed upon back in June 2019.

We voiced our concerns regarding this project when it was announced in 2019, particularly because the proposed addition would negatively impact the solar access our house and backyard receive and subsequently, the property value of our house. As our backyard is only about 17' ft in depth, the proposed addition on the 1<sup>st</sup> floor would block the entire south side of the yard. Not only would the proposed 2<sup>nd</sup> floor addition run far beyond the depth of our backyard, but the plan also had the addition running parallel to our property for 5' ft.

After consulting the city planner (Gabriela Pantoja), we spoke to the architect, Andrew Kwok, to reach a compromise. Both parties agreed to having a 5'x5' corner removed from the right side of the 2<sup>nd</sup> floor addition. This would ensure that the addition would not run parallel to our property and allow for some light access. Andrew sent the revised plans over to us and Gabriela (emails attached), but the most recent plans have now reverted back to the original wherein "Bedroom 2" is flush against our property line for 5' ft.

Thus, we seek to Appeal as this was not the revised plan that both parties had agreed to. We ask that our neighbors at 2019 honor our original agreement and have the 5'x5' corner removed.

Sincerely,

Yee Family

Residents

Business | Government | Visitors | Online Services

▶ Help

City and County of

# San Francisco

Home

**Permit Services** 

Plan Review

Inspection Services

Most Requested

**Key Programs** 

About Us

Home » Most Requested

## Welcome to our Permit / Complaint Tracking System! **Permit Details Report**

Report Date: 3/16/2021 12:48:27 PM

Application Number: 201808308786

Form Number: 3

Address(es): 2143 / 005 / 0 2019 23RD ΑV

HORIZONTAL & VERTICAL ADDITION. ADDITION TO THE REAR OF (E) 2-STORY BUILDING Description:

Cost: \$300,000.00

Occupancy Code: R-3

Building Use: 27 - 1 FAMILY DWELLING

#### Disposition / Stage:

| Action Date | Stage    | Comments |
|-------------|----------|----------|
| 8/30/2018   | TRIAGE   |          |
| 8/30/2018   | FILING   |          |
| 8/30/2018   | FILED    |          |
| 3/8/2021    | APPROVED |          |
| 3/8/2021    | ISSUED   |          |

#### **Contact Details:**

# **Contractor Details:**

License Number: 1003909 YING HUI CHEN Name:

Company Name: STAR LIGHT CONSTRUCTION INC

174 ELMIRA \* SAN FRANCISCO CA 94124-0000 Address:

Phone:

#### Addenda Details:

#### Description:

| Step | Station     | Arrive  | Start    | In Hold | Out<br>Hold | Finish  | Checked By          | Hold Description   |
|------|-------------|---------|----------|---------|-------------|---------|---------------------|--|
| 1    | СРВ         | 9/5/18  | 9/5/18   |         |             | 9/5/18  | TORRES<br>SHIRLEY   |  |
| 2    | CP-NP       | 5/3/19  |          | 5/3/19  | 5/9/19      | 6/19/19 | PANTOJA<br>GABRIELA | Emailed cover letter on 5/3/2019 (William) Mailed 311 notice on 5/20/2019; expires 6/19/2019 (William)   |
| 2    | CP-ZOC      | 9/5/18  | 10/23/18 | 1/2/19  | 5/3/19      | 6/28/19 | PANTOJA<br>GABRIELA | Approved the construction of a two-story horizontal addition at the rear of an existing two-story single family residence. At the first floor, the addition will be approximately 20 feet in depth and 20 feet in width. At the second floor, the addition will be approximately 17 feet in depth and at maximum 20 feet in width. GP 06/28/2019 Sent NOPDR. GP 1/2/2019                       |
| 3    | BLDG        | 7/1/19  | 7/3/19   |         |             | 7/11/19 | LOVE GARY           | otc not applied  |
| 4    | BLDG        | 7/11/19 | 7/19/19  | 7/19/19 |             | 1/9/21  | FINNEGAN JOHN       | (WKP999) Approved Site Plan  |
| 5    | DPW-<br>BSM | 7/22/19 | 7/23/19  |         |             | 7/23/19 | ZHOU ANDY           | Approved SITE Permit only. 7/23/19: ADDENDUM requirement(s) for sign off: Minor Sidewalk Encroachment (Existing pavers and driveway). Download sidewalk application(s) at http://www.sfpublicworks.org/services/permits/application-forms and submit them at 1155 Market, 3rd Floor. Your construction addendum will be ON-HOLD until all necessary permit(s) are approved or the assigned BSM |



|    |             |         |         |         |                      | plan checker(s) may recommend sign off to the satellite office via email. Please call BSM main office at (415) 554-5810 or view http://www.sfpublicworks.org/informationalbrochures for permit application informationAZ  |
|----|-------------|---------|---------|---------|----------------------|---|
| 6  | SFPUC       | 7/24/19 | 7/25/19 | 7/25/19 | HELLER<br>MORGAN     | Capacity Charge not applicable. No change in meter size, not enough fixtures added to warrant a larger meter.  Route to PPC - 07/25/2019  |
| 7  | CP-ZOC      | 1/11/21 | 2/1/21  | 2/1/21  | PANTOJA<br>GABRIELA  | Re-stamp revised plan sets. GP 2/1/2020   |
| 8  | DPW-<br>BSM | 2/3/21  | 2/9/21  | 2/9/21  | THEO DEVINE<br>DAVID | Approved SITE Permit only 2/9/21. ADDENDUM requirement(s) for sign off: Minor Sidewalk Encroachment (Existing pavers and driveway), Inspection Right-of-Way Conformity (final inspection), Bureau of Urban Forestry (new street tree). Download sidewalk application(s) at http://www.sfpublicworks.org/services/permits/application-forms and submit electronically to bsmpermitdivision@sfdpw.org (sidewalk) and/or urbanforestry@sfdpw.org (trees/landscaping) Only new trees can be applied ONLINE and UPLOAD plans through http://bsm.sfdpw.org/buftrees2/treeplanting.aspx. Your construction addendum will be ON-HOLD until all necessary permit(s) are approved or the assigned BSM plan checker(s) may recommend sign off to the satellite office via email. Please call the office at (628) 271-2000 or email at bsmpermitdivision@sfdpw.org for more informationTD |
| 9  | SFPUC       | 2/10/21 | 2/11/21 | 2/11/21 | WONG<br>KENDRICK     | Restamp. Route to PPC. 02/11/2021   |
| 10 | DFCU        | 2/11/21 | 2/11/21 | 2/11/21 | BLACKSHEAR<br>JOHN   | 2/11/21: Planning entered a Child Care impact fee on this permit. It will be collected at addenda #1 issuance.  |
| 11 | PPC         | 1/11/21 | 1/11/21 | 2/12/21 | LUA NATALIE          | 2/12/21: to CPB; NL 2/11/21: QC'd to DFCU; NL 2/10/21: To SFPUC to review and stamp revised sets; NL 02/03/21: To BSM;ME 1/11/21: To DCP to review and stamp revised sets, then BSM & PUC; HP 7/25/19: to HOLD bin pending BLDG approval; am 7/24/19: to PUC; am 7/22/19: to BSM; cp 7/11/19: To BLDG; HP 7/1/19: to BLDG;EC. 6/21/19: S/R1 to DCP; HP  |
| 12 | СРВ         | 2/12/21 | 2/18/21 | 3/8/21  | CHEUNG DEREK         | 3/8/21: released to Permit Center for customer p/udc 2/18/2021: Extension fee required. 1st extension fee \$860.85. When pay fee, new cancel date: 6/20/2021.ay 2/18: called owner for e-mail to send invoicedc   |

This permit has been issued. For information pertaining to this permit, please call 628-652-3450.

#### Appointments:

| Appointment Date   Appointment AM/PM   Appoin | nent Code Appointment Type | Description Time S | Slots |
|---|----------------------------|--------------------|-------|
|---|----------------------------|--------------------|-------|

#### Inspections:

| Activity Date | Inspector | Inspection Description | Inspection Status |
|---------------|-----------|------------------------|-------------------|

#### **Special Inspections:**

| Addend | a No. | Completed Date | Inspected By | Inspection Code | Description | Remarks |
|--------|-------|----------------|--------------|-----------------|-------------|---------|
|--------|-------|----------------|--------------|-----------------|-------------|---------|

For information, or to schedule an inspection, call 628-652-3400 between 8:30 am and 3:00 pm.

Online Permit and Complaint Tracking home page.

#### **Technical Support for Online Services**

If you need help or have a question about this service, please visit our  $\mathsf{FAQ}$  area.

Contact SFGov Accessibility Policies

City and County of San Francisco © 2021



# **BRIEF(S) SUBMITTED BY APPELLANT(S)**

Yee Family Jeffrey Yee and Jenny Yee 2015 23<sup>rd</sup> Ave San Francisco, CA 94116

April 13, 2021

Dear Board of Appeals,


We are writing to appeal the project at 2019 23<sup>rd</sup> AVE (Permit No: 0210218-138-OL / Application Number: 2018 0830 8786-S). Although our Appeal Application statement mentioned the submission of the original plan, rather than a revised plan, we now want to use this opportunity before the Board to ask that it consider the impact that this addition would have on our home and overall livelihood.

We have lived at 2015 23<sup>rd</sup> AVE, the house adjacent to 2019, since 1995. For more than 25 years, this has been our home – where we raised and watched our two children grow into adults, where we finally bought a house of our own after renting apartments and basement units, and where we made priceless memories with family and friends. Our home is our sanctuary and where we as a family could reconvene after grueling days at work or laborious days at school. As first-generation Chinese immigrants, our parents, Jenny and Jeffrey, worked menial jobs (and still do, to this day) to support their children. Adapting to a new country, where you don't speak the language or have the education and means for upward mobility, was and remains a constant struggle. By purchasing the house, they firmly planted their roots down in San Francisco. Our home at 2015 is one of the few tangible sources of happiness and symbols of success.

When we originally heard our neighbors at 2019 wanted to add an addition to their home, we immediately expressed our hesitancy. The original architect, Andrew Kwok, held a Pre-Application Meeting in August 2018. Hearing about the original plans, we already knew that the proposed addition would significantly impact the solar access the back of our house and the yard would receive.

In the summer of 2019, we received a Notice of Building Permit Application. Again, the plans showed in greater detail a proposed 2-story addition that would extend 20' on the first floor and 17' on the second floor. The depth of our backyard is only 17'. Not only would this addition cast a shadow on our property and block potential light access, but the addition would extend far beyond the depth of our backyard, creating a tunnel.

Google Maps satellite screenshot below to show the stark difference between the depth of our backyard versus that of our neighbor's:

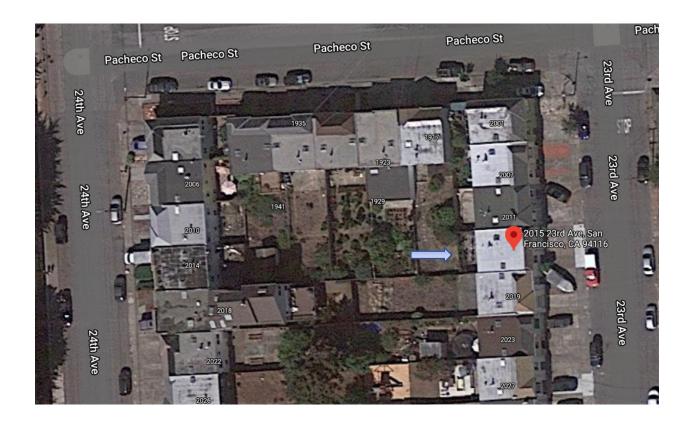

# Zoomed in:



Per the notice, our options were to reach out to the Applicant (Andrew Kwok, at the time) and the City Planner (Gabriela Pantoja) to express our concerns regarding the project. We wrote letters to both parties (attached) in May 2019 detailing the impact this addition would have on our property, including reducing solar access, limiting the use of our outdoor space, and severely impacting our property value. In the letter to Andrew Kwok, we initially suggested a compromise of just a 1<sup>st</sup> floor addition.

The city planner recommended exhausting all opportunities to discuss and work out a compromise that would address all concerns before resorting to a Discretionary Hearing. We quickly arranged for a phone call between ourselves and the architect, Andrew Kwok, in order to express our concerns and explain how this proposed addition would impact our home. After hearing our concerns, Andrew offered up the removal of a right side 5'x5' corner, so as to not have part of the second-floor addition run adjacent to our property line. However, as he mentioned, the addition would be happening regardless and that this was the best he could do as a compromise. Thinking we were out of options and as a gesture of goodwill and being neighborly, we reluctantly agreed. He sent over the revised plans and we offered our approval. In hindsight, we feel as though we were steamrolled by Andrew into accepting a compromise that did not completely address our concerns.


That was the last we had heard of the project. For the remainder of 2019 and throughout all of 2020, we never heard back from Andrew, our neighbors, or the City. However, in March of this year, we finally received a Notification of Structural Addition. Per the notice, we were allowed to view the plans at the Records Management Division.


Once at the Records Management Division, we were shocked to see that the plans submitted and approved were the ORIGINAL plans and not the revised plan that Andrew had drawn up in 2019 with the 5'x5' corner removed. Had we not had the foresight to go down to the Records Management Division, we most likely would not have known until the rear addition had already been constructed. Although it may be claimed that this was a "mistake," it is incredibly disappointing that this would have been submitted and approved without a single party recognizing the "mistake." Again, the compromise was offered up as a gesture of good faith and will; to see that this was not honored, in addition to the fact that our longstanding concerns have not been taken into account, makes us uncomfortable and reluctant to let the project move forward as is. Thus, we come to the Board of Appeals to express our concerns with this project.

We ask the Board of Appeals to please consider the severe and negative impact that this proposed addition would have on our home and neighborhood. As is, the project would extend far beyond the depth of our backyard, which is only 17'. The most recent plans dated

03222021 incorrectly indicate that our property line runs alongside our neighbor's at 2019 on sheet A1.2. This is completely inaccurate.

Screenshot of Sheet A1.2 below:

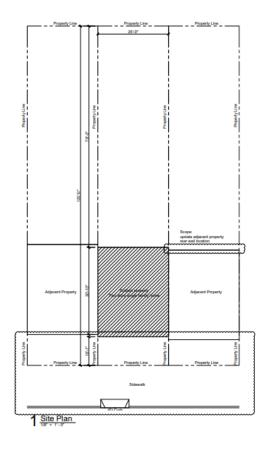


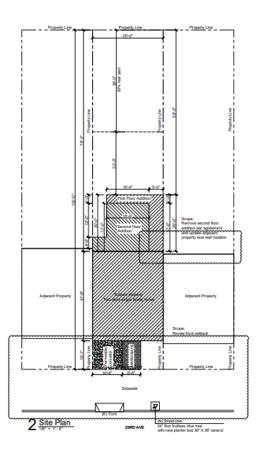

With our neighbor at 1917 having a longer backyard running perpendicular to our yard and those of our neighbors at 2001, 2007, and 2011, we have absolutely no possibility of adding an addition of our own. The Google Maps satellite images above show the difference between the drawn plans and what actually exists. See also the attached Sanborn map and Assessor's Block map from SF PIM (<a href="https://sfplanninggis.org/PIM/">https://sfplanninggis.org/PIM/</a>) that show the true width and depth of our backyard. We are concerned that these submitted plans paint an inaccurate picture depicting a yard of equal depth and the possibility that we could add an addition of our own if we chose. This simply is not true or accurate.

The photos below are taken from our backyard and show the view and sunlight that we are at risk losing with this addition, as well as the fence lines.

Facing west, back fence is visible.

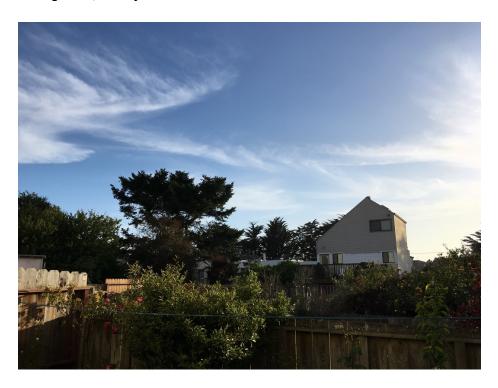

Facing southwest, south fence (runs alongside 2019 property line) is visible



# Facing south



Facing south, taken from northeast corner to depict actual size of backyard





While we are understanding of our neighbor's desire to add onto their home, we ask that our concerns with this addition be heard and considered. An addition of this size would negatively impact our home and property in numerous ways, including reducing solar access, limiting our outdoor space use, and negatively impacting our property value.

In conclusion, we ask the Board of Appeals and our neighbors at 2019 to seriously consider the concerns we have outlined in this letter and ask that the rear addition not exceed more than a single story. We do not feel comfortable allowing the proposed rear addition to go through, as it will severely impact our livelihood and the place we have called home since 1995. We believe a single-story addition would allow our neighbors to expand upon their home, with minimal impact on our solar access and overall livelihood. Considering our initial compromise was not honored in the plans that were submitted to the City and the inaccurate portrayal of the depth of our property, we cannot in good faith allow this plan to

| move forwa   | rd as is without  | speaking up and a  | asking that the I | Board of Appeals | and the City to |
|--------------|-------------------|--------------------|-------------------|------------------|-----------------|
| seriously re | consider the issu | ue of this permit. |                   |                  |                 |

Sincerely,

Yee Family

May 24, 2019

Jeffrey and Jenny Yee 2015 23<sup>rd</sup> Avenue San Francisco, CA 94116

Andrew Kwok 475 Littlefield Avenue South San Francisco, CA 94080

Dear Andrew,

We are the homeowners of  $2015\ 23^{rd}$  Avenue. It has come to our attention that you are moving ahead to build a rear addition to the home at  $2019\ 23^{rd}$  Avenue.

After examining the plans that were sent to us by the San Francisco Planning Department, we are writing to voice our concerns about this project. The two-story rear addition proposed would severely impact the solar access our home and backyard receive, and effectively cause devaluation in our property.

The depth of our backyard is approximately 17 feet. The proposed first floor addition would be 20 feet in depth, while the proposed second floor would be 17 feet. The entire south side of our backyard, which runs adjacent to this proposed addition, would be entirely blocked by this rear addition. Again, this would negatively impact our solar access and limit our outdoor space use; we have several plants that would suffer due to lack of sunlight.

Here is a photo of the south side of our backyard, which would be completely blocked by this rear addition:



Here is a photo of the west view from the backyard (the end of the backyard). The rear addition would extend far beyond the depth of our backyard and also alter the solar access from this angle.



While we understand our neighbor's desire to expand their home and take advantage of the land available, we ask that you please consider the severe impact this rear addition would have on our home and backyard. As mentioned, this proposed two-story rear addition would extend beyond the depth of our backyard, impact our solar access, and ultimately affect our property valuation and the livelihood of our home.

We are open to reaching a compromise between our two parties and would be open to potentially an addition of <u>just the first floor</u> to the home. We believe this would allow an addition to the home without the negative impact on our home and property.

We ask that you please reconsider the current proposal for this project and take into account our concerns regarding this rear addition. We hope that our solution for a compromise is acceptable to both parties.

Sincerely,

Jeffrey and Jenny Yee

May 22, 2019

To Whom It May Concern:

We are the owners of 2015  $23^{rd}$  Avenue. It has come to our attention that our neighbor at 2019  $23^{rd}$  Avenue is moving ahead to build a rear addition to their home.


After examining the plans that were sent to us by the San Francisco Planning Department, we are writing to voice our concerns about this project. The two-story rear addition proposed would severely impact the solar access our home and backyard receives, and effectively cause devaluation in our property.

The depth of our backyard is approximately 17 feet. The proposed first floor addition would be 20 feet in depth, while the proposed second floor would be 17 feet. The entire south side of our backyard, which runs adjacent to this proposed addition, would be entirely blocked by this rear addition. Again, this would negatively impact our solar access and limit our outdoor space use; we have several plants that would suffer due to lack of sunlight.

Here is a photo of the south side of our backyard, which would be completely blocked by this rear addition:




Here is a photo of the west view from the backyard (the end of the backyard). The rear addition would extend far beyond the depth of our backyard and also alter the solar access from this angle.

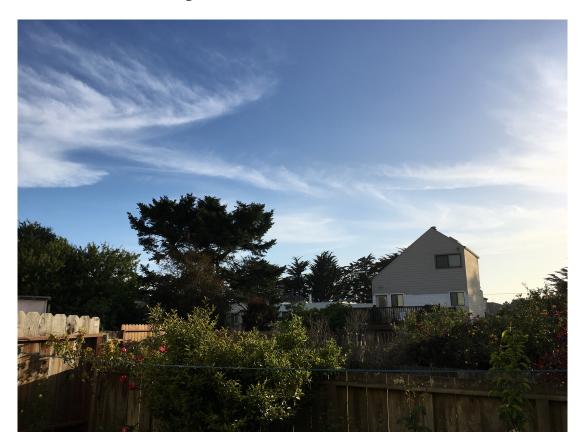


We ask the San Francisco Planning Department to please reconsider approval of this rear addition as it would severely impact the solar access, property valuation, and livelihood of our home.

Sincerely,

Jeffrey and Jenny Yee

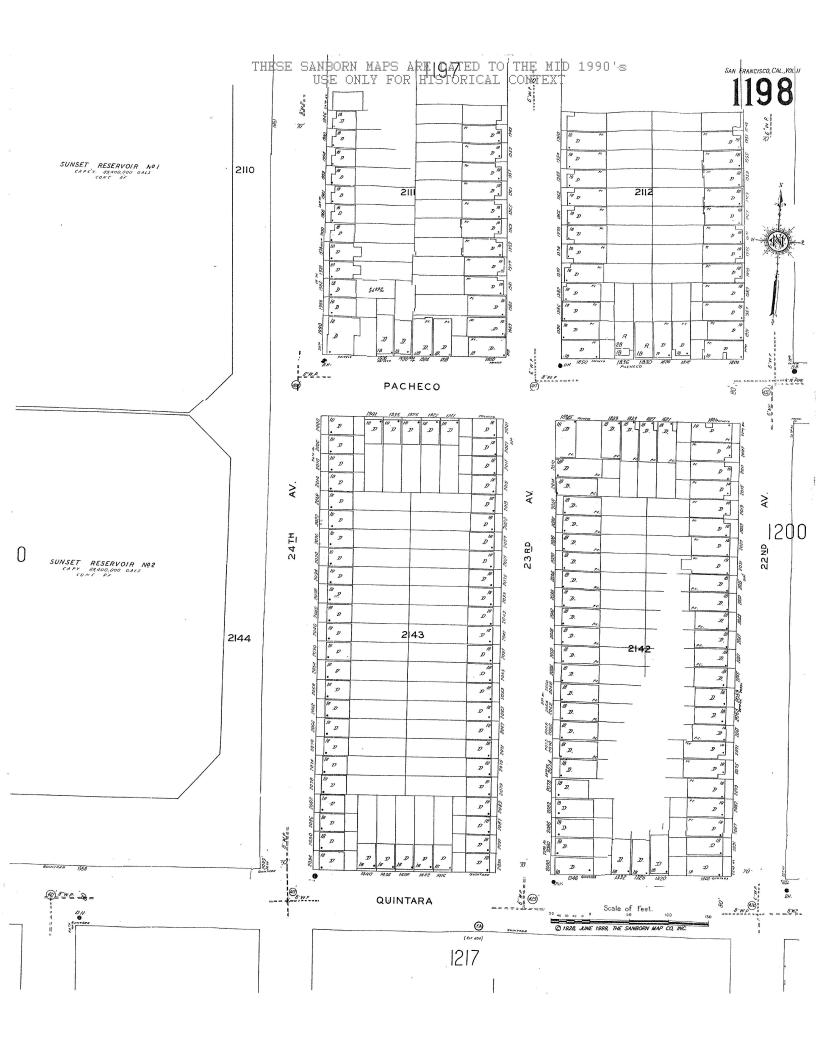

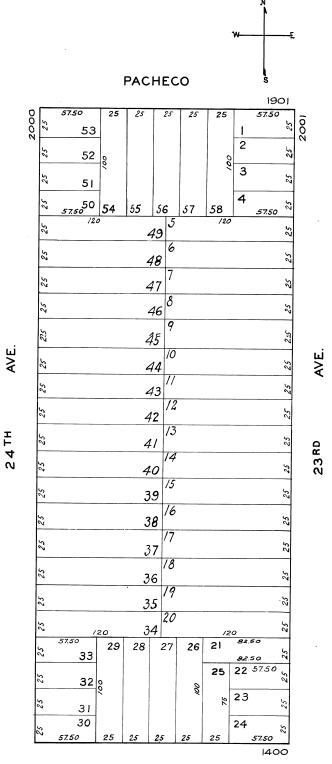

QUINTARA

# BRIEF SUBMITTED BY THE PERMIT HOLDER(S)

**Dung Family** 

Ricky Dung and Carolyn Zhen

2019 23rd Ave

San Francisco, CA 94116

April 16, 2021

Dear Board of Appeals,

The project on 2019 23<sup>rd</sup> Avenue started as a two story single family home with a two story rear yard addition 20 feet wide by 25 feet depth design by Andrew Kwok (Exhibit #1). Planning department staff made determinations to reduce the project: first floor 20 feet width and 20 feet length; and second floor to 15 feet width by 17 feet length with additional 5 feet by 5 feet at the side corner on north and south side (Exhibit #2). In May 2019 the 311 notification was sent out and an agreement was reached with the Yee Family to further reduce rear north side corner on the second floor by 5 feet by 5 feet (Exhibit #3).

After the design was approved by planning staff, Yuflux Engineering took over the project to complete the working drawings (Exhibit #4 based on Exhibit #2). Yuflux Engineering was not made aware of the 5 feet by 5 feet reduction agreement (Exhibit #3) and used the submitted 311 notification plans as a template (Exhibit #2). The working plans were approved with this error and the site permit was released (Exhibit

#4). The Yee Family filed a permit appeal pointing out the error (5 feet by 5 feet second floor corner not removed).

Since the board of appeals was filed the plans have been revised for accuracy and to encompass the agreement (Exhibit #5 & #6):

- 1) Removing the second floor 5'x5' addition
- 2) Revising the site plan to show north and south adjacent neighbors accurately, proper property lines and setbacks.


The revisions were reviewed by planning and building department staff for code compliance. The project has gone through countless review and it was determined after all the reductions that it drastically limits light impacts because the building windows are also facing east and west and the second floor is setback 5 feet from property line. We have added photos #1-#7 to illustrate shadow throughout the day and its limited impacts and reach due to building direction and geographic configuration. The shadow of the second floor with the 5 feet setback will not pass the shadow of the first floor shadow.

Design team and ownership is asking the board of appeals to accept and adopt the revised plans showing the corrections (Exhibit #6). This project appeal is not requesting a <u>Jurisdiction Request</u> because the City has not caused to be late in filing an appeal. A <u>Rehearing request</u> is not justified because no extraordinary facts or circumstances have arisen and the project is very similar to original previously agreed upon plans Exhibit #3 (original agreed concept) compared to Exhibit #6 (requested adoption plan set).


Photo took at 1pm on April 15th 2021 from backyard to the (photo#1)



Took at 1:34pm from our kitchen window to the north side of the house (photo#2)

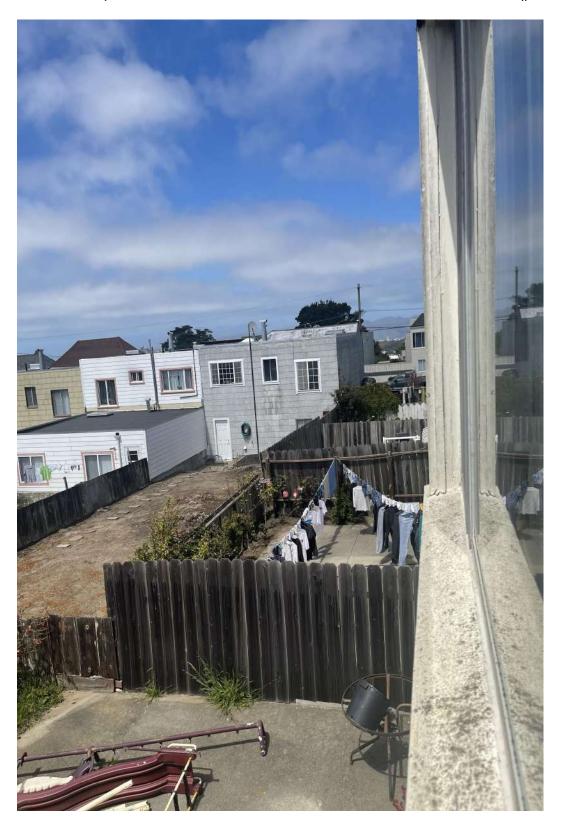


Took at 2:45pm from back yard to the house (photo#3)

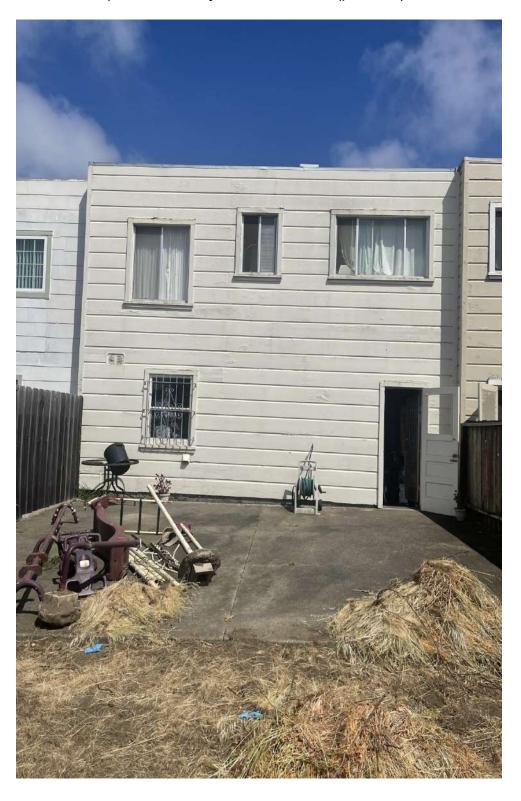


Took at 5:10pm from our house to the west side (photo#4)



5:11pm view from the back yard back to the house (photo#5)

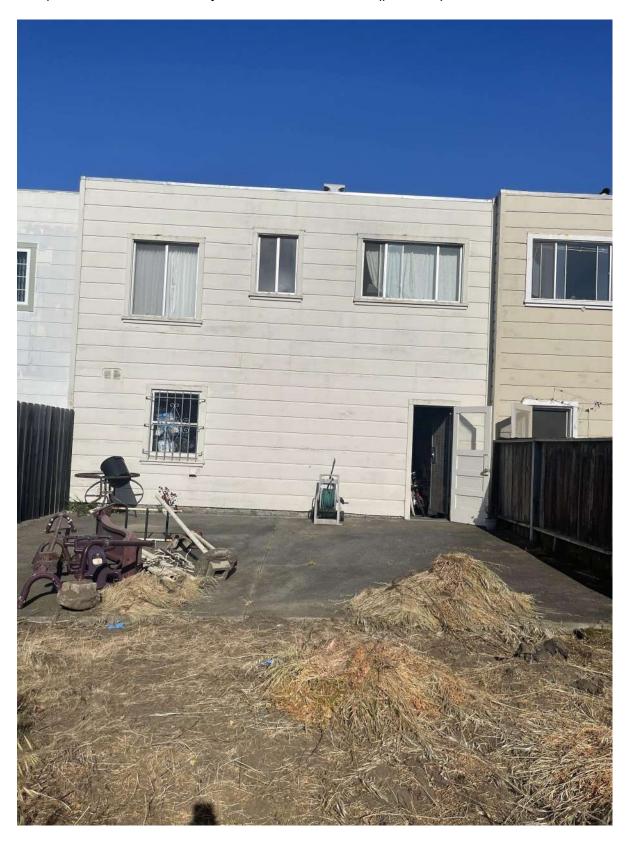

Took at 6:26pm from our kitchen window to the west side. You can clearly see the sun sets from our backyard. (photo#6)

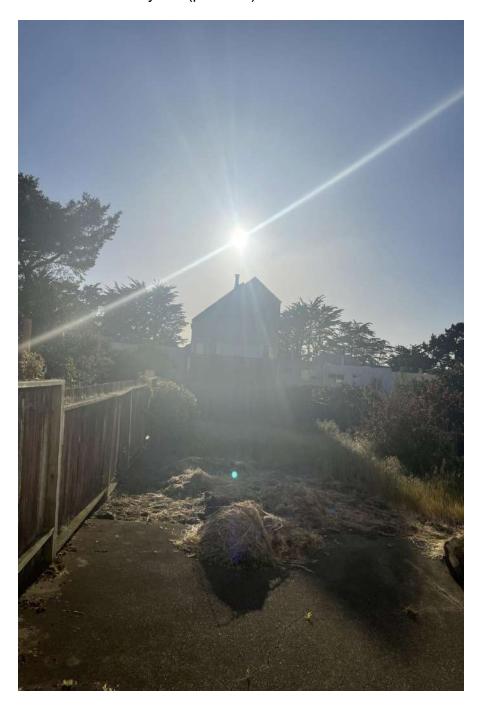

Took at 7:14pm (photo#7)



Since 2005 the single family home at 2019 23<sup>rd</sup> Avenue has been owner occupied. We are a growing family with kids fighting for their own rooms, crying for their own privacy space, fighting for taking turns to go to bathroom for the whole family; we have no choice but extend our living space while we have a long backyard. In addition to all these facts we want to provide for our 75 and 74 years old parents who are in a single room occupancy apartment on the 3rd floor sharing the public bathroom and kitchen in Chinatown. They have been on a list for senior housing for over 10 years and over 30 application rejections has been disheartening. The expansion will allow us to make this home a multigenerational living space. As a daughter, my heart is broken during this pandemic when they are stuck in that small area for more than a year but I can't do anything for them while we are still waiting for this project to be approved.


We are also the 1st generation immigrants. My husband started working since he was 15 to save money to afford the house we are living in and continue to work on 3 jobs a day to support the family and pay for our house, my husband only sleeps 2 hours for a long period of time when he worked for 3 jobs a day. Even now he still continues with his long working schedule daily and wakes up at 3:30 am every morning.

Since the Covid-19 pandemic, we postpone our project due to the unsafe conditions for our neighborhood and the people who are in the project; we have decided to continue our project late 2020 again as we felt it was safe enough.

The Yee family is requesting a unjustified amount of further reduction stating this project will do harm to them, while we are legally following city ordinance and going through long and expensive review process request. They however are having work done without permits. According to San Francisco city building permit records, only one


home improvement permits on file since 1995 correcting a violation for the glass sliding door and patio deck removal. Examples of current work without permit include but not limited to: all the windows in the house, side walk re- pavement, and recently repainted their house by 3rd party. Work without permits can be hazardous for the neighborhood and themselves without proper permit and city inspection.


The photo of 2015 23<sup>rd</sup> avenue showing: new paint and new windows. The new windows do not meet planning code standards (vinyl with fake dividers)

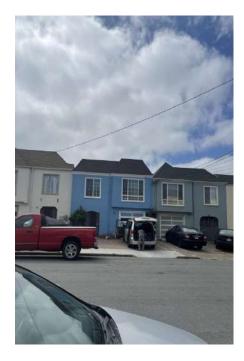

Recent sidewalk replacement without permit and front yard landscaping paved at some point without permit is already cracking causing potential tripping hazard.



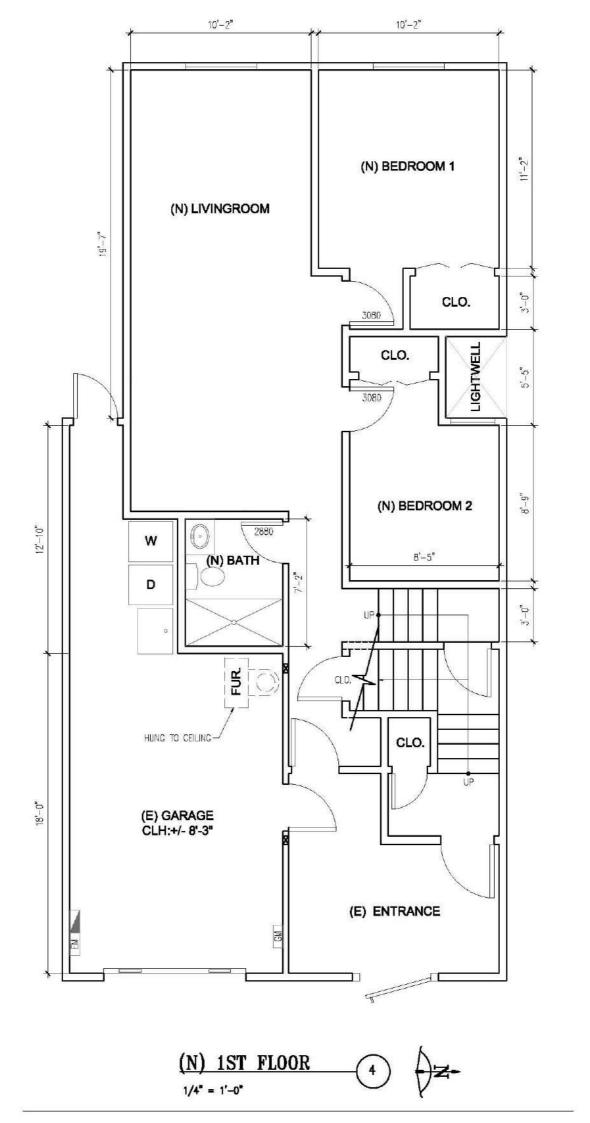

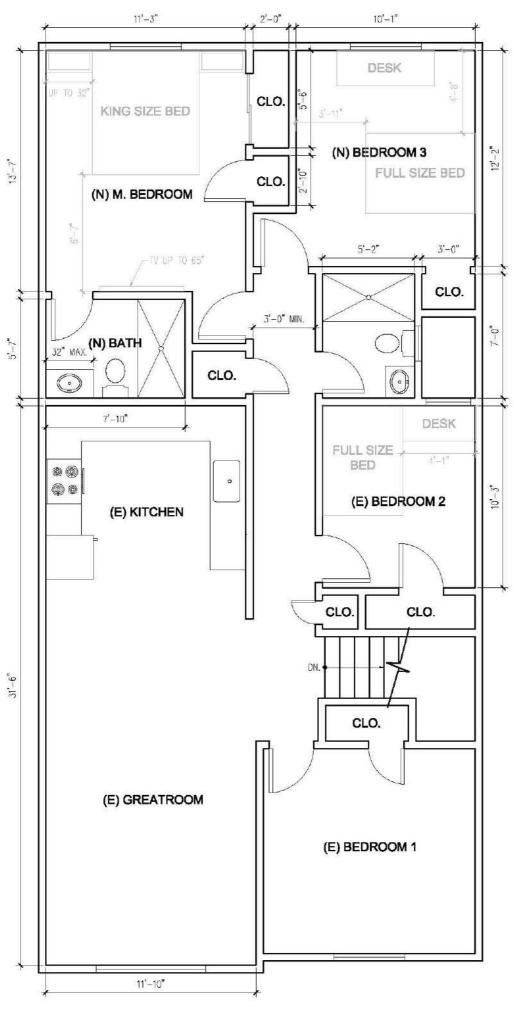





#### DRAWING INDEX

#### DRAWING INDEX:

GENERAL INFORMATION AND PLOT PLAN

SHEET A1.1 SHEET A2.0

FLOOR PLANS EXISTING ELEVATIONS EXISTING ELEVATIONS

SHEET A2.2 SHEET A2.3 PROPOSED ELEVATIONS

PROPOSED ELEVATIONS

SECTIONS PHOTOGRAPHS SHEET A4.0

#### PROJECT INFORMATION

#### BLOCK/LOT: 2143/005

CONSTRUCTION TYPE: NUMBER OF STORIES: OCCUPANCY GROUP: R-3 RH-1

ZONING: MAX. BUILDING HEIGHT: 40'-0" PROPOSED BUILDING HEIGHT:

EXISTING LIVING AREA:

753 SQF. ADDITION LIVING AREA: NEW TOTAL LIVING ARE:


#### SCOPE OF WORK


#### SCOPE OF WORK

HORIZONTAL ADDITION AT REAR OF EXISTING TWO STORIES RESIDENTIAL BUILDING, IN TOTAL

#### APPLICABLE CODES

CALIFORNIA BUILDING CODE 2016 (CBC) CALIFORNIA FIRE CODE 2016 (CFC) CALIFORNIA PLUMBING CODE 2016 (CPC) CALIFORNIA MECHANICAL CODE 2016 (CMC)
CALIFORNIA ELECTRICAL CODE 2016 (CEC) CALIFORNIA ENERGY CODE (CNC) 2016
CALIFORNIA RESIDENTIAL CODE 2016 (CRC)
CALIFORNIA GREEN BUILDING STANDARDS CODE 2016 CALIFORNIA HISTORICAL BUILDING CODE (CHBC) 2016 SAN FRANCISCO PLANNING CODE 2016 SAN FRANCISCO BUILDING CODE 2016 (SFBC) SAN FRANCISCO FIRE CODE 2016 (SFFC) SAN FRANCISCO PLUMBING CODE 2016 SAN FRANCISCO MECHANICAL CODE 2016 (SFMC) SAN FRANCISCO ELECTRICAL CODE 2016 (SFEC) SAN FRANCISCO ENERGY CODE 2016

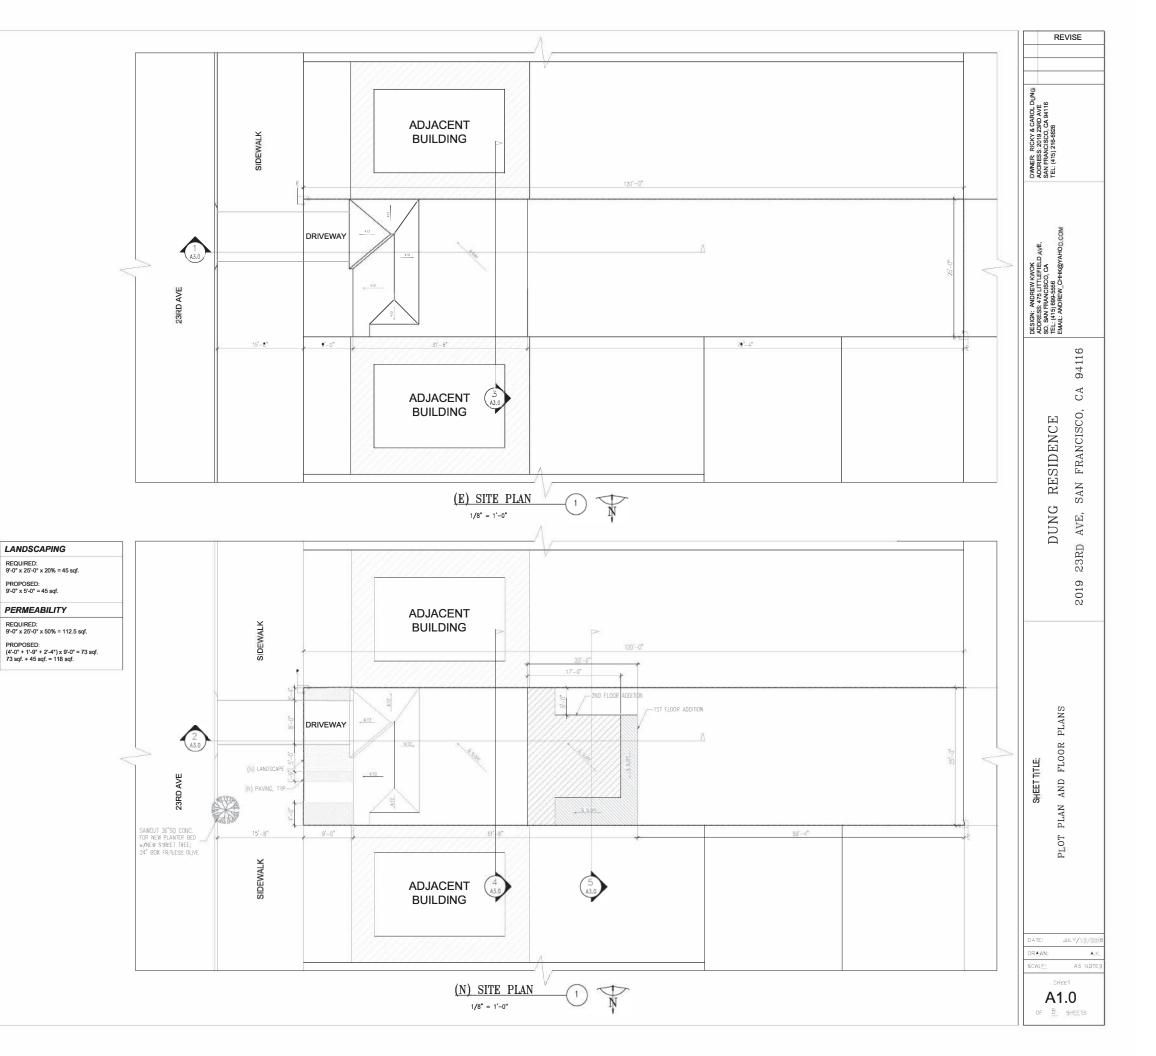


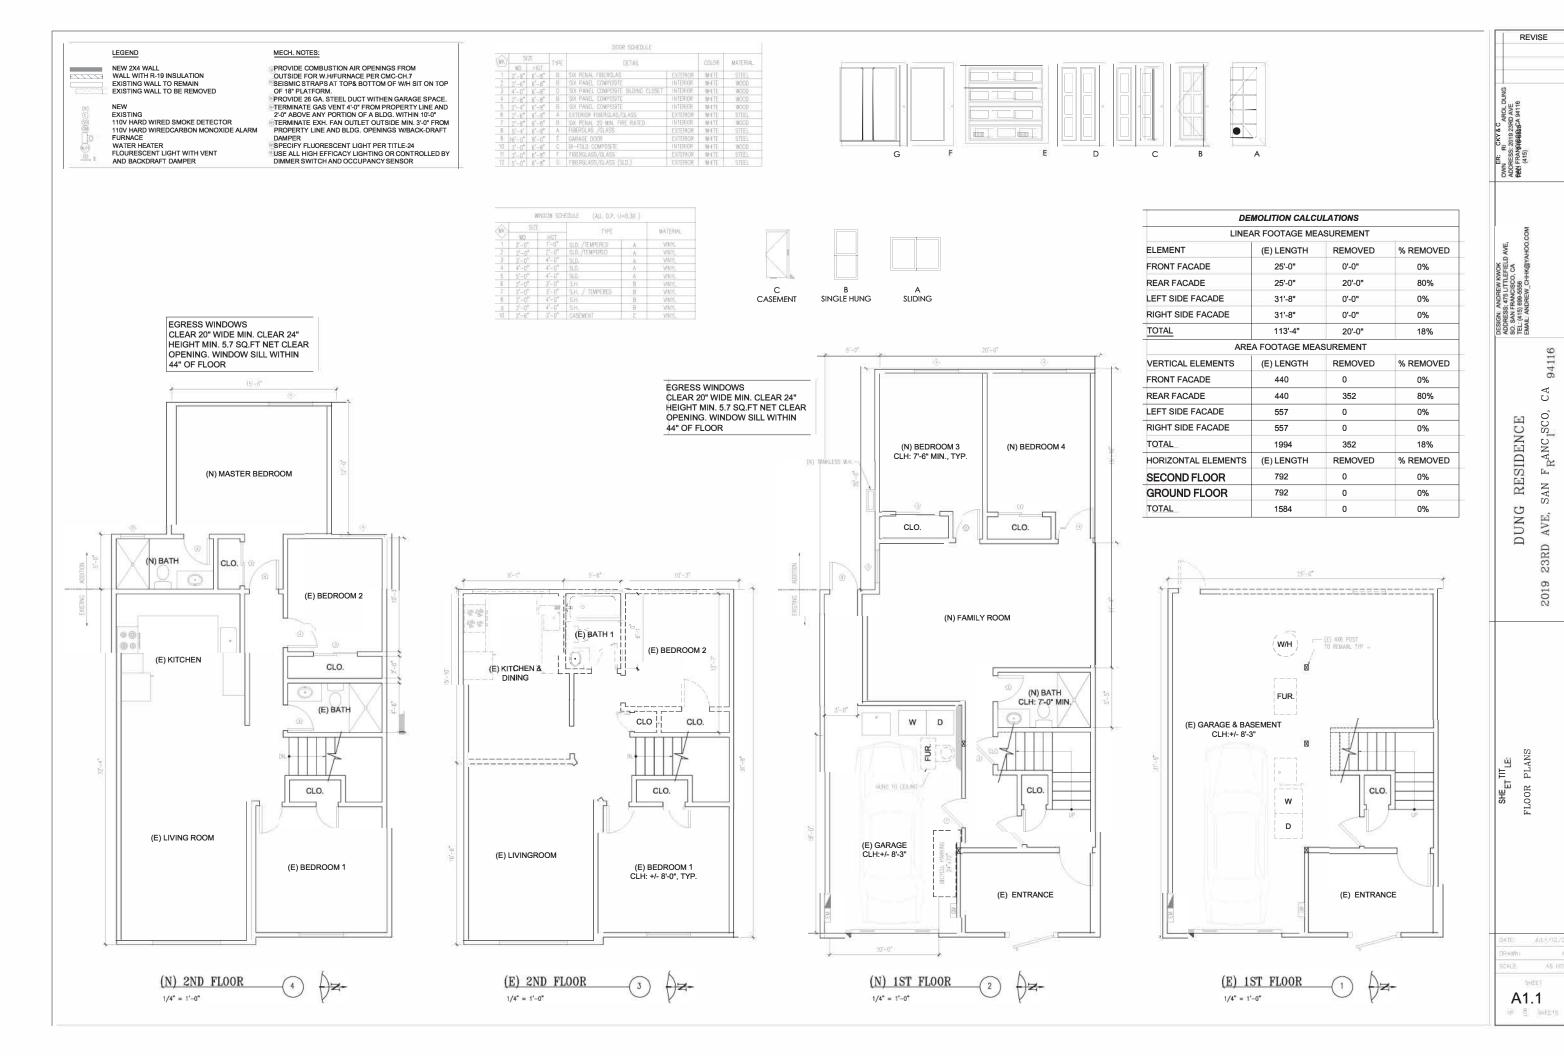



(E) FRONT ELEVATION (NO WORK)

1/4" = 1'-0"

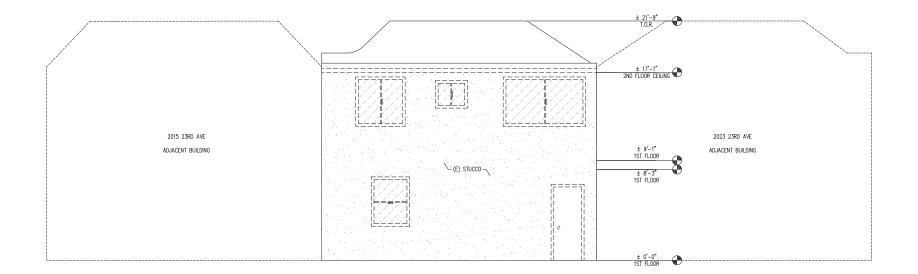


(E) REAR ELEVATION


1/4" = 1'-0"


| 7[  | T   | REVI   | SE                                     |
|-----|---|--|--|
|     |   |  |  |
|     | U   |  |  |
|     | OWNER: RICKY & CAROL DUNG<br>ADDRESS: 2019 23RD AVE | SAN FRANCISCO, CA 94116<br>TEL: (415) 216-6828                               |  |
|     | DESIGN: ANDREW KWOK ADDRESS: 475 LITTLEFIELD AVE,   | SO, SAN FRANCISCO, CA<br>TEL: (415) 699-6556<br>EMAIL: ANDREW_CHHK@YAHOO.COM |  |
|     |   | DUNG RESIDENCE   | 2019 23RD AVE, SAN FRANCISCO, CA 94116 |
|     | SHEET TITLE:  | EXISTING ELEVATION   |  |
| 1 7 |   |  |  |

SCALE: AS NOTED

**A2.0**of <u>8</u> SHEETS

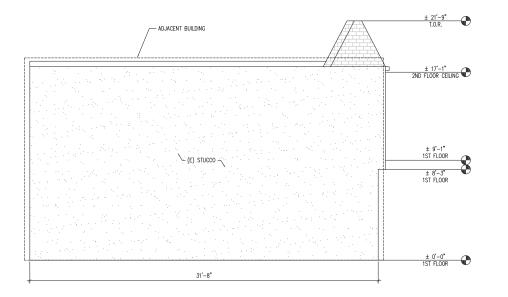

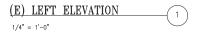

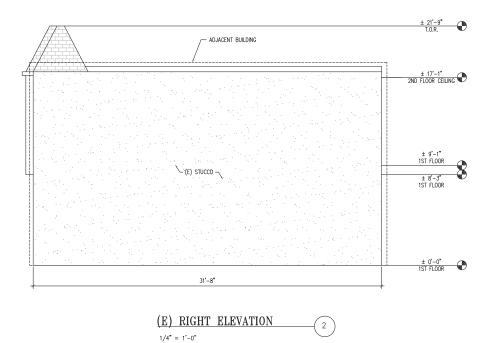

| DESIGNE, ANDREW KWOK DESIGNE, ANDREW KWOK ADDRESS, 278 LITTERELD AVE, SO. SHOWER, RICKY & CAROL DUNG ADDRESS, 278 280 DVR SO. SHOW THE MANGEO, CA SO. SHOW THE SHOW SO, CA TEL. (415) 216-9228 TEL. (415) 216- |
|--|
|  |
|  |
| 0 (0)  |
| W KWOK<br>TILEFIELD AVE,<br>SGO., CA<br>GG<br>CHHK@YAHOO,COM   |
| DESIGN: ANDREW KWOK<br>ADDRESS, 475 LITTEFELD<br>SO, SAN FRANCISCO, CA<br>TEL: (415) 699-6566<br>EMAIL: ANDREW_CHHK@YA   |
| DUNG RESIDENCE<br>2019 23RD AVE, SAN FRANCISCO, CA 94116   |
| SHEET TITLE:<br>NG ELEVATION   |
| SHEE   |
| DATE: JULY/12/201 DRAWN: A.K SCALE: AS NOTE!   |
| DATE: JULY/12/201 DRAWN: A.K.  |

**A2.1**of <u>8</u> SHEETS



(N) FRONT ELEVATION (NO WORK)

1/4" = 1'-0"




(N) REAR ELEVATION

1/4" = 1'-0"

|  | REVI  | SE                                     |
|--|---|--|
|  |   |  |
| OWNER: RICKY & CAROL DUNG<br>ADDRESS: 2019 23RD AVE  | TEL: (415) 216-6828                               |  |
| DESIGN: ANDREW KWOK<br>ADDRESS: 475 LITTLEFIELD AVE, | TEL: (415) 699-5556  EMAIL: ANDREW_CHHK@YAHOO.COM |  |
|  | DUNG RESIDENCE                                    | 2019 23RD AVE, SAN FRANCISCO, CA 94116 |
| SHEET TITLE:   | PROPOSED ELEVATION                                |  |
| DATE:  |   | LY/12/2018<br>A.K.                     |
| SCALE:   |   | AS NOTED                               |


A2.2

OF <u>8</u> SHEETS

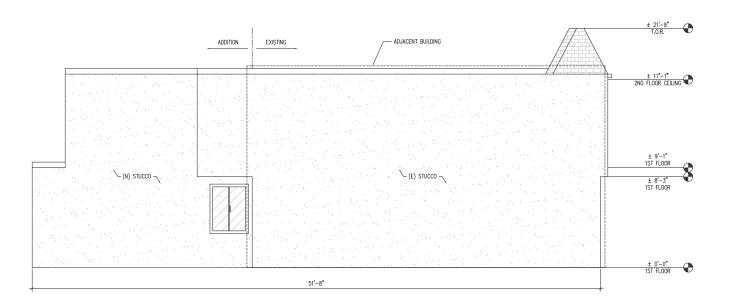


(N) LEFT ELEVATION

1/4" = 1'-0"

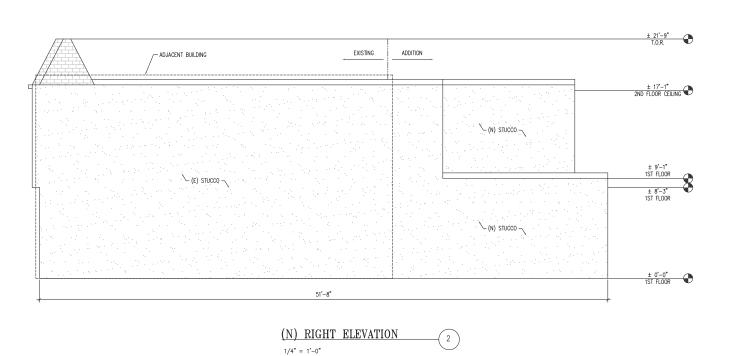

| REVISE   |
|--|
| OWNER RICKY & CAROL DUNG<br>ADDRESS 2019 23RD AVE<br>SAN FRANCISCO. C. 94116<br>TEL: (415) 216-4828                              |
| DESIGN. ANDREW KWOK<br>ADDRESS, AZE UTILERED AVE.<br>SO, SAN FRANCISCO, CA<br>TEL: (415) 898-5566<br>EMAIL: ANDREW_CHK@YAHOO,COM |
| DUNG RESIDENCE<br>2019 23RD AVE, SAN FRANCISCO, CA 94116   |
| SHEET TILE: PROPOSED ELEVATION   |
| DATE: JULY/12/201 DRAWN: A.K SCALE: AS NOTE  |
| A2.3   |

OF <u>8</u> SHEETS

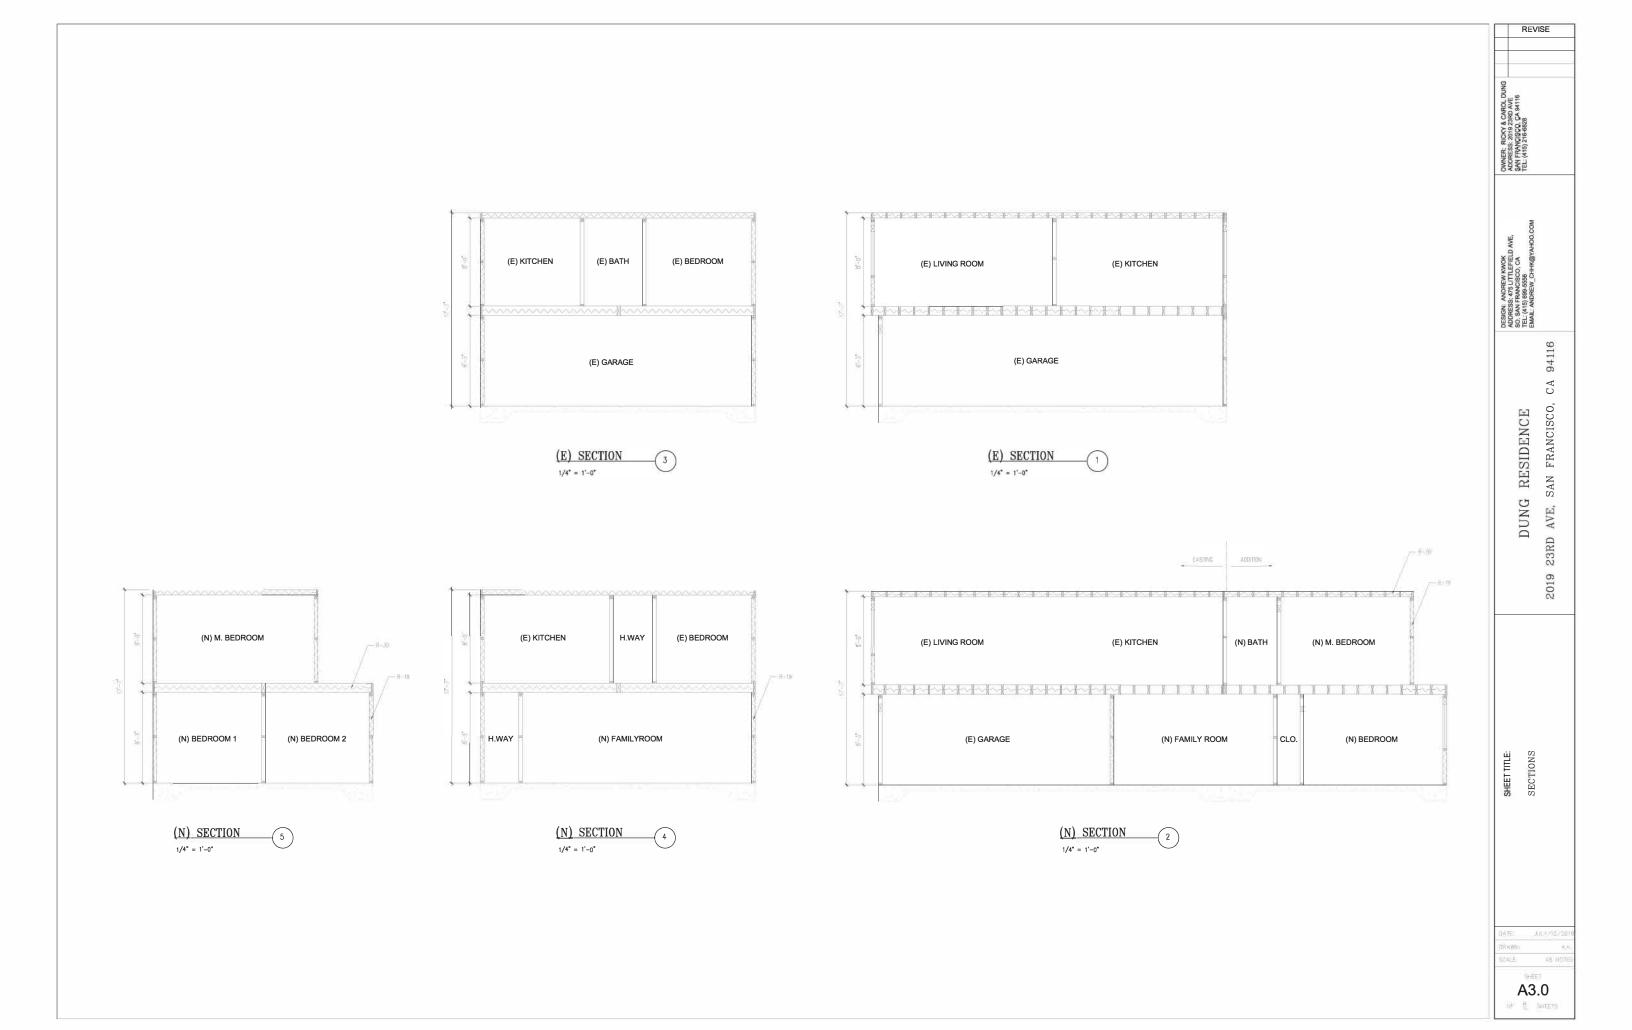

# DRAWING INDEX

#### **DRAWING INDEX:**

SHEET A1.0 GENERAL INFORMATION AND PLOT PLAN

SHEET A1.1 FLOOR PLANS

SHEET A2.0 EXISTING ELEVATIONS
SHEET A2.1 EXISTING ELEVATIONS
SHEET A2.2 PROPOSED ELEVATIONS

SHEET A2.3 PROPOSED ELEVATIONS SHEET A3.0 SECTIONS

SHEET A3.0 SECTIONS
SHEET A4.0 PHOTOGRAPHS

# PROJECT INFORMATION

### BLOCK/LOT: 2143/005

CONSTRUCTION TYPE: VB
NUMBER OF STORIES: 2
OCCUPANCY GROUP: R-3
ZONING: RH-1
MAX. BUILDING HEIGHT: 40'-0"
PROPOSED BUILDING HEIGHT: 21'-9" +/-

EXISTING LIVING AREA: 753 SQF.

ADDITION LIVING AREA: 1,045 SQF.

NEW TOTAL LIVING ARE: 1,798 SQF.


# SCOPE OF WORK


#### SCOPE OF WORK

HORIZONTAL & VERTICAL ADDITION AT REAR OF EXISTING TWO STORIES RESIDENTIAL BUILDING, IN TOTAL OF 1,045 SQF.

## APPLICABLE CODES

CALIFORNIA BUILDING CODE 2016 (CBC) CALIFORNIA FIRE CODE 2016 (CFC) CALIFORNIA PLUMBING CODE 2016 (CPC) CALIFORNIA MECHANICAL CODE 2016 (CMC) CALIFORNIA ELECTRICAL CODE 2016 (CEC) CALIFORNIA ENERGY CODE (CNC) 2016 CALIFORNIA RESIDENTIAL CODE 2016 (CRC) CALIFORNIA GREEN BUILDING STANDARDS CODE 2016 CALIFORNIA HISTORICAL BUILDING CODE (CHBC) 2016 SAN FRANCISCO PLANNING CODE 2016 SAN FRANCISCO BUILDING CODE 2016 (SFBC) SAN FRANCISCO FIRE CODE 2016 (SFFC) SAN FRANCISCO PLUMBING CODE 2016 SAN FRANCISCO MECHANICAL CODE 2016 (SFMC) SAN FRANCISCO ELECTRICAL CODE 2016 (SFEC) SAN FRANCISCO ENERGY CODE 2016

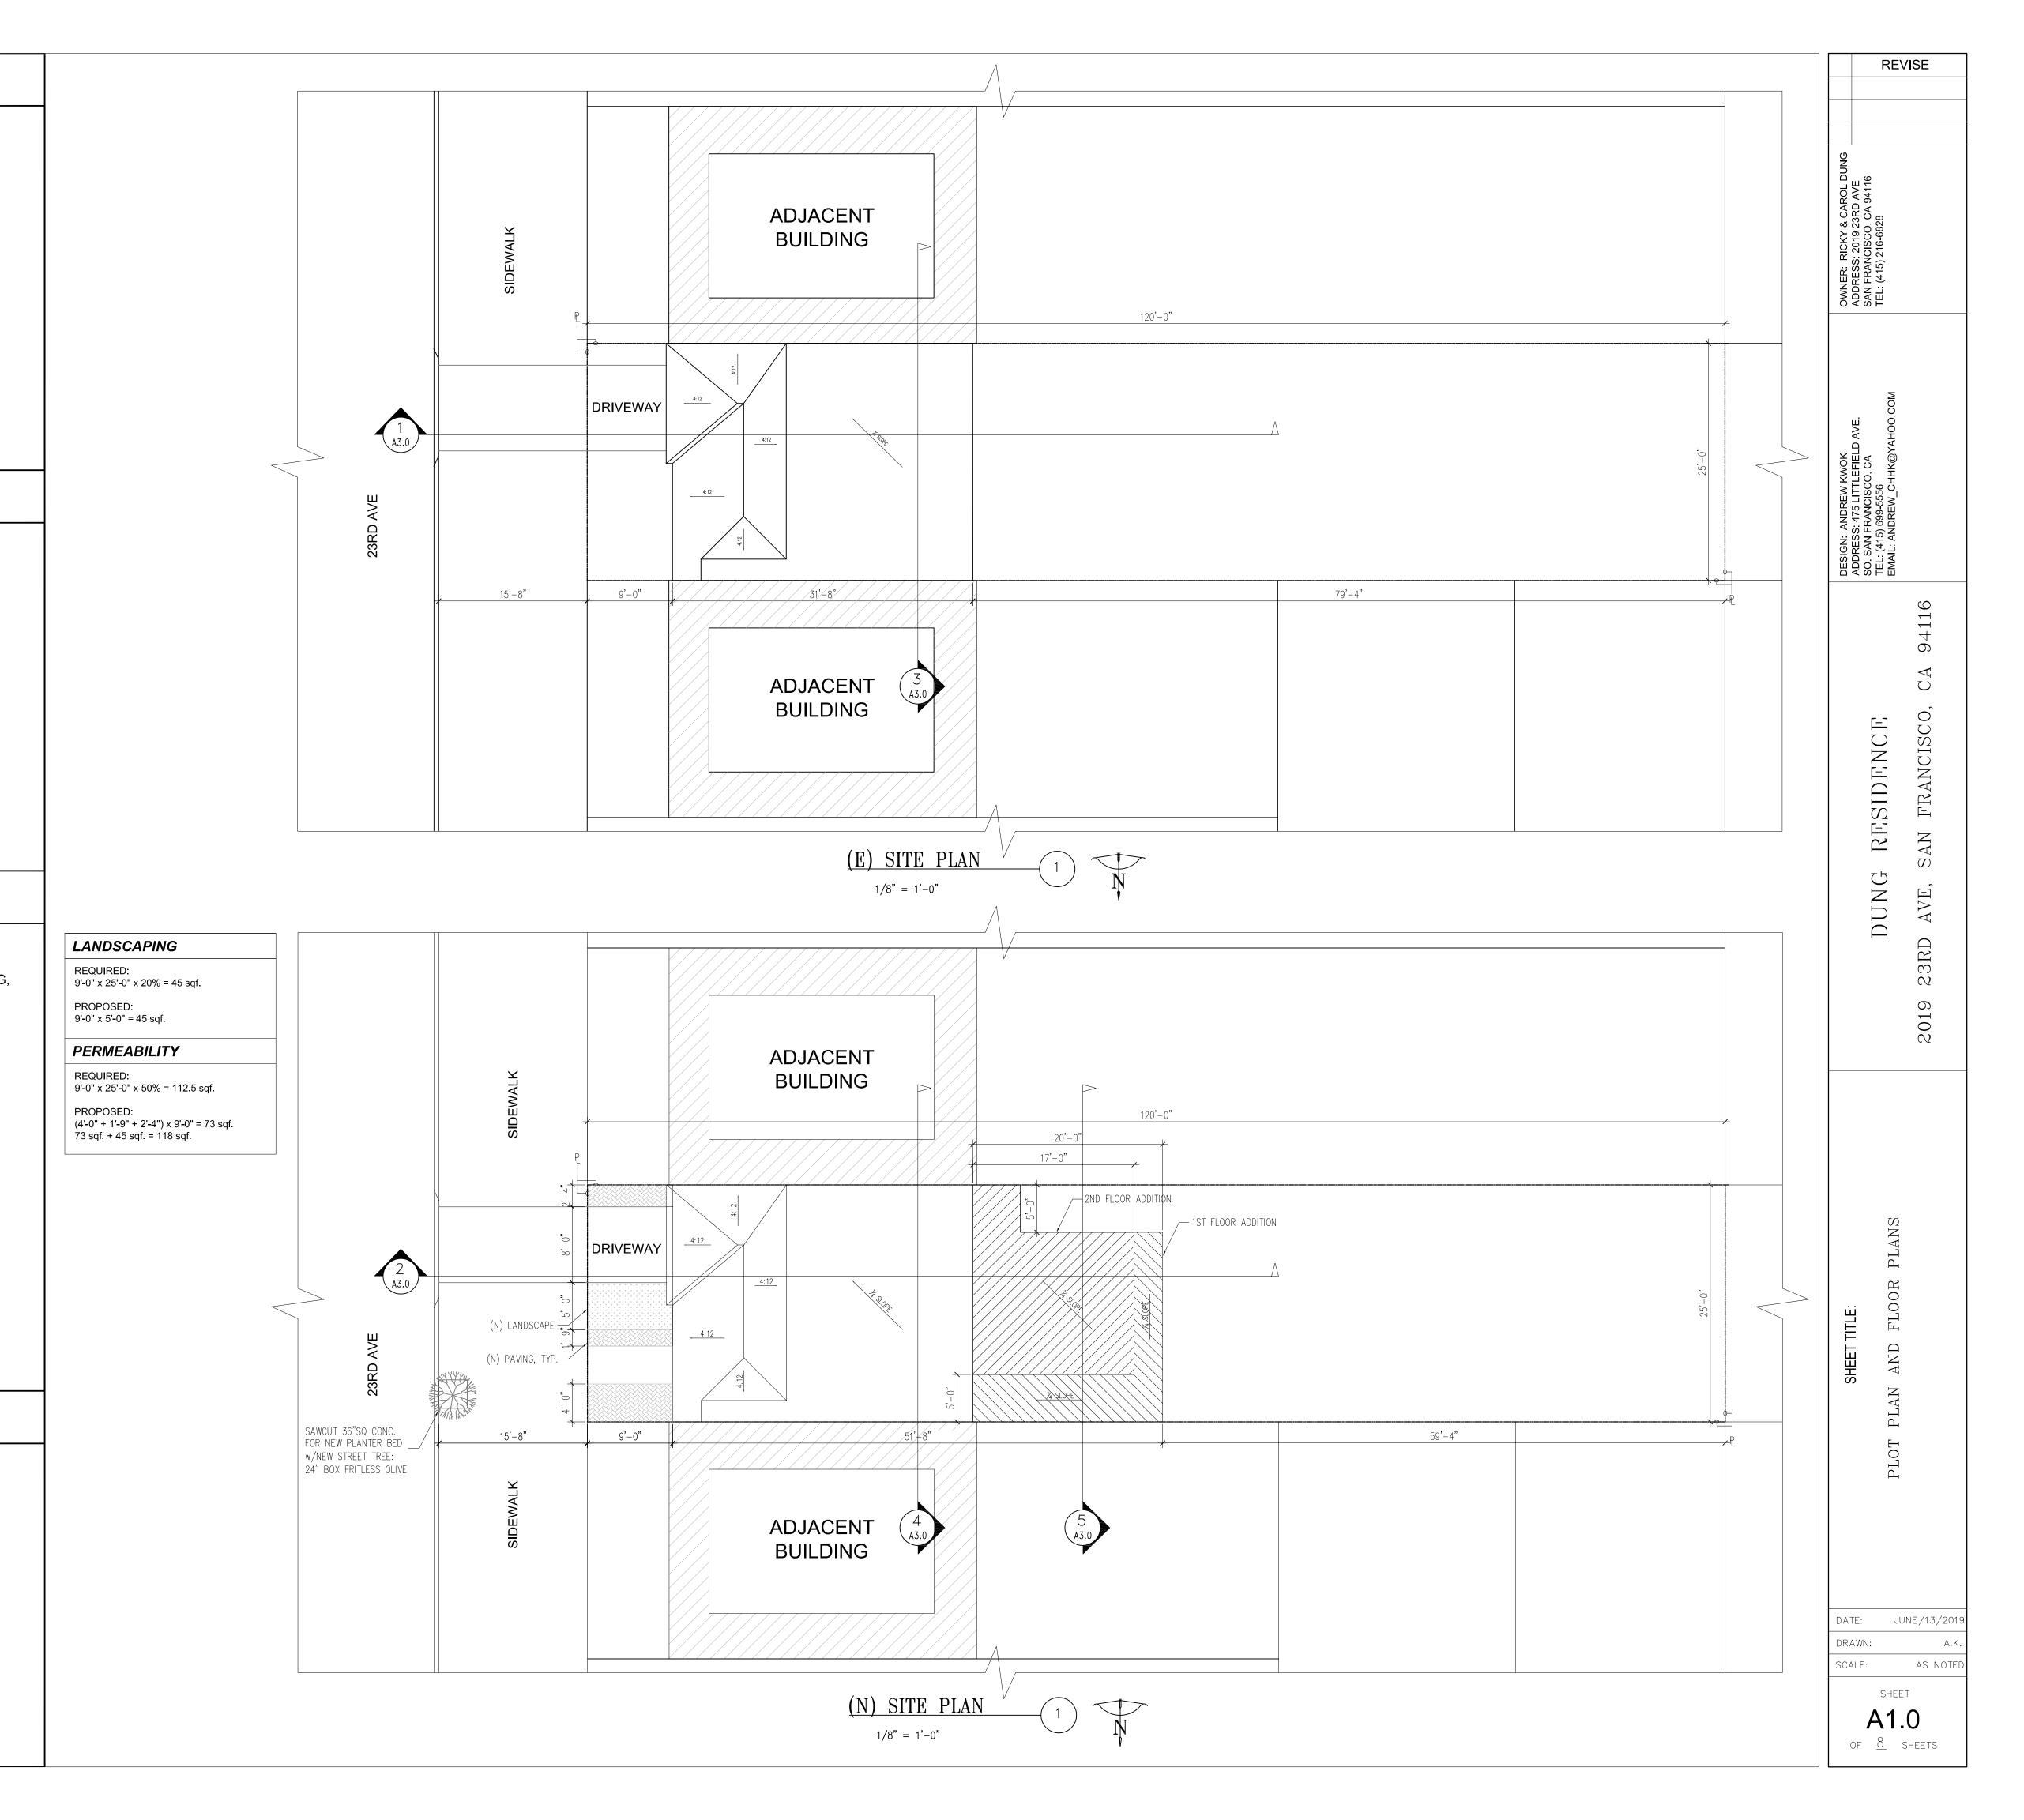

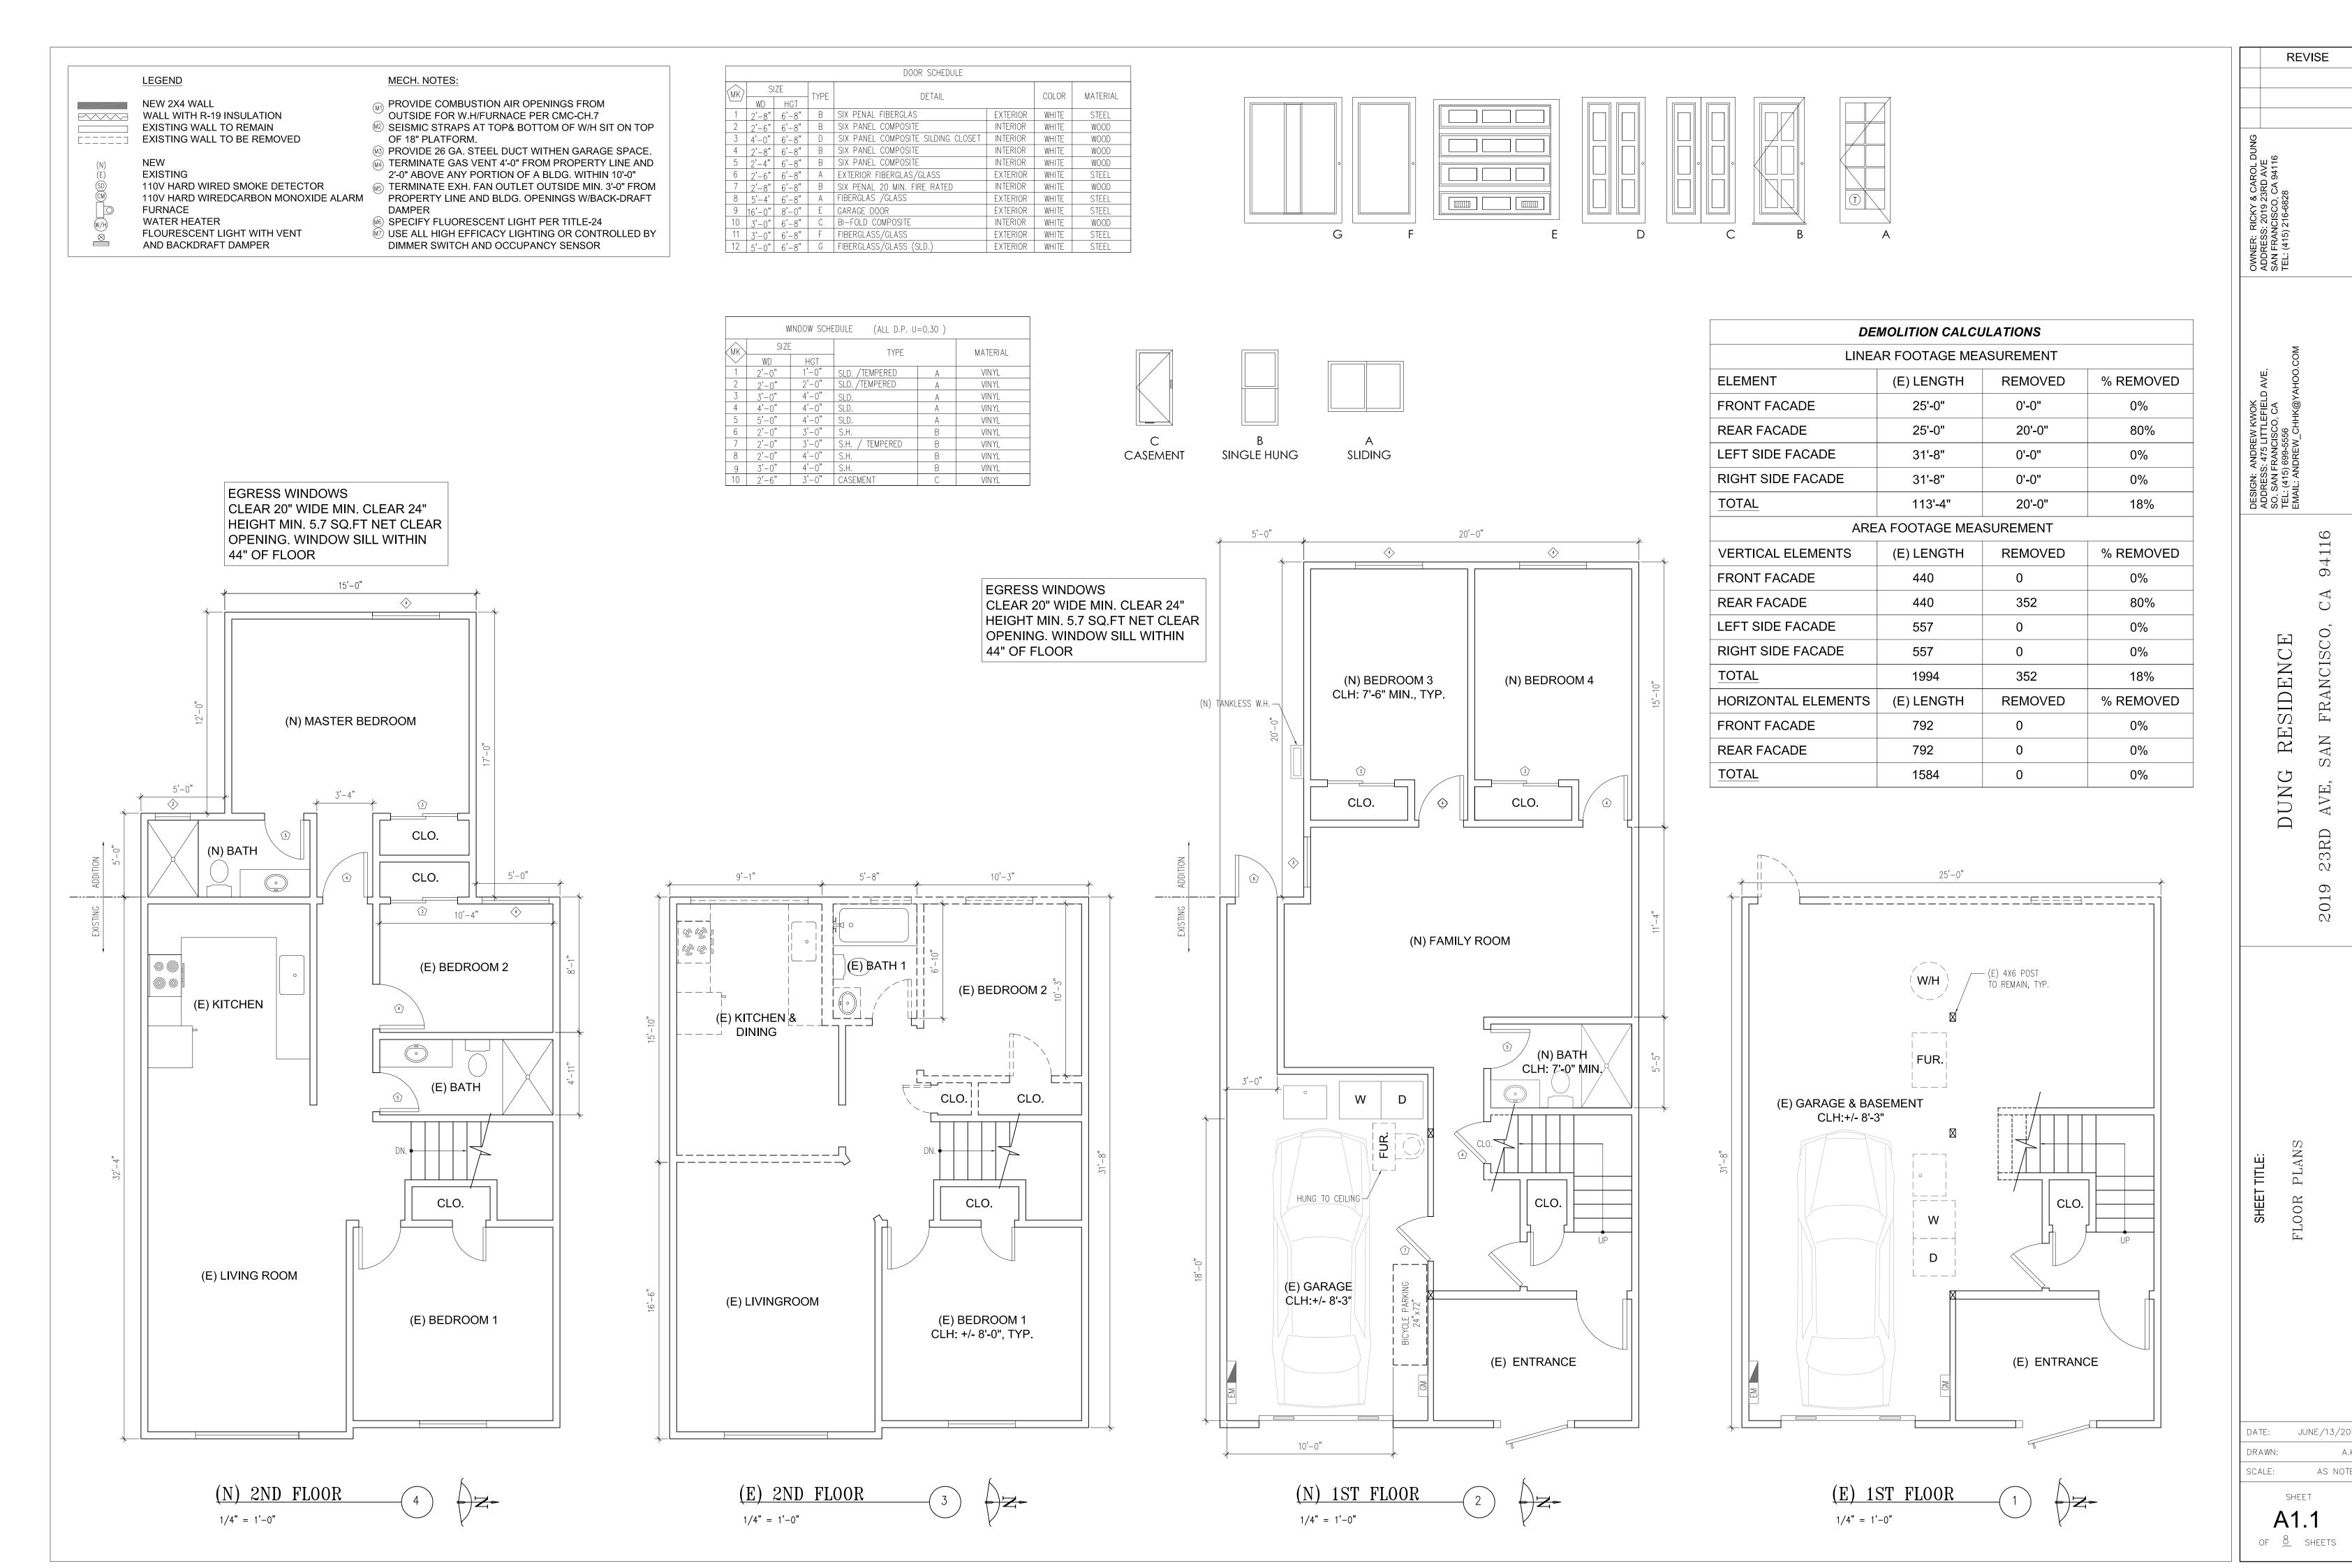

0

FRANCISCO

23R


2019

AS NOTE



(E) FRONT ELEVATION (NO WORK)

1/4" = 1'-0"

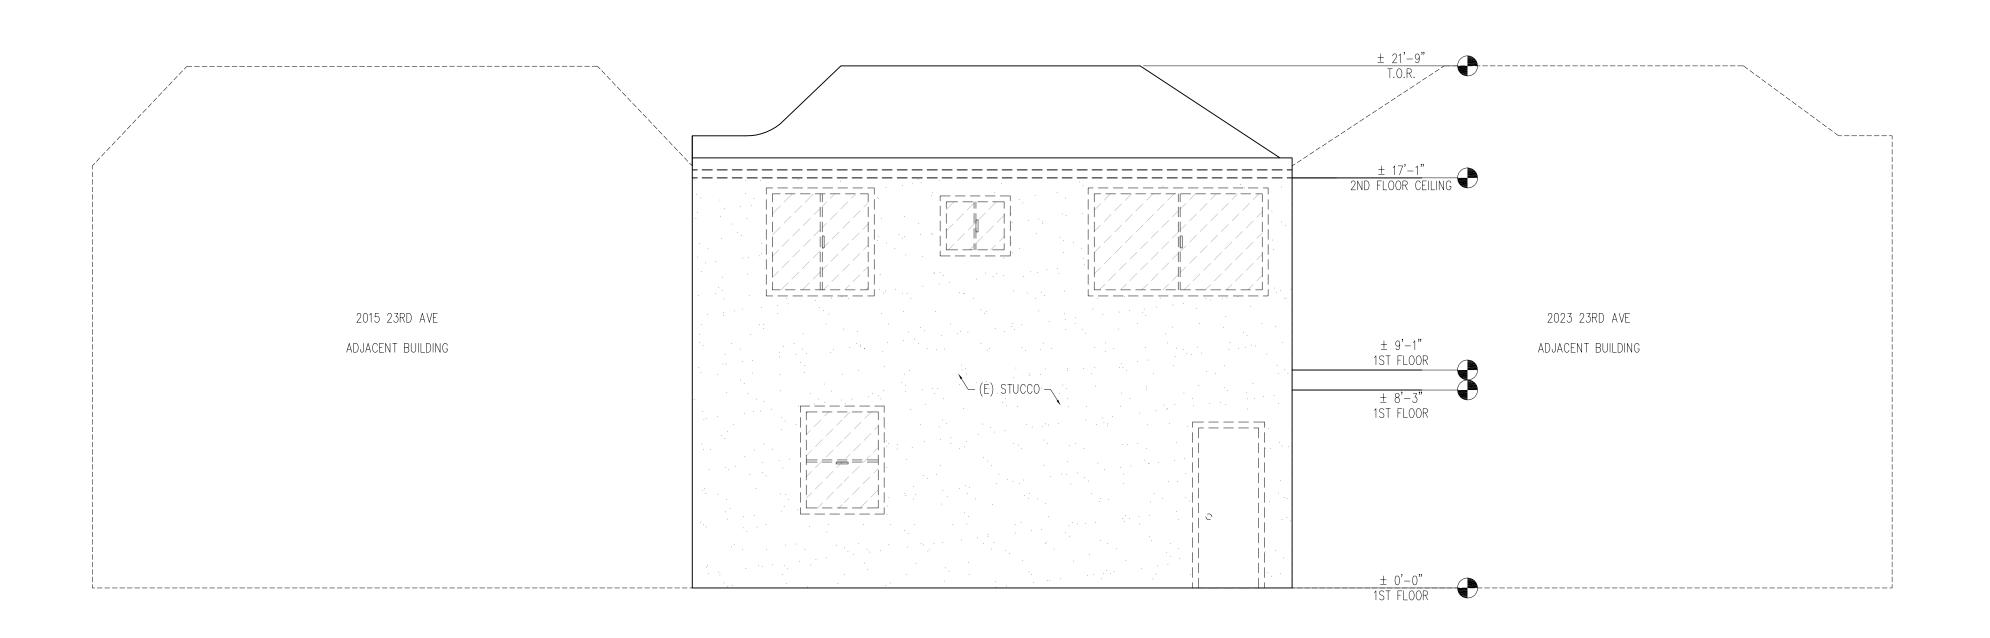

(E) REAR ELEVATION

1/4" = 1'-0"

FRANCISCO, RESIDENCE SAN DUNG AVE, 23R] 2019


REVISE

DATE: JUNE/13/2019


DRAWN: A.K.

SCALE: AS NOTED

SHEET A2.0 of 8 sheets

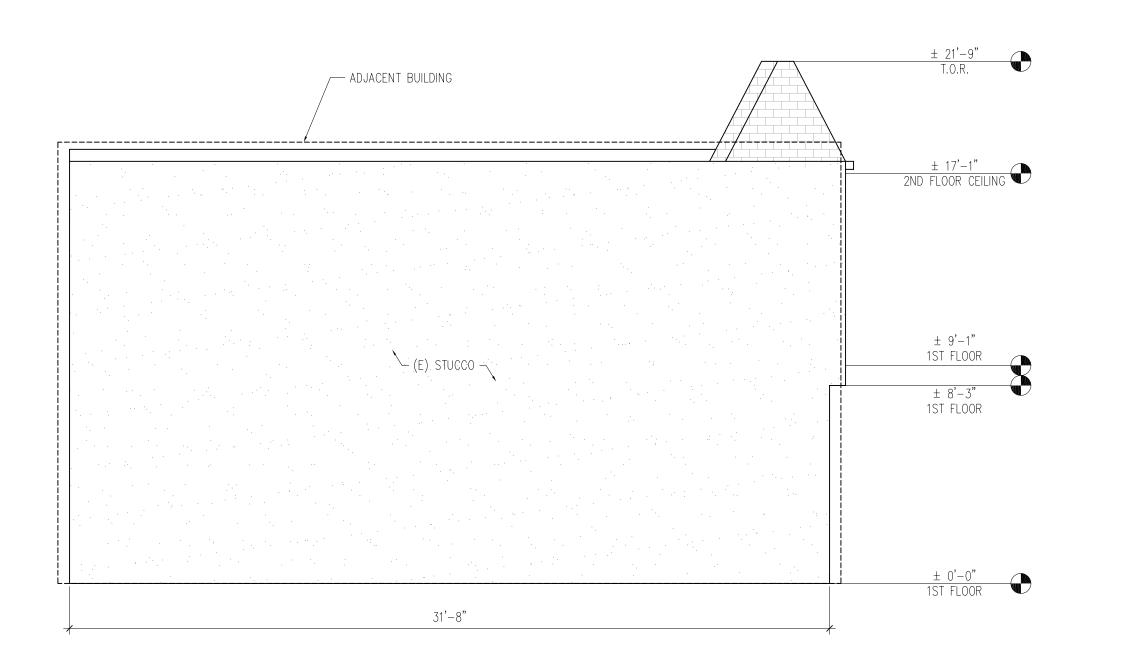



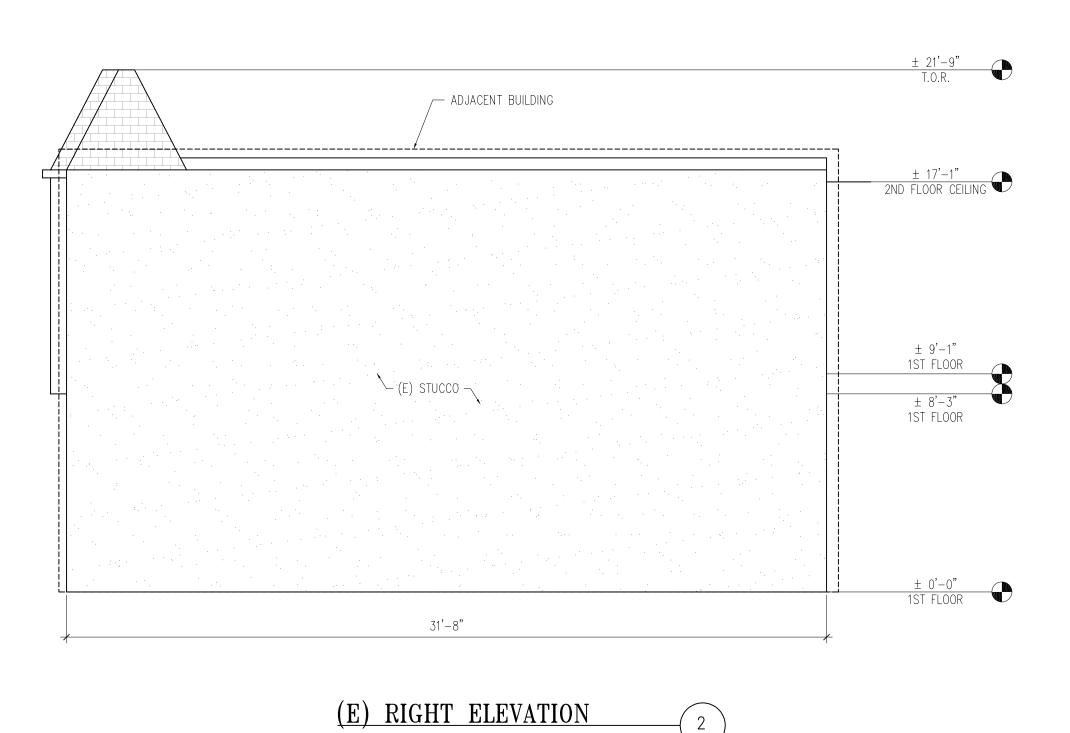

1/4" = 1'-0"

REVISE SAN FRANCISCO, RESIDENCE 23RD 2019

DATE: JUNE/13/2019

DRAWN: A.K.

SCALE: AS NOTED


SHEET

SHEET A2.1 of 8 sheets



(N) FRONT ELEVATION (NO WORK)

1/4" = 1'-0"

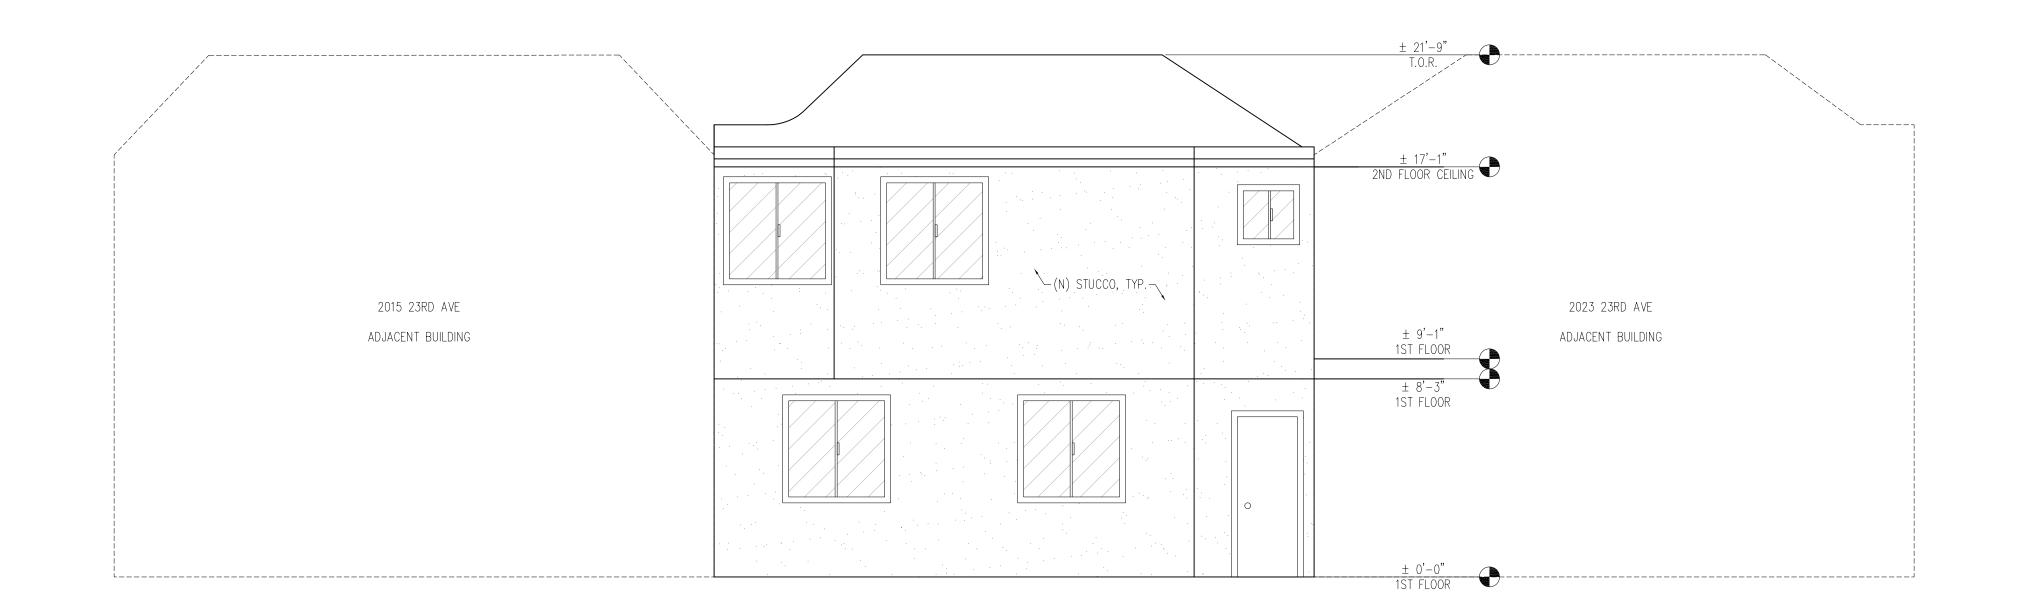

(N) REAR ELEVATION 1/4" = 1'-0"

DRESS: 2019 23RD AVE
N FRANCISCO, CA 94116
.: (415) 216-6828
.. (415) 216-6828
.. (415) 216-6828
.. (415) 216-6828

DESIGN: ANDREW KWOK ADDRESS: 475 LITTLEFIELD AVE, SO. SAN FRANCISCO, CA TEL: (415) 699-5556 EMAIL: ANDREW\_CHHK@YAHOO.COM

> DUNG RESIDENCE 23RD AVE, SAN FRANCISCO, CA

> > 2019

SHEET TITLE:
PROPOSED ELEVATION


DATE: JUNE/13/2019
DRAWN: A.K.

AS NOTED


SHEET **A2.2** 

SCALE:

A2.2 of 8 sheets

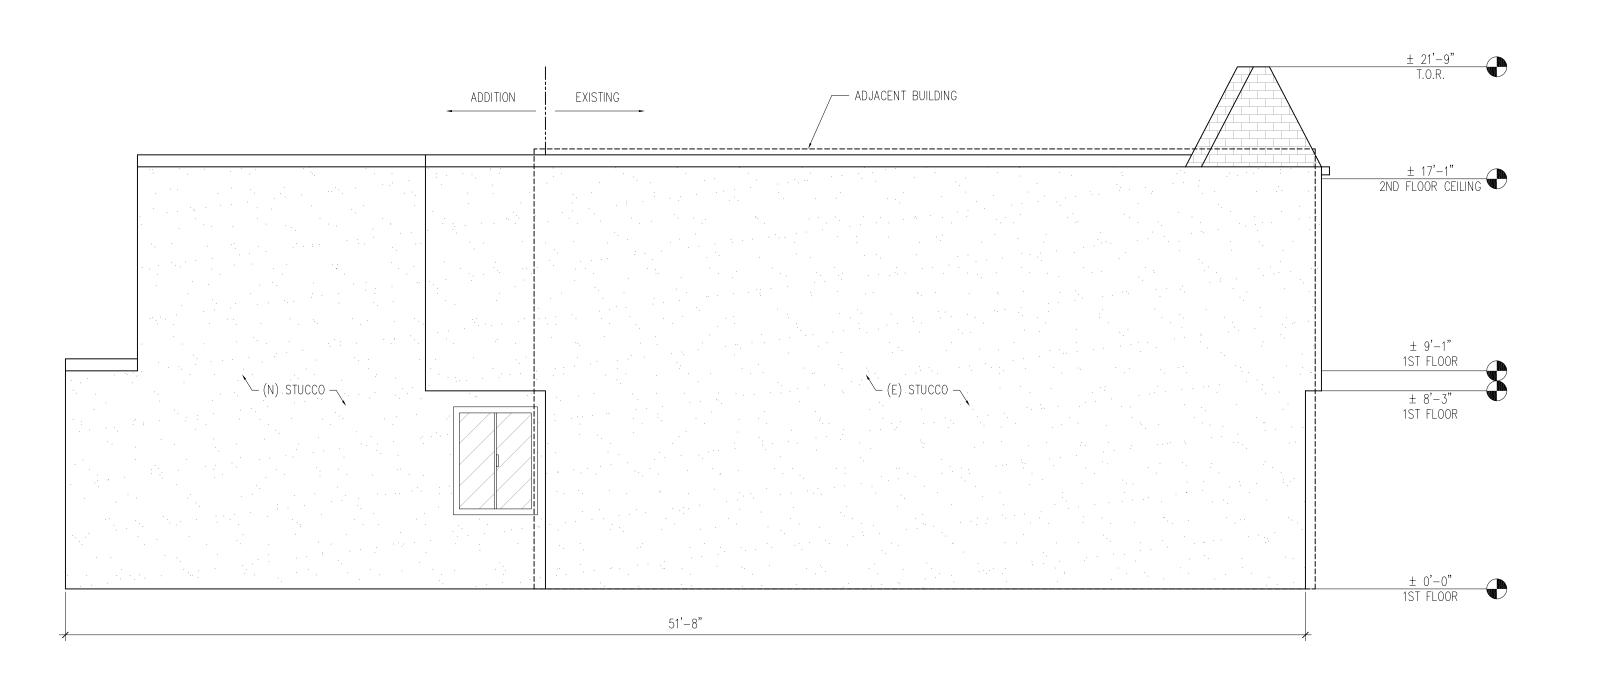

 $\frac{\text{(N) LEFT ELEVATION}}{1/4" = 1'-0"}$ 

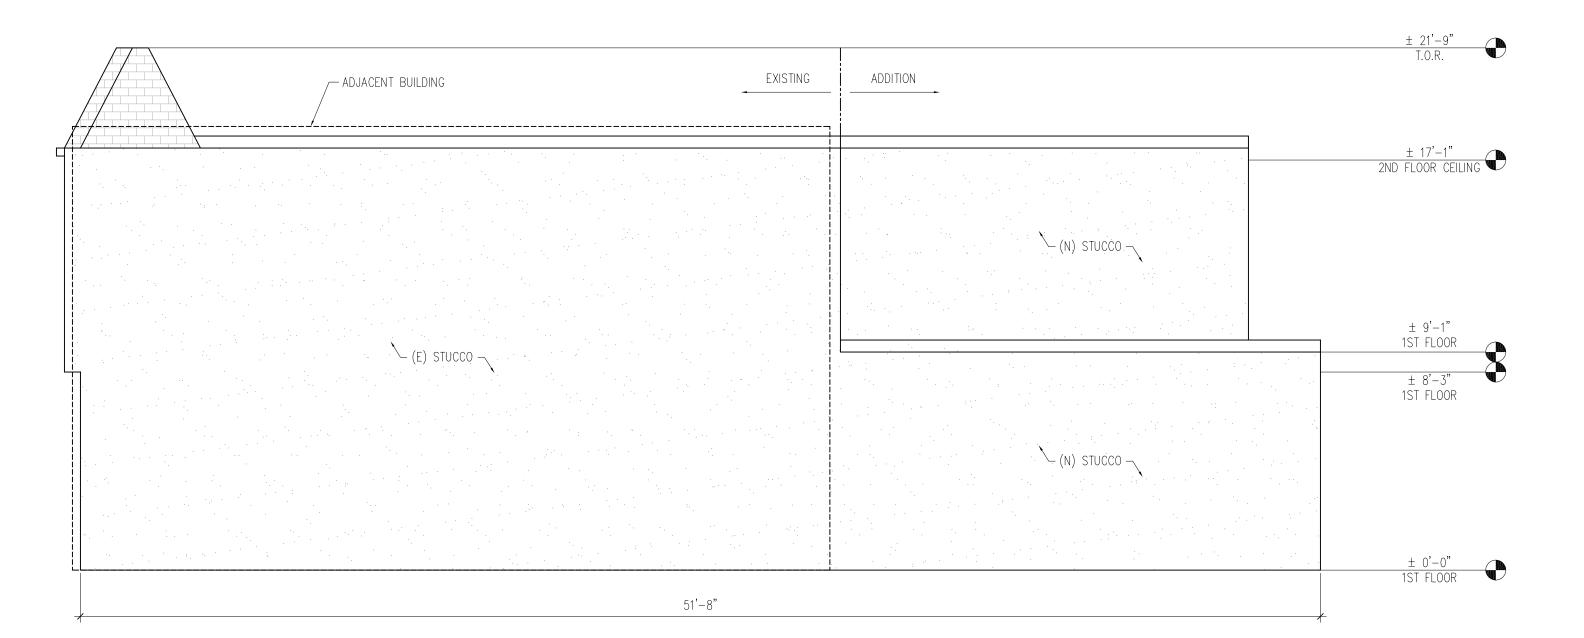

(N) RIGHT ELEVATION 1/4" = 1'-0"

5S: 2019 23RD AVE ANCISCO, CA 94116 5) 216-6828

OWNER: RICKY & CAROL ADDRESS: 2019 23RD AVE SAN FRANCISCO, CA 9411 TEL: (415) 216-6828

DESIGN: ANDREW KWOK ADDRESS: 475 LITTLEFIELD AVE, SO. SAN FRANCISCO, CA TEL: (415) 699-5556 EMAIL: ANDREW\_CHHK@YAHOO.COM

> G RESIDENCE SAN FRANCISCO, CA 9411


DUNG R 2019 23RD AVE, SAN

SHEET TITLE: PROPOSED ELEVATION

DATE: JUNE/13/2019
DRAWN: A.K.

DRAWN: A.K.

SCALE: AS NOTED

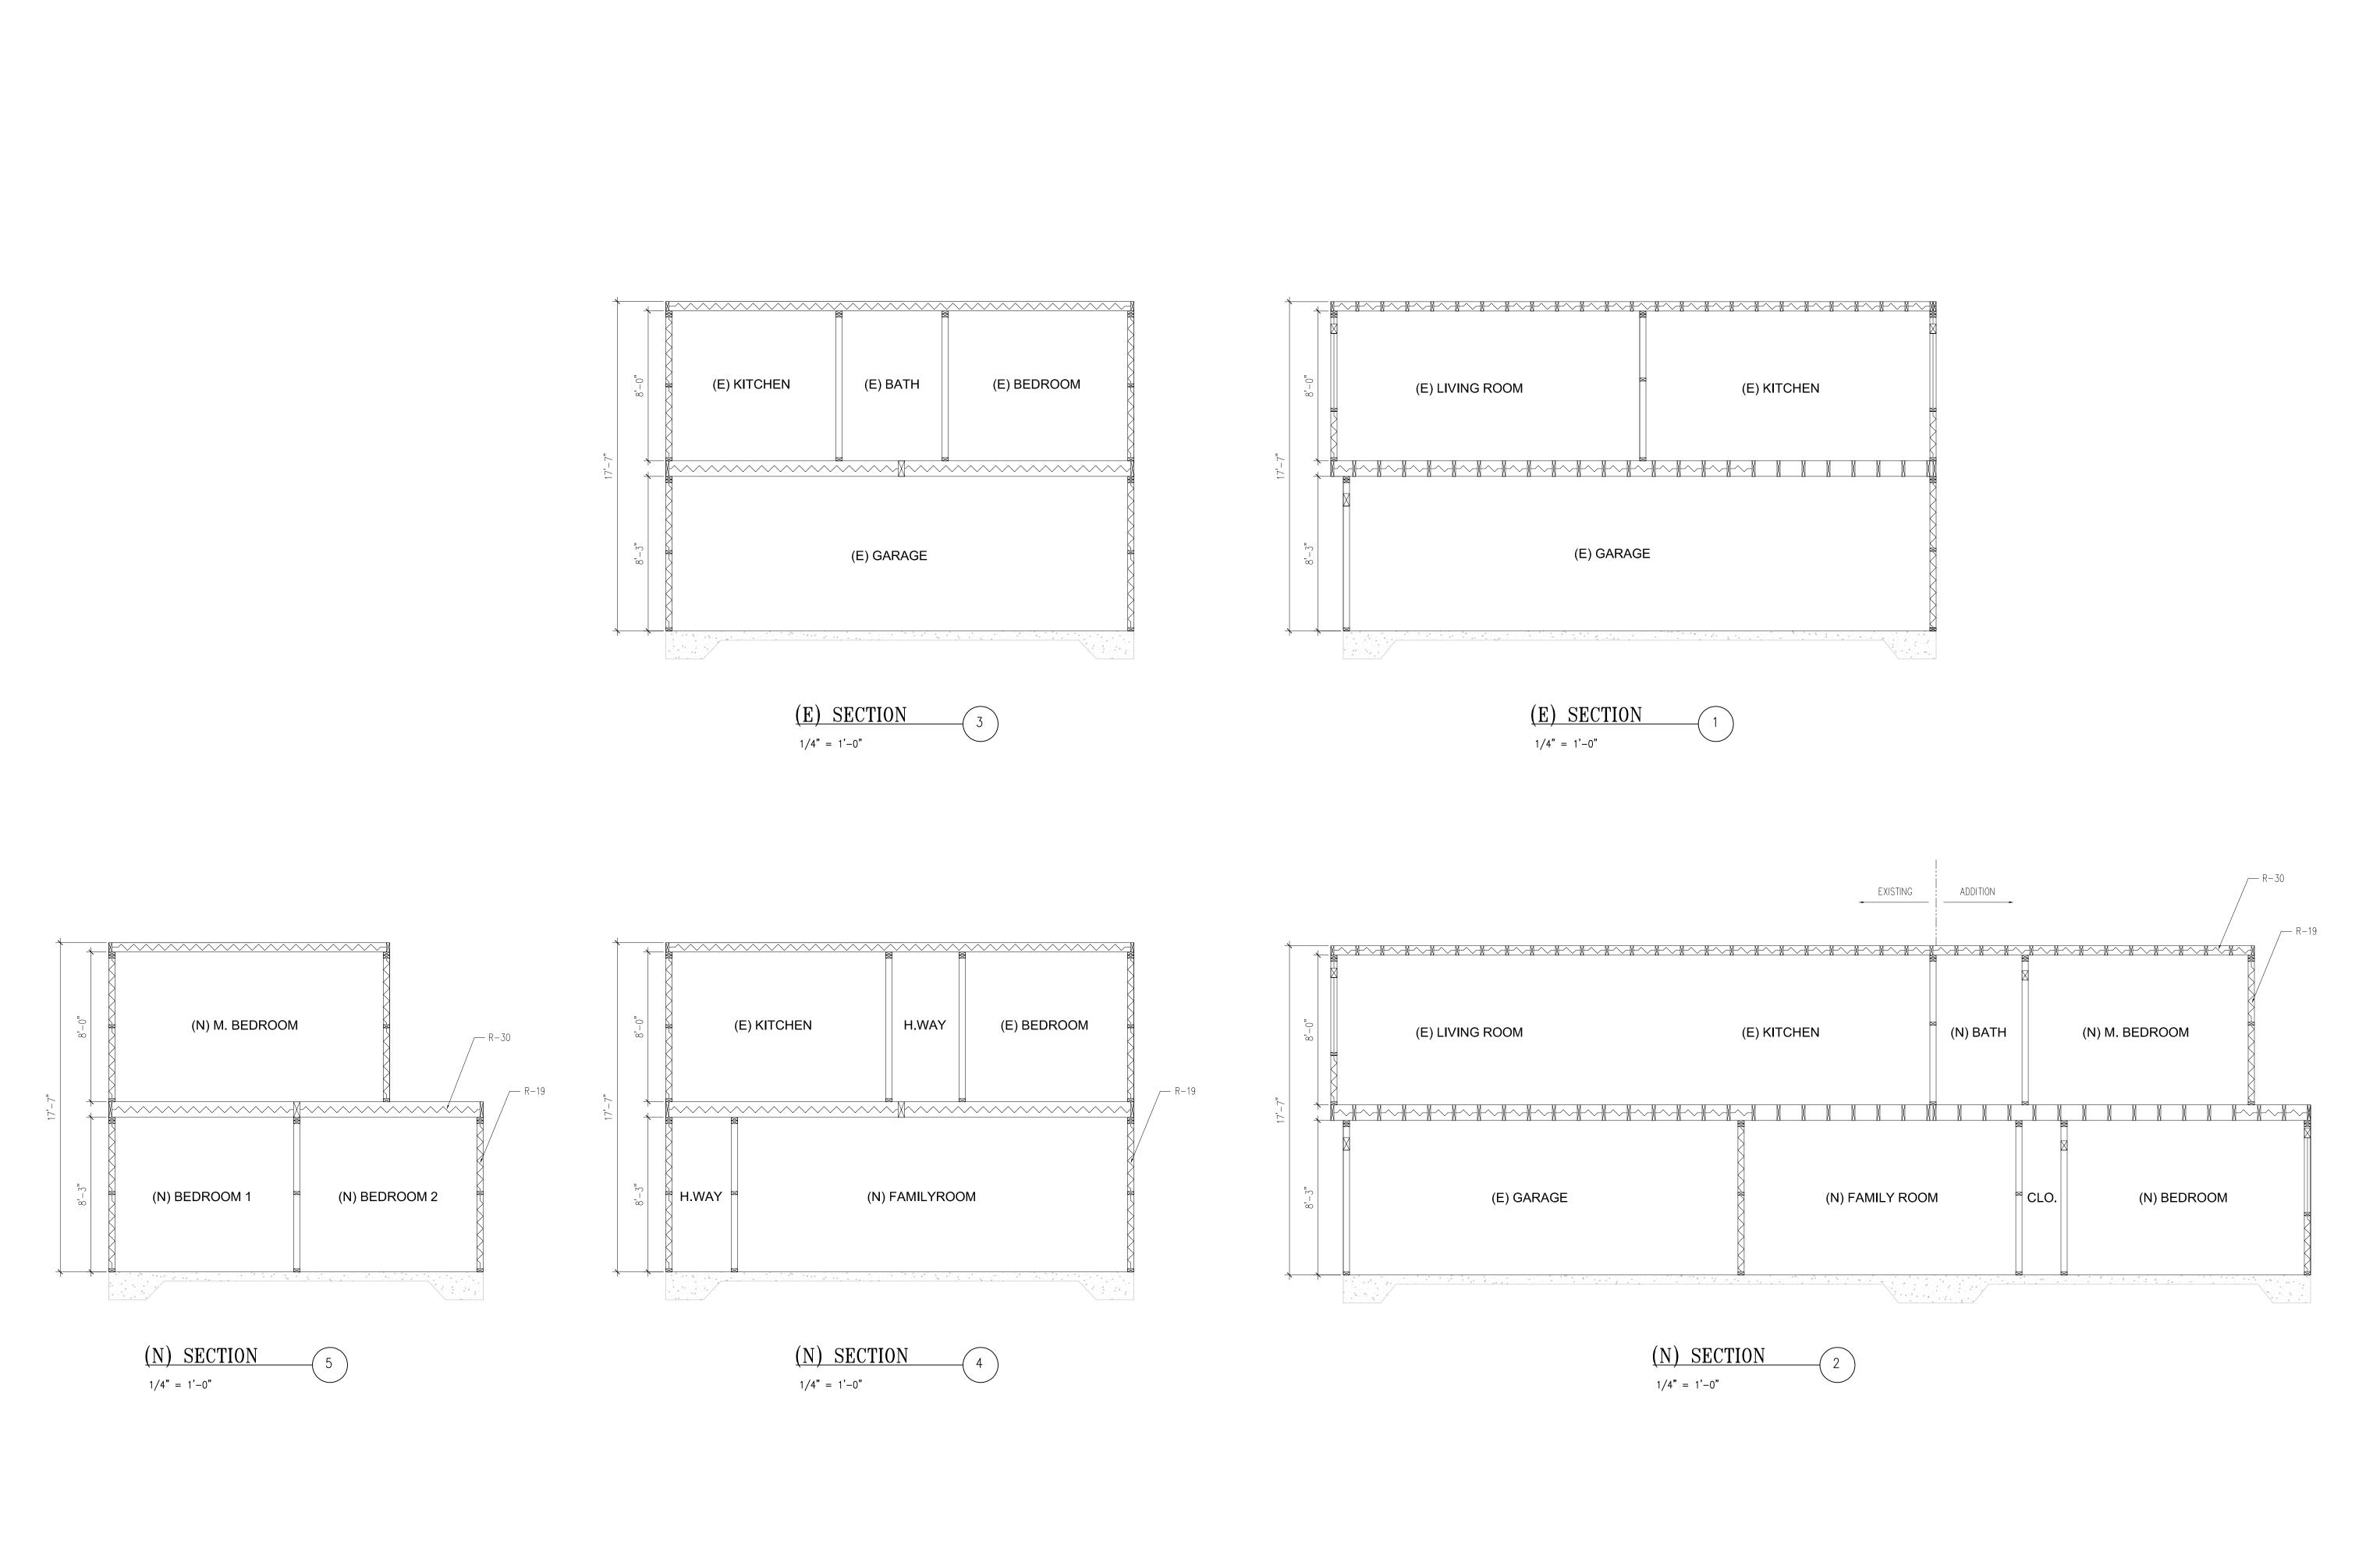

REVISE

FRANCISCO, RESIDENCE

23R

2019

SECTIONS SHEET TITLE:

DATE: JUNE/13/201

SCALE: AS NOTED SHEET

A3.0

of 8 sheets





REVISE

OWNER: RICKY & CAROL DUNG ADDRESS: 2019 23RD AVE SAN FRANCISCO, CA 94116

> N: ANDREW KWOK ESS: 475 LITTLEFIELD AVE, AN FRANCISCO, CA 115) 699-5556 : ANDREW\_CHHK@YAHOO.COM

ADDRESS: 475 LITTLEFIELD A SO. SAN FRANCISCO, CA TEL: (415) 699-5556 EMAIL: ANDREW\_CHHK@YAH

> DUNG RESIDENCE 2019 23RD AVE, SAN FRANCISCO,

PHOTOGRAPHS

DATE: JUNE/13/2019

DRAWN: A.K.

SCALE: AS NOTED

SHEET A4.0 OF 8 SHEETS

|                | Project data  |                              | Abbrevi                               | atior               |
|----------------|---|------------------------------|---------------------------------------|---------------------|
| ADDRESS:       | 2019 23rd Ave   | ABV.<br>A.F.F.<br>ALC.       | ABOVE<br>ABOVE FINISH FLOOR<br>ALCOVE | MTG.<br>MTL.<br>(N) |
| BLOCK          | 2143  | ADJ.<br>ADJUST.              | ADJACENT<br>ADJUSTABLE                | N.I.C.<br>N.T.S     |
| LOT            | 005   | ALUM.<br>A.V.                | ALUMINUM<br>AUDIO-VISUAL              | O/<br>O.C.          |
| STORIES:       | 2   | B.O.<br>BD.                  | BOTTOM OF<br>BOARD                    | O.H.<br>OPNO        |
| PRESENT USE:   | Residential-House, One Family                             | BLDG.<br>BTWN.               | BUILDING<br>BETWEEN                   | OPP.                |
| OCCUPANCY:     | R3  | CAB.<br>C.G.                 | CABINET<br>CORNER GUARD               | 0.0.0               |
| TYPE:          | 5B  | C.H.<br>C.J.                 | CLOTHES HOOK CONTROL JOINT            | 0.8.0               |
| ZONING:        | RH-1  | C.J.<br>C.L.<br>CLG.<br>CLR. | CENTER LINE CEILING CLEAR             | PART<br>PL.         |
|                | Scope of work   | CNTR.                        | COUNTER<br>COLUMN                     | P. LAI              |
| RIZONTAL ADDIT | ION AT REAR OF EXISTING TWO STORIES RESIDENTIAL BUILDING. | CONC.<br>COND.               | CONCRETE<br>CONDITION                 | PLCB                |

HORIZONTAL ADDITION AT REAR OF EXISTING TWO STORIES RESIDENTIAL BUILDING.

| Proi | ioct | note |
|------|------|------|
|      | CUL  | HOLE |

| Area/floor        | Existing (ft <sup>2</sup> ) | Proposed (ft <sup>2</sup> ) | Change (ft²)     |   |                          |
|-------------------|-----------------------------|-----------------------------|------------------|---|--------------------------|
| Living            | 753                         | 1798                        | 1,045            |   |                          |
| Car parking       | 1                           | 1                           |                  |   |                          |
| Bike parking      | 0                           | 1                           |                  |   |                          |
| Landscaping       | 0                           | (9*6.5)/(9*25)= 5           | 58.5 / 225 = 26% | > | (45 ft <sup>2</sup> )20% |
| Permeable surface | 0                           | (9*17)/(9*25)= 1            | 52/225 68%       | > | (12 ft <sup>2</sup> )50% |
|                   |                             |                             |                  |   |                          |

\*No existing sprinkler and no proposed sprinkler systems

## General notes

- 1. All work performed shall be in accordance with the adopted codes, standards and any applicable state or local amendments, including but not limited to:
  - Occupational safety and health standards, (CAL OSHA).
  - Lists of inspected appliances, equipment and materials (underwriters laboratories).
  - Approved equipment listing (factory mutual).
  - Handbook of rigging (rossnagel).
  - Safety code for building construction, ANSI.
  - California Building Code, 2016 edition. California Electrical Code, 2016 edition.
  - California Energy Code, 2016 edition.
  - 1.9. California Fire code, 2016 edition.
  - California Mechanical code, 2016 edition. California Plumbing code, 2016 edition.
  - California Referenced Standards code, 2016 edition.
  - California Energy Efficiency standards, 2016 edition. 1.13.
  - San Francisco Building Code 1.14
- 2. Where differences exist between codes affecting this work, the more restrictive code shall govern.
- 3. If the contractors observe that these drawings and specifications are in variance with the codes, he shall notify the architects and engineers in writing at once.
- 4. Ductwork, piping and equipment shall be installed per smacna "seismic restraint manual guidelines for mechanical systems addendum no. 1 or equal in accordance with asce chapter 13 seismic design requirements for non-structural components".
- 5. All fire-rated wall and floor penetrations shall be firesafed utilizing a ul approved fire safing systems.
- 6. All plumbing and piping systems shall be pressure tested and verified leak tight prior to calling for city progress or final inspections.
- 7. These drawings represent approximations of existing conditions. all conditions and dimensions are to be field verified by contractors prior to construction.

MOUNTING **METAL NOT IN CONTRACT** NOT TO SCALE **OVER** ON CENTER

OPPOSITE HAND NG. OPENING **OPPOSITE** S.C.I. OWNER SUPPLIED & CONTRACTOR INSTALLED S.O.I. OWNER SUPPLIED & OWNER INSTALLED RT. BD. PARTICLE BOARD PLATE PLASTIC LAMINATE

P.T.

RAD.

RM.

S.D.

SIM.

REINF.

REQ'D.

CONT.

CONST.

C.S.C.I

DEMO.

DIM.

DN.

DR.

DTL.

DWG.

DWR.

(E)

EA.

EL.

ELEC.

ENCL

EQ.

EQUIP.

EXPAN

EXT.

F.F.

FEC.

FLR.

F.T.

F.S.

GA.

G.B.

G.D.

G.C.

H.C.

HT.

INT.

JT.

K.S.

LOC.

MAG.

MAX.

MIN.

MOS.

MTD.

MECH.

INSUL.

GYP. BD.

FLUOR.

DISP.

CPT.

CONTINUOUS

CONTRACTOR

CONTRACTOR

SUPPLIED &

**INSTALLED** 

**DEMOLITION** 

**DIMENSION** 

DISPENSER

DOOR

DETAIL

**DRAWING** 

DRAWER

**EXISTING** 

**ELEVATION** 

**ELECTRICAL** 

**ENCLOSED** 

**EQUIPMENT** 

**EXPANSION** 

**FABRICATION** FLOOR DRAIN

FINISH FLOOR

**FLUORESCENT** 

FIRE SHUTTER

CONTRACTOR

HANDICAPPED

FIRE EXT. CABINET

**EXTERIOR** 

FINISH

**FLOOR** 

FACE OF

**GAUGE** 

**GRAB BAR** 

**GENERAL** 

GLASS

HEIGHT

JOINT

INTERIOR

MOUNTED

INSULATED

FEET

EACH

**EQUAL** 

CENTER

DOUBLE

CONSTRUCTION

PLASTIC LAMINATE CABINET **PANEL** PAPER TOWEL **DISPENSER** PAINTED RADIUS REINFORCE REQUIRED RESILIENT REFLECTED **CEILING PLAN** 

ROOM R.O. **ROUGH OPENING** R.O.S. ROLL OUT SHELF SHELF AND POLE SOAP DISPENSER SIMILAR SHT. SHEET SEE CIVIL **ENGINEERING** DRAWINGS SEE ELECTRICAL DRAWINGS

S.E.D. SEE LANDSCAPE DRAWINGS SEE MECHANICAL DRAWINGS SEE PLUMBING DRAWINGS SPECIFICATIONS SQUARE INCHES SQ. IN. SQUARE FEET S.S. S.S.D.

STAINLESS STEEL SEE STRUCTURAL DRAWINGS STAINLESS STEEL STEEL STATION SUSPENDED TEMPERED GLASS

GARBAGE DISPOSAL SUSP. TEL. **TELEPHONE** TEMPERED **GYPSUM BOARD** TOP OF T.O. **TYPICAL** TYP. UNLESS U.N. OTHERWISE NOTED V.A.T. VINYL ACOUSTICAL TILE VERIFY IN FIELD V.I.F. W/ WITH WATER CLOSET

**KNEE SPACE** LOCKER W.C. LOCATION WOOD MAGNETIC WD. WINDOW MAXIMUM WDW W/O. WITHOUT MECHANICAL MINIMUM W.O. WHERE OCCURS MOTION SENSOR

# Sheet index

| A1.1 | Notes, Legend, Scope of World |
|------|-------------------------------|
| A1.2 | Site plans                    |
| A2.1 | Floor plans                   |
| A2.2 | Roof plans                    |
| A2.3 | Elevations                    |
| A2.4 | Elevations                    |
| A2.5 | Section                       |
| A3.1 | Architectural details         |
|      |                               |

# 2019 23rd Ave

# San Francisco CA 94116

|                      | Demolition Cal | culation  |           |
|----------------------|----------------|-----------|-----------|
| Lin                  | ear footage me | asurement |           |
| Element              | (E) Length     | Removed   | % Removed |
| Front Façade         | 25'0"          | 0'-0"     | 0%        |
| Rear Façade          | 25'0"          | 20'0"     | 80%       |
| Left side elevation  | 31'8"          | 0'-0"     | 0%        |
| Right side elevation | 31'8"          | 0'-0"     | 0%        |
| Total                | 113'4"         | 20'0"     | 18%       |
| Ar                   | ea footage mea | surement  |           |
| Vertical elements    | (E) Length     | Removed   | % Removed |
| Front Façade         | 440            | 0         | 0%        |
| Rear Façade          | 440            | 352       | 80%       |
| Left side elevation  | 557            | 0         | 0%        |
| Right side elevation | 557            | 0         | 0%        |
| Total                | 1994           | 352       | 18%       |
| Horizontal Elements  | (E) Length     | Removed   | % Removed |
| Second floor         | 792            | 0         | 0         |
| Ground floor         | 792            | 0         | 0         |
| Total                | 1584           | 0         | 0         |

| Floor area   | Existing total (ft <sup>2</sup> ) | Proposed total (ft <sup>2</sup> ) |
|--------------|-----------------------------------|-----------------------------------|
| First floor  | 0                                 | 504                               |
| Second floor | 530                               | 700                               |
| Total area   | 530                               | 1204                              |



5418A GEARY BLVD. SAN FRANCISCO, CA P 415-322-0793 F 415-963-4080

Avenue

REVISIONS

DESCRIPTION DATE PROJECT TITLE

Residential horizontal addition

General notes

LOCATION

2019 23rd Ave San Francisco CA 94116

BLOCK: 2143 LOT: 005

ZONING: RH-1

These drawings represent approximations of existing conditions. all conditions and dimensions are to be field verified by contractors prior to construction.



DRAWN

**AS NOTED** 

7/23/2020

Property Line Property Line Property Line 25'-0" Subject property Adjacent Property Adjacent Property Two story single family home Property Line Property Line Property Line

Property Line Property Line Property Line 25'-0" 5'-0" First Floor Addition Second Floor Addition Subject property Adjacent Property Adjacent Property Two story single family home Property Line Property Line 10'-6" | 6'-6" | Property Line

Sidewalk

 $2 \frac{\text{Site Plan}}{\frac{1}{8} = \frac{1}{0} = 0}$ (N) Street tree 24" Box fruitless olive tree with new planter bed 36" X 36" sawcut 23RD AVE

5418A GEARY BLVD. SAN FRANCISCO, CA P 415-322-0793 F 415-963-4080

REVISIONS

| NO. | DESCRIPTION | DATE |
|-----|-------------|------|
|     |             |      |
|     |             |      |
| PRO | JECT TITLE  |      |

Residential horizontal addition

SHEET TITLE Site Plans

LOCATION


2019 23rd Ave

LOT: 005 BLOCK: 2143

San Francisco CA 94116

ZONING: RH-1

These drawings represent approximations of existing conditions. all conditions and dimensions are to be field verified by contractors prior to construction.

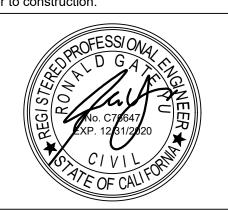

DRAWN


SCALE **AS NOTED** 


7/23/2020


PROJECT NO.

A1.2

1 Site Plan  $\frac{1}{1/8"} = 1' - 0"$ 

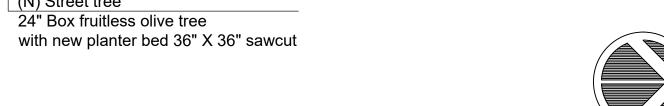

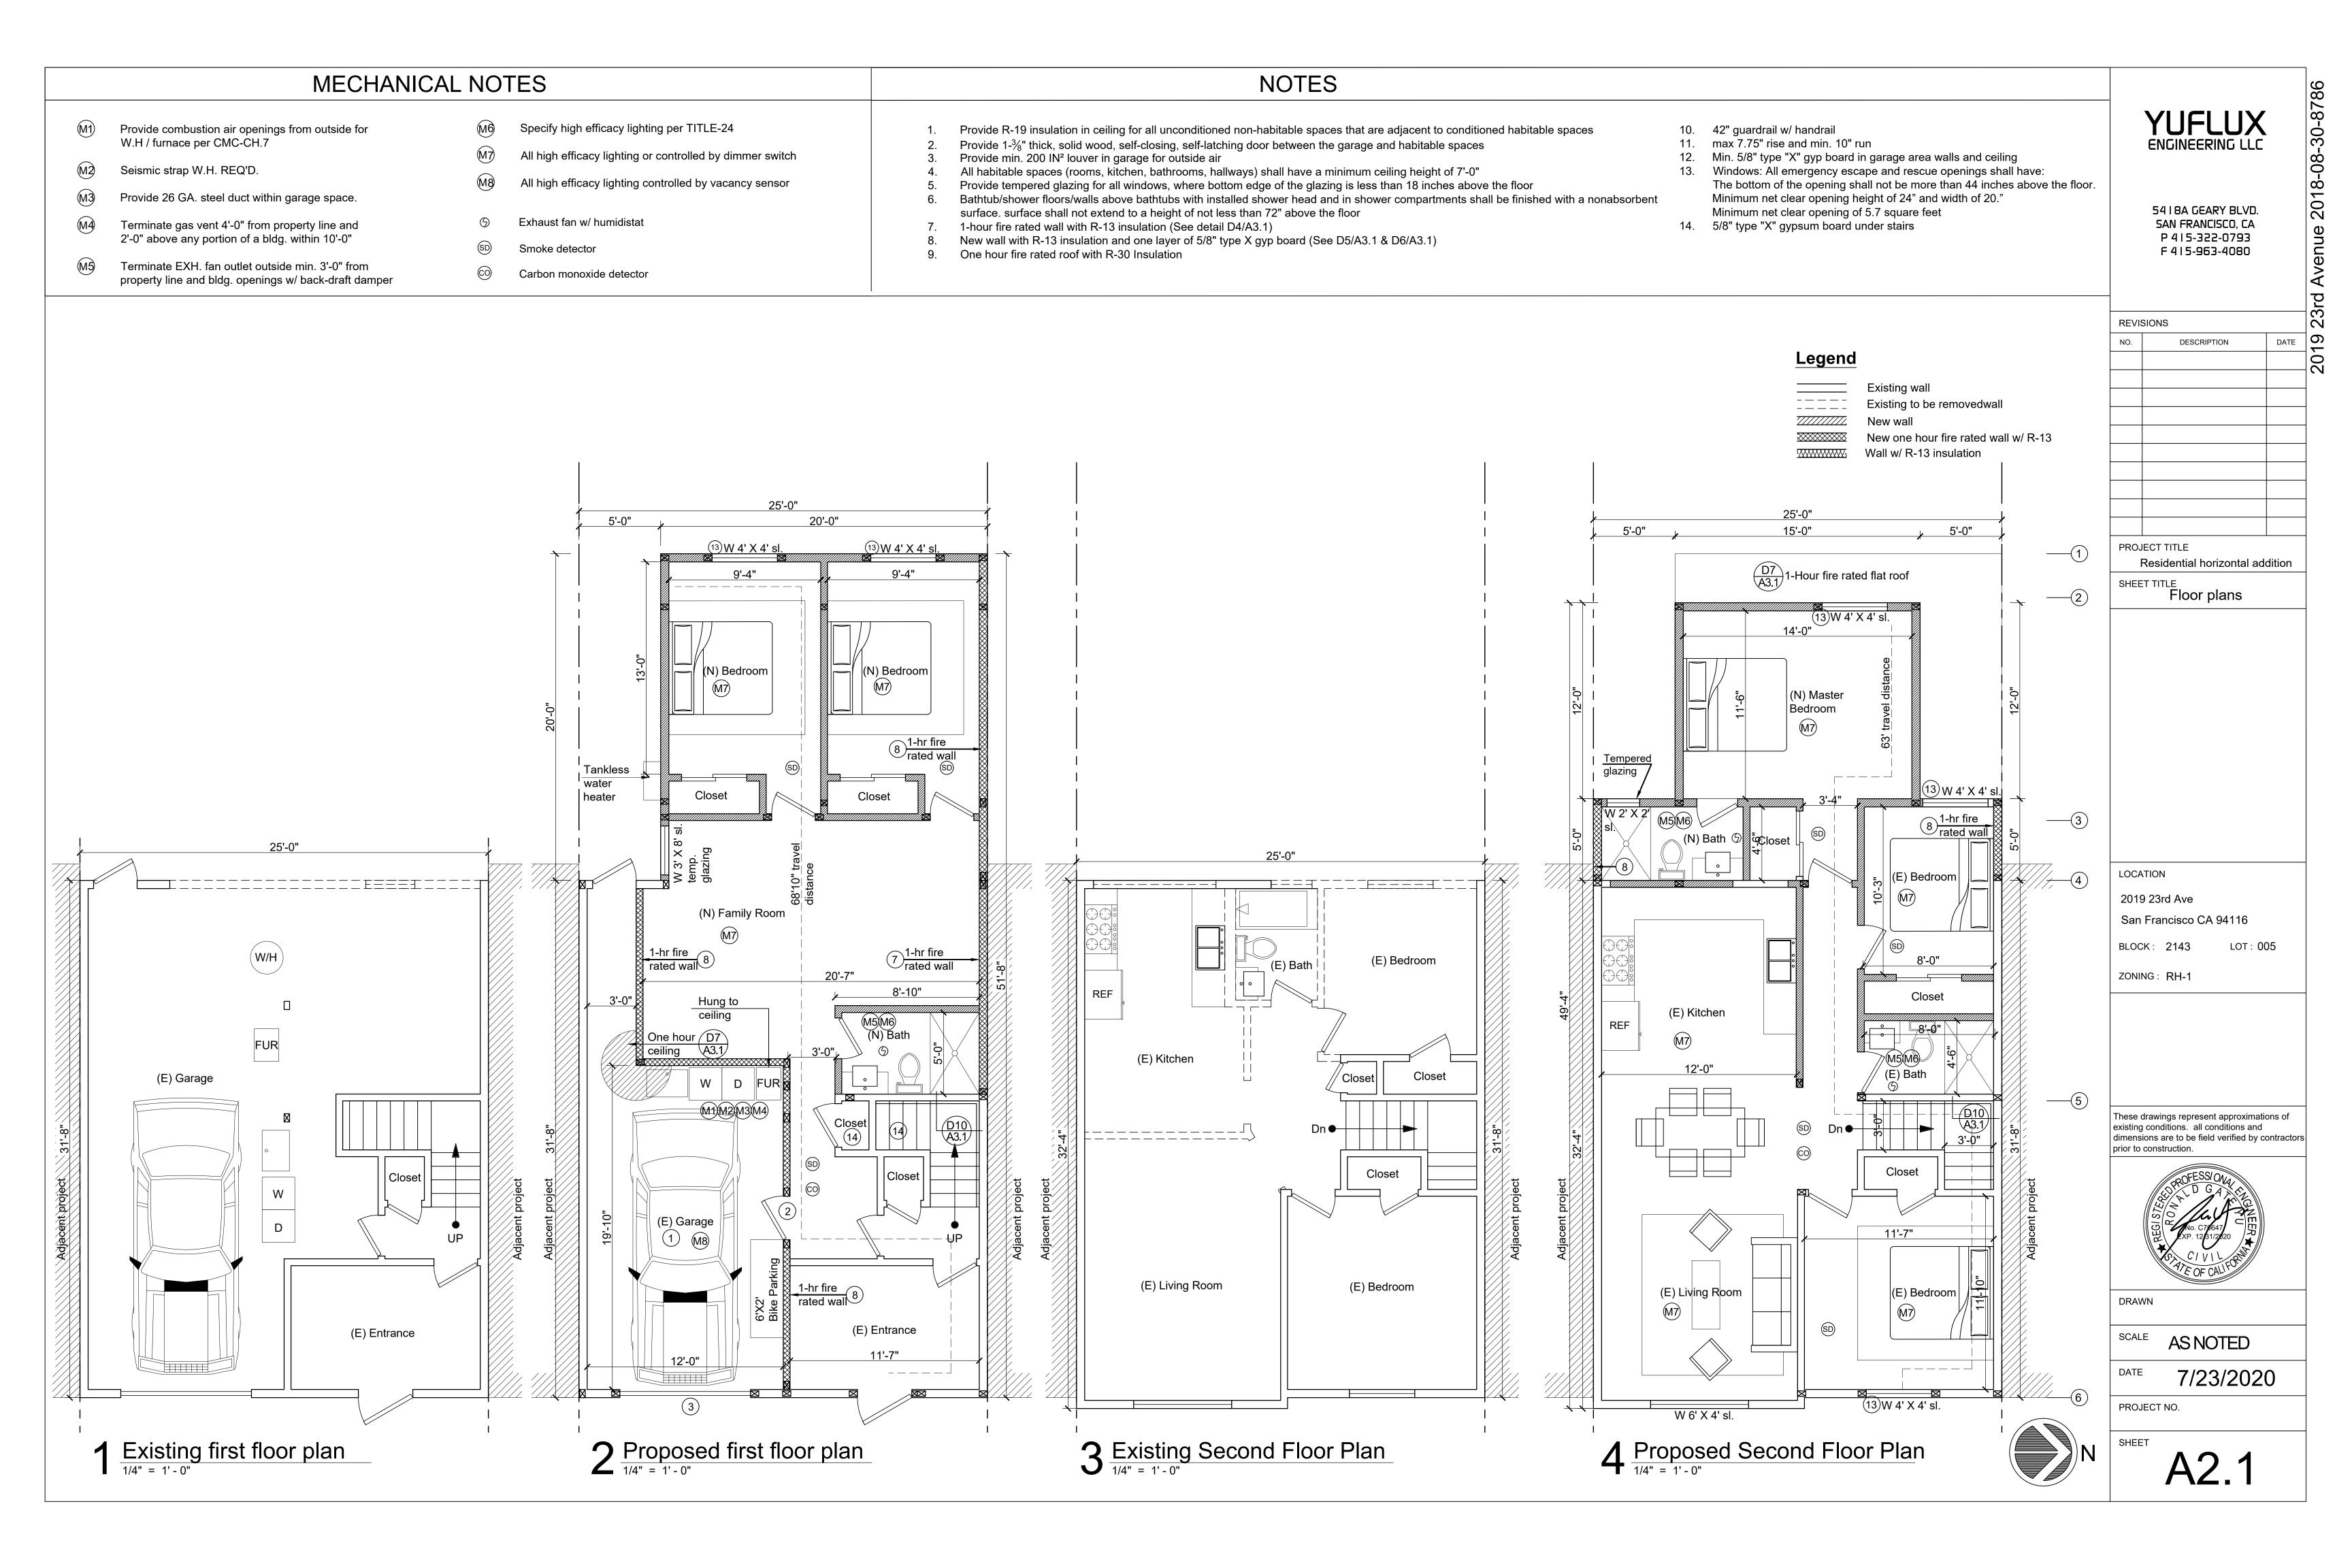

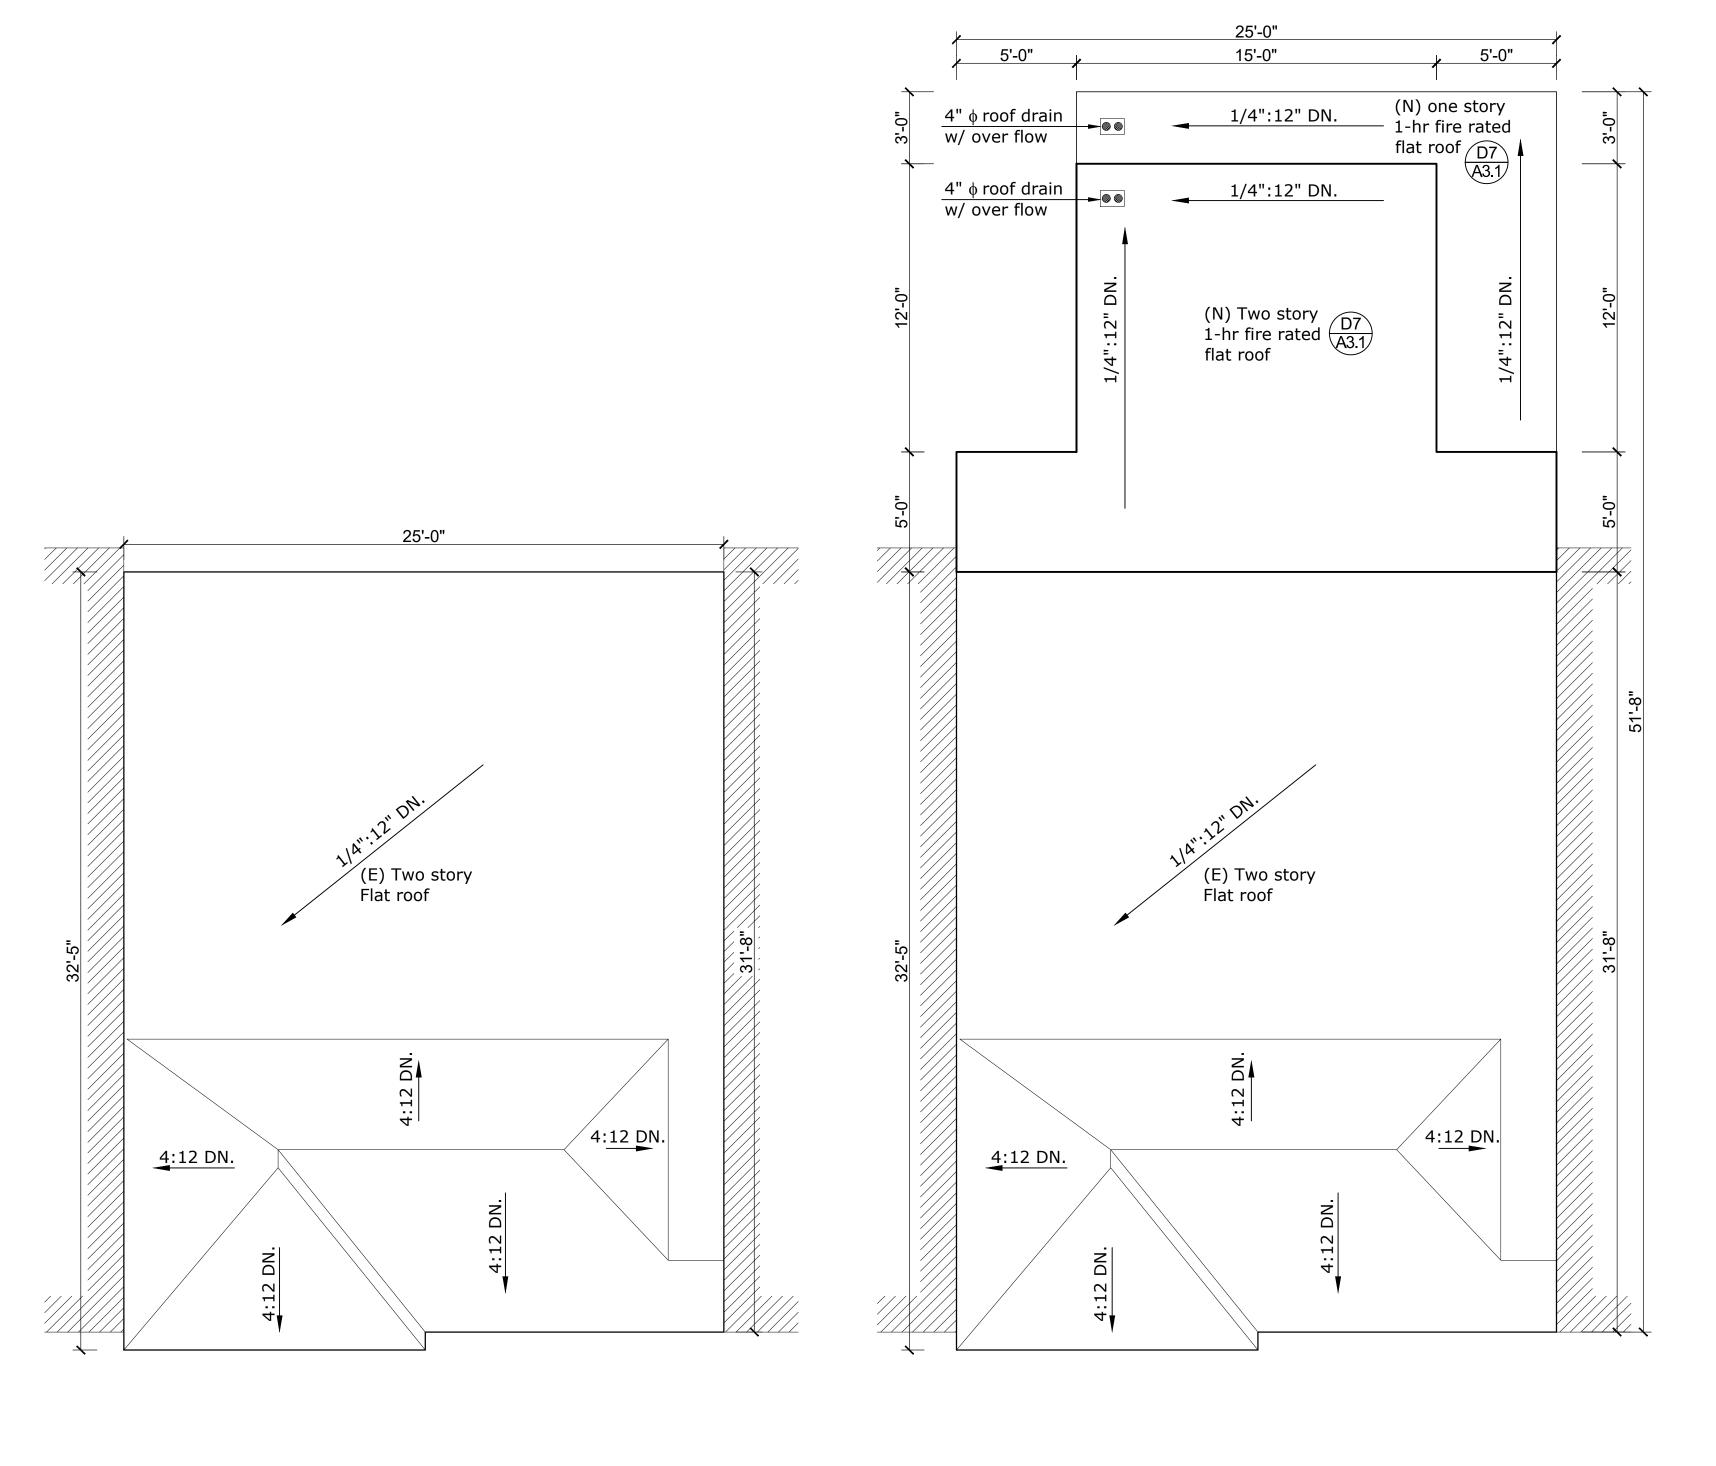

1 Existing roof plans  $\frac{1}{1/4"} = 1' - 0"$ 

 $2^{\frac{\text{Proposed roof plans}}{1/4" = 1' - 0"}}$ 



|      | YUFLUX ENGINEERING LLC   |      |
|------|--|------|
|      | 5418A GEARY BLVD.<br>SAN FRANCISCO, CA<br>P 415-322-0793<br>F 415-963-4080 |      |
| REVI | SIONS  |      |
| NO.  | DESCRIPTION  | DATE |
|      |  |      |
|      |  |      |

Residential horizontal addition

SHEET TITLE Roof plans

LOCATION

2019 23rd Ave


San Francisco CA 94116

LOT: 005

ZONING: RH-1

BLOCK: 2143


These drawings represent approximations of existing conditions. all conditions and dimensions are to be field verified by contractors prior to construction.

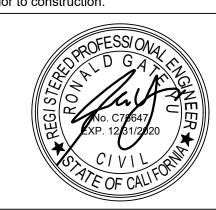

DRAWN

SCALE **AS NOTED** 

7/23/2020

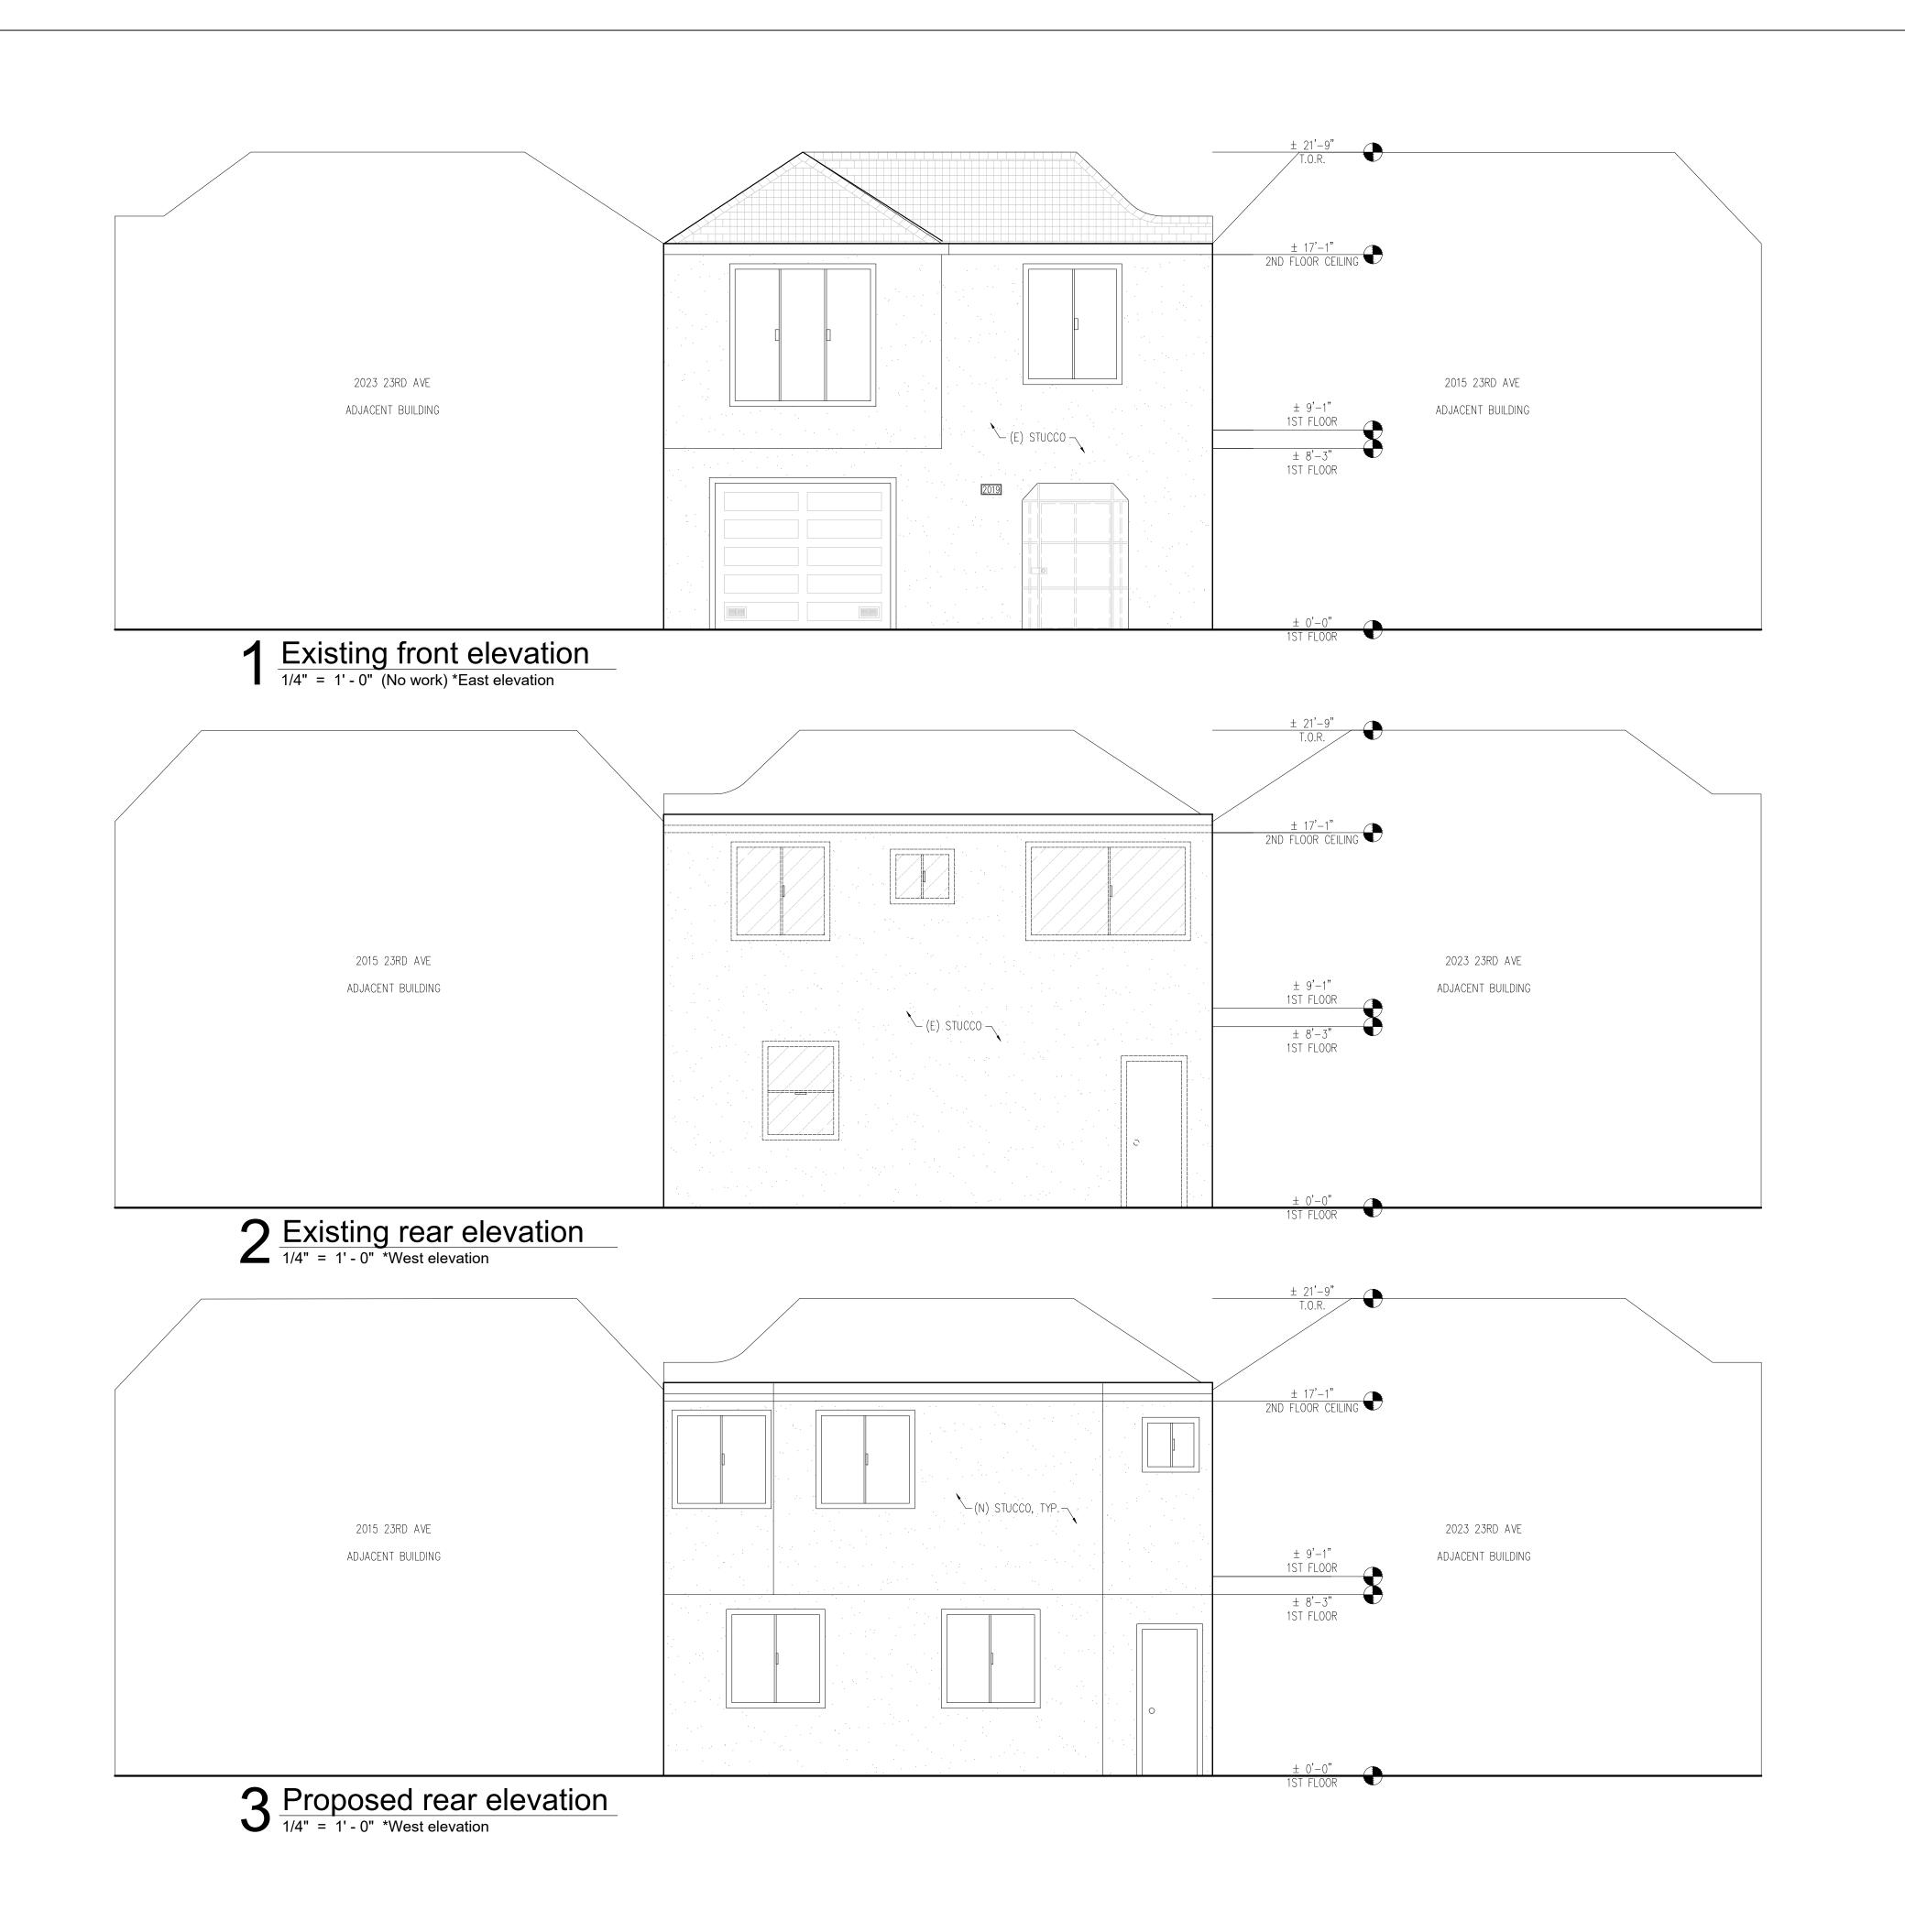

|      | YUFLUX ENGINEERING LLC   |      | -08-30-8786                      |
|------|--|------|----------------------------------|
|      | 5418A GEARY BLVD.<br>SAN FRANCISCO, CA<br>P 415-322-0793<br>F 415-963-4080 |      | 2019 23rd Avenue 2018-08-30-8786 |
| REVI | SIONS  |      | <b>23</b> r                      |
| NO.  | DESCRIPTION  | DATE | 019                              |
|      |  |      | 2                                |
|      |  |      |                                  |
|      |  |      |                                  |
|      |  |      |                                  |
|      |  |      |                                  |
| PRO  | JECT TITLE   |      |                                  |

Residential horizontal addition

SHEET TITLE
Elevations

LOCATION


2019 23rd Ave

San Francisco CA 94116

ZONING: RH-1


BLOCK: 2143


These drawings represent approximations of existing conditions. all conditions and dimensions are to be field verified by contractors prior to construction.

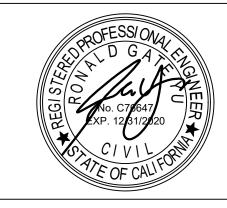


**AS NOTED** 

7/23/2020

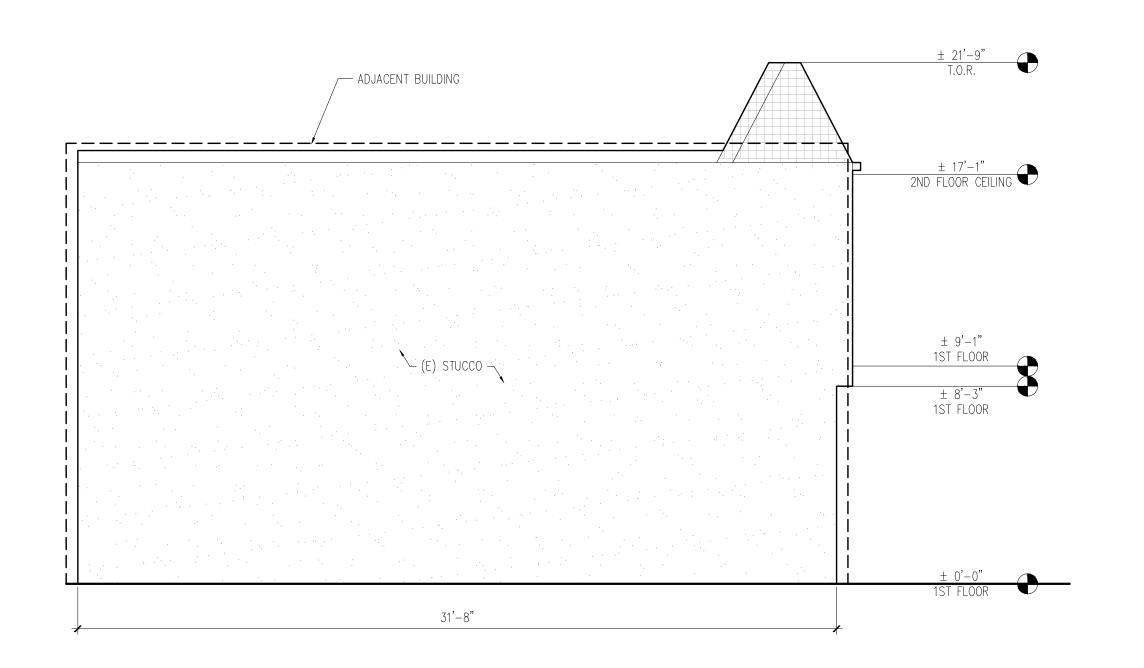

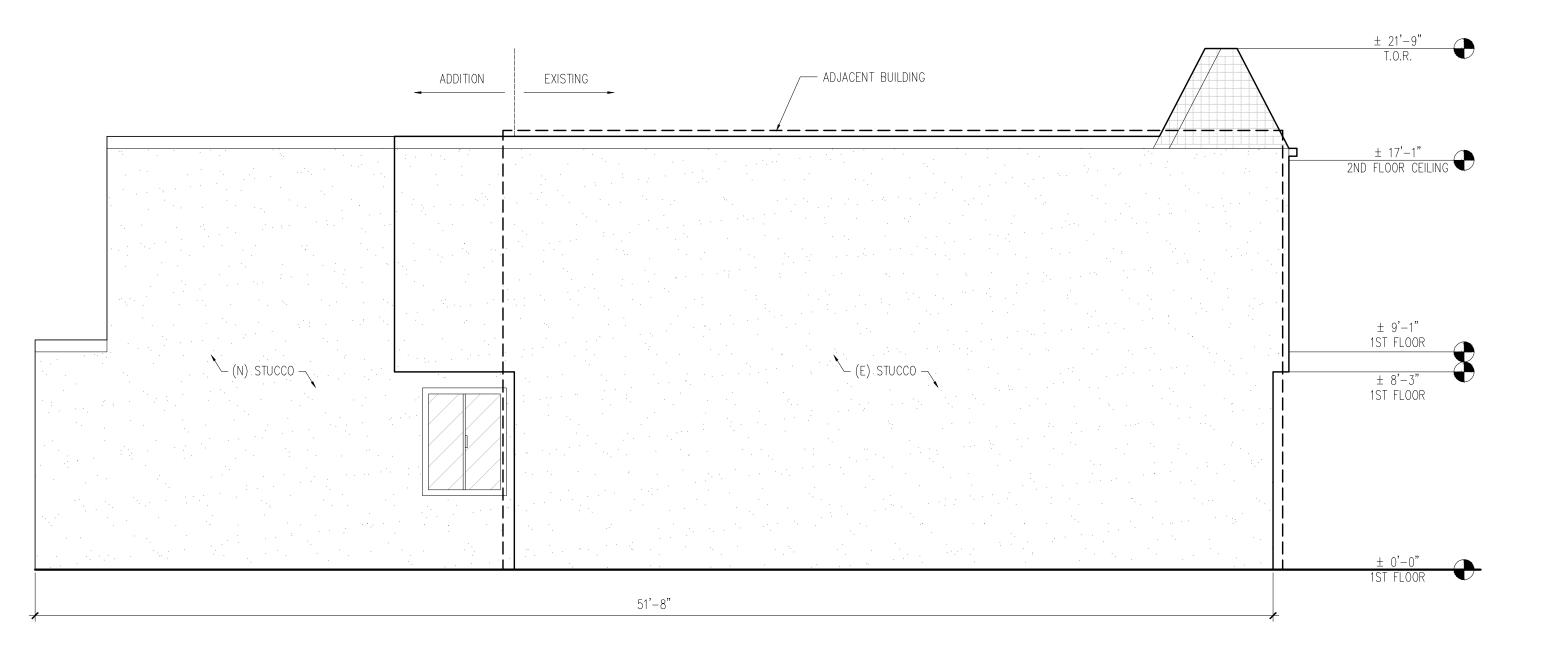




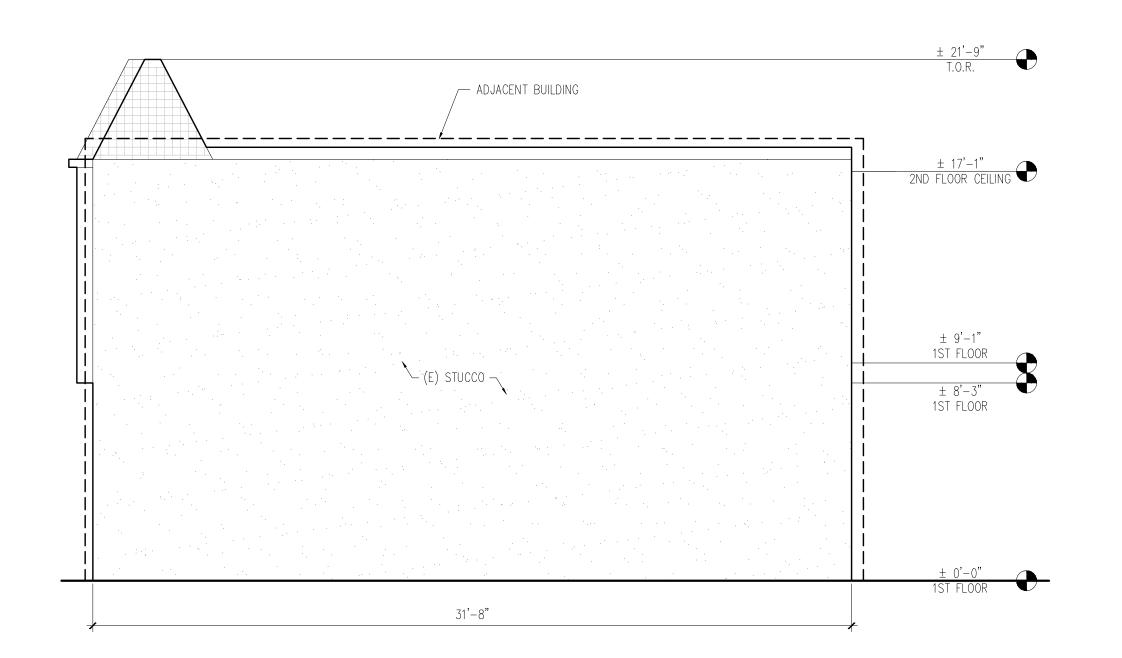

Existing left elevation

1/4" = 1' - 0" \*South elevation

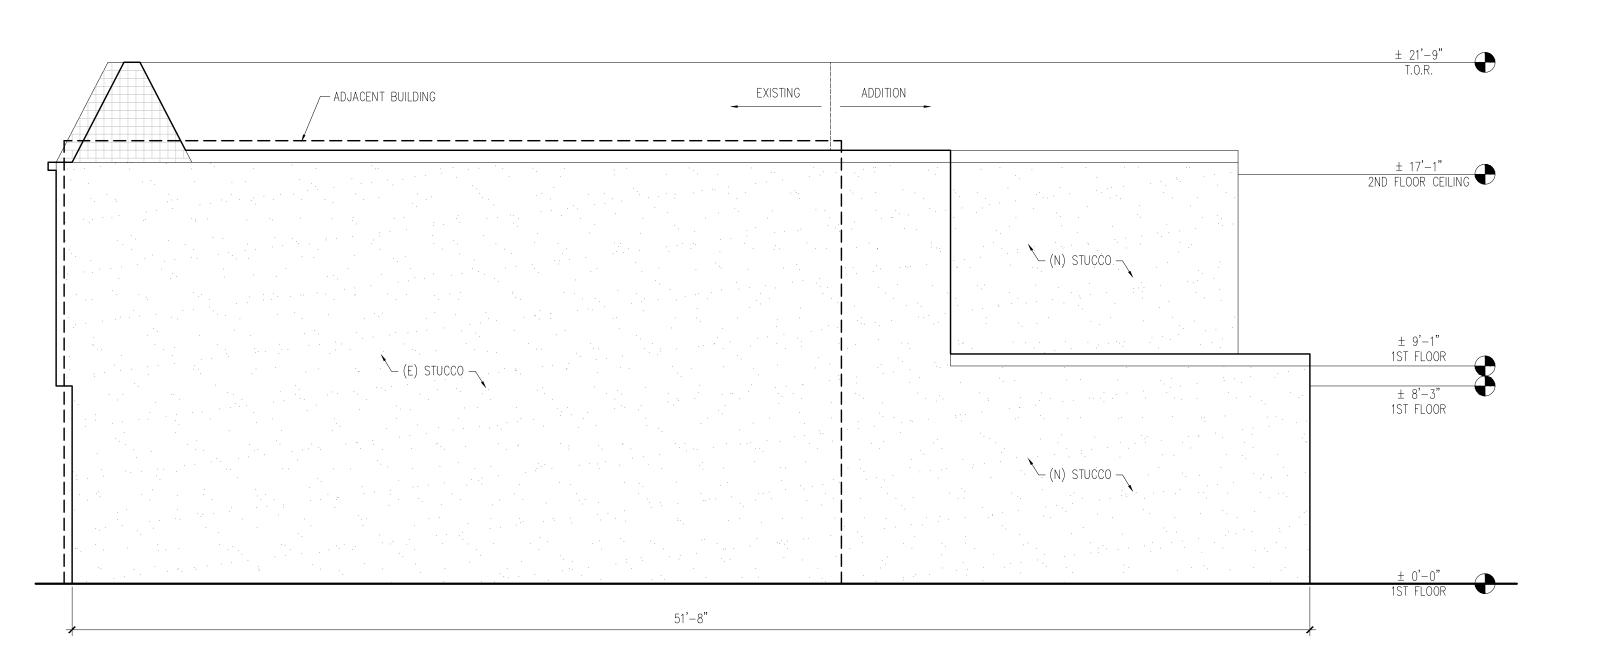

3 Existing right elevation

1/4" = 1' - 0" \*North elevation

Proposed right elevation

1/4" = 1' - 0" \*North elevation

REVISIONS

|      | YUFLUX<br>ENGINEERING LLC<br>5418A GEARY BLVD.<br>SAN FRANCISCO, CA<br>P 415-322-0793<br>F 415-963-4080 |        | 2019 23rd Avenue 2018-08-30-8786 |
|------|---|--------|----------------------------------|
|      |   |        | 3r                               |
| REVI | SIONS   |        | 7                                |
| NO.  | DESCRIPTION   | DATE   | 2018                             |
|      |   |        |                                  |
|      | ECT TITLE<br>Residential horizontal add   | dition |                                  |

SHEET TITLE
Elevations


LOCATION

2019 23rd Ave

San Francisco CA 94116 LOT: 005 BLOCK: 2143

ZONING: RH-1

These drawings represent approximations of existing conditions. all conditions and dimensions are to be field verified by contractors prior to construction.

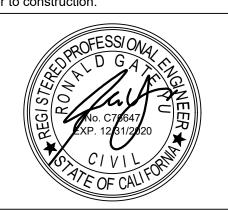


DRAWN


**AS NOTED** 

7/23/2020

PROJECT NO.

A2.4

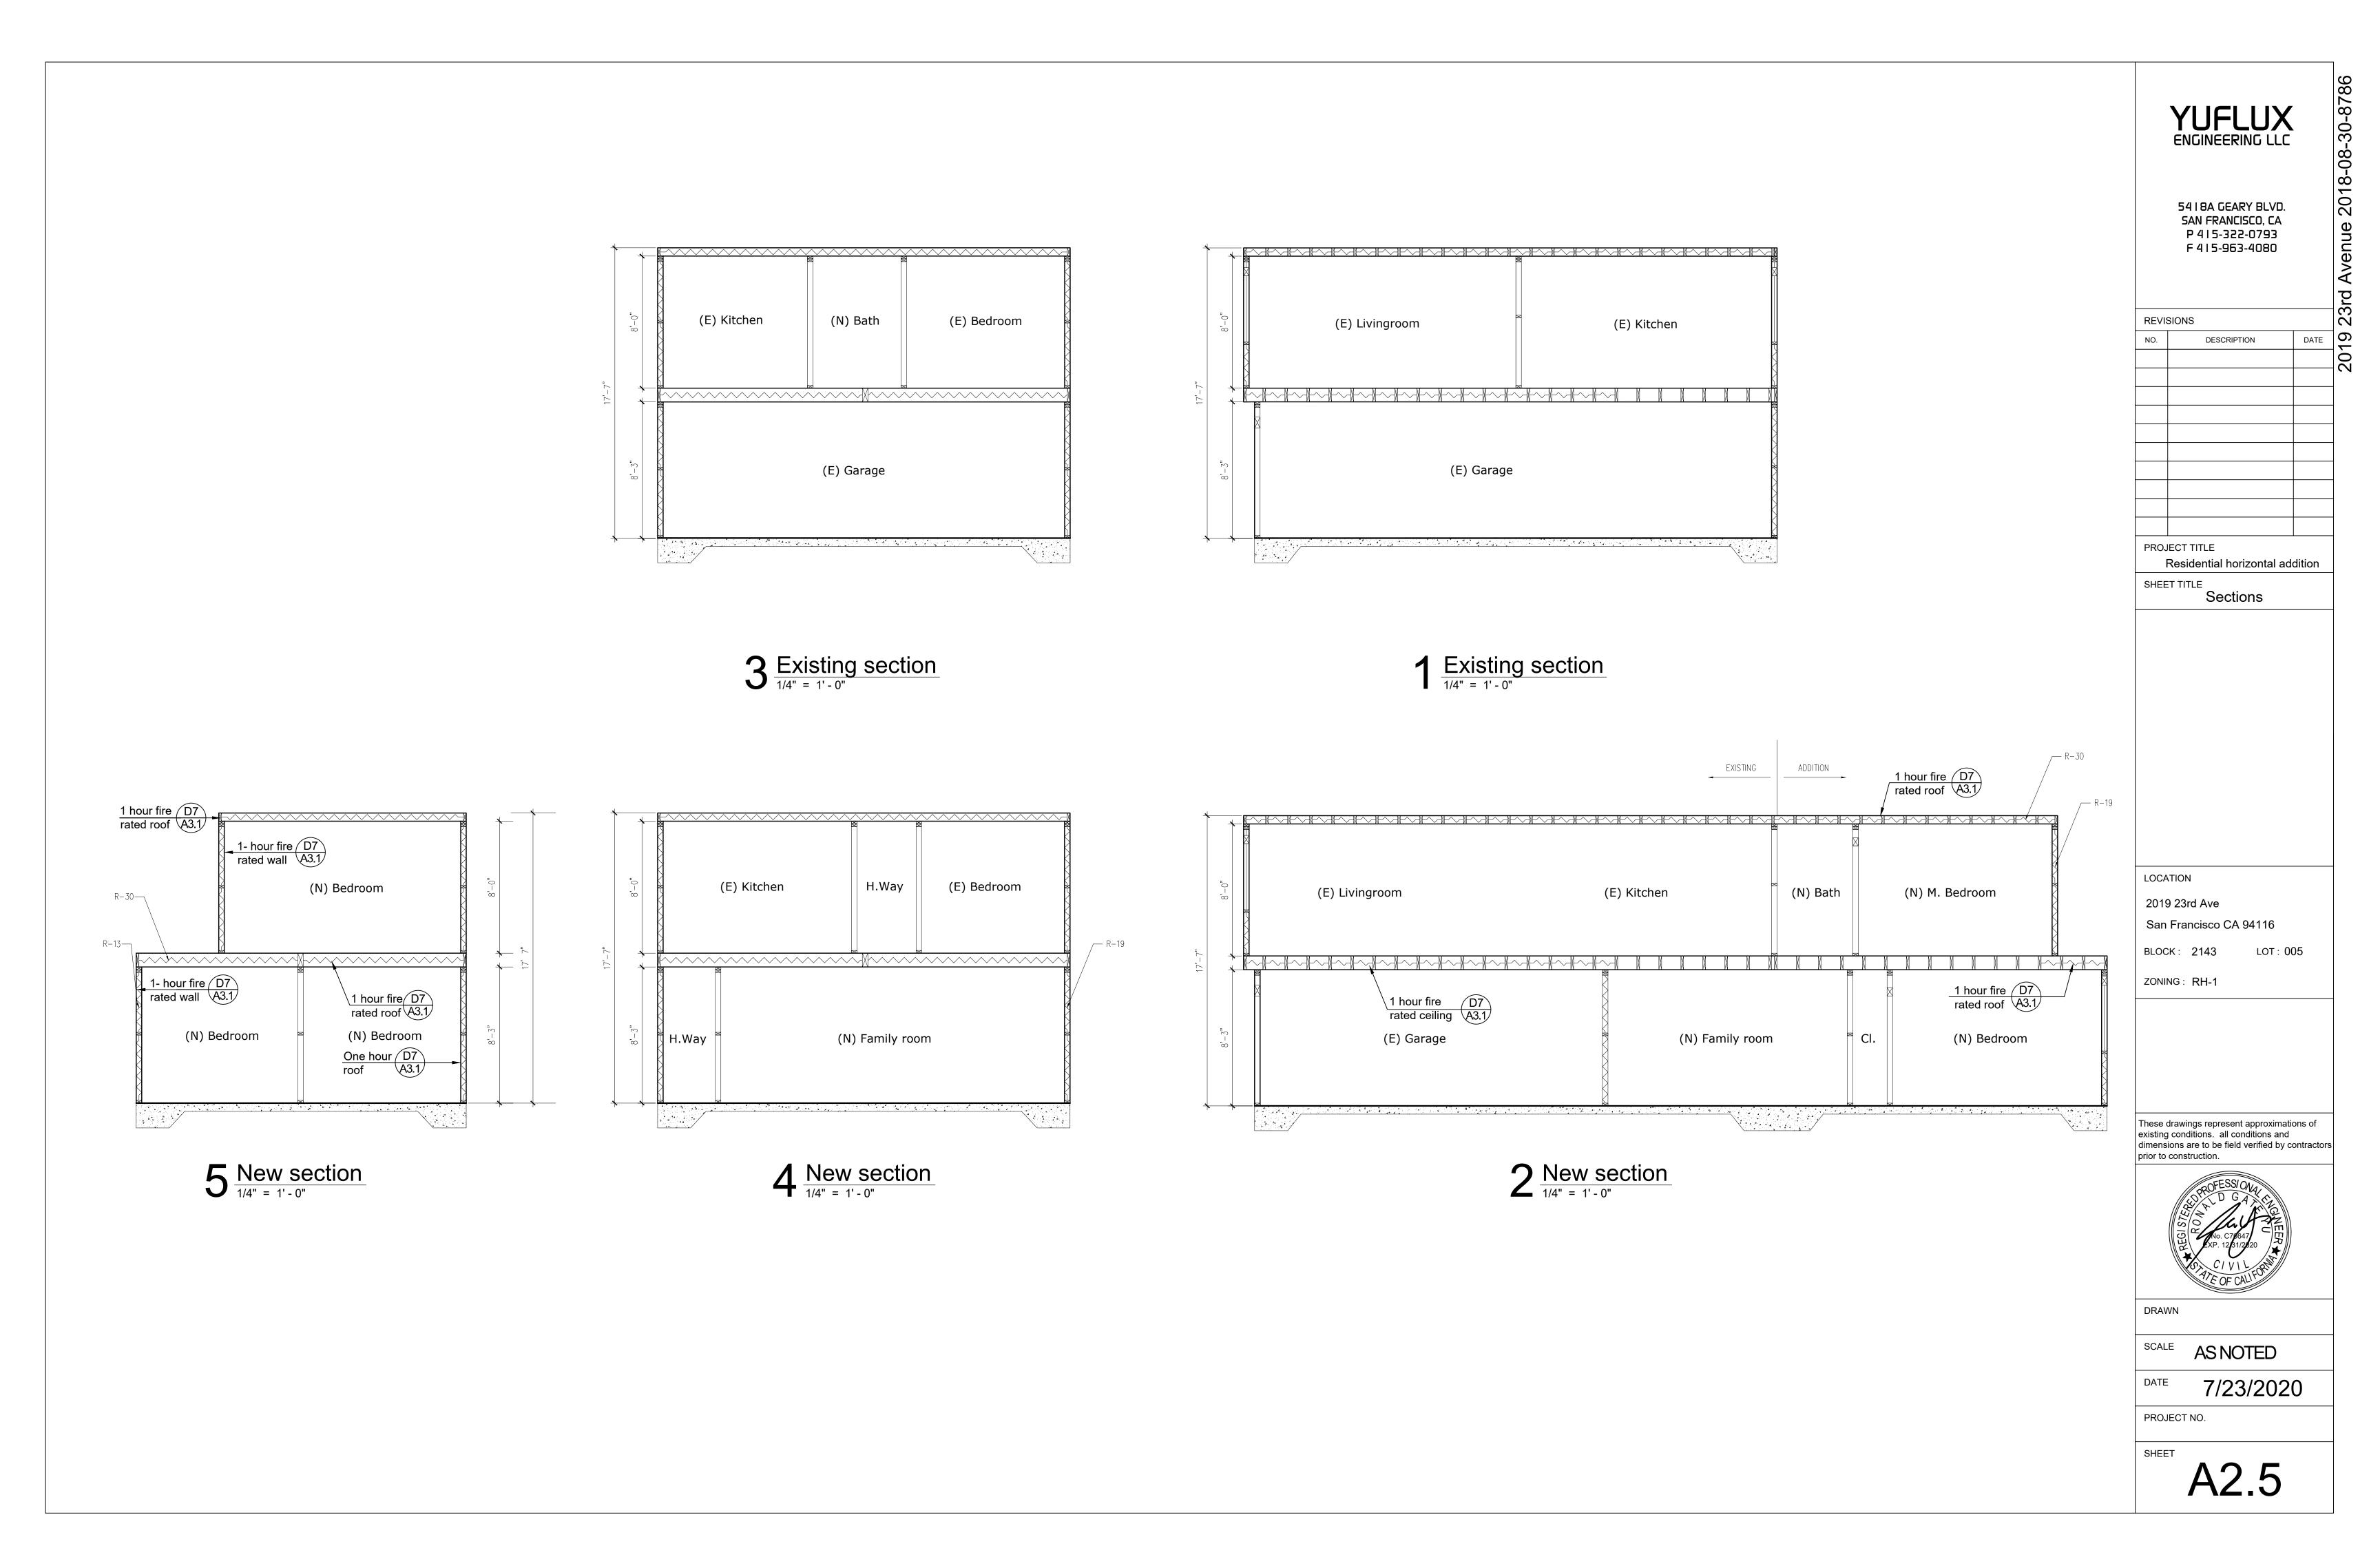

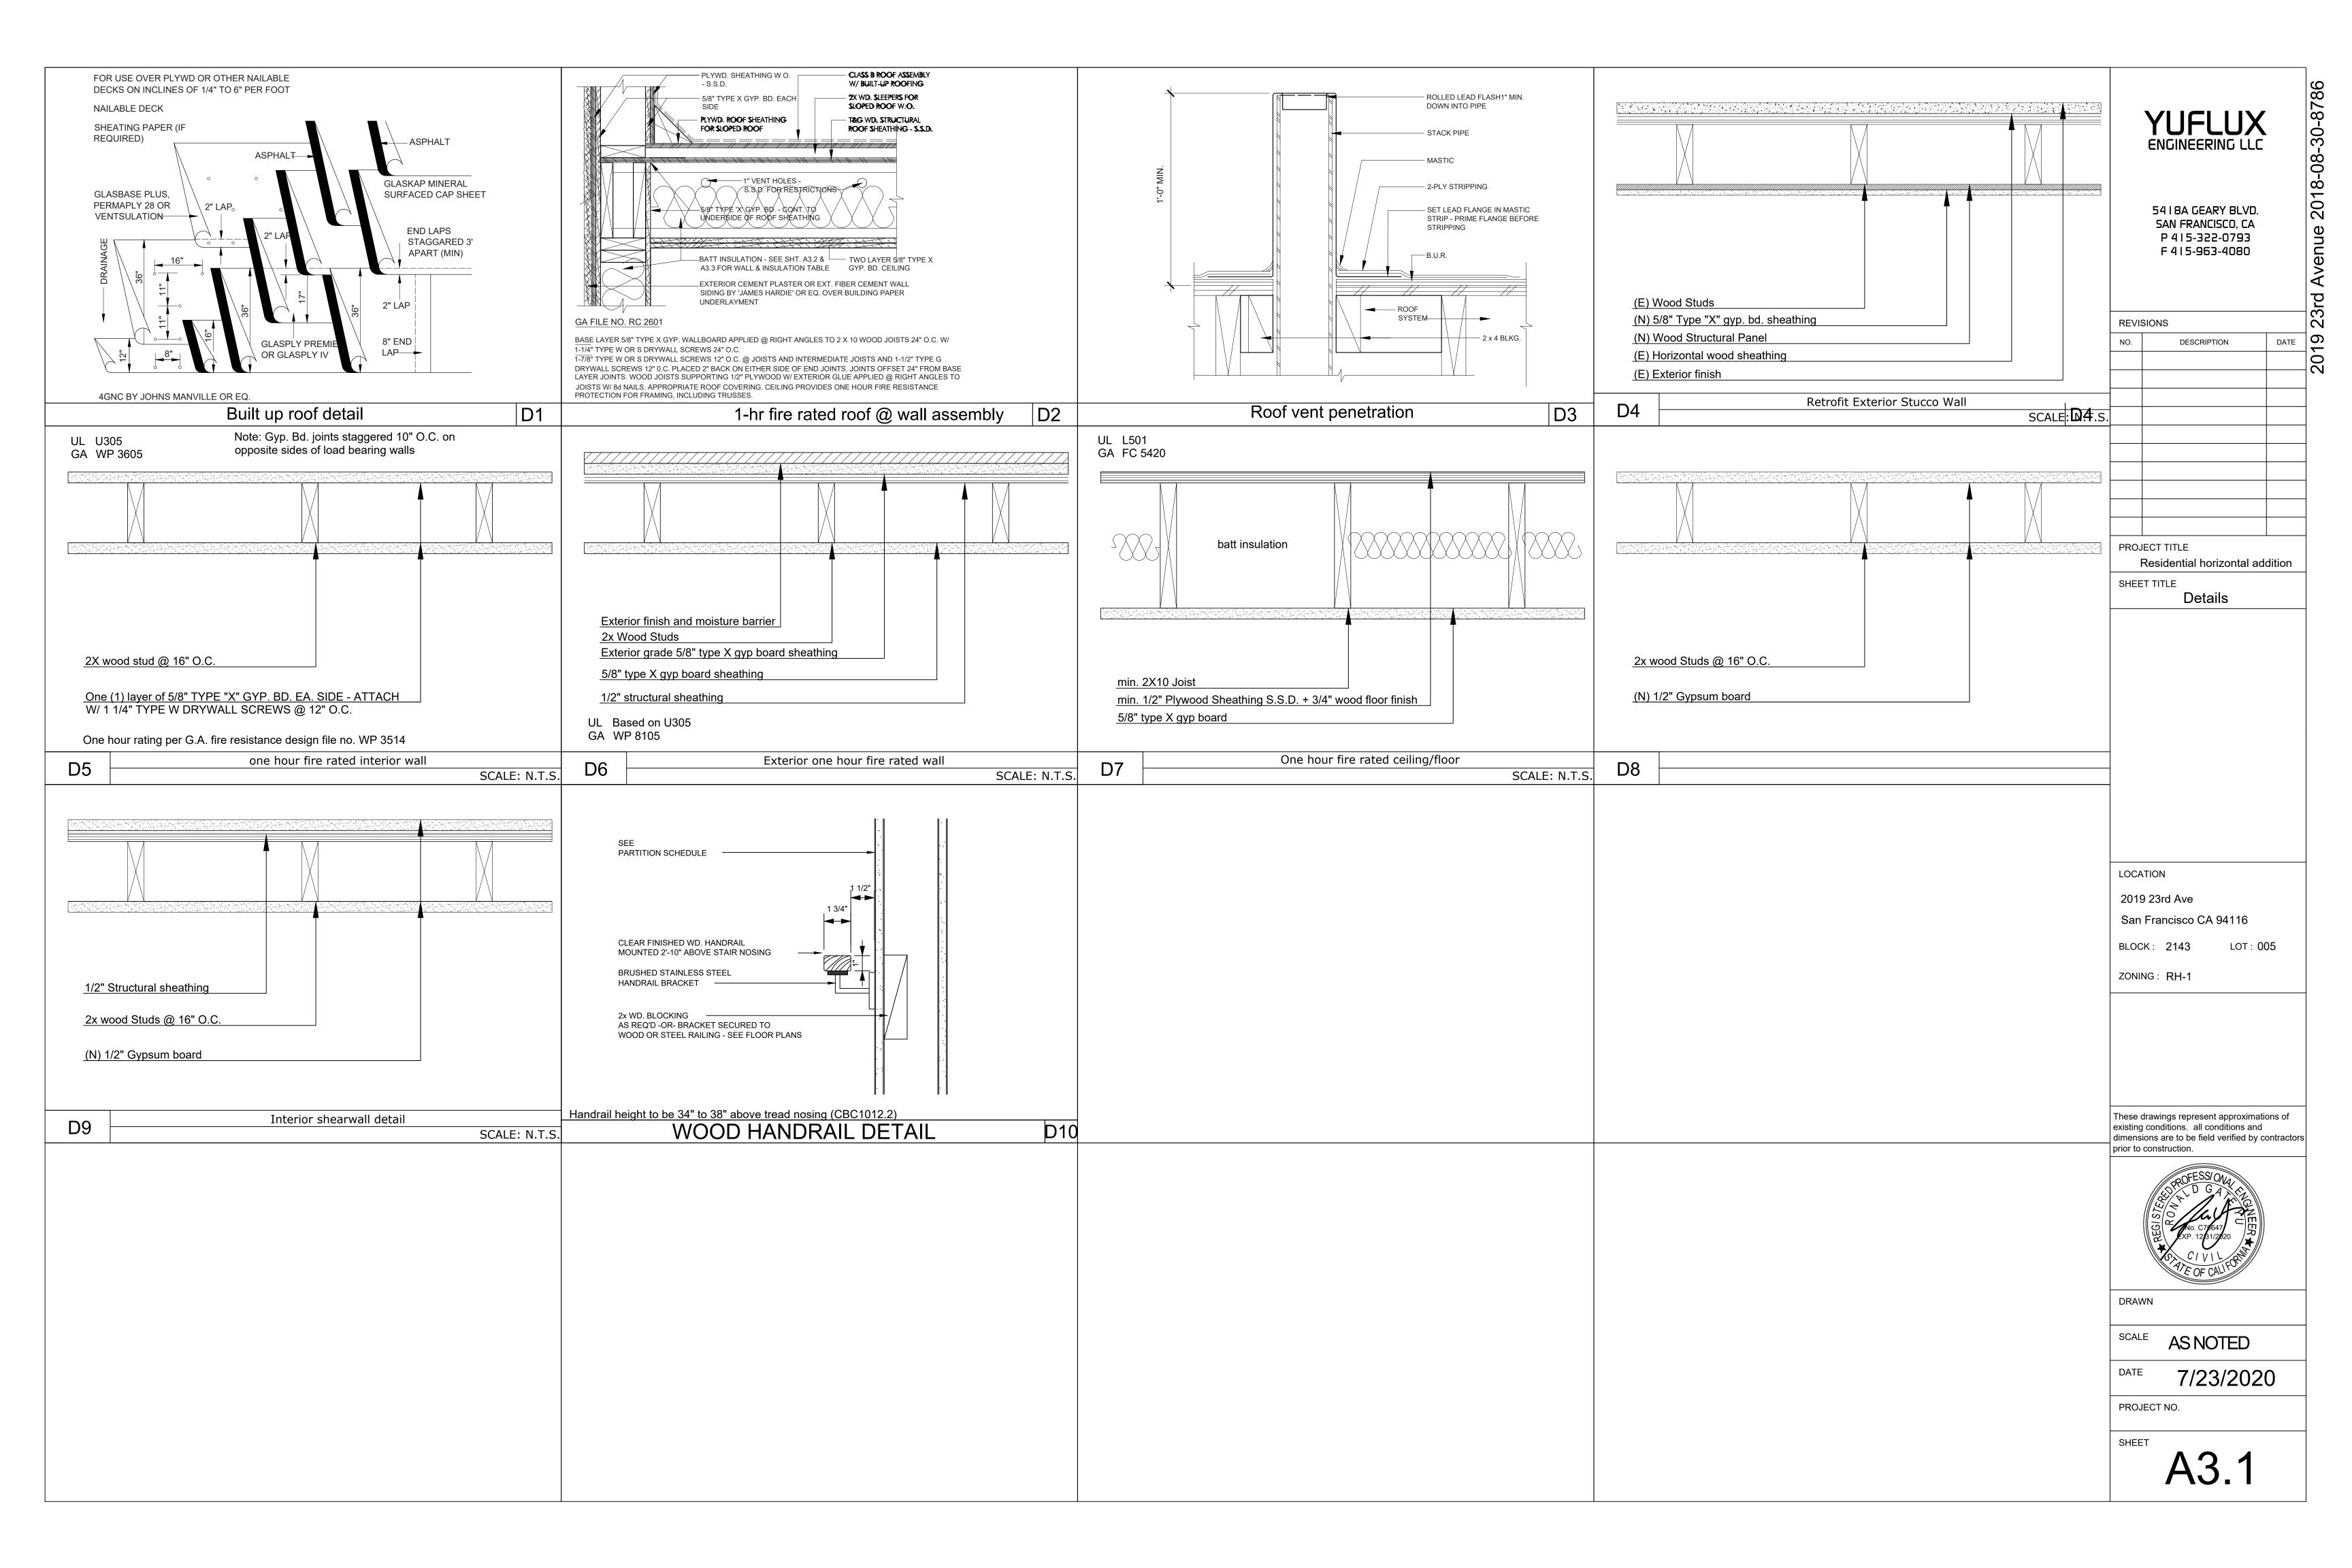

|                                |  | Project data  |   | Abbrevi                               | ations              |  |
|--------------------------------|--|---|---|---------------------------------------|---------------------|--|
| ADDRESS:                       | 2019 23rd Ave                                |   | ABV.<br>A.F.F.<br>ALC.                  | ABOVE<br>ABOVE FINISH FLOOR<br>ALCOVE | MTG.<br>MTL.<br>(N) | MOUNTING<br>METAL<br>NEW               |
| BLOCK                          | 2143   |   | ADJ.<br>ADJUST.                         | ADJACENT<br>ADJUSTABLE                | N.I.C.<br>N.T.S.    | NOT IN CONTRACT                        |
| LOT                            | 005  |   | ALUM.                                   | ALUMINUM                              | O/                  | OVER                                   |
| STORIES:                       | 2  |   | A.V.<br>B.O.                            | AUDIO-VISUAL<br>BOTTOM OF             | O.C.<br>O.H.        | ON CENTER<br>OPPOSITE HAND             |
|                                |  | One Family  | BD.<br>BLDG.                            | BOARD<br>BUILDING                     | OPNG.<br>OPP.       | OPENING<br>OPPOSITE                    |
| PRESENT USE:                   | Residential-House                            | e, One Family   | BTWN.<br>CAB.                           | BETWEEN<br>CABINET                    | O.S.C.I.            | OWNER SUPPLIED                         |
| OCCUPANCY:                     | R3   |   | C.G.                                    | CORNER GUARD                          | INS                 | TALLED                                 |
| TYPE:                          | 5B   |   | C.H.<br>C.J.                            | CLOTHES HOOK<br>CONTROL JOINT         | O.S.O.I.<br>& C     | OWNER SUPPLIE                          |
| ZONING:                        | RH-1   |   | C.L.<br>CLG.                            | CENTER LINE<br>CEILING                | INS<br>PART. BD     | TALLED<br>). PARTICLE BOARD            |
|                                |  |   | CLR.                                    | CLEAR                                 | PL.                 | PLATE                                  |
|                                | S  | Scope of work   | CNTR.<br>COL.                           | COUNTER<br>COLUMN                     | P. LAM.             | PLASTIC LAMINAT                        |
| ODIZONITAL ASSIST              |  | VIOTINO TWO OTODICO DEGIDENTIAL DUM DINO                      | CONC.<br>COND.                          | CONCRETE<br>CONDITION                 | PLCB.               | PLASTIC<br>LAMINATE CABINI             |
| ORIZONTAL ADDITI               | ON AT REAR OF E                              | XISTING TWO STORIES RESIDENTIAL BUILDING.                     | CONT.                                   | CONTINUOUS<br>CONSTRUCTION            | PNL.<br>P.T.        | PANEL<br>PAPER TOWEL                   |
|                                |  |   | CPT.                                    | CARPET                                |                     | DISPENSER                              |
|                                |  |   | C.S.C.I                                 | CONTRACTOR SUPPLIED &                 | PTD.<br>RAD.        | PAINTED<br>RADIUS                      |
|                                |  |   |   | CONTRACTOR<br>INSTALLED               | REINF.<br>REQ'D.    | REINFORCE<br>REQUIRED                  |
|                                |  |   | CTR.                                    | CENTER                                | RESIL.              | RESILIENT                              |
|                                |  |   | DBL.<br>DEMO.                           | DOUBLE<br>DEMOLITION                  | R.C.P.              | REFLECTED<br>CEILING PLAN              |
|                                |  |   | DIM.<br>DISP.                           | DIMENSION<br>DISPENSER                | RM.<br>R.O.         | ROOM<br>ROUGH OPENING                  |
|                                |  |   | DN.                                     | DOWN                                  | R.O.S.              | ROLL OUT SHELF                         |
|                                |  |   | DR.<br>DTL.                             | DOOR<br>DETAIL                        | S&P<br>S.D.         | SHELF AND POLE SOAP DISPENSEF          |
|                                |  |   | DWG. DWR.                               | DRAWING<br>DRAWER                     | SIM.<br>SHT.        | SIMILAR<br>SHEET                       |
|                                | F  | Project notes   | (E)<br>EA.                              | EXISTING<br>EACH                      | S.C.D.              | SEE CIVIL<br>ENGINEERING               |
| Area/floor                     | Existing (ft <sup>2</sup> )                  | Proposed (ft²) Change (ft²)                                   | EL.<br>ELEC.<br>ENCL.                   | ELEVATION<br>ELECTRICAL<br>ENCLOSED   | S.E.D.              | DRAWINGS<br>SEE ELECTRICAL<br>DRAWINGS |
| Living                         | 753  | 1798 1,045  | EQ.<br>EQUIP.                           | EQUAL<br>EQUIPMENT                    | S.L.D.              | SEE LANDSCAPE<br>DRAWINGS              |
| Car parking                    | 1  | 1   | EXPAN.                                  | EXPANSION                             | S.M.D.              | SEE MECHANICA                          |
|                                | -  |   | EXT.<br>FAB.                            | EXTERIOR<br>FABRICATION               | S.P.D.              | DRAWINGS<br>SEE PLUMBING               |
| Bike parking                   | 0  | 1   | F.D.<br>F.F.                            | FLOOR DRAIN<br>FINISH FLOOR           | SPECS.              | DRAWINGS<br>SPECIFICATIONS             |
| Landscaping req.               | 0  | { (10.08*6.5)/(10.08*25)= 65.54 / 252 = 26% > (50.4 f         | <sup>2</sup> )20% <b>}</b> FEC.<br>FIN. | FIRE EXT. CABINET FINISH              | SQ. IN.<br>SQ. FT.  | SQUARE INCHES<br>SQUARE FEET           |
|                                | 0  | \\\\\\\\\\\\\\\\\\\\\\\\\\\\\\\\\\\\\\                        | } FLR.                                  | FLOOR                                 | S.S.                | STAINLESS STEE                         |
| Permeable surface              | 0  | (10.08*17)/(10.08*25)= 171/252 68% >(126 ft²)50% rd           | F.O.                                    | FLUORESCENT<br>FACE OF                | S.S.D.              | SEE<br>STRUCTURAL                      |
|                                |  |   | F.T.<br>F.S.                            | FEET<br>FIRE SHUTTER                  | ST. STL.            | DRAWINGS<br>STAINLESS STEE             |
| *No existing sprinkle          | er and no proposed                           | sprinkler systems   | GA.<br>G.B.                             | GAUGE<br>GRAB BAR                     | STL.<br>STN.        | STEEL<br>STATION                       |
|                                | C  | Seneral notes   | G.D.                                    | GARBAGE DISPOSAL                      | SUSP.               | SUSPENDED                              |
|                                |  |   | G.C.                                    | GENERAL<br>CONTRACTOR                 | T.<br>TEL.          | TEMPERED GLAS TELEPHONE                |
| •                              |  | ance with the adopted codes, standards and any applicable s   | GL.<br>GYP. BD.                         | GLASS<br>GYPSUM BOARD                 | TEMP.<br>T.O.       | TEMPERED<br>TOP OF                     |
| or local amendments,<br>1.1. ( |  | mited to:<br>and health standards, (CAL OSHA).                | H.C.                                    | HANDICAPPED<br>HEIGHT                 | TYP.<br>U.N.        | TYPICAL<br>UNLESS                      |
|                                | •  | ppliances, equipment and materials (underwriters laboratories | . INT.                                  | INTERIOR                              |                     | OTHERWISE NOT                          |
|                                | • • • • •                                    | nt listing (factory mutual).                                  | INSUL.<br>JT.                           | INSULATED<br>JOINT                    | V.A.T.              | VINYL ACOUSTIC<br>TILE                 |
|                                | Handbook of rigging<br>Safety code for build | ding construction, ANSI.                                      | K.S.                                    | KNEE SPACE<br>LOCKER                  | V.I.F.<br>W/        | VERIFY IN FIELD<br>WITH                |
|                                |  | Code, 2016 edition.   | LOC.                                    | LOCATION                              | W.C.                | WATER CLOSET                           |
|                                | California Electrical<br>California Energy C | Code, 2016 edition. ode, 2016 edition.                        | MAG.<br>MAX.                            | MAGNETIC<br>MAXIMUM                   | WD.<br>WDW          | WOOD<br>WINDOW                         |
| 1.9.                           | California Fire code                         | , 2016 edition.   | MECH.<br>MIN.                           | MECHANICAL<br>MINIMUM                 | W/O.<br>W.O.        | WITHOUT WHERE OCCURS                   |
|                                |  | al code, 2016 edition.<br>code, 2016 edition.                 | MOS.                                    | MOTION SENSOR                         | vv.U.               | WILLIAM OCCURS                         |
|                                |  | ed Standards code, 2016 edition.                              | MTD.                                    | MOUNTED                               |                     |  |

California Referenced Standards code, 2016 edition. California Energy Efficiency standards, 2016 edition.

2. Where differences exist between codes affecting this work, the more restrictive code shall govern.

3. If the contractors observe that these drawings and specifications are in variance with the codes, he

4. Ductwork, piping and equipment shall be installed per smacna "seismic restraint manual guidelines for

mechanical systems addendum no. 1 or equal in accordance with asce chapter 13 "seismic design

5. All fire-rated wall and floor penetrations shall be firesafed utilizing a ul approved fire safing systems.

6. All plumbing and piping systems shall be pressure tested and verified leak tight prior to calling for city

7. These drawings represent approximations of existing conditions. all conditions and dimensions are to

San Francisco Building Code

shall notify the architects and engineers in writing at once.

requirements for non-structural components".

be field verified by contractors prior to construction.

progress or final inspections.

Site plans

Floor plans

Roof plans

Elevations

Elevations

Architectural details

Structural notes

Structural notes

Structural plans

Structural details

Structural details

Structural details

Structural details

Section

A1.2

A2.1 A2.2 A2.3

A2.4

A2.5 A3.1

S1.1

S1.2

S2.1

S3.1

S3.2

S3.3

Sheet index

Notes, Legend, Scope of Work

# 2019 23rd Ave San Francisco CA 94116

|                      | Demolition Cal | culation  |           |
|----------------------|----------------|-----------|-----------|
| Lin                  | ear footage me | asurement |           |
| Element              | (E) Length     | Removed   | % Removed |
| Front Façade         | 25'0"          | 0'-0"     | 0%        |
| Rear Façade          | 25'0"          | 20'0"     | 80%       |
| Left side elevation  | 31'8"          | 0'-0"     | 0%        |
| Right side elevation | 31'8"          | 0'-0"     | 0%        |
| Total                | 113'4"         | 20'0"     | 18%       |
| Ar                   | ea footage mea | surement  |           |
| Vertical elements    | (E) Length     | Removed   | % Removed |
| Front Façade         | 440            | 0         | 0%        |
| Rear Façade          | 440            | 352       | 80%       |
| Left side elevation  | 557            | 0         | 0%        |
| Right side elevation | 557            | 0         | 0%        |
| Total                | 1994           | 352       | 18%       |
| Horizontal Elements  | (E) Length     | Removed   | % Removed |
| Second floor         | 792            | 0         | 0         |
| Ground floor         | 792            | 0         | 0         |
| Total                | 1584           | 0         | 0         |

| 0   | F04 |
|-----|-----|
| U   | 504 |
| 530 | 700 |
| 530 | 700 |
|     | 530 |



5418A GEARY BLVD. SAN FRANCISCO, CA P 415-322-0793 F 4 I 5-963-4080

| REVIS | SIONS              |           |
|-------|--------------------|-----------|
| NO.   | DESCRIPTION        | DATE      |
| 1     | Site permit update | 3/22/2021 |
|       |                    |           |
|       |                    |           |
| PROJ  | ECT TITLE          |           |

Residential horizontal addition

General notes


LOCATION

2019 23rd Ave

San Francisco CA 94116 BLOCK: 2143 LOT: 005

ZONING: RH-1


These drawings represent approximations of existing conditions. all conditions and dimensions are to be field verified by contractors

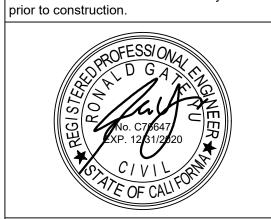


DRAWN

**AS NOTED** 

7/23/2020

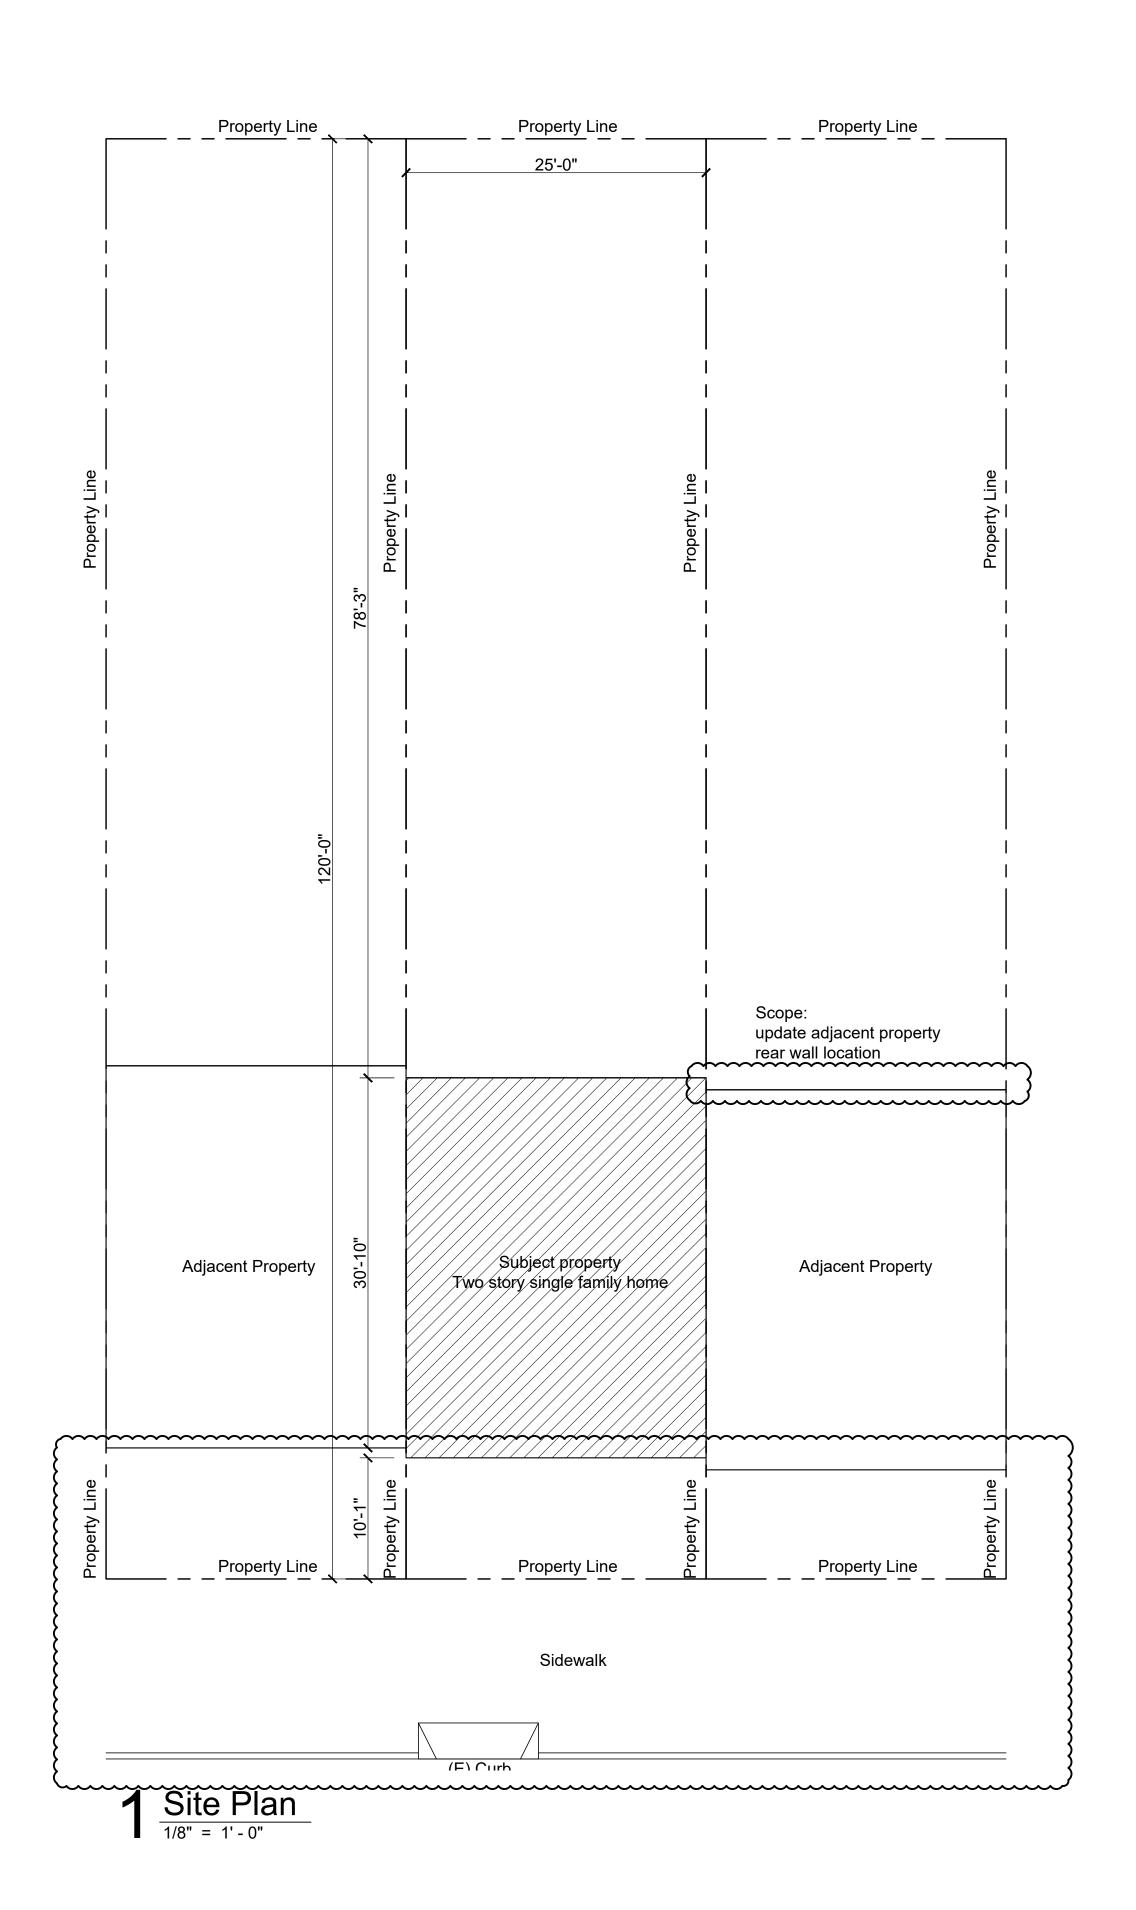

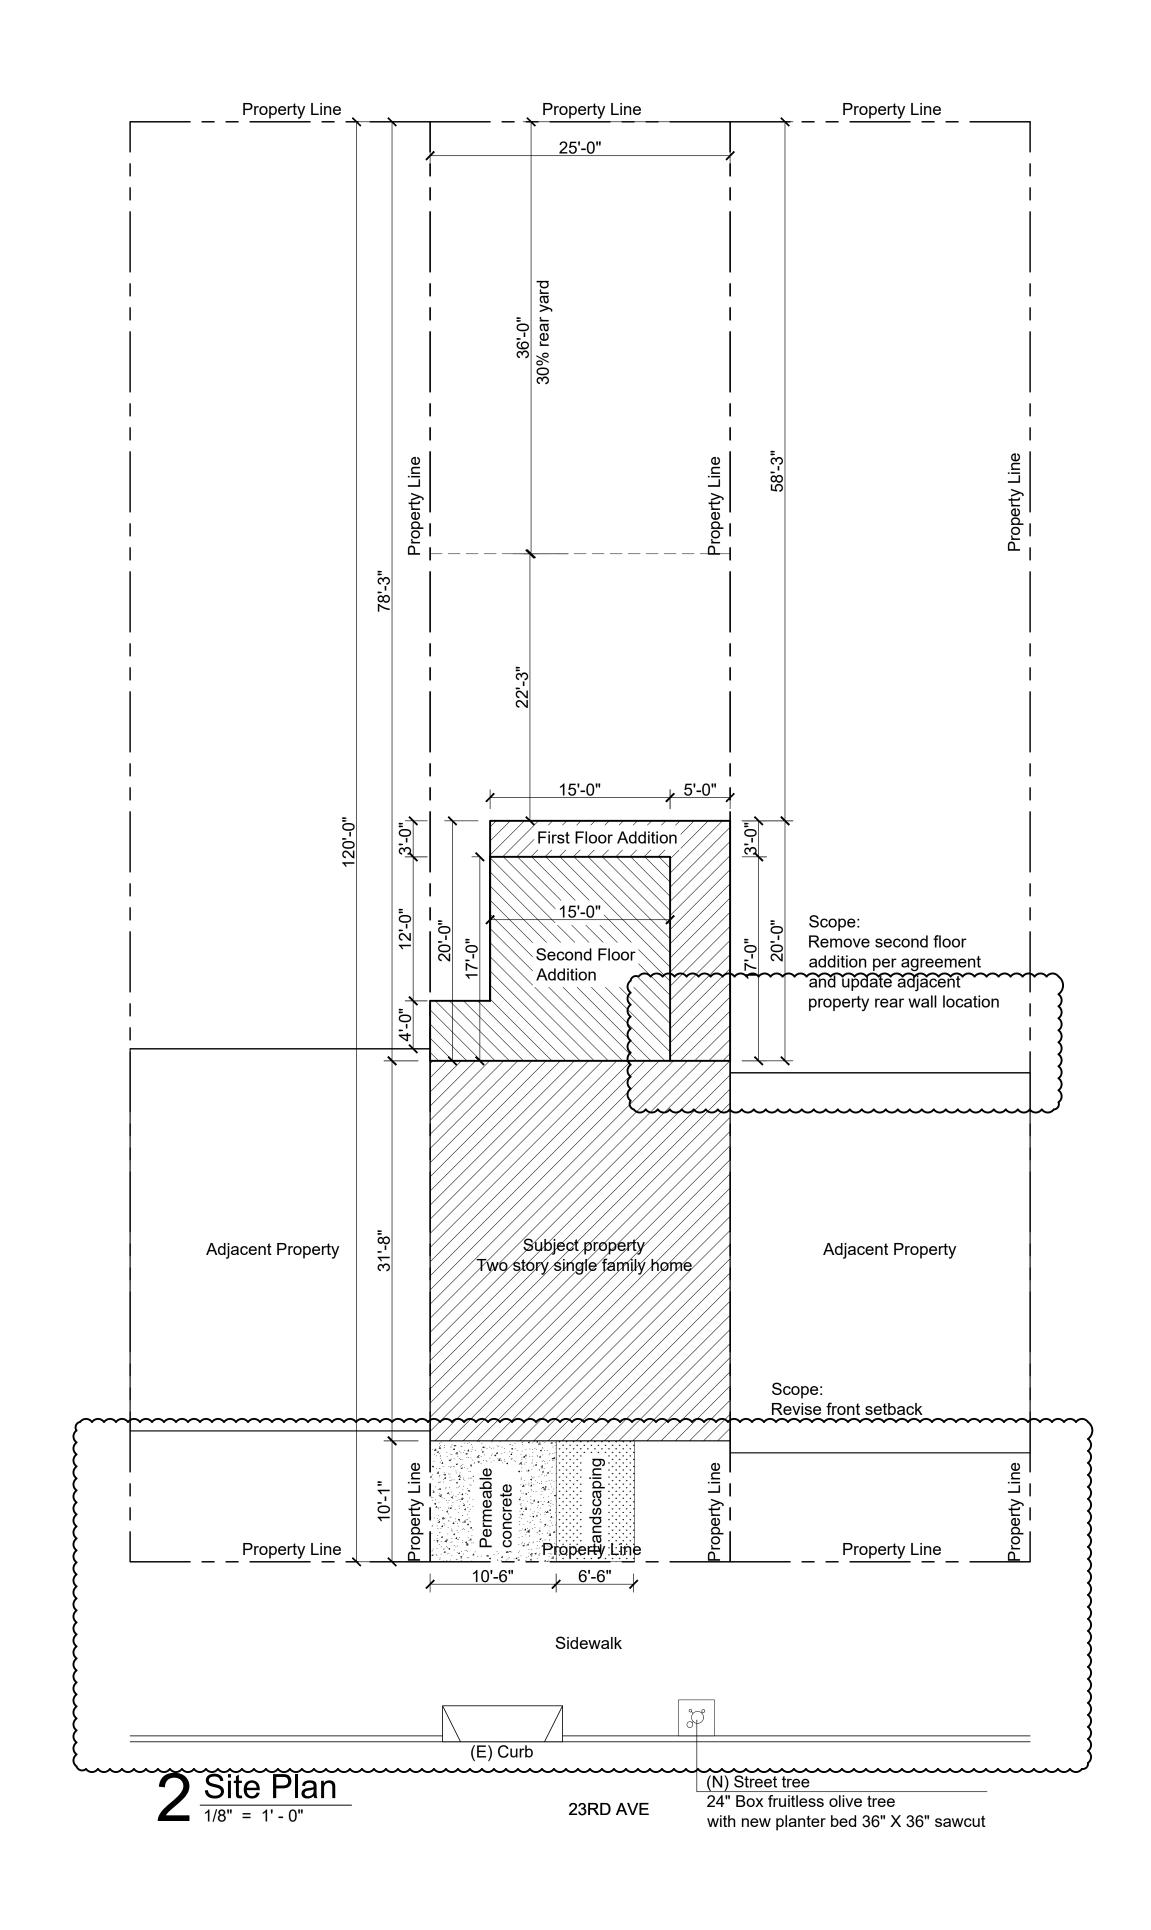



5418A GEARY BLVD. SAN FRANCISCO, CA P 415-322-0793 F 415-963-4080

REVISIONS

| NO. | DESCRIPTION        | DATE      |
|-----|--------------------|-----------|
| 1   | Site permit update | 3/22/2021 |
|     |                    |           |
|     |                    |           |
PROJECT TITLE

Residential horizontal addition

SHEET TITLE
Site Plans

LOCATION

2019 23rd Ave


San Francisco CA 94116

LOT: 005

ZONING: RH-1

BLOCK: 2143

These drawings represent approximations of existing conditions. all conditions and dimensions are to be field verified by contractors prior to construction.

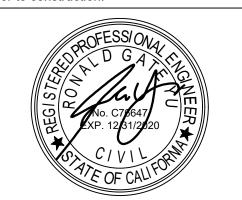

DRAWN

SCALE AS NOTED


DATE 7/23/2020


\_\_\_\_\_

PROJECT NO.

A1.2



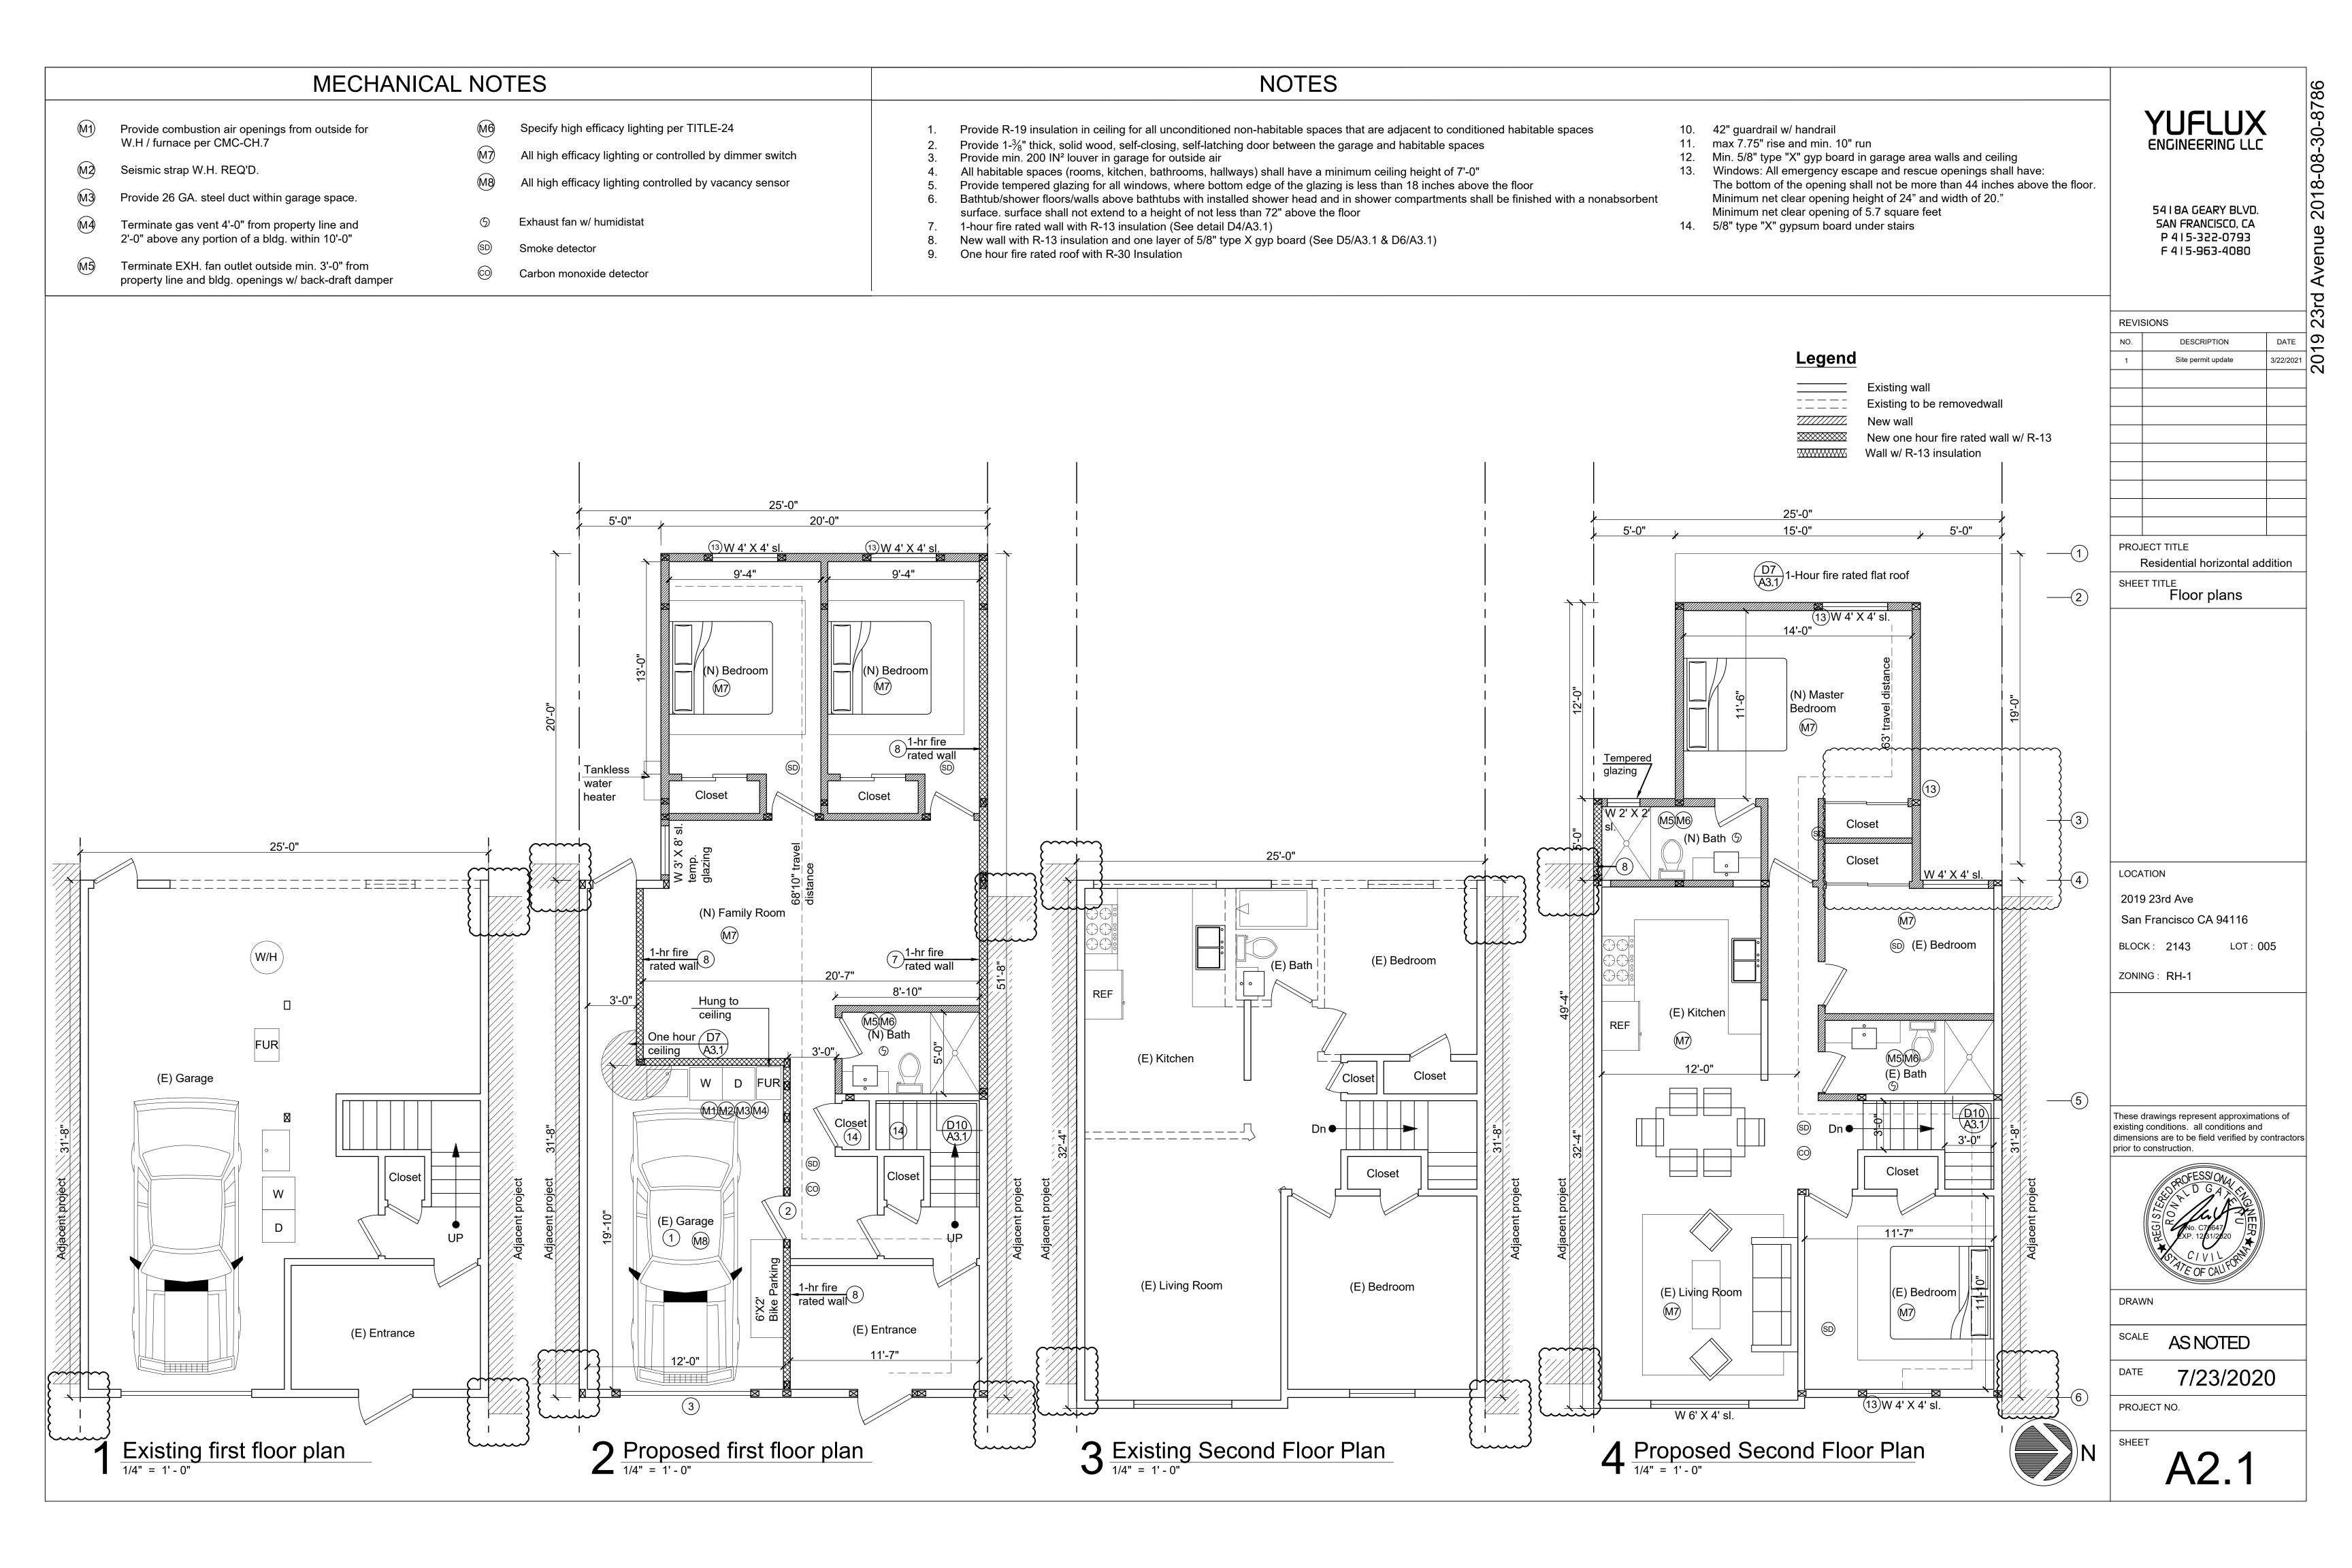

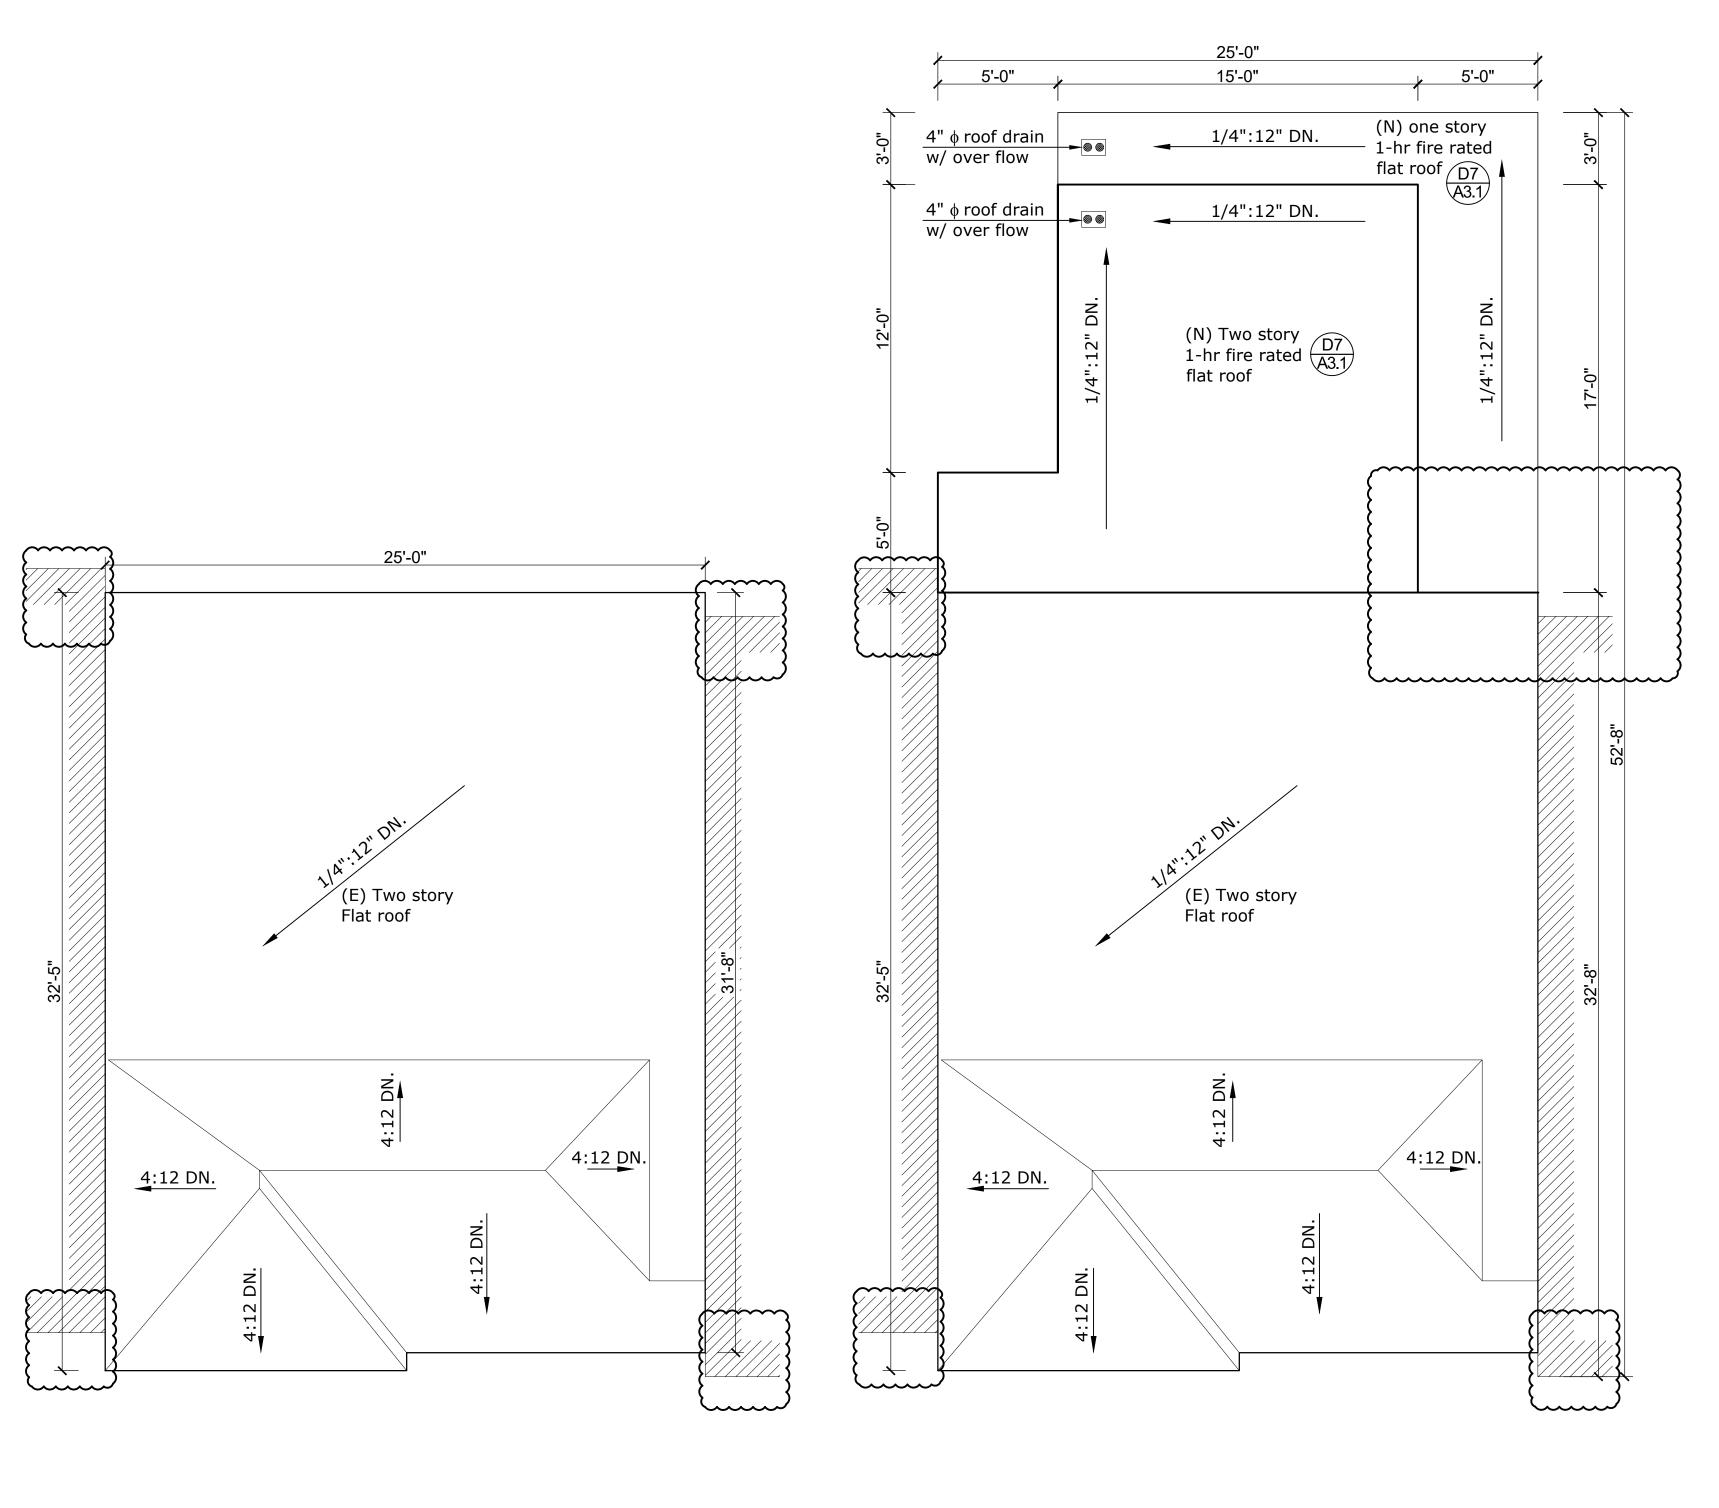

1 Existing roof plans  $\frac{1}{1/4"} = 1' - 0"$ 

 $2^{\frac{\text{Proposed roof plans}}{1/4" = 1' - 0"}}$ 

YUFLUX ENGINEERING LLC

5418A GEARY BLVD. SAN FRANCISCO, CA P 415-322-0793 F 415-963-4080

Avenue 2018-08-30-8786

|                          | DATE<br>3/22/202 |
|--------------------------|------------------|
| 1 Site permit update 3/2 | 3/22/202         |
|                          |                  |
|                          |                  |
PROJECT TITLE

Residential horizontal addition

SHEET TITLE Roof plans

LOCATION


2019 23rd Ave

LOT: 005 BLOCK: 2143

San Francisco CA 94116

ZONING: RH-1

These drawings represent approximations of existing conditions. all conditions and dimensions are to be field verified by contractors prior to construction.

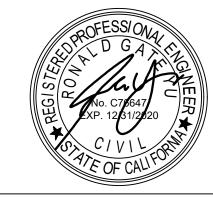

DRAWN

**AS NOTED** 

7/23/2020



|      | YUFLUX ENGINEERING LLC   |           | 3-08-30-8786                     |
|------|--|-----------|----------------------------------|
|      | 5418A GEARY BLVD.<br>SAN FRANCISCO, CA<br>P 415-322-0793<br>F 415-963-4080 |           | 2019 23rd Avenue 2018-08-30-8786 |
| REVI | SIONS  |           | 23                               |
| NO.  | DESCRIPTION  | DATE      | 19                               |
| 1    | Site permit update   | 3/22/2021 | 20                               |
|      |  |           |                                  |
|      |  |           |                                  |
|      |  |           |                                  |
|      |  |           |                                  |
|      |  |           | <u> </u>                         |
|      |  |           |                                  |
|      |  |           |                                  |
| PRO  | IECT TITLE   |           |                                  |

PROJECT TITLE

Residential horizontal addition

SHEET TITLE
Elevations


LOCATION

2019 23rd Ave San Francisco CA 94116

LOT: 005 BLOCK: 2143


ZONING: RH-1


These drawings represent approximations of existing conditions. all conditions and dimensions are to be field verified by contractors prior to construction.

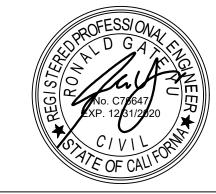


**AS NOTED** 

7/23/2020

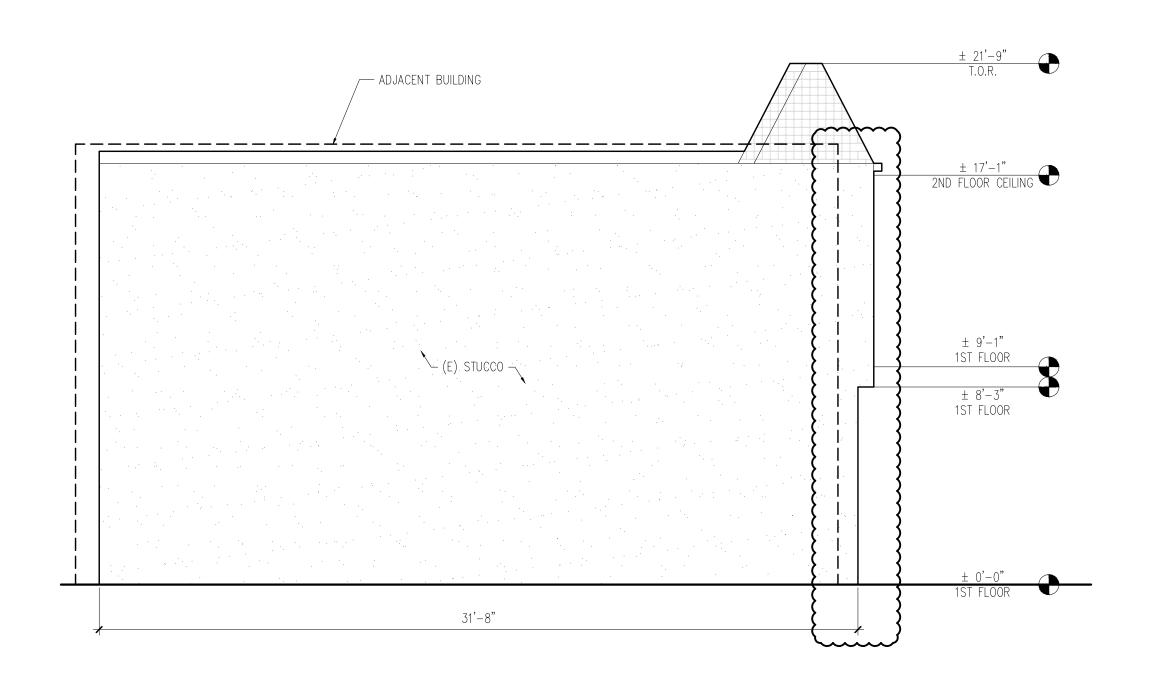

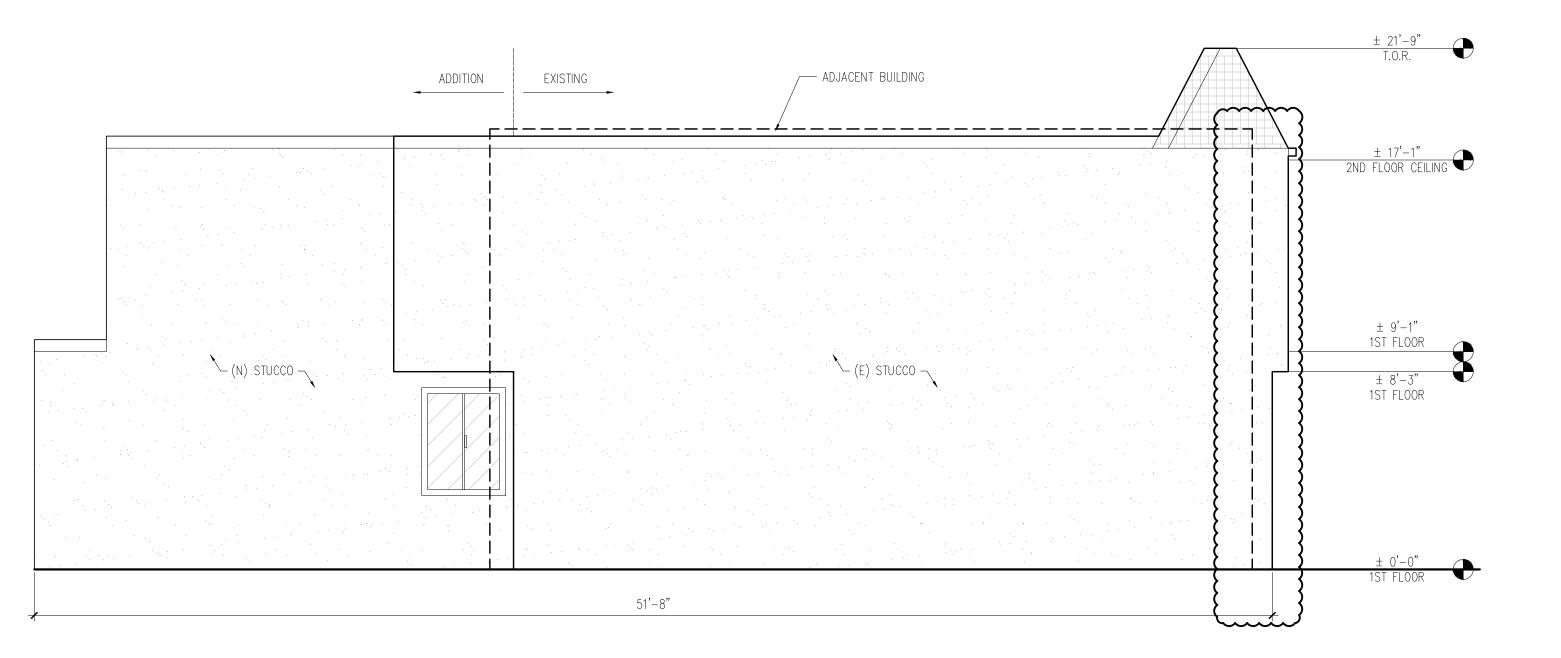


# 1 Existing left elevation 1/4" = 1' - 0" \*South elevation

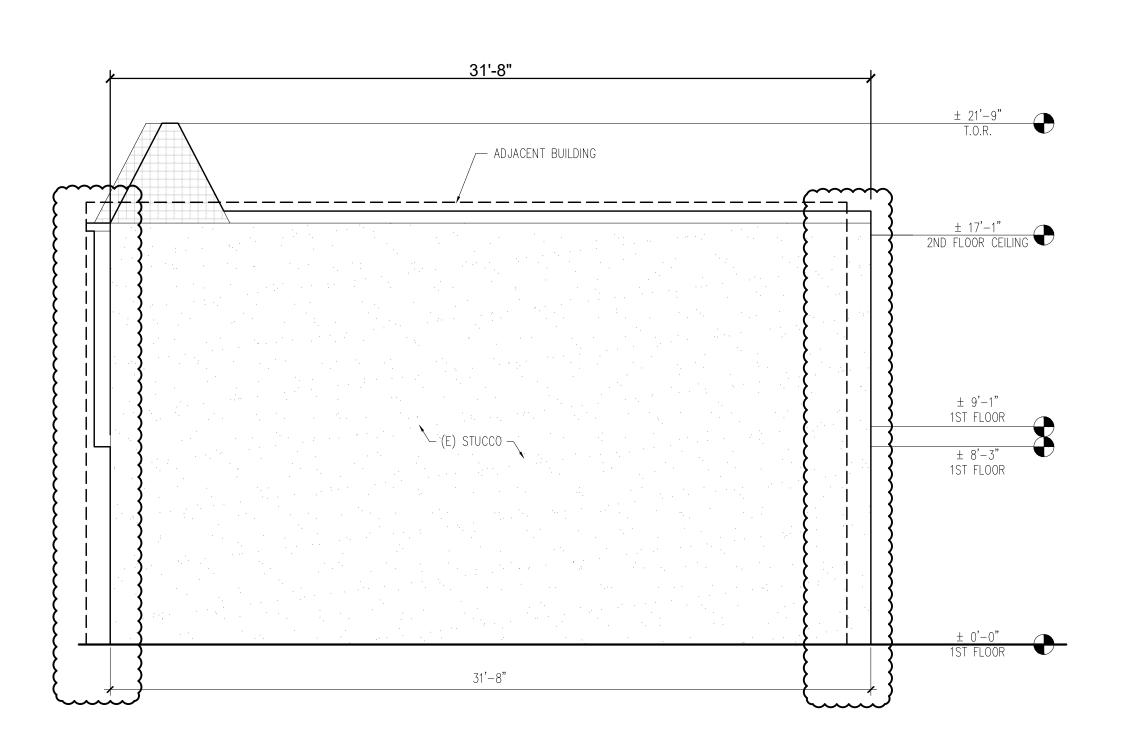

Proposed left elevation

1/4" = 1' - 0" \*South elevation

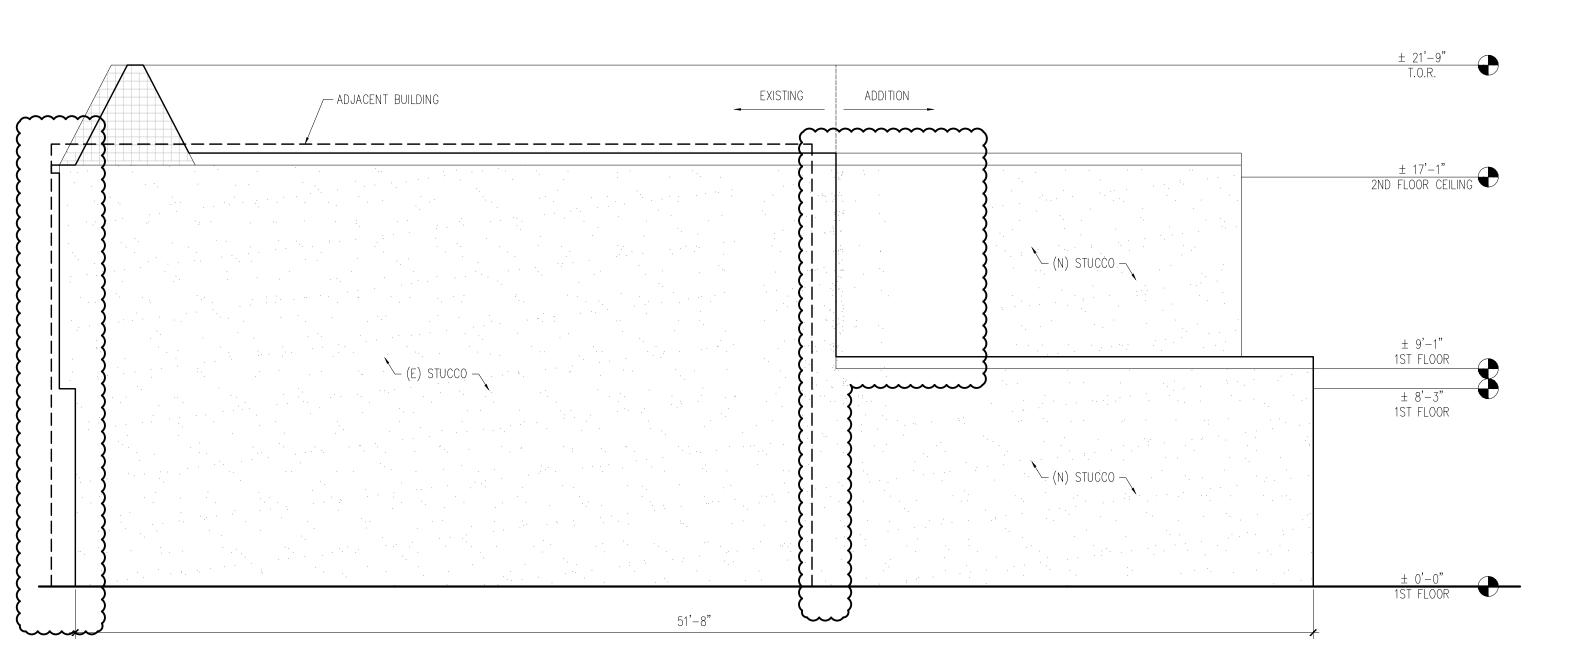

3 Existing right elevation

1/4" = 1' - 0" \*North elevation

Proposed right elevation

1/4" = 1' - 0" \*North elevation

|     | YUFLUX ENGINEERING LLC   |           | 18-08-30-8786                    |
|-----|--|-----------|----------------------------------|
|     | 5418A GEARY BLVD.<br>SAN FRANCISCO, CA<br>P 415-322-0793<br>F 415-963-4080 |           | 2019 23rd Avenue 2018-08-30-8786 |
|     | SIONS  |           | 92                               |
| NO. | DESCRIPTION  | DATE      | 7                                |
| 1   | Site permit update   | 3/22/2021 | 20                               |
|     |  |           |                                  |
|     |  |           |                                  |
|     | TEAT TITLE   | <u> </u>  |                                  |

PROJECT TITLE Residential horizontal addition

SHEET TITLE

Elevations

LOCATION


2019 23rd Ave

LOT: 005 BLOCK: 2143

San Francisco CA 94116

ZONING: RH-1

These drawings represent approximations of existing conditions. all conditions and dimensions are to be field verified by contractors prior to construction.

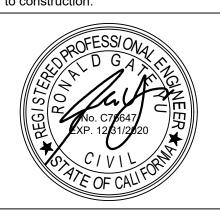


DRAWN


**AS NOTED** 

7/23/2020


PROJECT NO.


A2.4

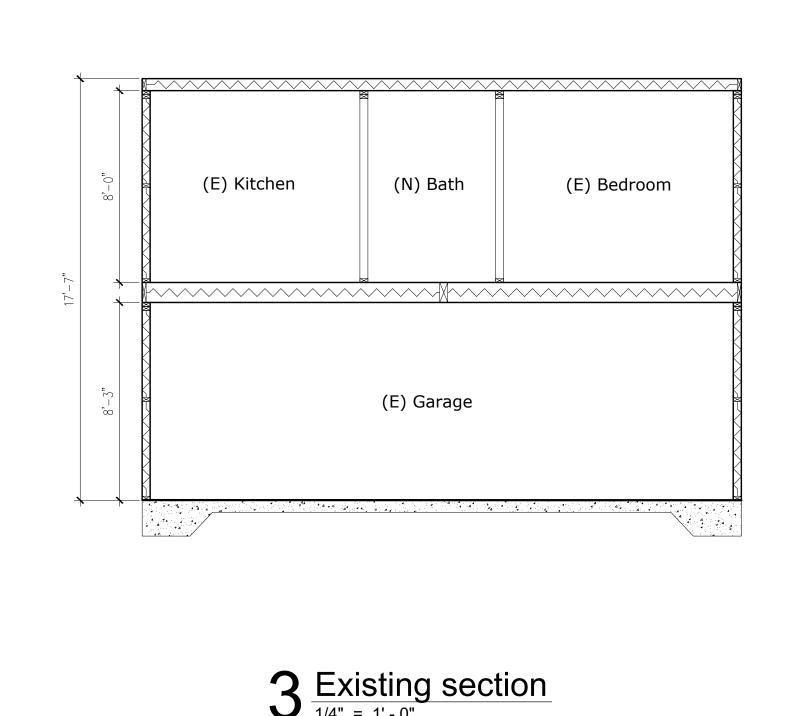

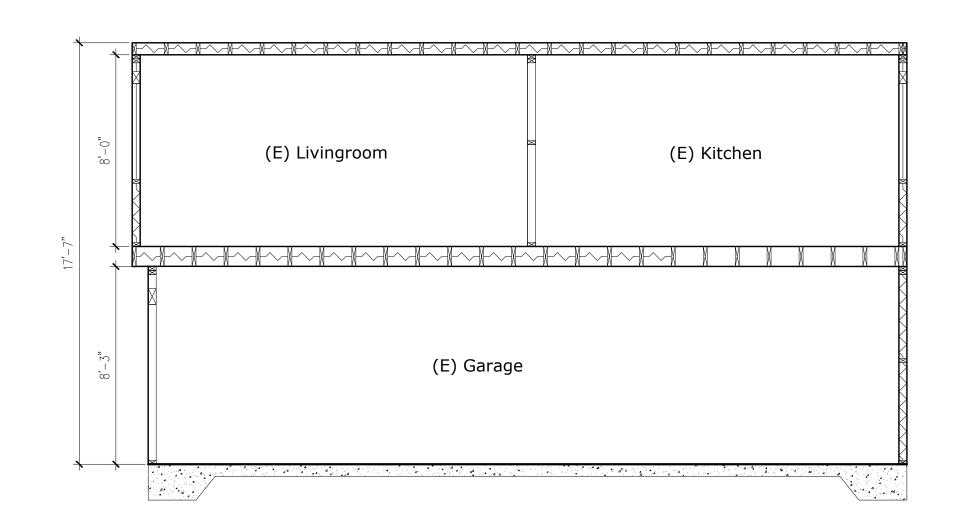


3 Existing section  $\frac{1}{4} = \frac{1}{0}$ 

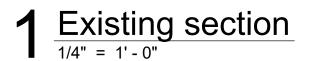


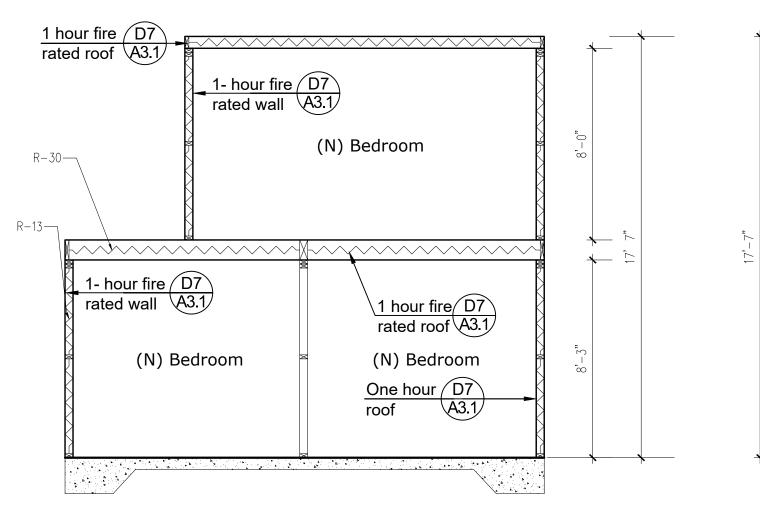

 $5_{\frac{1/4" = 1' - 0"}{}}$ 

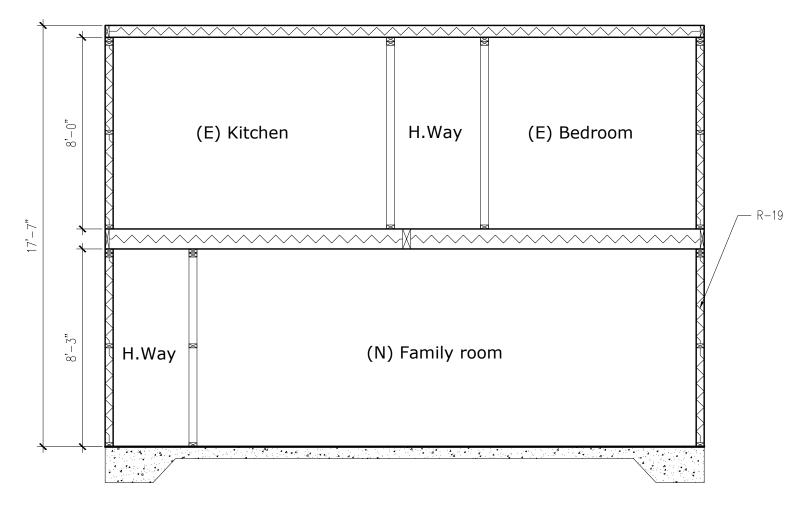

 $4 \frac{\text{New section}}{\frac{1}{4} = \frac{1}{0} = 0}$ 

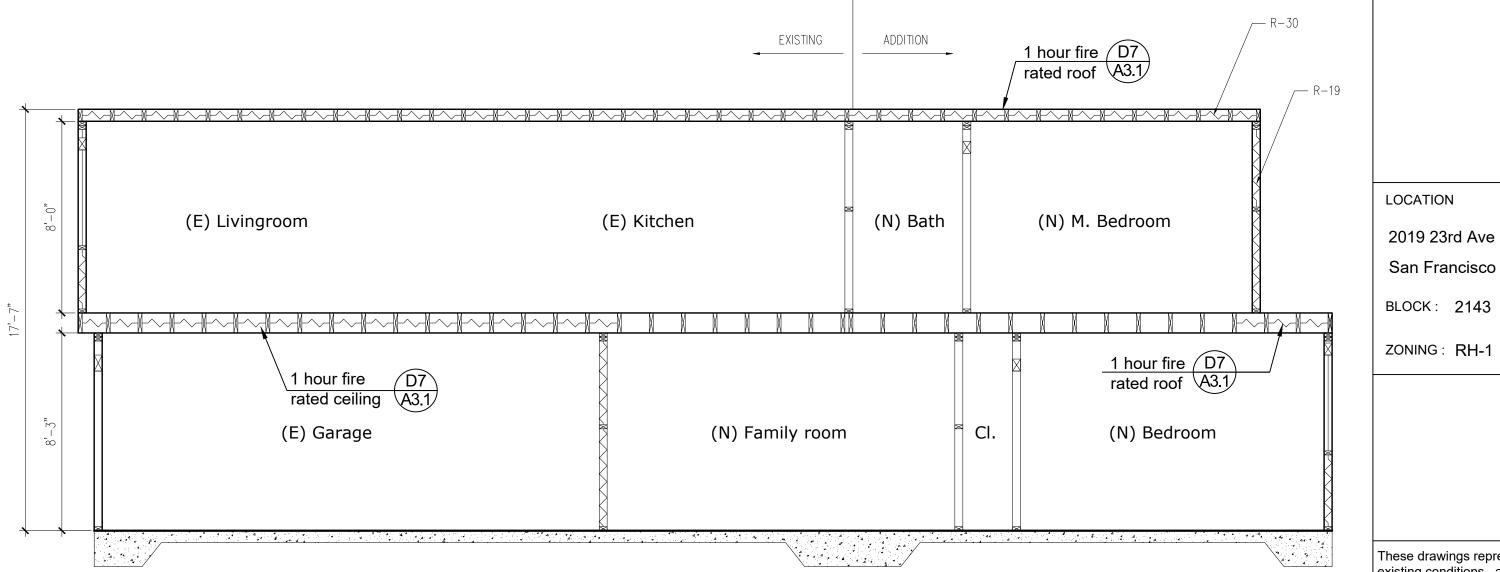

 $2^{\frac{\text{New section}}{1/4" = 1' - 0"}}$ 

YUFLUX ENGINEERING LLC

5418A GEARY BLVD. SAN FRANCISCO, CA P 415-322-0793 F 4 I 5-963-4080


Avenue 2018-08-30-8786

REVISIONS DESCRIPTION Site permit update PROJECT TITLE

Residential horizontal addition SHEET TITLE Sections

LOCATION 2019 23rd Ave San Francisco CA 94116 LOT: 005 BLOCK: 2143

These drawings represent approximations of existing conditions. all conditions and dimensions are to be field verified by contractors prior to construction.

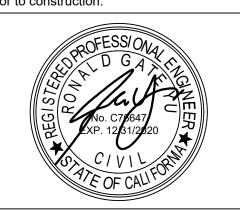


DRAWN

**AS NOTED** 

7/23/2020

PROJECT NO.

A2.5

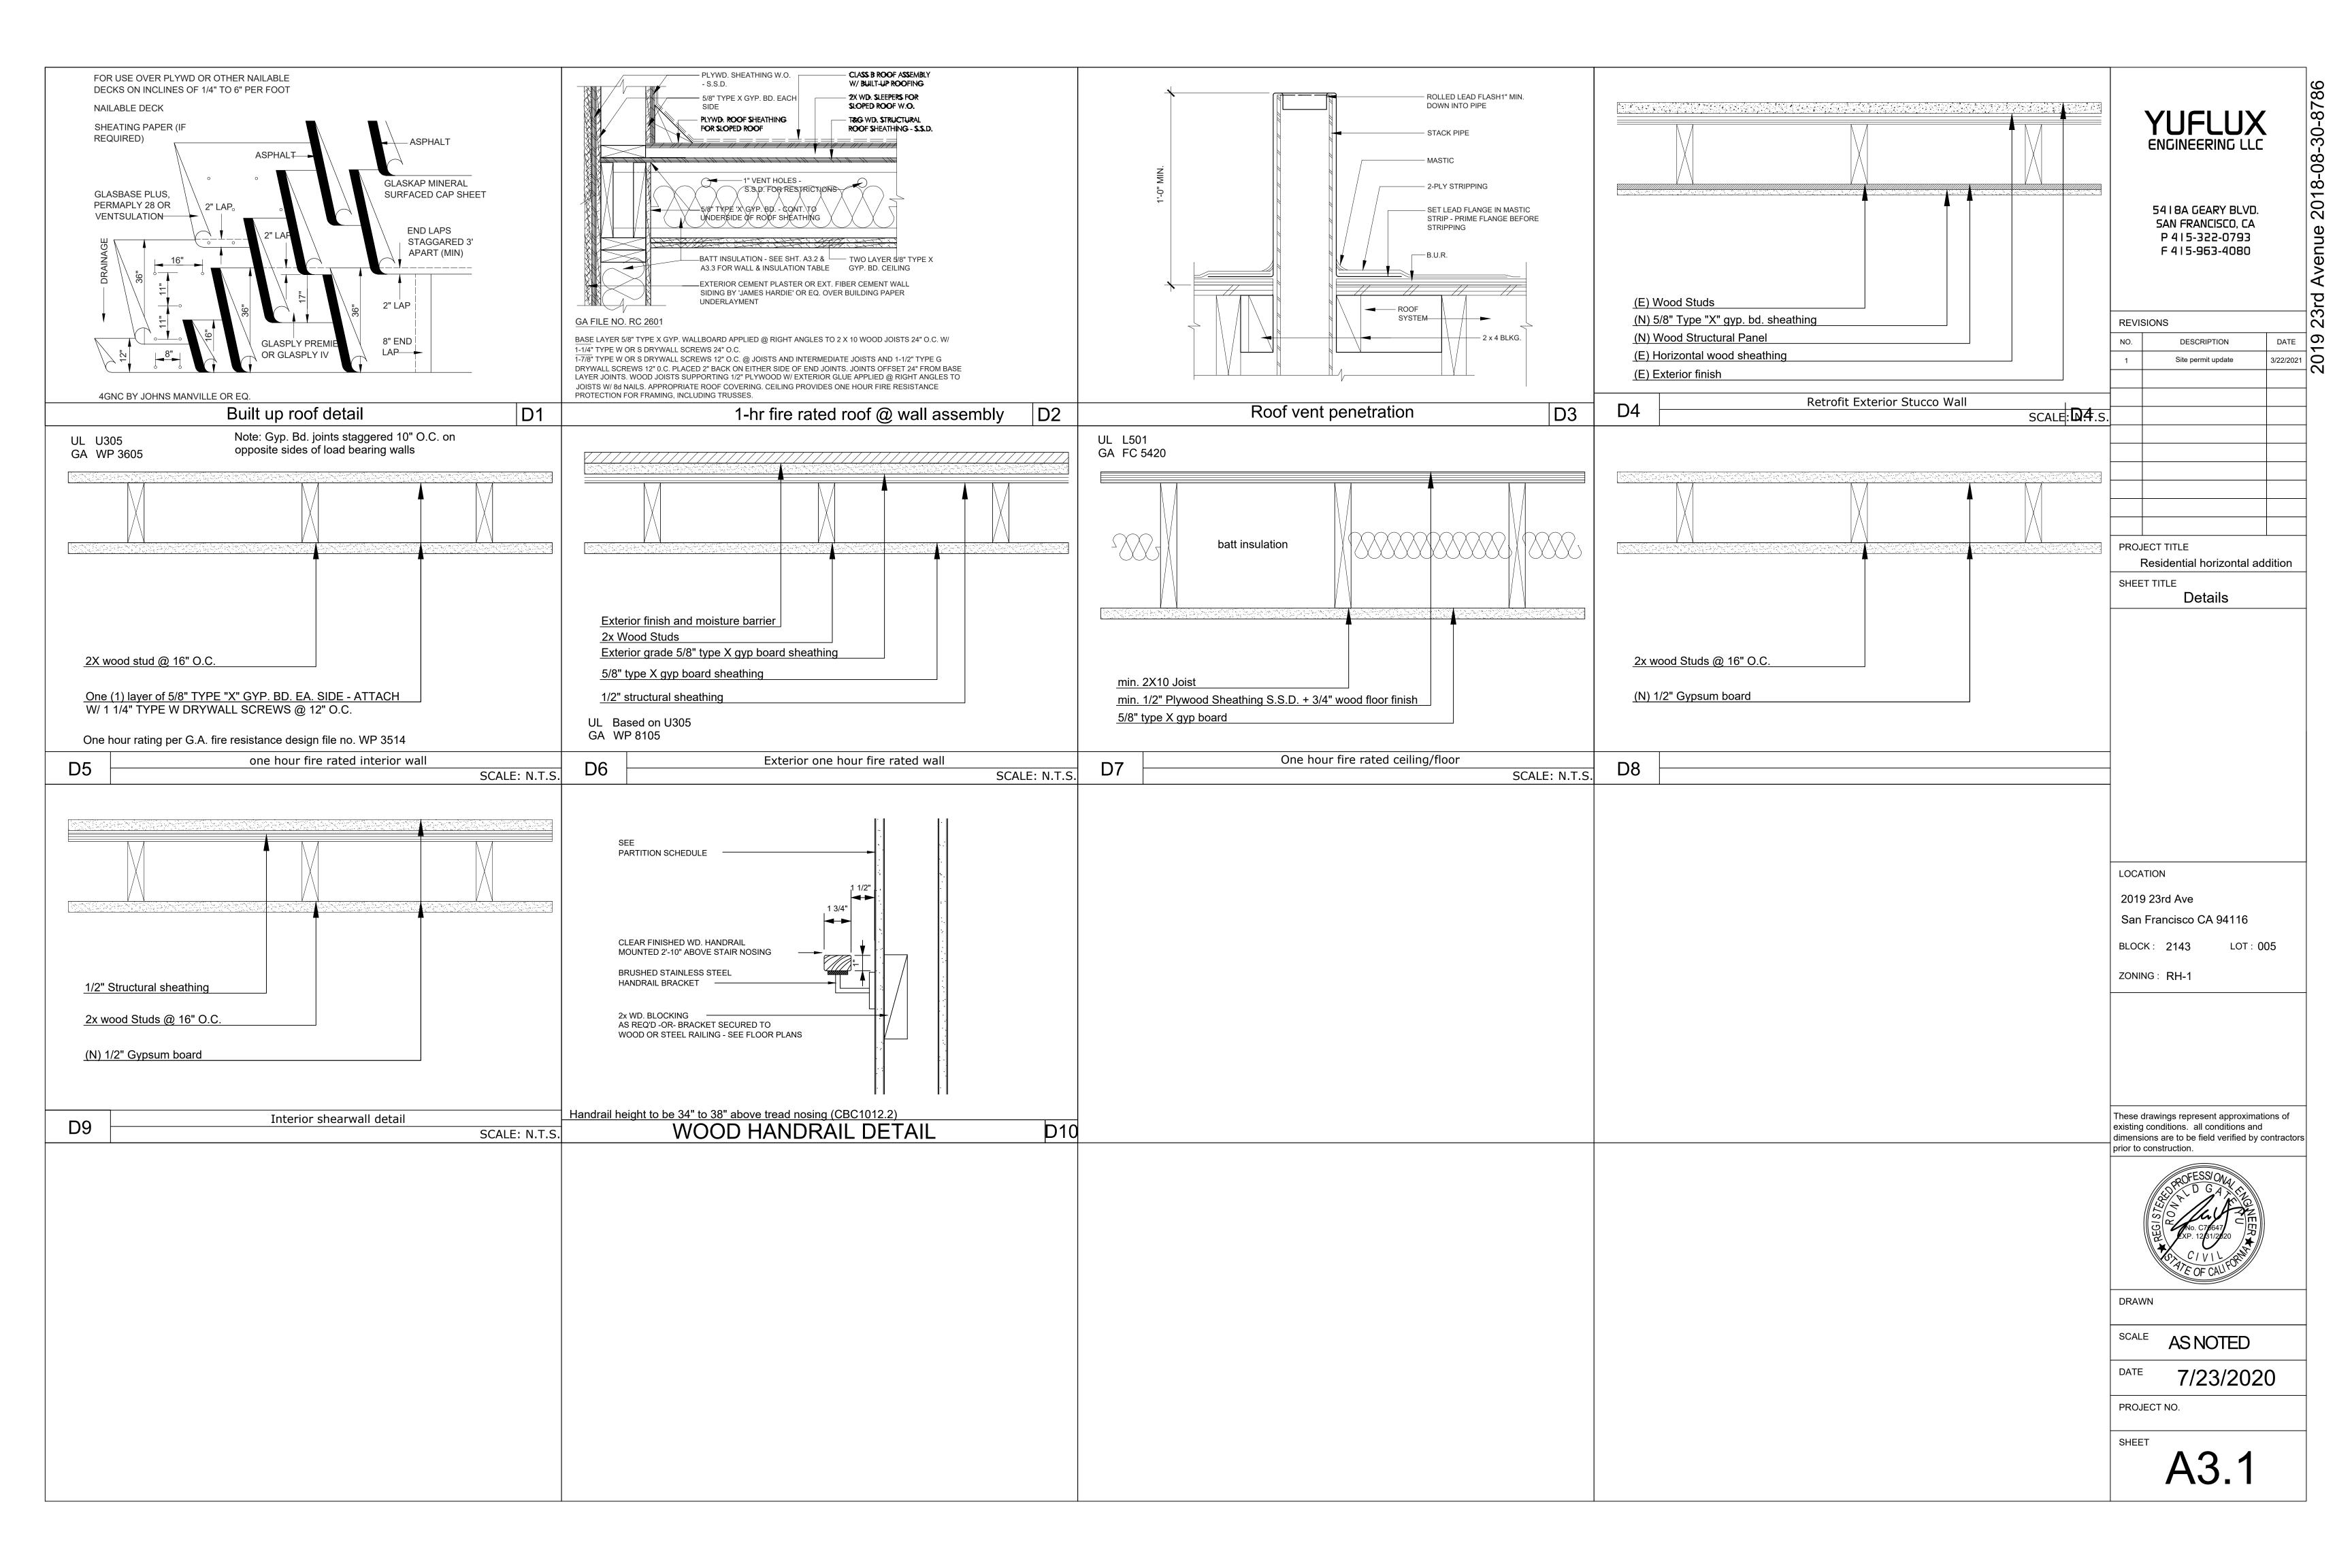

|                      |   | Project data   | Abbreviations    |   |                   |  |
|----------------------|---|--|------------------|---|-------------------|--|
| ADDRESS:             | 2019 23rd Ave                             |  | ABV.<br>A.F.F.   | ABOVE<br>ABOVE FINISH FLOOR                   | MTG.<br>MTL.      | MOUNTING<br>METAL                          |
| BLOCK                | 2143                                      |  | ALC.<br>ADJ.     | ALCOVE<br>ADJACENT                            | (N)<br>N.I.C.     | NEW<br>NOT IN CONTRACT                     |
|                      |   |  | ADJUST.<br>ALUM. | ADJUSTABLE<br>ALUMINUM                        | N.T.S.<br>O/      | NOT TO SCALE<br>OVER                       |
| LOT                  | 005                                       |  | A.V.             | AUDIO-VISUAL                                  | O.C.              | ON CENTER                                  |
| STORIES:             | 2   |  | B.O.<br>BD.      | BOTTOM OF<br>BOARD                            | O.H.<br>OPNG.     | OPPOSITE HAND<br>OPENING                   |
| PRESENT USE:         | Residential-Hous                          | e, One Family  | BLDG.<br>BTWN.   | BUILDING<br>BETWEEN                           | OPP.<br>O.S.C.I.  | OPPOSITE<br>OWNER SUPPLIE                  |
| OCCUPANCY:           | R3  |  | CAB.<br>C.G.     | CABINET<br>CORNER GUARD                       |                   | ONTRACTOR<br>TALLED                        |
| TYPE:                | 5B  |  | C.H.<br>C.J.     | CLOTHES HOOK<br>CONTROL JOINT                 | O.S.O.I.          | OWNER SUPPLIE                              |
| ZONING:              | RH-1                                      |  | C.L.             | CENTER LINE                                   | INS               | TALLED                                     |
|                      |   |  | CLG.<br>CLR.     | CEILING<br>CLEAR                              | PART. BD<br>PL.   | <ul><li>PARTICLE BOARI<br/>PLATE</li></ul> |
|                      |   | Scope of work  | CNTR.<br>COL.    | COUNTER<br>COLUMN                             | P. LAM.           | PLASTIC LAMINA                             |
|                      |   | •  | CONC.<br>COND.   | CONCRETE<br>CONDITION                         | PLCB.             | PLASTIC<br>LAMINATE CABIN                  |
| RIZONTAL ADDIT       | ION AT REAR OF E                          | EXISTING TWO STORIES RESIDENTIAL BUILDING.   | CONT.            | CONTINUOUS                                    | PNL.              | PANEL                                      |
|                      |   |  | CONST.<br>CPT.   | CONSTRUCTION<br>CARPET                        | P.T.              | PAPER TOWEL DISPENSER                      |
|                      |   |  | C.S.C.I          | CONTRACTOR<br>SUPPLIED &                      | PTD.<br>RAD.      | PAINTED<br>RADIUS                          |
|                      |   |  |                  | CONTRACTOR<br>INSTALLED                       | REINF.<br>REQ'D.  | REINFORCE<br>REQUIRED                      |
|                      |   |  | CTR.             | CENTER  | RESIL.            | RESILIENT                                  |
|                      |   |  | DBL.<br>DEMO.    | DOUBLE<br>DEMOLITION                          | R.C.P.            | REFLECTED<br>CEILING PLAN                  |
|                      |   |  | DIM.<br>DISP.    | DIMENSION<br>DISPENSER                        | RM.<br>R.O.       | ROOM<br>ROUGH OPENING                      |
|                      |   |  | DN.<br>DR.       | DOWN<br>DOOR                                  | R.O.S.<br>S&P     | ROLL OUT SHELI<br>SHELF AND POLI           |
|                      |   |  | DTL.             | DETAIL  | S.D.              | SOAP DISPENSE                              |
|                      |   | D'   | DWG.<br>DWR.     | DRAWING<br>DRAWER                             | SIM.<br>SHT.      | SIMILAR<br>SHEET                           |
|                      |   | Project notes  | (E)<br>EA.       | EXISTING<br>EACH                              | S.C.D.            | SEE CIVIL<br>ENGINEERING                   |
| Area/floor           | Existing (ft <sup>2</sup> )               | Proposed (ft²) Change (ft²)  | EL.<br>ELEC.     | ELEVATION<br>ELECTRICAL                       | S.E.D.            | DRAWINGS<br>SEE ELECTRICAL                 |
|                      |   |  | ENCL.<br>EQ.     | ENCLOSED<br>EQUAL                             | S.L.D.            | DRAWINGS<br>SEE LANDSCAPE                  |
| Living               | 753                                       | 1798 1,045   | EQUIP.           | EQUIPMENT                                     |                   | DRAWINGS                                   |
| Car parking          | 1   | 1  | EXPAN.<br>EXT.   | EXPANSION<br>EXTERIOR                         | S.M.D.            | SEE MECHANICA<br>DRAWINGS                  |
| Bike parking         | 0   | 1  | FAB.<br>F.D.     | FABRICATION<br>FLOOR DRAIN                    | S.P.D.            | SEE PLUMBING<br>DRAWINGS                   |
| Landscaping          | 0   | (10.08*6.5)/(10.08*25)= 65.54 / 252 = 26% > (50.4 ft²)20%  | F.F.<br>FEC.     | FINISH FLOOR<br>FIRE EXT. CABINET             | SPECS.<br>SQ. IN. | SPECIFICATIONS SQUARE INCHES               |
| req.                 | G   | { (10.00 0.0),(10.00 20) 00.01, 202 20,0 (00.111,)20,0 }   | FIN.             | FINISH  | SQ. FT.           | SQUARE FEET                                |
| Permeable surface    | . 0                                       | $ \left\{ (10.08*17)/(10.08*25) = 171/252 68\% > (126 \text{ ft}^2)50\% \text{ req.} \right\} $      | FLR.<br>FLUOR.   | FLOOR<br>FLUORESCENT                          | S.S.<br>S.S.D.    | STAINLESS STEE<br>SEE                      |
|                      |   |  | F.O.<br>F.T.     | FACE OF<br>FEET                               |                   | STRUCTURAL<br>DRAWINGS                     |
| *No existing sprinkl | er and no proposed                        | sprinkler systems  | F.S.<br>GA.      | FIRE SHUTTER<br>GAUGE                         | ST. STL.<br>STL.  | STAINLESS STEE<br>STEEL                    |
|                      |   |  | G.B.<br>G.D.     | GRAB BAR<br>GARBAGE DISPOSAL                  | STN.<br>SUSP.     | STATION<br>SUSPENDED                       |
|                      |   | General notes  | G.C.             | GENERAL                                       | T.                | TEMPERED GLAS                              |
| All work porforms    | d aball be in accord                      | Janes with the adented codes, standards and any applicable state                                     | GL.              | CONTRACTOR<br>GLASS                           | TEL.<br>TEMP.     | TELEPHONE<br>TEMPERED                      |
| local amendments     | s, including but not                      |  | GYP. BD.<br>H.C. | GYPSUM BOARD<br>HANDICAPPED                   | T.O.<br>TYP.      | TOP OF<br>TYPICAL                          |
|                      | -   | y and health standards, (CAL OSHA). appliances, equipment and materials (underwriters laboratories). | HT.<br>INT.      | HEIGHT<br>INTERIOR                            | U.N.              | UNLESS<br>OTHERWISE NOT                    |
| 1.3.                 | Approved equipme                          | nt listing (factory mutual).   | INSUL.<br>JT.    | INSULATED<br>JOINT                            | V.A.T.            | VINYL ACOUSTIC                             |
|                      | Handbook of riggin<br>Safety code for bui | g (rossnagel).<br>Iding construction, ANSI.  | K.S.             | KNEE SPACE                                    | V.I.F.            | VERIFY IN FIELD                            |
| 1.6.                 | California Building                       | Code, 2016 edition.  | L.<br>LOC.       | LOCKER<br>LOCATION                            | W/<br>W.C.        | WITH<br>WATER CLOSET                       |
|                      | California Electrica California Energy (  | l Code, 2016 edition.<br>Code, 2016 edition.   | MAG.<br>MAX.     | MAGNETIC<br>MAXIMUM                           | WD.<br>WDW        | WOOD<br>WINDOW                             |
| 1.9.                 | California Fire code                      | e, 2016 edition.   | MECH.<br>MIN.    | MECHANICAL<br>MINIMUM                         | W/O.<br>W.O.      | WITHOUT WHERE OCCURS                       |
|                      |   | cal code, 2016 edition.<br>g code, 2016 edition.   | MOS.             | MOTION SENSOR                                 | v v . <b>∪</b> .  | WILLIAL OCCURS                             |
| 1.12.                | California Reference                      | ced Standards code, 2016 edition.  | MTD.             | MOUNTED                                       |                   |  |
|                      | California Energy E<br>San Francisco Buil | Efficiency standards, 2016 edition.<br>ding Code   |                  | Sheet i                                       | ndex              |  |
| 1.14                 | San Francisco Buil                        | ·  | A1.1<br>A1.2     | Sheet i  Notes, Legend, Scope of W Site plans |                   |  |

A1.2

A2.1 A2.2 A2.3

A2.4 A2.5 A3.1

S1.1

S1.2

S2.1 S3.1

S3.2

S3.3

3. If the contractors observe that these drawings and specifications are in variance with the codes, he

4. Ductwork, piping and equipment shall be installed per smacna "seismic restraint manual guidelines for

mechanical systems"addendum no. 1 or equal in accordance with asce chapter 13 "seismic design

5. All fire-rated wall and floor penetrations shall be firesafed utilizing a ul approved fire safing systems.

6. All plumbing and piping systems shall be pressure tested and verified leak tight prior to calling for city

7. These drawings represent approximations of existing conditions. all conditions and dimensions are to

shall notify the architects and engineers in writing at once.

requirements for non-structural components".

be field verified by contractors prior to construction.

progress or final inspections.

Site plans

Floor plans

Roof plans

Elevations

Elevations

Architectural details

Structural notes

Structural notes

Structural plans

Structural details

Structural details

Structural details

Structural details

Section

# 2019 23rd Ave San Francisco CA 94116

|                      | <b>Demolition Cal</b> | culation  |           |
|----------------------|-----------------------|-----------|-----------|
| Lin                  | ear footage me        | asurement |           |
| Element              | (E) Length            | Removed   | % Removed |
| Front Façade         | 25'0"                 | 0'-0"     | 0%        |
| Rear Façade          | 25'0"                 | 20'0"     | 80%       |
| Left side elevation  | 31'8"                 | 0'-0"     | 0%        |
| Right side elevation | 31'8"                 | 0'-0"     | 0%        |
| Total                | 113'4"                | 20'0"     | 18%       |
| Ar                   | ea footage mea        | surement  | ~         |
| Vertical elements    | (E) Length            | Removed   | % Removed |
| Front Façade         | 440                   | 0         | 0%        |
| Rear Façade          | 440                   | 352       | 80%       |
| Left side elevation  | 557                   | 0         | 0%        |
| Right side elevation | 557                   | 0         | 0%        |
| Total                | 1994                  | 352       | 18%       |
| Horizontal Elements  | (E) Length            | Removed   | % Removed |
| Second floor         | 792                   | 0         | 0         |
| Ground floor         | 792                   | 0         | 0         |
| Total                | 1584                  | 0         | 0         |

| Floor area   | Existing total (ft <sup>2</sup> ) | Proposed total (ft <sup>2</sup> ) |
|--------------|-----------------------------------|-----------------------------------|
| First floor  | 0                                 | 504                               |
| Second floor | 530                               | 700                               |
| Total area   | E30                               | 1204                              |



5418A GEARY BLVD. SAN FRANCISCO, CA P 415-322-0793 F 4 I 5-963-4080

REVISIONS

| NO. | DESCRIPTION        | DATE      |
|-----|--------------------|-----------|
| 1   | Site permit update | 3/22/2021 |
| 2   | Site permit update | 4/28/2021 |
|     |                    |           |
|     |                    |           |
|     |                    |           |
|     |                    |           |
|     |                    |           |
|     |                    |           |
|     |                    |           |
|     |                    |           |
| DDO | IECT TITLE         |           |

Residential horizontal addition

SHEET TITLE

General notes


LOCATION

2019 23rd Ave San Francisco CA 94116

LOT: 005 BLOCK: 2143

ZONING: RH-1


These drawings represent approximations of existing conditions. all conditions and dimensions are to be field verified by contractors prior to construction.

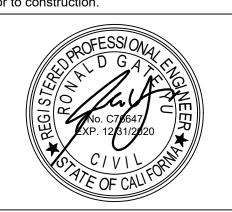


DRAWN

**AS NOTED** 

7/23/2020

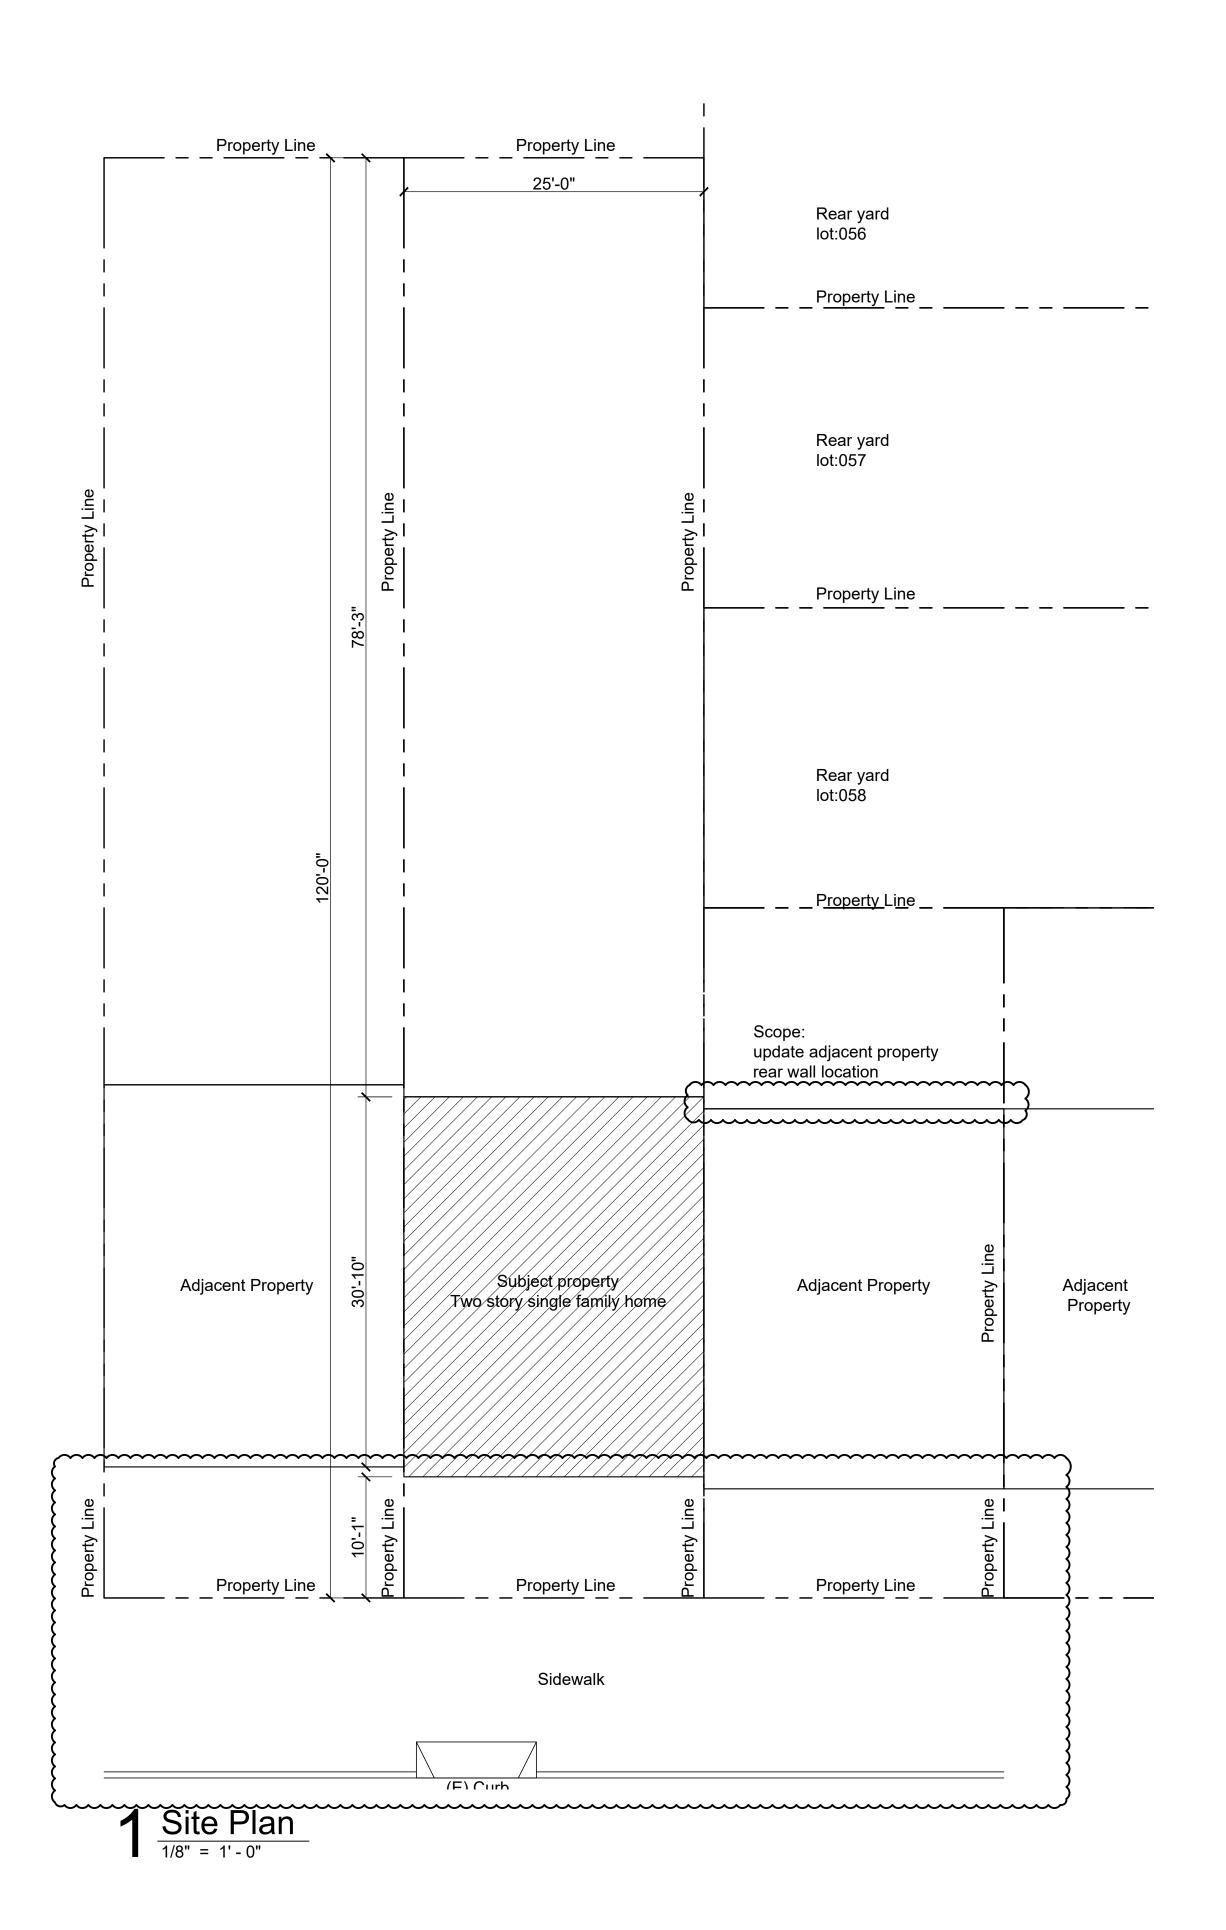

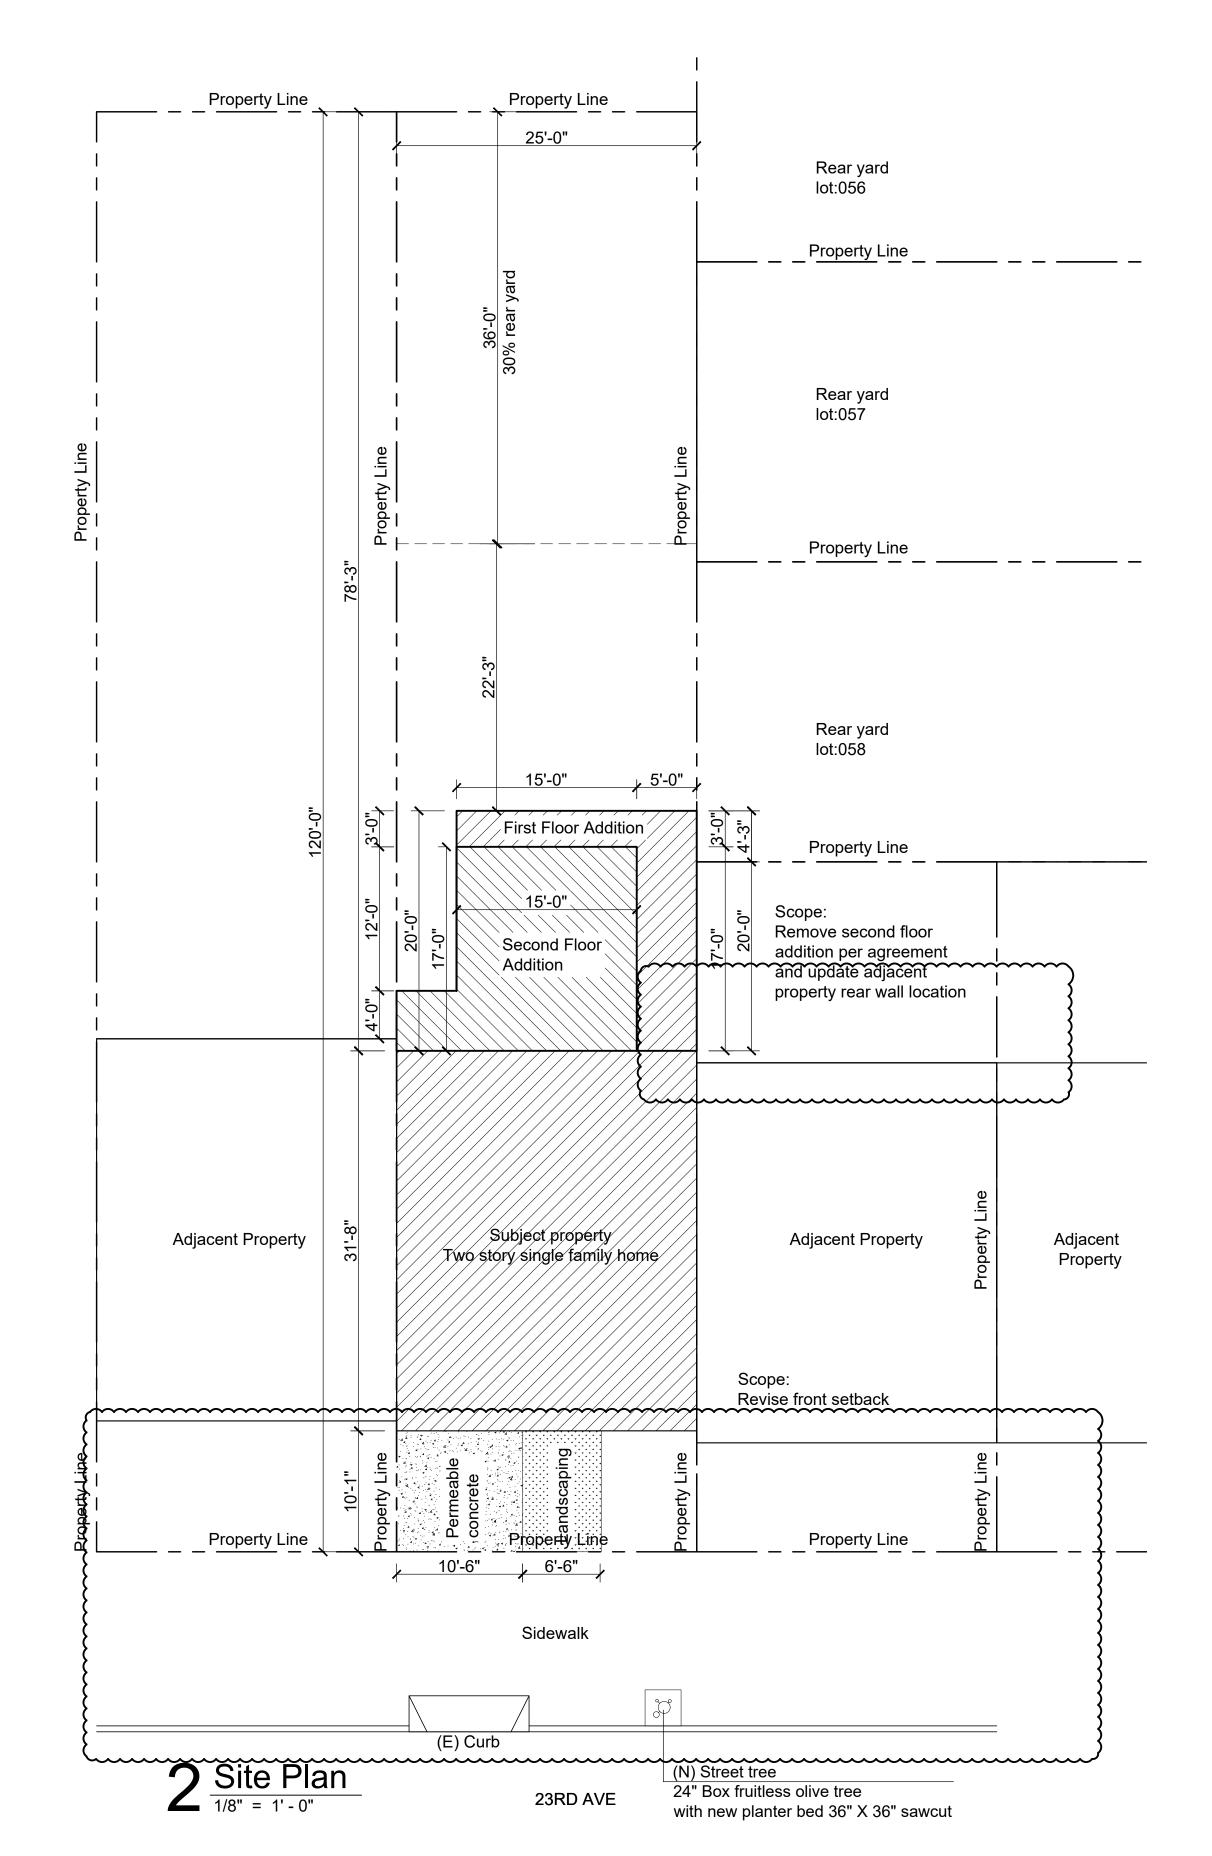



5418A GEARY BLVD. SAN FRANCISCO, CA P 415-322-0793 F 415-963-4080

Avenue

REVISIONS

|     |                    |           | -    |
|-----|--------------------|-----------|------|
| NO. | DESCRIPTION        | DATE      | 0    |
| 1   | Site permit update | 3/22/2021 | 2010 |
| 2   | Site permit update | 4/28/2021 |      |
|     |                    |           |      |
|     |                    |           |      |
|     |                    |           |      |
|     |                    |           |      |
|     |                    |           |      |
|     |                    |           |      |
|     |                    |           |      |
|     |                    |           |      |

PROJECT TITLE

Residential horizontal addition

SHEET TITLE
Site Plans

LOCATION


2019 23rd Ave

BLOCK: 2143 LOT: 005

San Francisco CA 94116

ZONING: RH-1

These drawings represent approximations of existing conditions. all conditions and dimensions are to be field verified by contractors prior to construction.

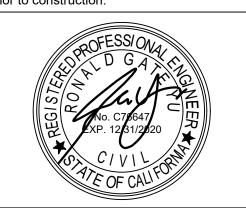

DRAWN

SCALE AS NOTED


\_\_\_\_


7/23/2020

PROJECT NO.

A1.2



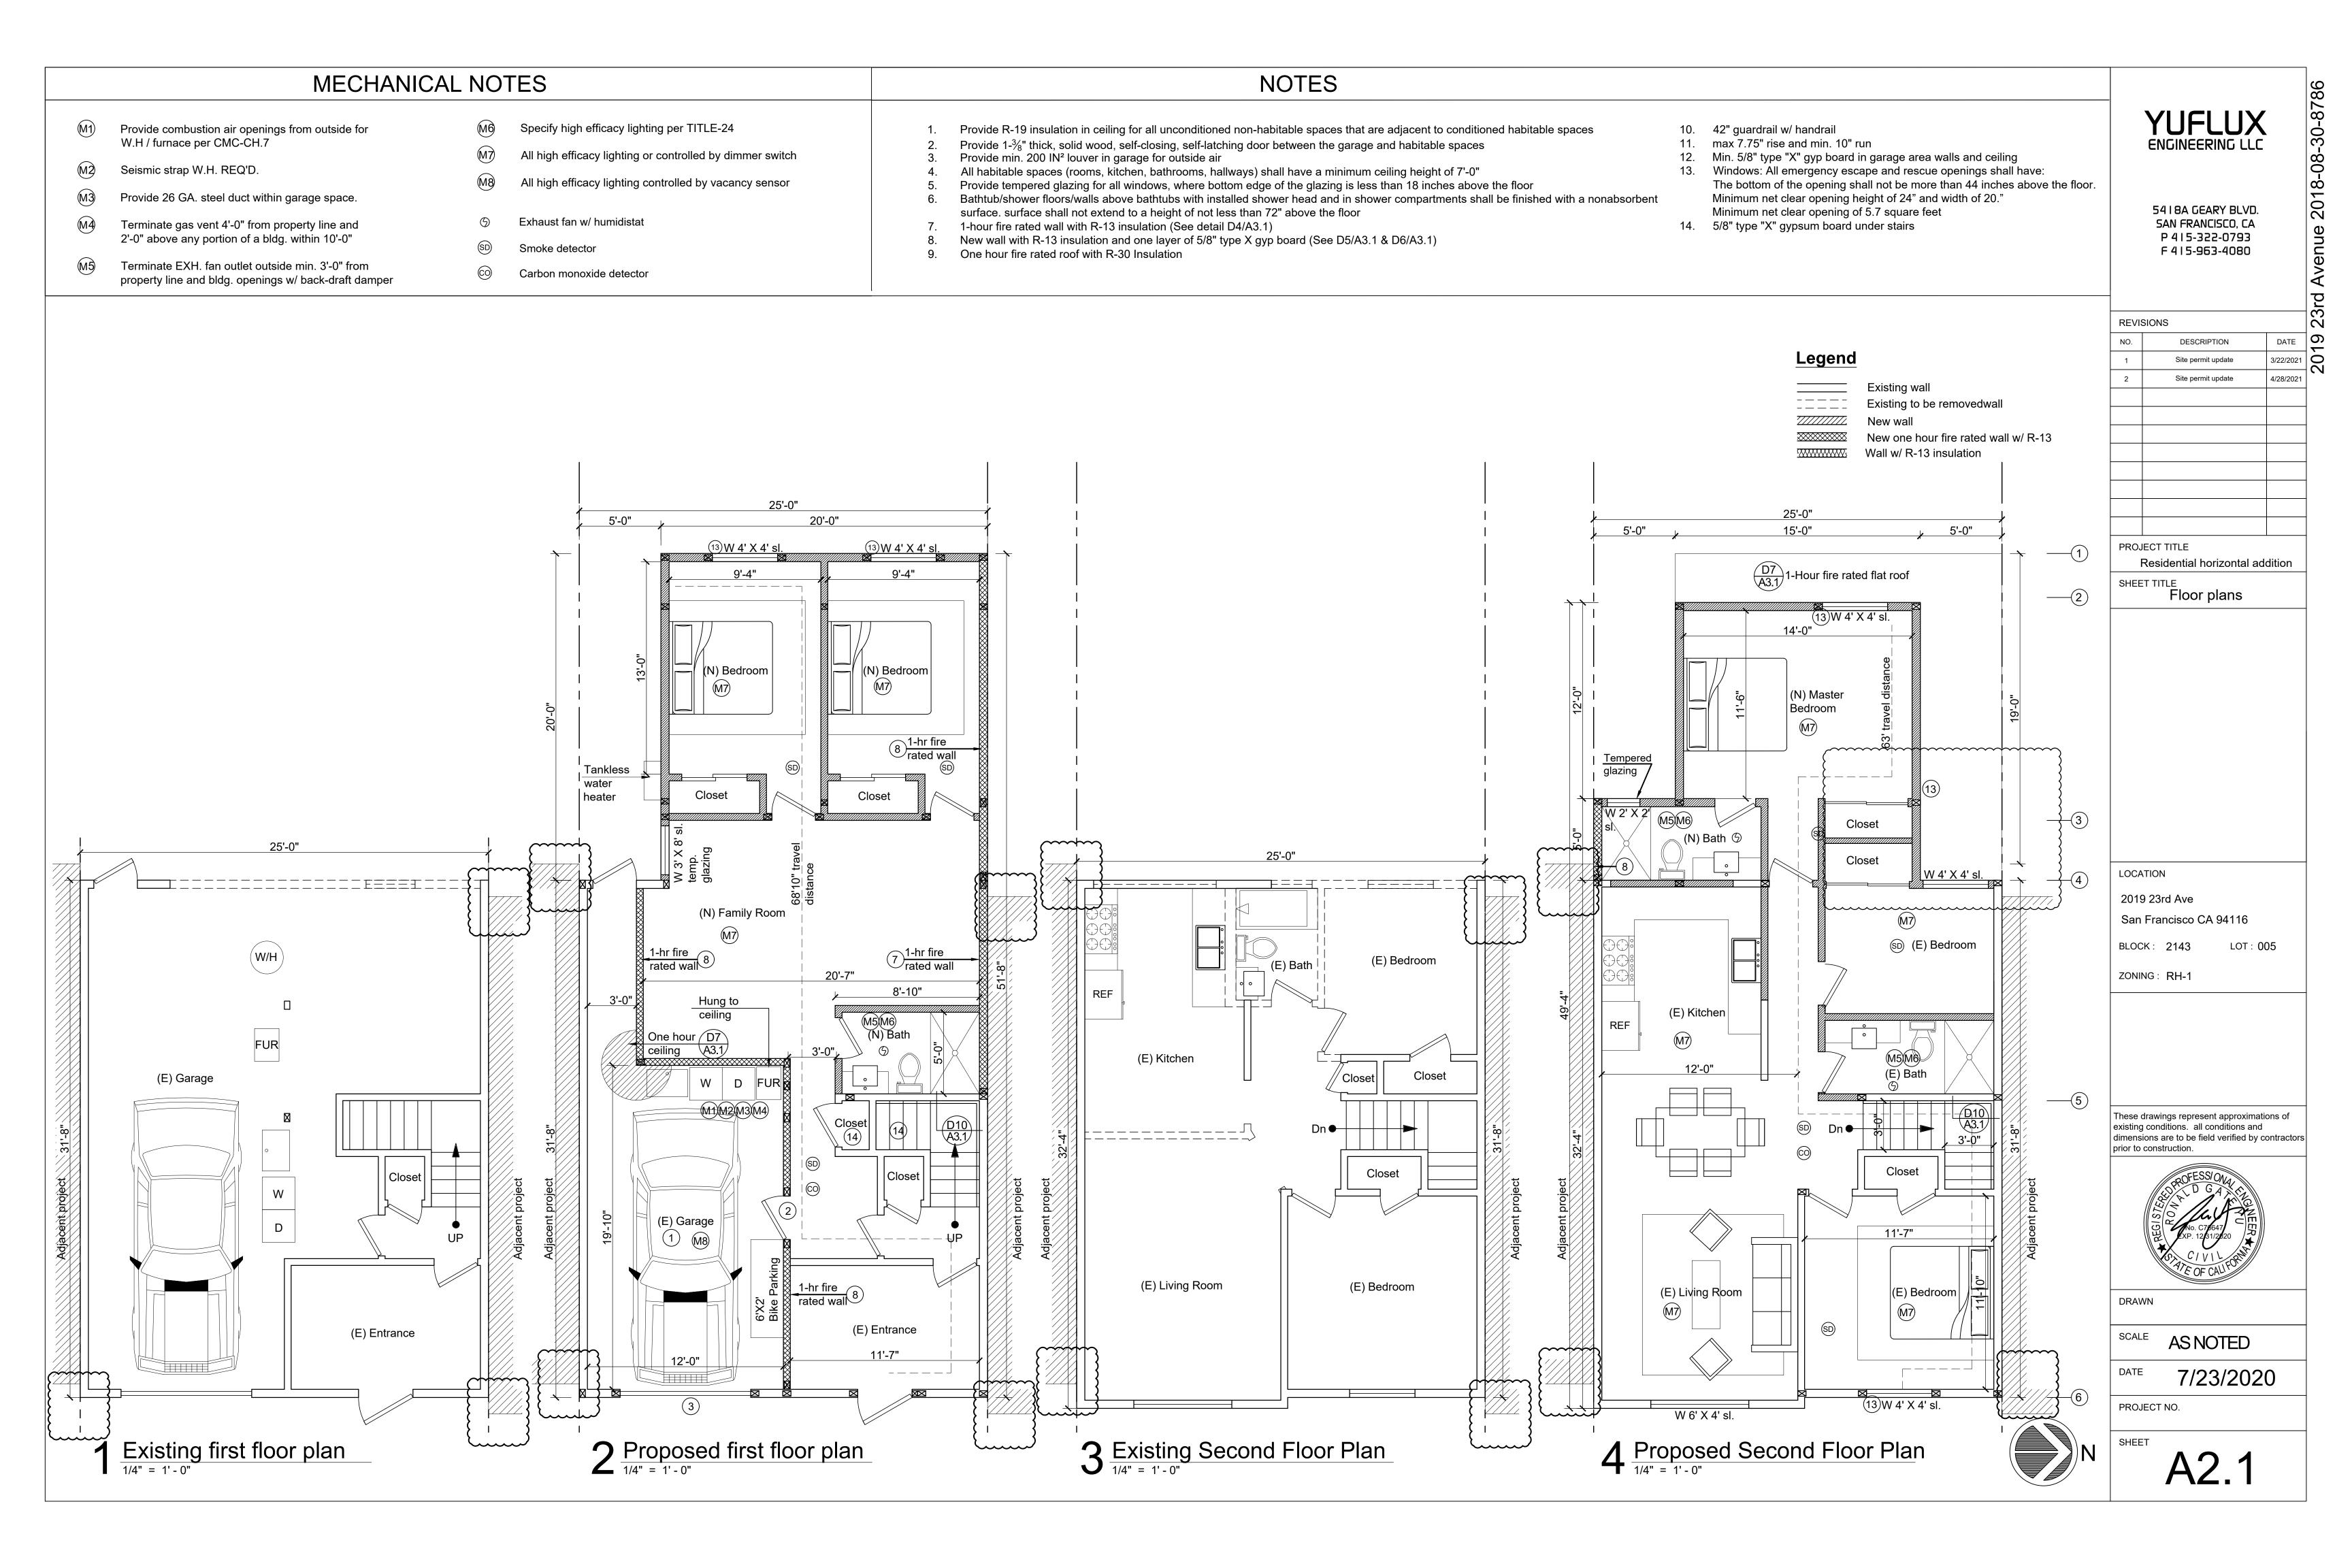

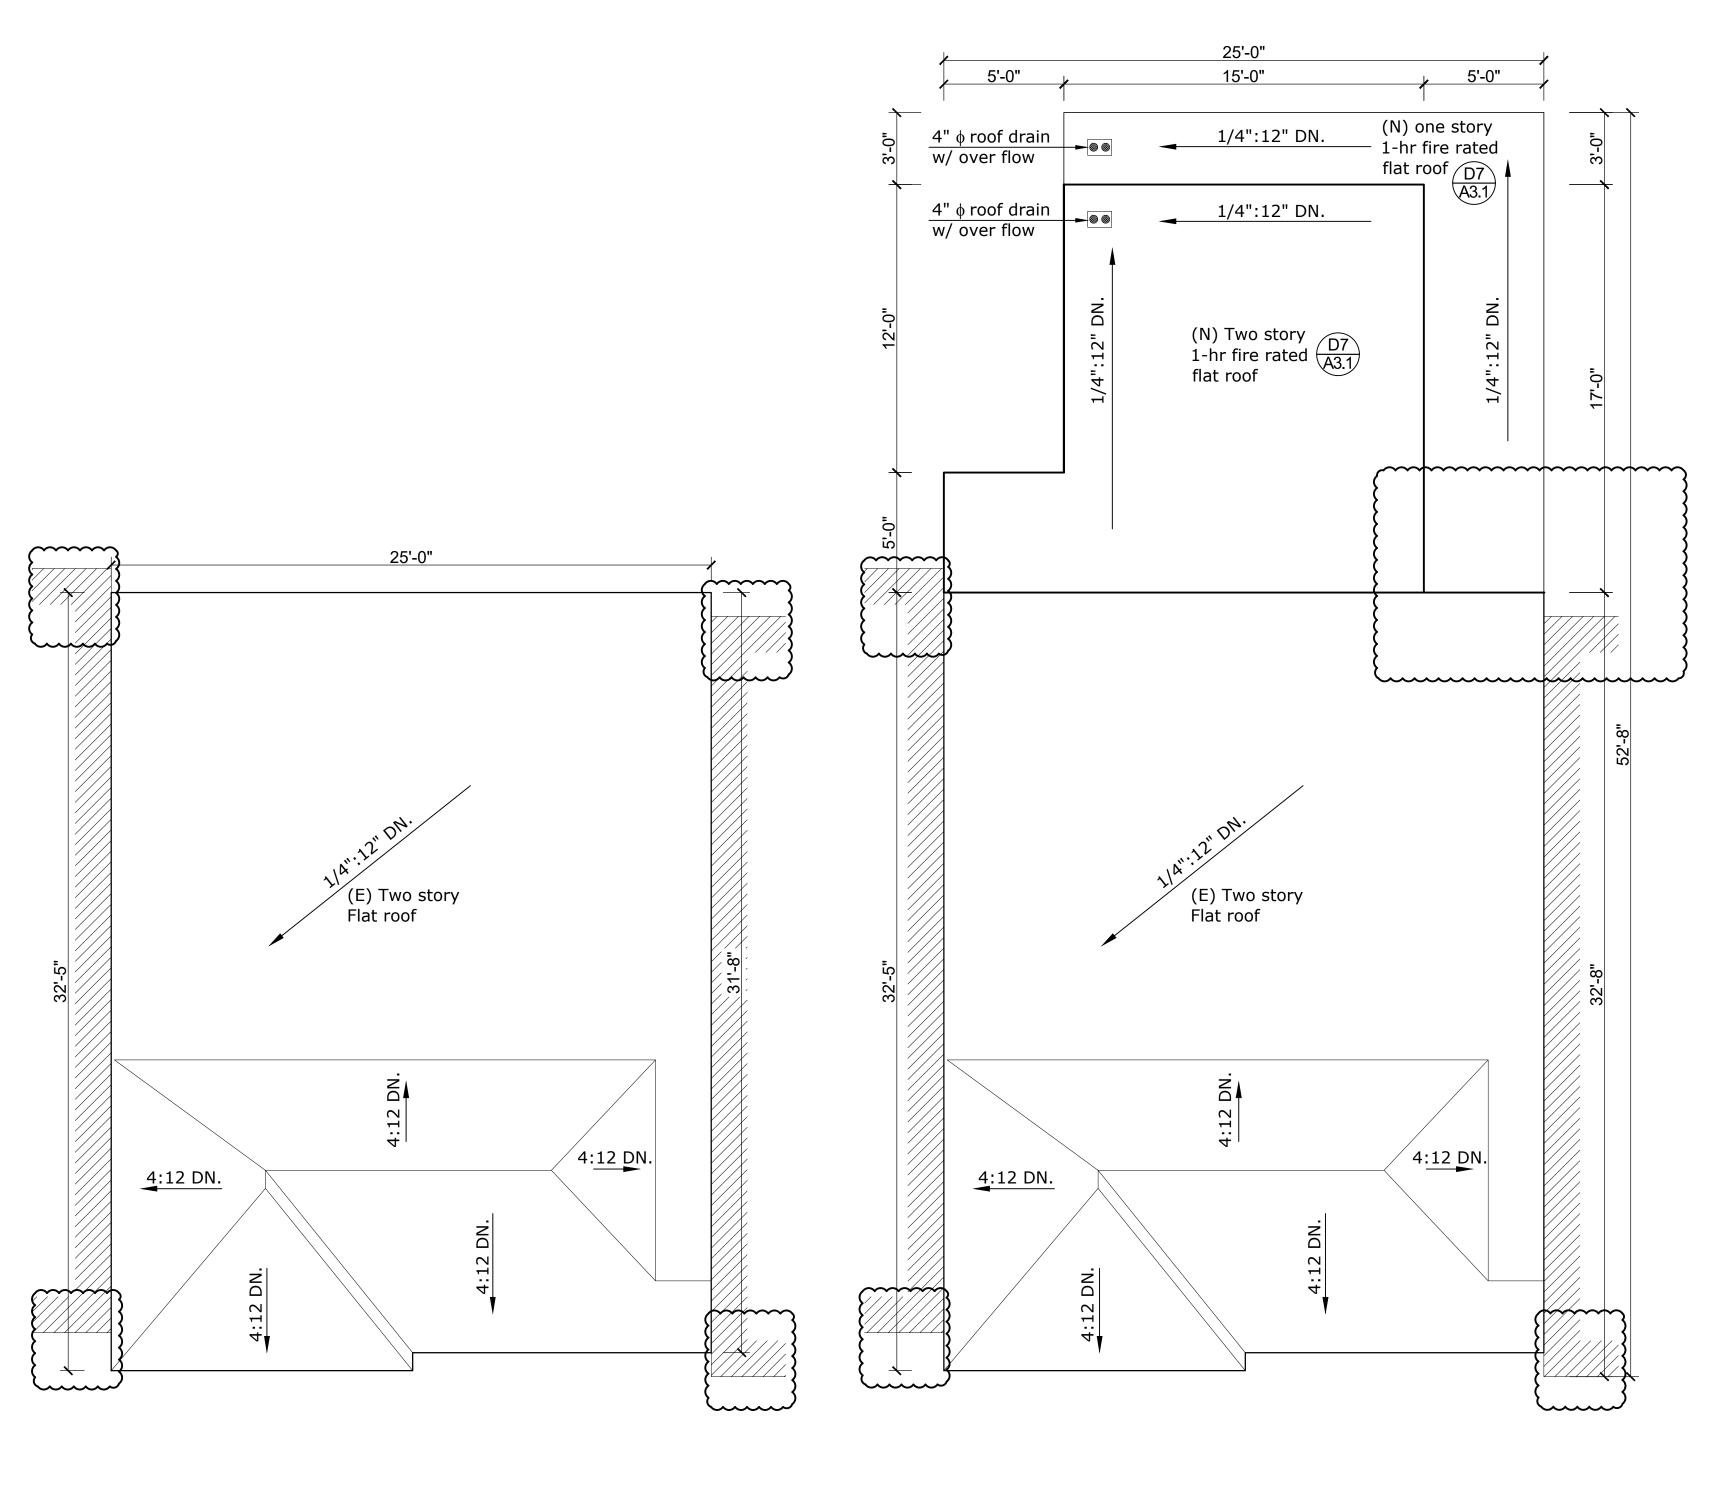

1 Existing roof plans  $\frac{1}{1/4"} = 1' - 0"$ 

 $2^{\frac{\text{Proposed roof plans}}{1/4" = 1' - 0"}}$ 

YUFLUX ENGINEERING LLC

5418A GEARY BLVD. SAN FRANCISCO, CA P 415-322-0793 F 415-963-4080

Avenue 2018-08-30-8786

| REVISI | ONS                |           |
|--------|--------------------|-----------|
| NO.    | DESCRIPTION        | DATE      |
| 1      | Site permit update | 3/22/2021 |
| 2      | Site permit update | 4/28/2021 |
|        |                    |           |
|        |                    |           |
|        |                    |           |
|        |                    |           |
|        |                    |           |
|        |                    |           |
|        |                    |           |
|        |                    |           |

PROJECT TITLE

Residential horizontal addition

SHEET TITLE Roof plans

LOCATION


2019 23rd Ave

LOT: 005 BLOCK: 2143

San Francisco CA 94116

ZONING: RH-1


These drawings represent approximations of existing conditions. all conditions and dimensions are to be field verified by contractors prior to construction.

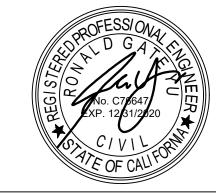

DRAWN

**AS NOTED** 

7/23/2020

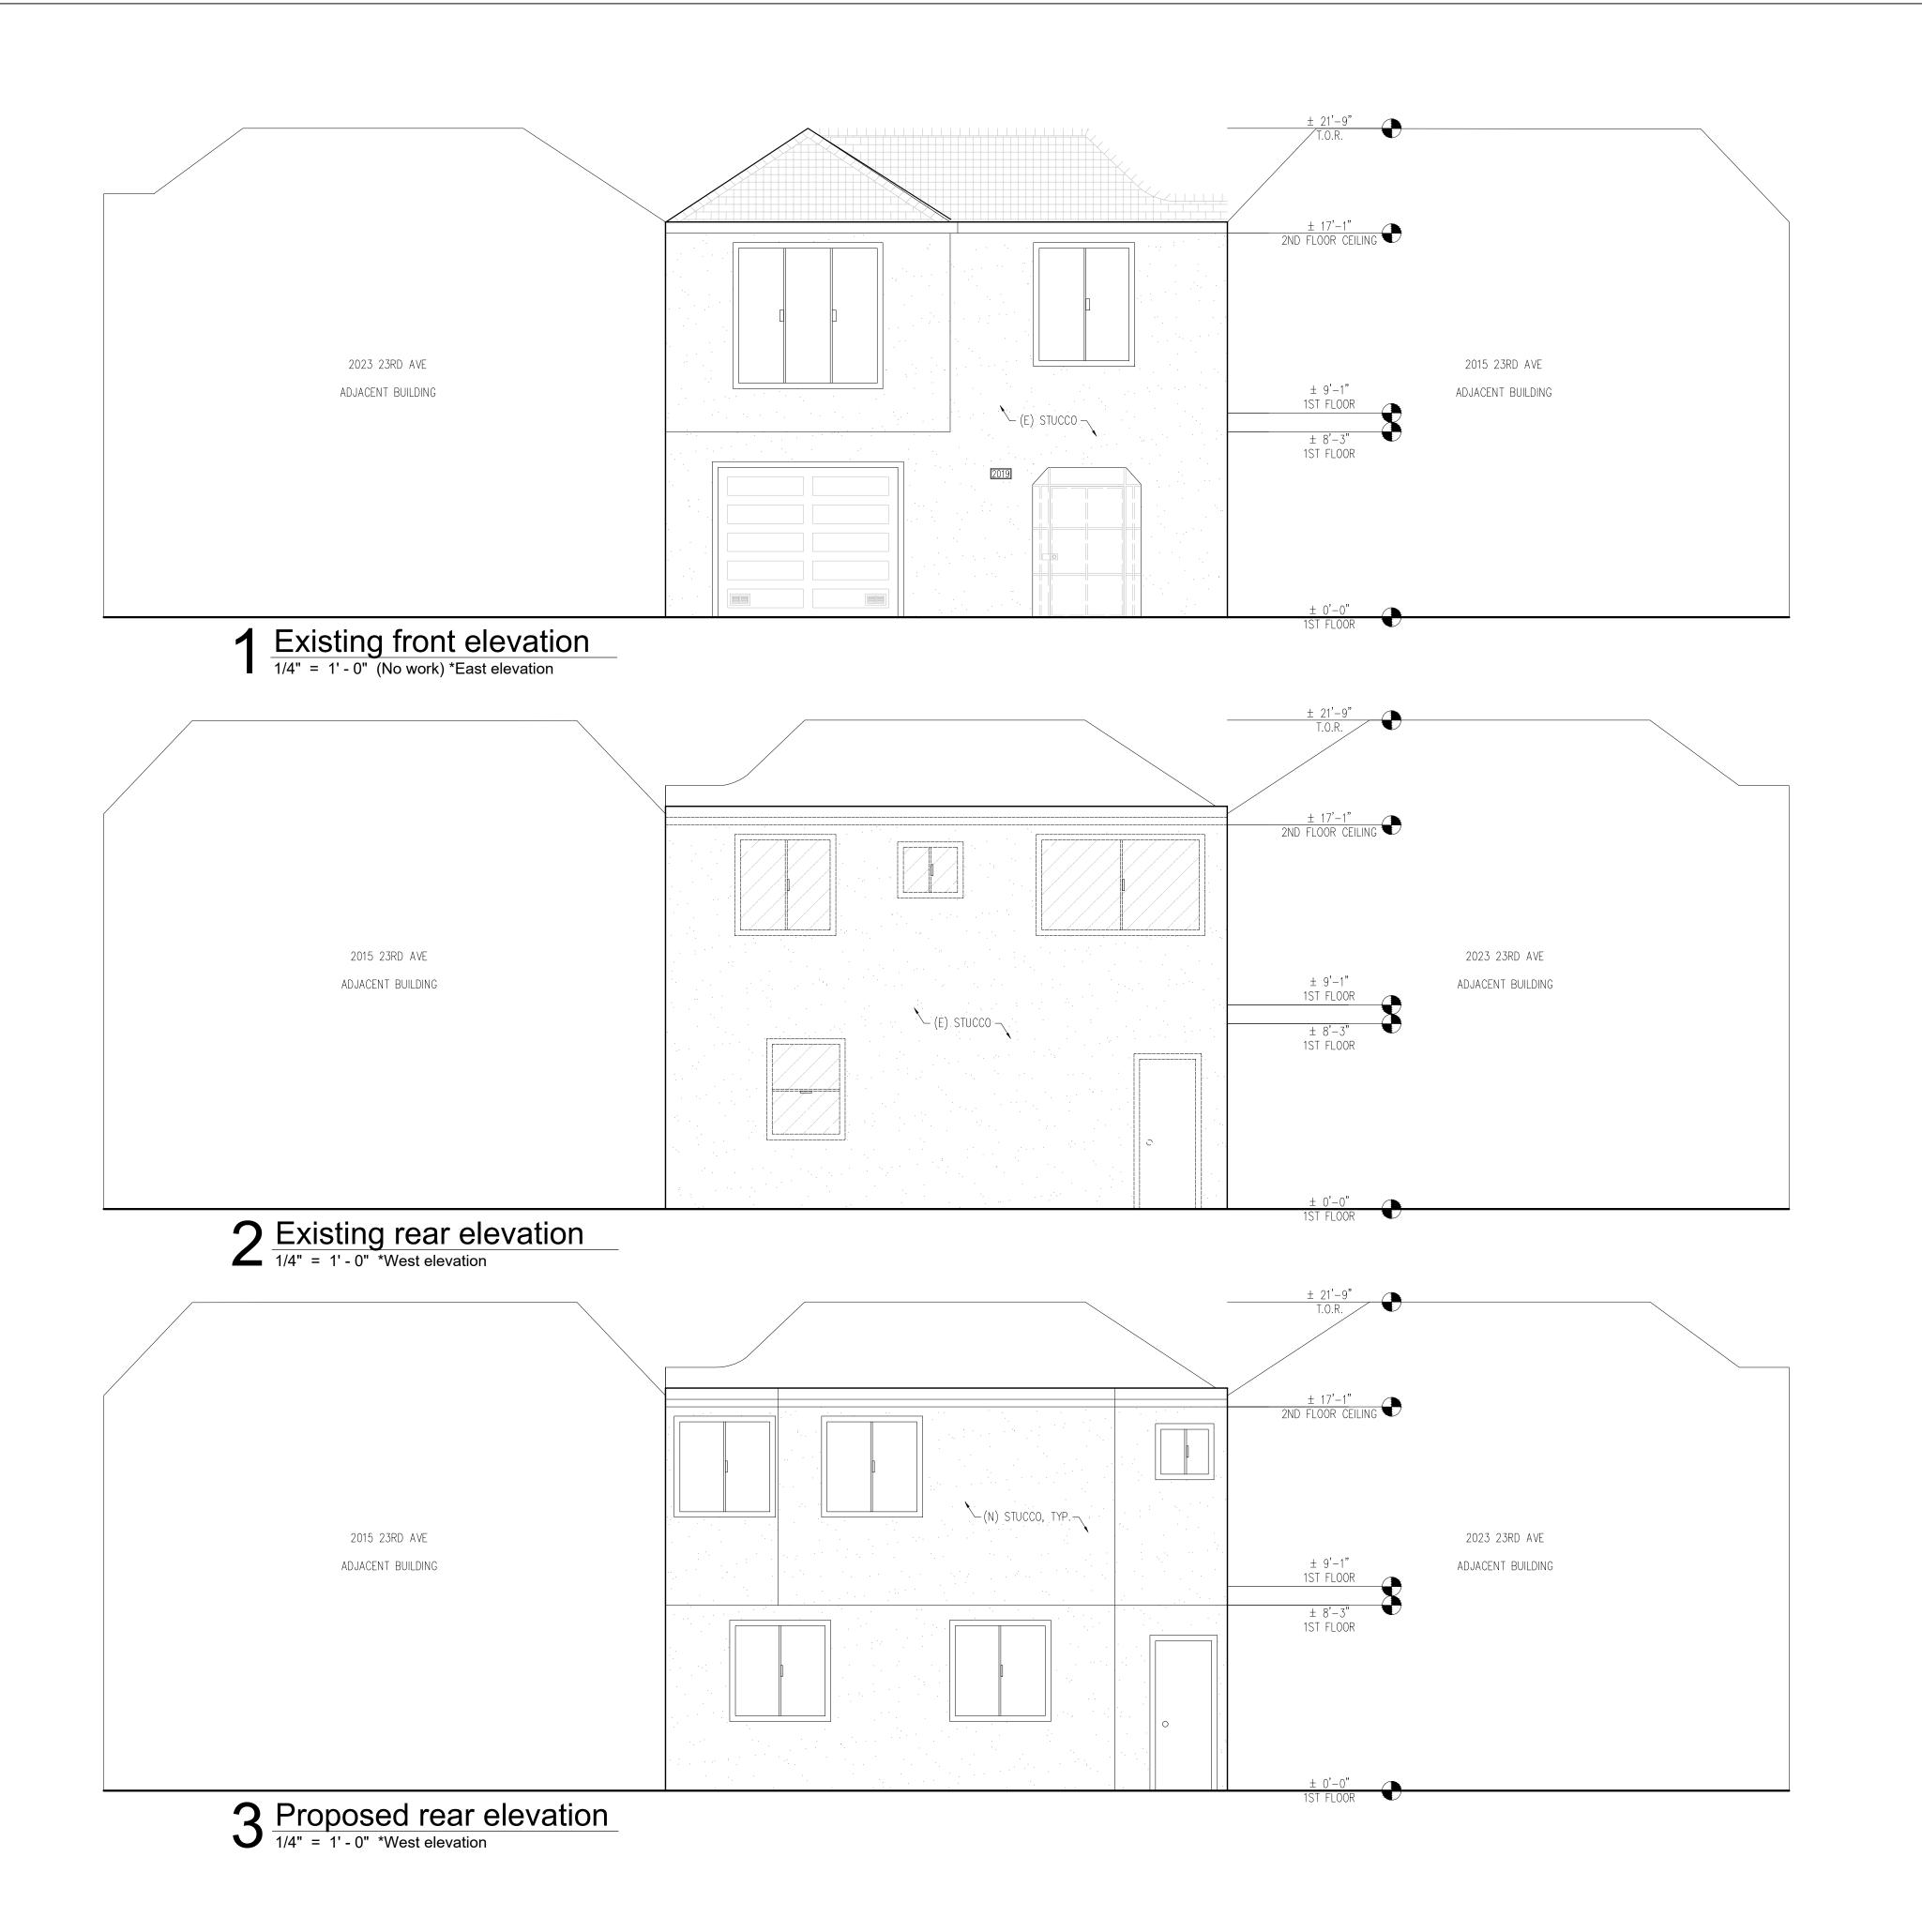

|      | YUFLUX ENGINEERING LLC   | ,         | -08-30-8786                      |
|------|--|-----------|----------------------------------|
|      | 5418A GEARY BLVD.<br>SAN FRANCISCO, CA<br>P 415-322-0793<br>F 415-963-4080 |           | 2019 23rd Avenue 2018-08-30-8786 |
| REVI | SIONS  |           | <b>23</b> r                      |
| NO.  | DESCRIPTION  | DATE      | <u>ග</u>                         |
| 1    | Site permit update   | 3/22/2021 | ò                                |
| 2    | Site permit update   | 4/28/2021 |                                  |
|      |  |           | _                                |
|      |  |           |                                  |
|      |  |           |                                  |
|      |  |           |                                  |
|      |  |           |                                  |
|      |  |           |                                  |
|      |  |           | -                                |

PROJECT TITLE

Residential horizontal addition

SHEET TITLE
Elevations

LOCATION


2019 23rd Ave

LOT: 005 BLOCK: 2143

San Francisco CA 94116


ZONING: RH-1


These drawings represent approximations of existing conditions. all conditions and dimensions are to be field verified by contractors prior to construction.

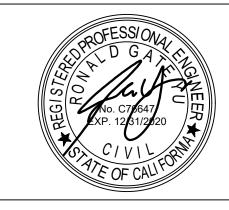


**AS NOTED** 

7/23/2020

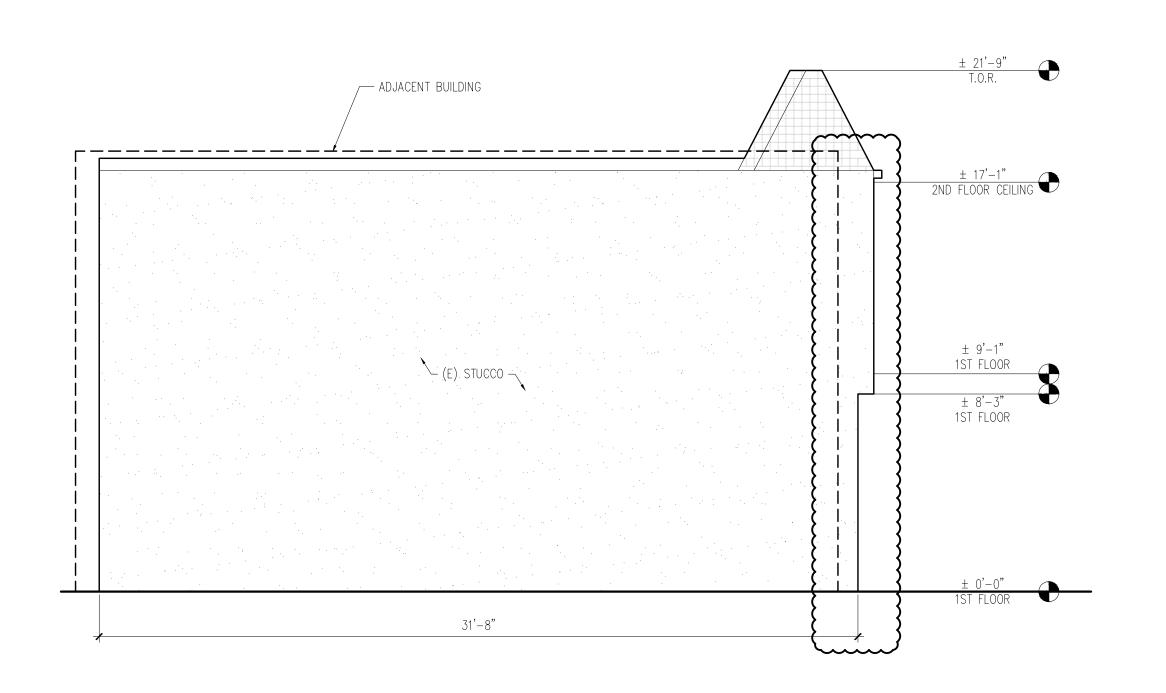

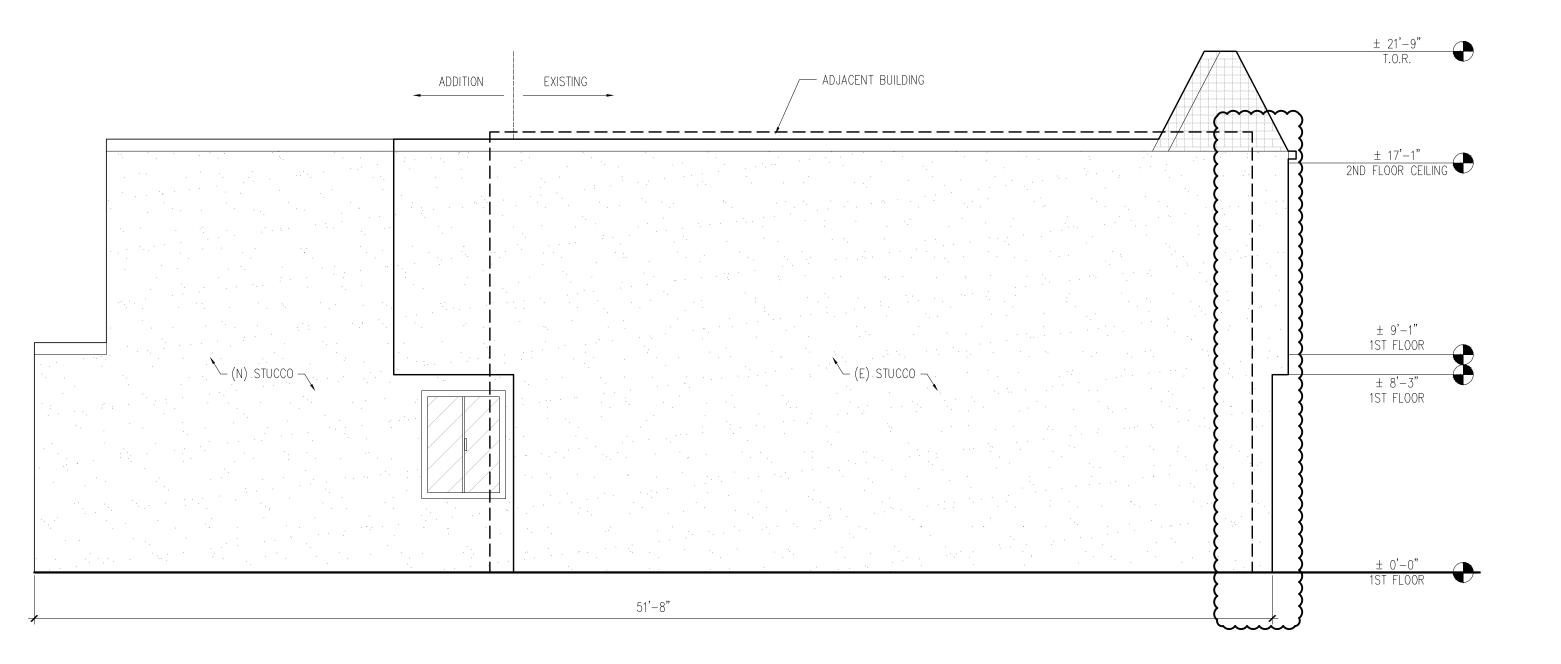


# 1 Existing left elevation 1/4" = 1' - 0" \*South elevation

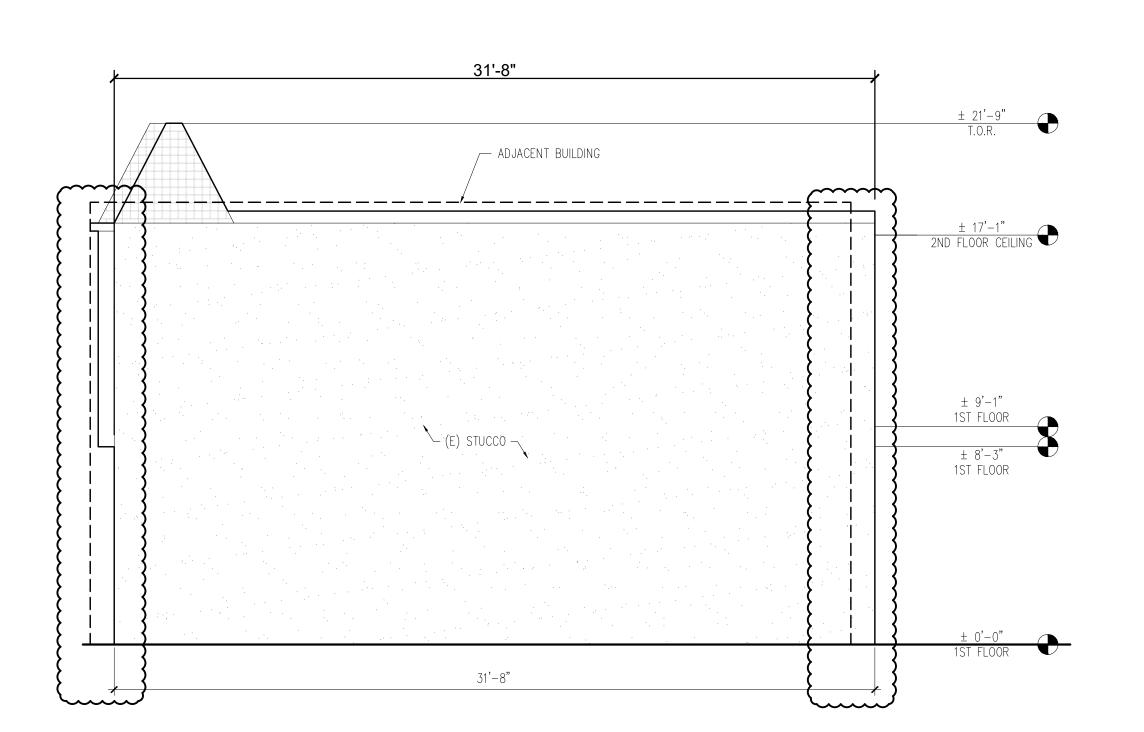

Proposed left elevation

1/4" = 1' - 0" \*South elevation

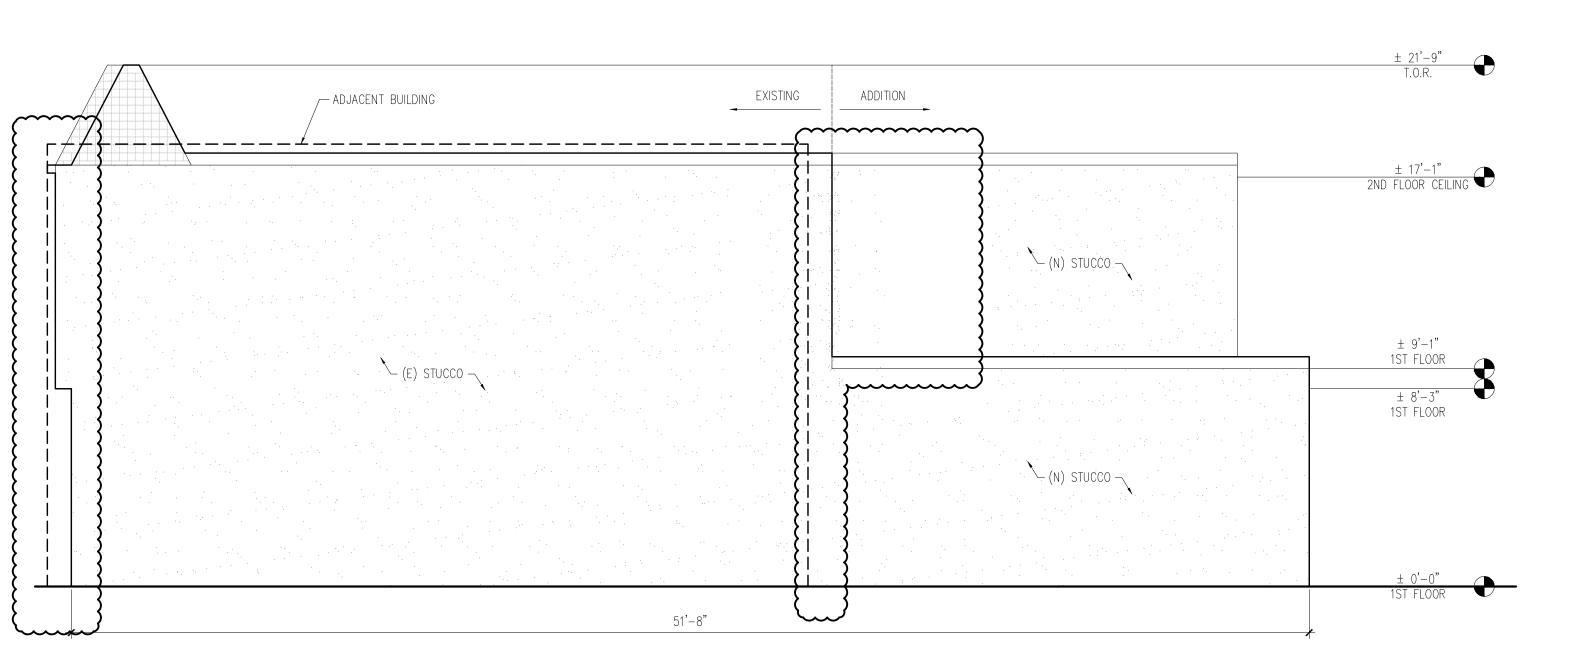

3 Existing right elevation

1/4" = 1' - 0" \*North elevation

Proposed right elevation

1/4" = 1' - 0" \*North elevation

YUFLUX ENGINEERING LLC

5418A GEARY BLVD. SAN FRANCISCO, CA P 415-322-0793 F 415-963-4080

| REVISIO | NS                 |           |
|---------|--------------------|-----------|
| NO.     | DESCRIPTION        | DATE      |
| 1       | Site permit update | 3/22/2021 |
| 2       | Site permit update | 4/28/2021 |
|         |                    |           |
|         |                    |           |
|         |                    |           |
|         |                    |           |
|         |                    |           |
|         |                    |           |
|         |                    |           |
|         |                    |           |

PROJECT TITLE

Residential horizontal addition

SHEET TITLE Elevations

LOCATION


2019 23rd Ave

LOT: 005 BLOCK: 2143

San Francisco CA 94116

ZONING: RH-1

These drawings represent approximations of existing conditions. all conditions and dimensions are to be field verified by contractors prior to construction.

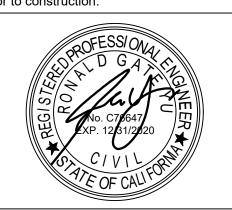


DRAWN


**AS NOTED** 

7/23/2020


PROJECT NO.


A2.4

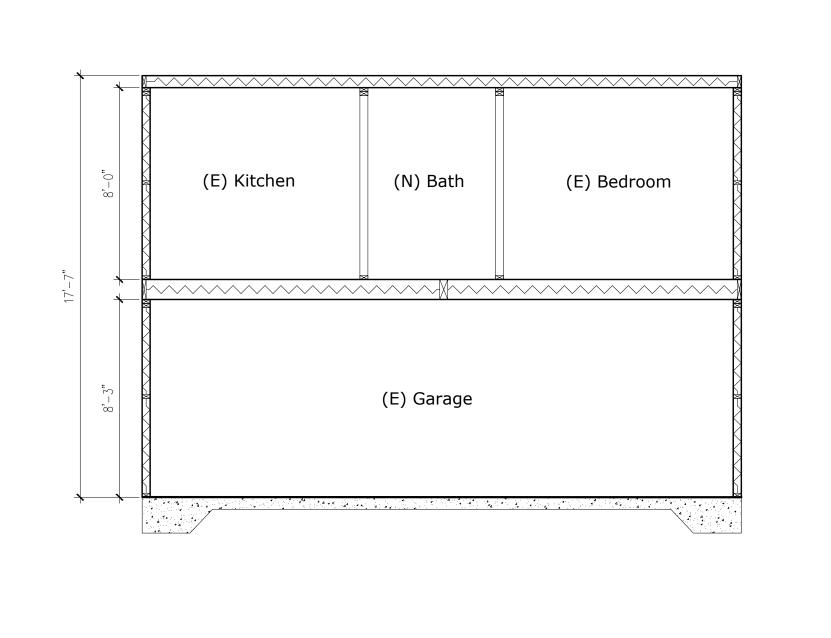


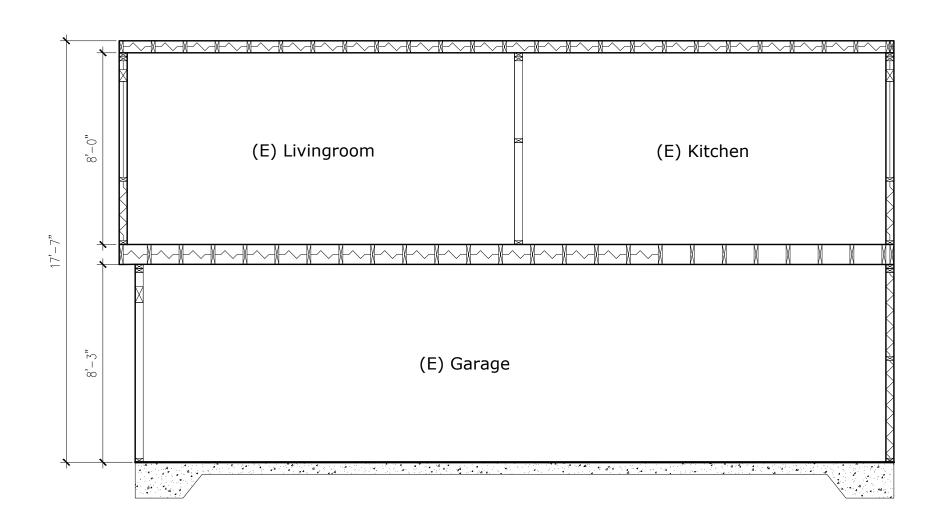

3 Existing section  $\frac{1}{4} = \frac{1}{0}$ 

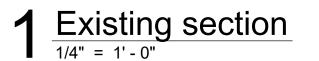

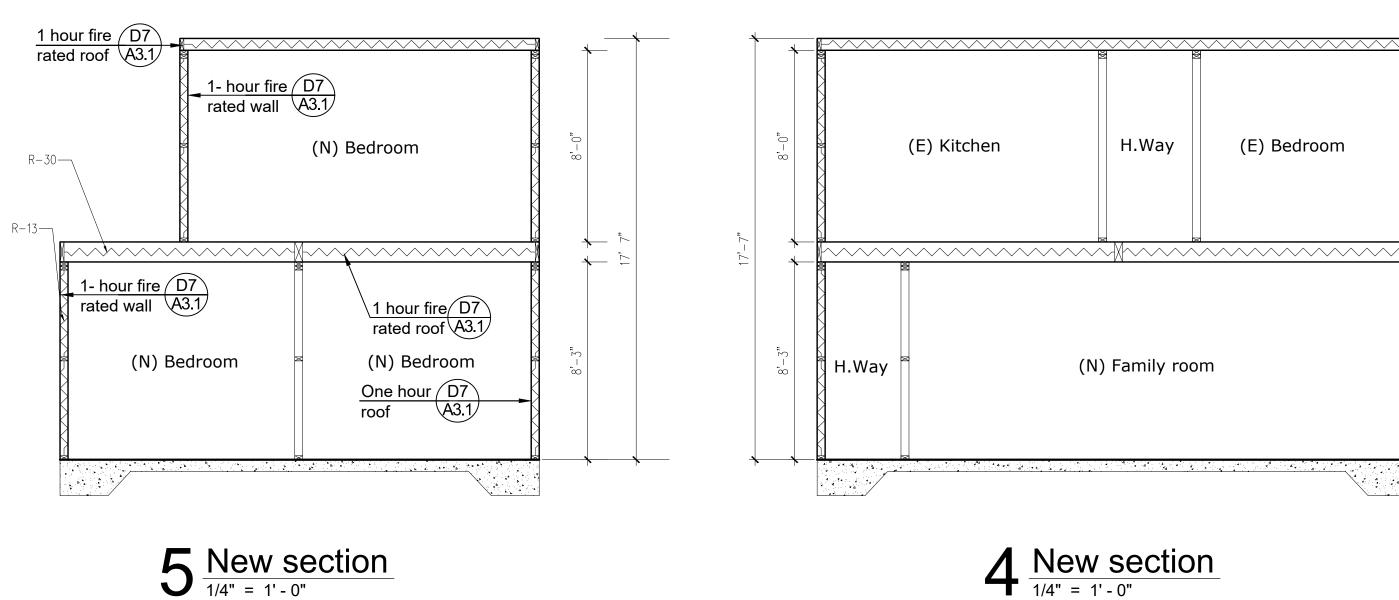

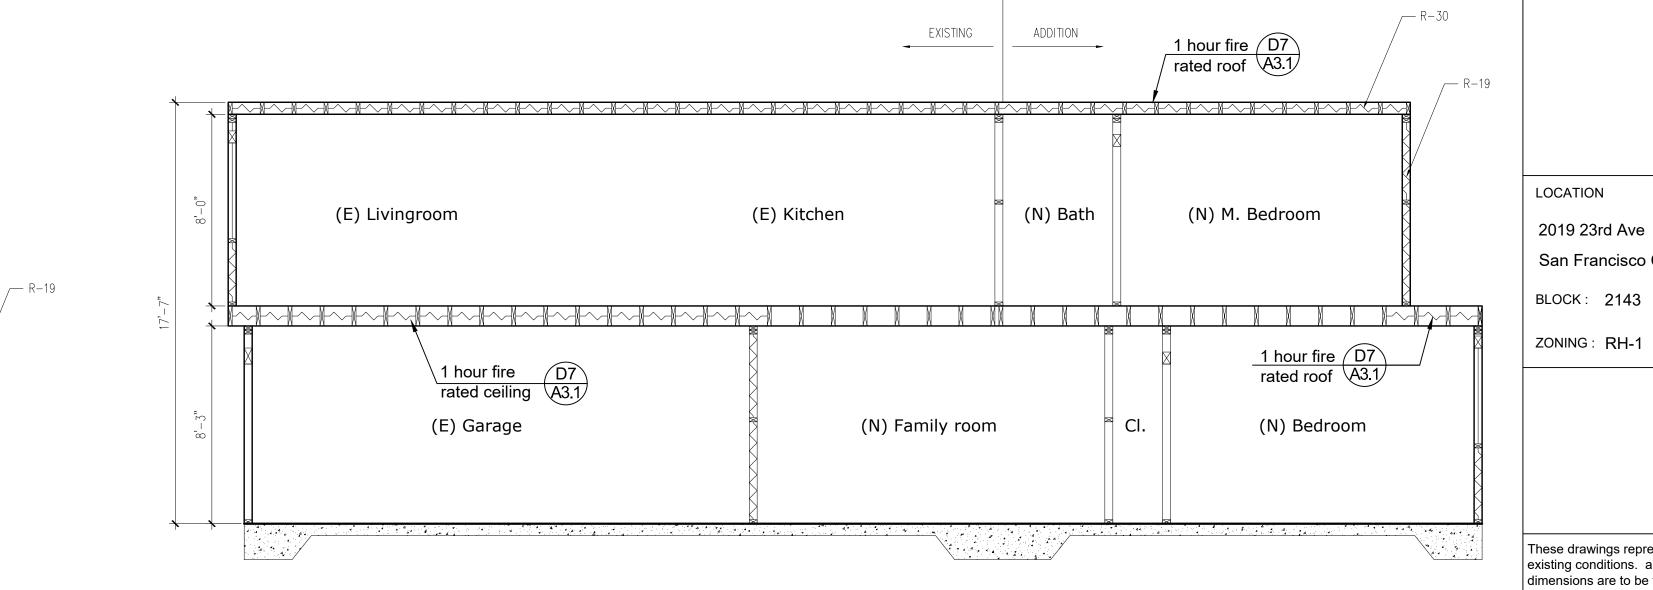

 $4 \frac{\text{New section}}{\frac{1}{4} = \frac{1}{0} = 0}$ 

 $2^{\frac{\text{New section}}{1/4" = 1' - 0"}}$ 

YUFLUX ENGINEERING LLC

5418A GEARY BLVD. SAN FRANCISCO, CA P 415-322-0793 F 4 I 5-963-4080

Avenue 2018-08-30-8786

REVISIONS DESCRIPTION Site permit update Site permit update 4/28/2021

PROJECT TITLE Residential horizontal addition

SHEET TITLE Sections


LOCATION

2019 23rd Ave San Francisco CA 94116

LOT: 005

ZONING: RH-1

These drawings represent approximations of existing conditions. all conditions and dimensions are to be field verified by contractors prior to construction.

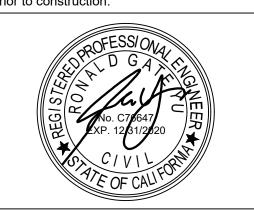

DRAWN

**AS NOTED** 

7/23/2020

PROJECT NO.

A2.5

