GREEN ROOF PLANTING FLAVOR

GREEN ROOF AND DECK PRELIMINARY PLANT LIST Common Name

Botanical Name

Shrubs + Groundcovers:

Achillea tomentosa Armeria maritima ssp. californica Blechnum spicant Carex praegracilis Chondropetalum tectorum Festuca 'Molate' Fragaria chiloensis Iris douglasiana Koeleria glauca Lomandra 'Breeze' Sedum spurium

Sea Pink Deer Fern Field Sedge Cape Reed Tomales Bay Fescue Molate Sedge Strawberry Douglas Iris Blue Hair Grass Lomandra Two-row Stonecrop

KEYED NOTES

- 1 GREEN ROOF OVER GARAGE
- 2 ROOF DECK
- 3 BENCH
- 4 ROOF DECK ACCESS / SLIDING SKYLIGHT
- 5 ROOF GARDEN
- 6 PLANTER

bernard trainor + associates LANDSCAPE ARCHITECTURE

tel: 831.655.1414 fax: 831.655.3462

www.bernardtrainor.com

PROJECT NAME COX VICHIT-VADAKAN RESIDENCE

JOB NO. 12-009 PROJECT ADDRESS 3660 21ST STREET, SAN FRANCISCO, CA. 94114

CLIENT NAME 3660 21ST STREET, LLC

CURRENT RELEASE DATE: 01.28.2014

CURRENT RELEASE SET: SITE PERMIT AND VARIANCE SET REVISION 2

> PREVIOUS RELEASE SITE PERMIT CHECK SET 05 07 2013 REVISION 1

SHEET TITLE PRELIMINARY LANDSCAPE PLAN -ROOF AND DECK **AREAS**













Flavor Images are not intended to be exact representations of materials, finishes, colors and/or installation details for the Cox Vichit-Vadakan Residence project. Rather, the images provide a preliminary depiction of each depicted site element, as shown and described herein.

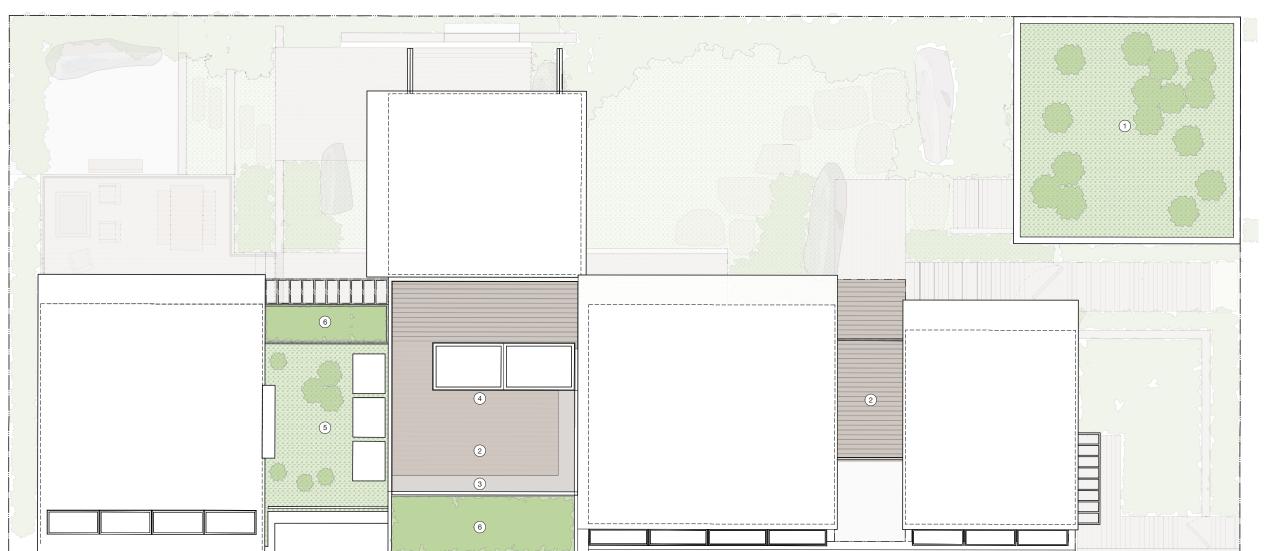

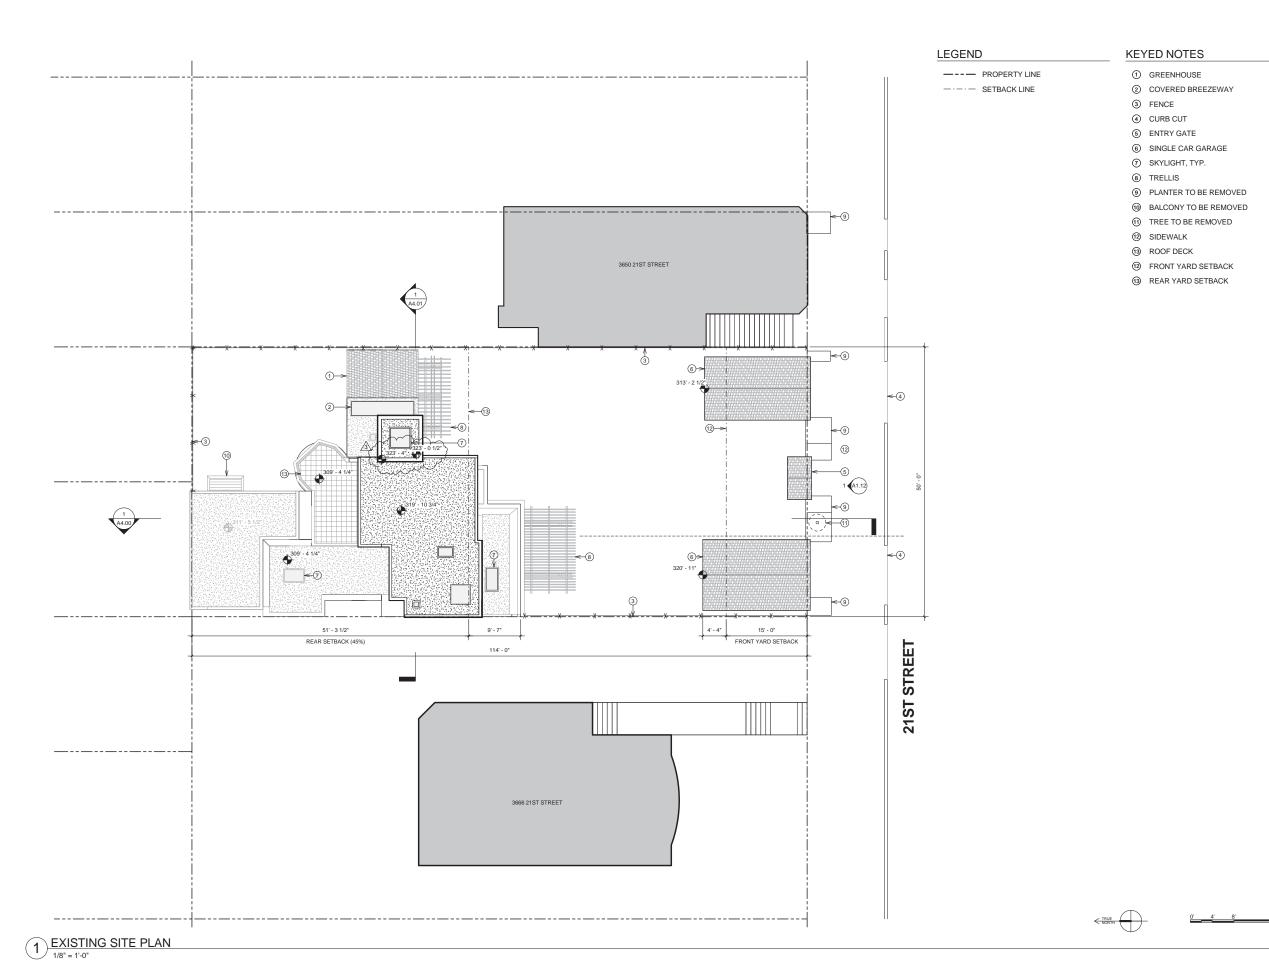



1005 Sansome St, Ste 240 San Francisco, CA 94111 p 415 252 1441 f 415 252 1442



PROJECT NAME 3660 21ST STREET

JOB NO. 12-009 PROJECT ADDRESS 3660 21ST STREET, SAN FRANCISCO, CA. 94114

CLIENT NAME
3660 21ST STREET,
LLC

CURRENT RELEASE DATE: 02.26.2014

CURRENT RELEASE SET:


SITE PERMIT & VARIANCE SET REV.3

PREVIOUS RELEASE

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SHEET TITLE
EXISTING SITE PLAN

A1.10



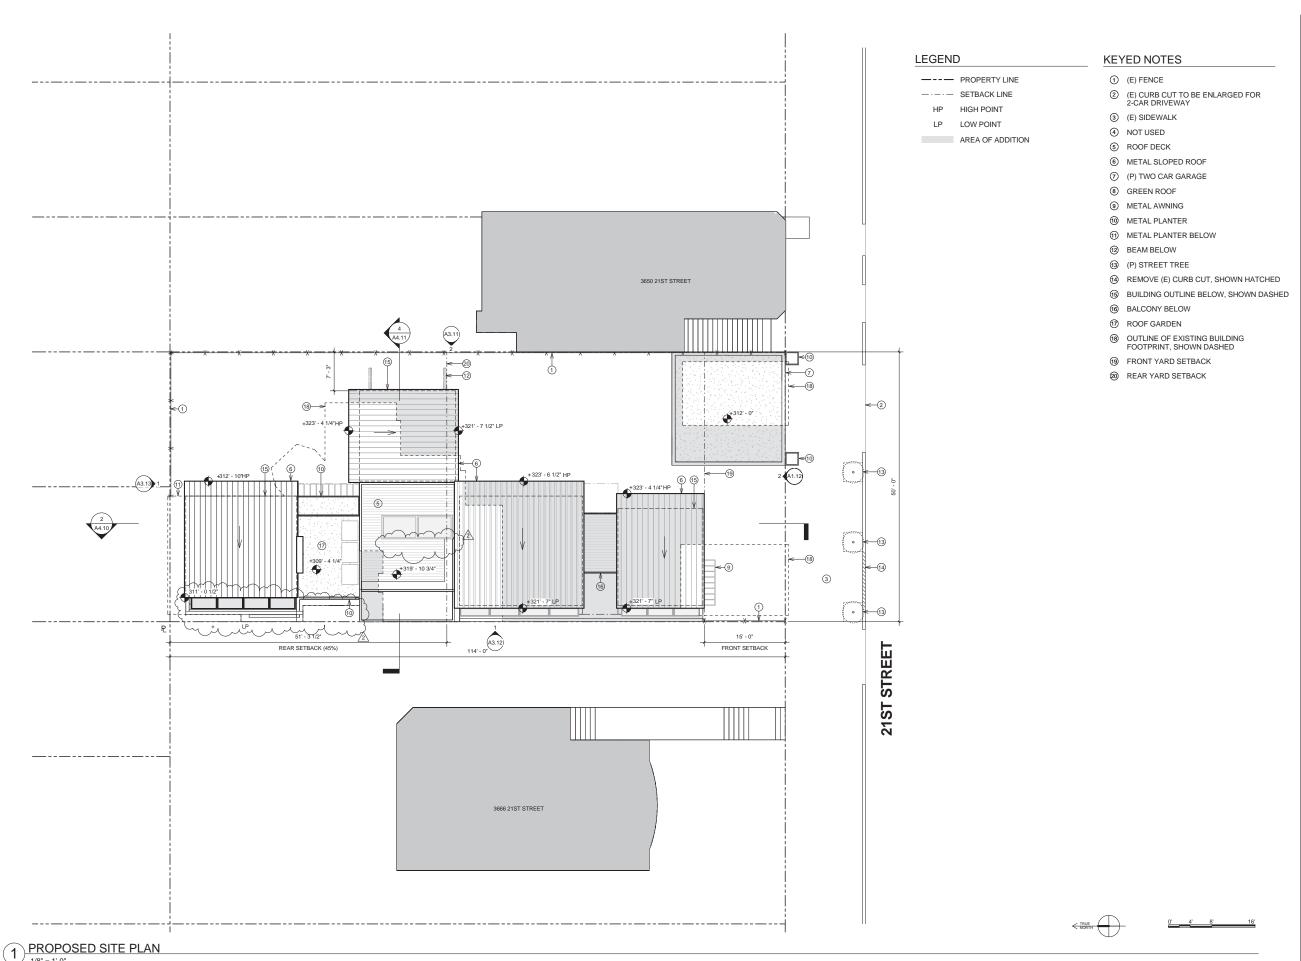

1005 Sansome St, Ste 240 San Francisco, CA 94111 p 415 252 1441 f 415 252 1442



PROJECT NAME
3660 21ST
STREET

JOB NO. 12-009 PROJECT ADDRESS 3660 21ST STREET, SAN FRANCISCO, CA. 94114

CLIENT NAME
3660 21ST STREET,
LLC

CURRENT RELEASE DATE: 01.28.2014

CURRENT RELEASE SET:


SITE PERMIT & VARIANCE SET REV.2

PREVIOUS RELEASE

| ENVIRONMENTAL | 2.14.2013 | EVALUATION (HISTORIC) | NEIGHBORHOOD OUTREACH | 3.13.2013 | SITE PERMIT/VARIANCE | 7.03.2013 | SITE PERMIT/VARIANCE | 7.03.2013 |

SHEET TITLE
PROPOSED SITE PLAN

A1.11

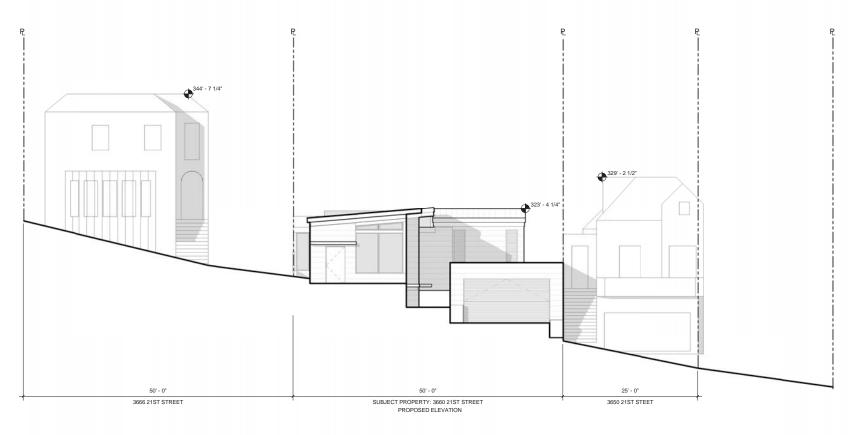

2 SITE CONTEXT - PROPOSED SOUTH ELEVATION

1/8" = 1'-0"



1) SITE CONTEXT - EXISTING SOUTH ELEVATION

FELDMAN ARCHITECTURE

1005 Sansome St, Ste 240 San Francisco, CA 94111 p 415 252 1441 f 415 252 1442



PROJECT NAME
3660 21ST
STREET

JOB NO. 12-009 PROJECT ADDRESS 3660 21ST STREET, SAN FRANCISCO, CA. 94114

CLIENT NAME
3660 21ST STREET,
LLC

CURRENT RELEASE DATE: 01.28.2014

CURRENT RELEASE SET:

2 SITE PERMIT & VARIANCE SET REV.2

PREVIOUS RELEASE

| ENVIRONMENTAL | 2.14.2013 | EVALUATION (HISTORIC) | NEIGHBORHOOD OUTREACH | 3.13.2013 | SITE PERMIT/VARIANCE | 3.29.2013 | SITE PERMIT/VARIANCE | 7.03.2013 |

SHEET TITLE
SITE CONTEXT
ELEVATIONS

A1.12

① GARAGE ABOVE SHOWN DASHED

3 HOUSE ABOVE SHOWN DASHED 4 FRONT YARD SETBACK ⑤ REAR YARD SETBACK

② GREENHOUSE ABOVE SHOWN DASHED

LEGEND

EXISTING WALL TO REMAIN

___ DEMO

SHEET NOTES

ALL DIMENSIONS ARE TO FACE OF FRAMING U.O.N.

2. CONTRACTOR TO FIELD VERIFY ALL DIMENSIONS, TYP.



1005 Sansome St, Ste 240 San Francisco, CA 94111 p 415 252 1441 f 415 252 1442



PROJECT NAME 3660 21ST STREET

JOB NO. 12-009 PROJECT ADDRESS 3660 21ST STREET, SAN FRANCISCO, CA. 94114

CLIENT NAME 3660 21ST STREET, LLC


CURRENT RELEASE DATE: 01.28.2014

CURRENT RELEASE SET: SITE PERMIT & VARIANCE SET REV.2

PREVIOUS RELEASE

ENVIRONMENTAL EVALUATION (HISTORIC) NEIGHBORHOOD OUTREACH 3.13.2013 SITE PERMIT/VARIANCE 3.29.2013 SITE PERMIT/VARIANCE R1 7.03.2013

SHEET TITLE EXISTING/DEMO UNCONDITIONED BASEMENT FLOOR PLAN

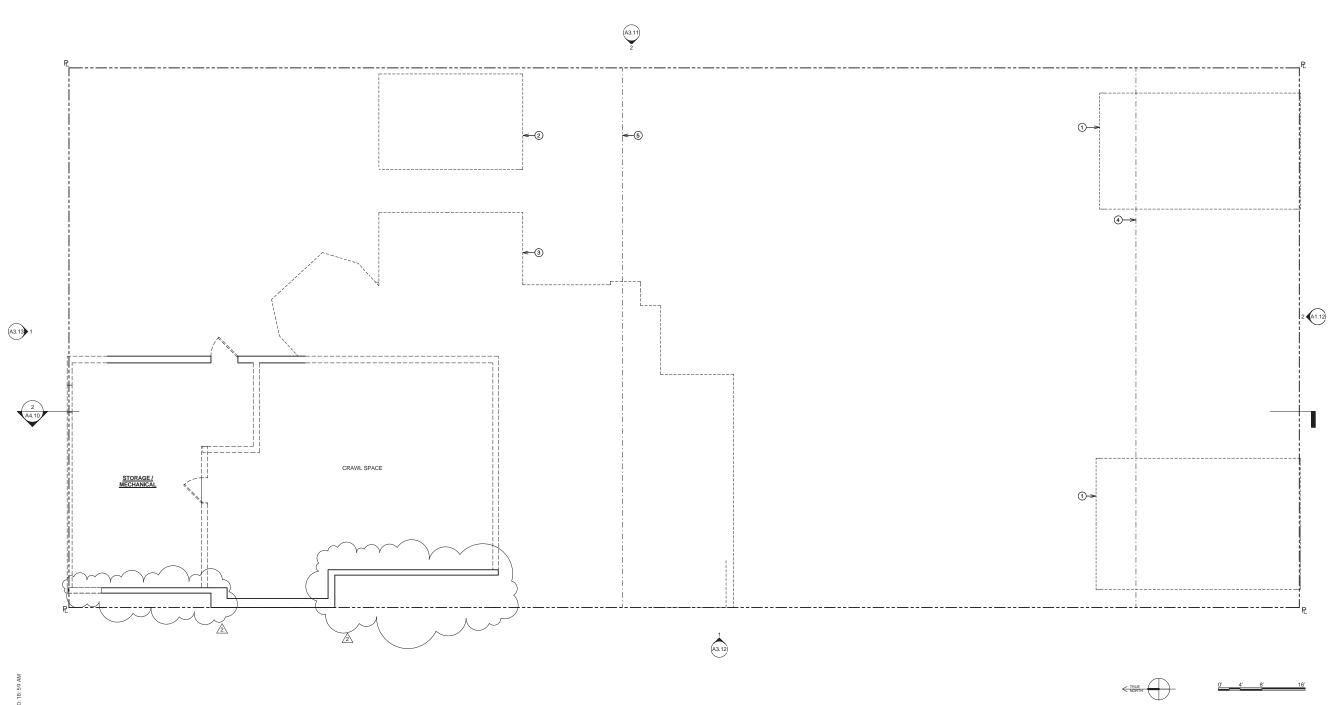

KEYED NOTES ① GREENHOUSE

> ③ SKYLIGHT 4 TRELLIS ⑤ BALCONY 6 DECK

② COVERED BREEZEWAY

7 GARAGE ABOVE SHOWN DASHED 8 FRONT YARD SETBACK 9 REAR YARD SETBACK

LEGEND

EXISTING WALL TO REMAIN

___ _ DEMO

SHEET NOTES

ALL DIMENSIONS ARE TO FACE OF FRAMING U.O.N.

2. CONTRACTOR TO FIELD VERIFY ALL DIMENSIONS, TYP.

FELDMAN

1005 Sansome St, Ste 240 San Francisco, CA 94111 p 415 252 1441 f 415 252 1442



PROJECT NAME 3660 21ST STREET

JOB NO. 12-009 PROJECT ADDRESS 3660 21ST STREET, SAN FRANCISCO, CA. 94114

CLIENT NAME 3660 21ST STREET, LLC


CURRENT RELEASE DATE: 01.28.2014

CURRENT RELEASE SET: SITE PERMIT & VARIANCE SET REV.2

PREVIOUS RELEASE

ENVIRONMENTAL EVALUATION (HISTORIC) NEIGHBORHOOD OUTREACH 3.13.2013 SITE PERMIT/VARIANCE 3.29.2013 SITE PERMIT/VARIANCE R1 7.03.2013

SHEET TITLE EXISTING/DEMO FIRST FLOOR & GARAGE A FLOOR PLAN

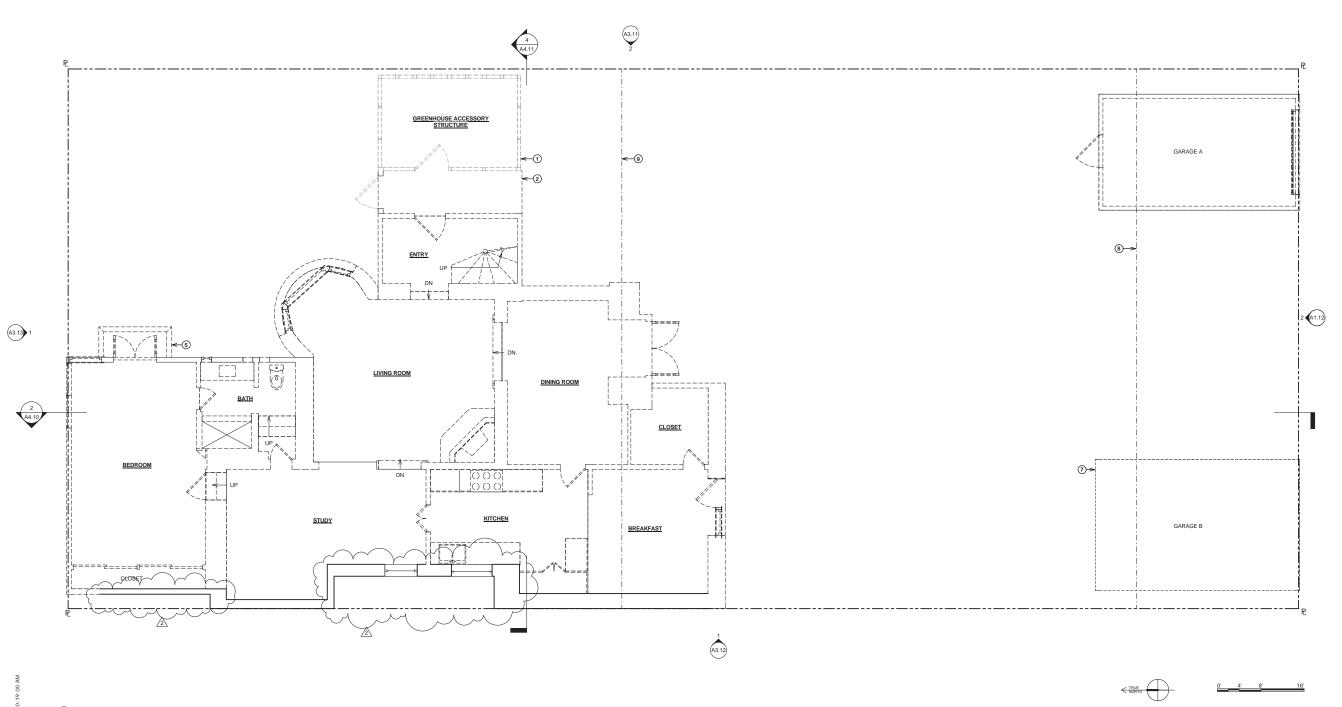

KEYED NOTES ① GREENHOUSE

> ③ SKYLIGHT 4 TRELLIS ⑤ BALCONY ⑥ DECK

② COVERED BREEZEWAY

FRONT YARD SETBACK REAR YARD SETBACK

LEGEND

___ _ DEMO

EXISTING WALL TO REMAIN

SHEET NOTES

ALL DIMENSIONS ARE TO FACE OF FRAMING U.O.N.

2. CONTRACTOR TO FIELD VEIRFY ALL DIMENSIONS, TYP.

FELDMAN 1005 Sansome St, Ste 240

San Francisco, CA 94111 p 415 252 1441 f 415 252 1442



PROJECT NAME 3660 21ST STREET

JOB NO. 12-009 PROJECT ADDRESS 3660 21ST STREET, SAN FRANCISCO, CA. 94114

CLIENT NAME 3660 21ST STREET, LLC


CURRENT RELEASE DATE: 01.28.2014

CURRENT RELEASE SET: SITE PERMIT & VARIANCE SET REV.2

PREVIOUS RELEASE

ENVIRONMENTAL EVALUATION (HISTORIC) NEIGHBORHOOD OUTREACH 3.13.2013 SITE PERMIT/VARIANCE 3.29.2013 SITE PERMIT/VARIANCE R1 7.03.2013

SHEET TITLE EXISTING/DEMO SECOND FLOOR & GARAGE B FLOOR PLAN

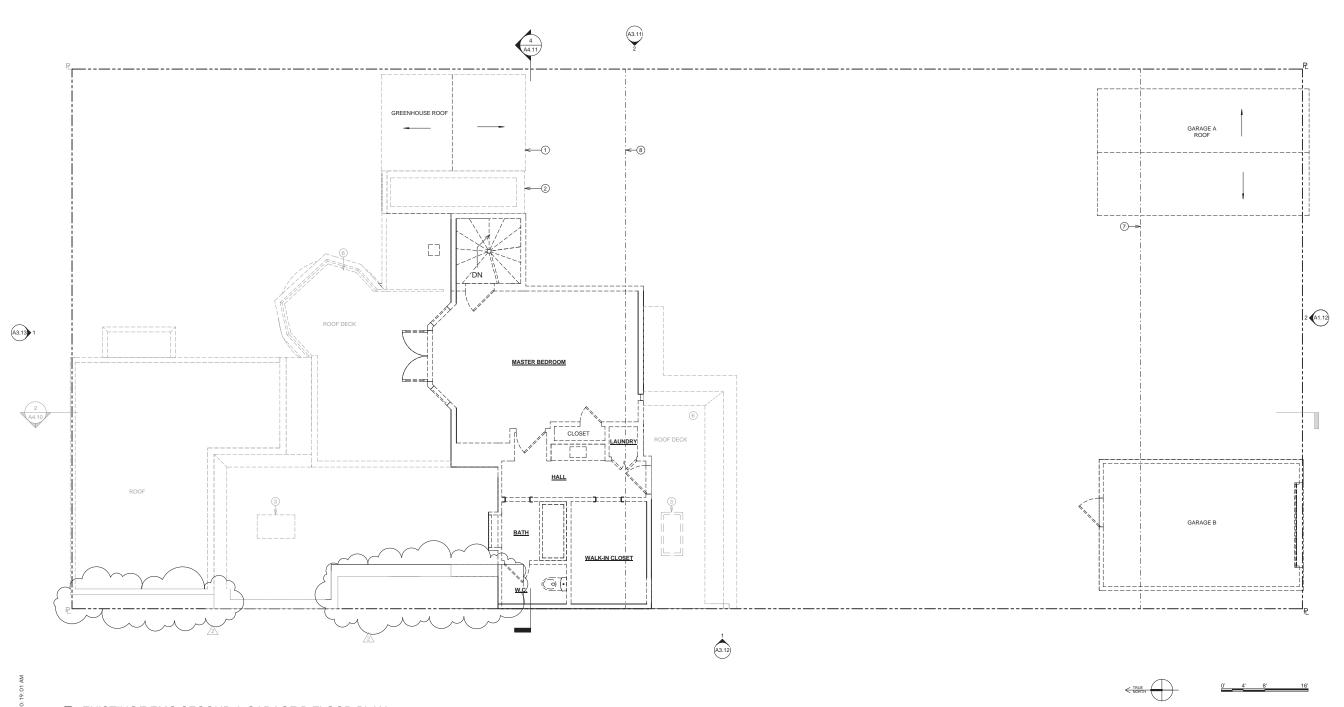

GREENHOUSE
 COVERED BREEZEWAY

③ ENTRY GATE④ SINGLE CAR GARAGE⑤ SKYLIGHT, TYP.⑥ TRELLIS

8 ROOF DECK9 FRONT YARD SETBACK10 REAR YARD SETBACK

BALCONY TO BE REMOVED

_____ EXISTING WALL

LEGEND

EXISTING WALL TO REMAIN

SHEET NOTES

ALL DIMENSIONS ARE TO FACE OF FRAMING U.O.N.

2. CONTRACTOR TO FIELD VERIFY ALL DIMENSIONS, TYP.

FELDMAN ARCHITECTURE

1005 Sansome St, Ste 240 San Francisco, CA 94111 p 415 252 1441 f 415 252 1442



PROJECT NAME
3660 21ST
STREET

JOB NO. 12-009 PROJECT ADDRESS 3660 21ST STREET, SAN FRANCISCO, CA. 94114

CLIENT NAME
3660 21ST STREET,
LLC

CURRENT RELEASE DATE: 01.28.2014


CURRENT RELEASE SET:

SITE PERMIT & VARIANCE SET REV.2

PREVIOUS RELEASE

| ENVIRONMENTAL | 2.14.2013 | EVALUATION (HISTORIC) | NEIGHBORHOOD OUTREACH | 3.13.2013 | SITE PERMIT/VARIANCE | 3.29.2013 | SITE PERMIT/VARIANCE | 7.03.2013 |

SHEET TITLE
EXISTING/DEMO
ROOF PLAN

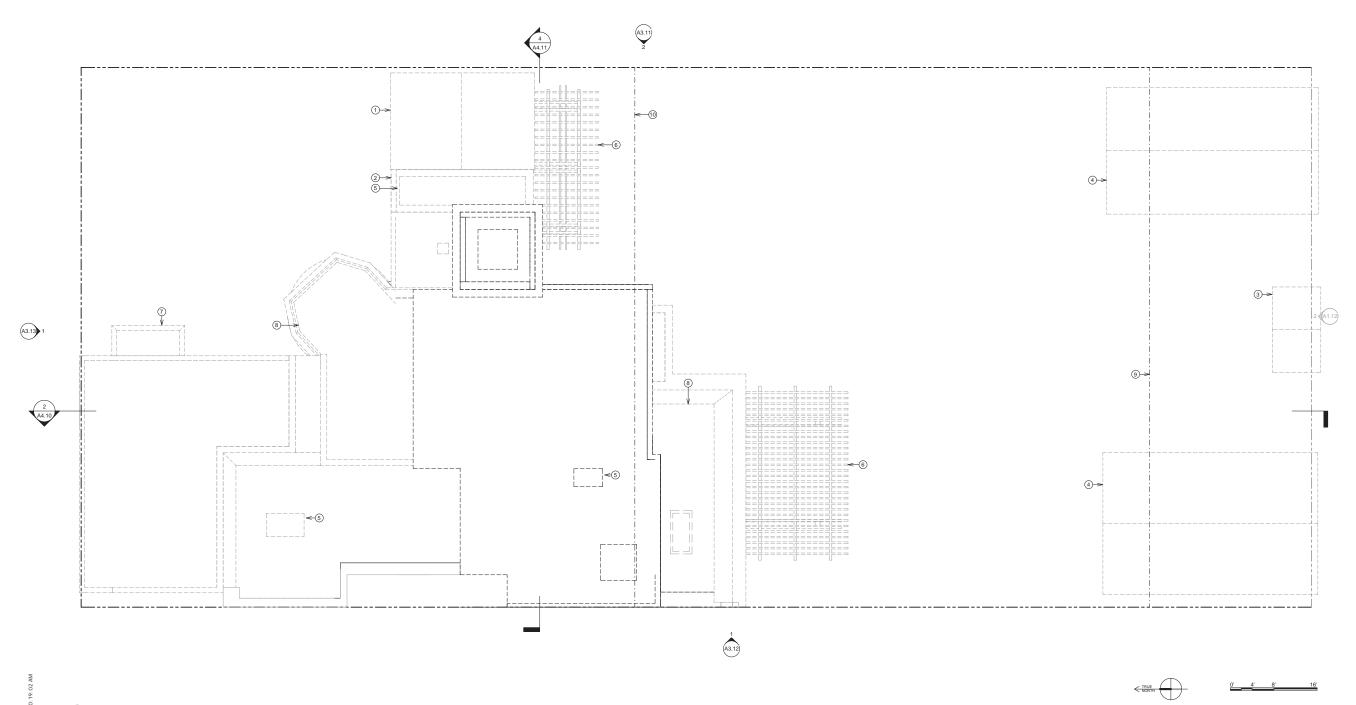

KEYED NOTES GARAGE ABOVE SHOWN DASHED

② HOUSE ABOVE SHOWN DASHED

③ FRONT YARD SETBACK

4 REAR YARD SETBACK

LEGEND

NEW WALL

EXISTING WALL TO REMAIN

AREA OF ADDITION

SHEET NOTES

ALL DIMENSIONS ARE TO FACE OF FRAMING U.O.N.

2. CONTRACTOR TO FIELD VERIFY ALL DIMENSIONS, TYP.

San Francisco, CA 94111

1005 Sansome St, Ste 240

FELDMAN

p 415 252 1441 f 415 252 1442



PROJECT NAME 3660 21ST STREET

JOB NO. 12-009 PROJECT ADDRESS 3660 21ST STREET, SAN FRANCISCO, CA.

94114

LLC

CLIENT NAME

01.28.2014

3660 21ST STREET,

(GB) (G1) -(G2) ② ③→

SITE PERMIT & VARIANCE SET REV.2

CURRENT RELEASE DATE:


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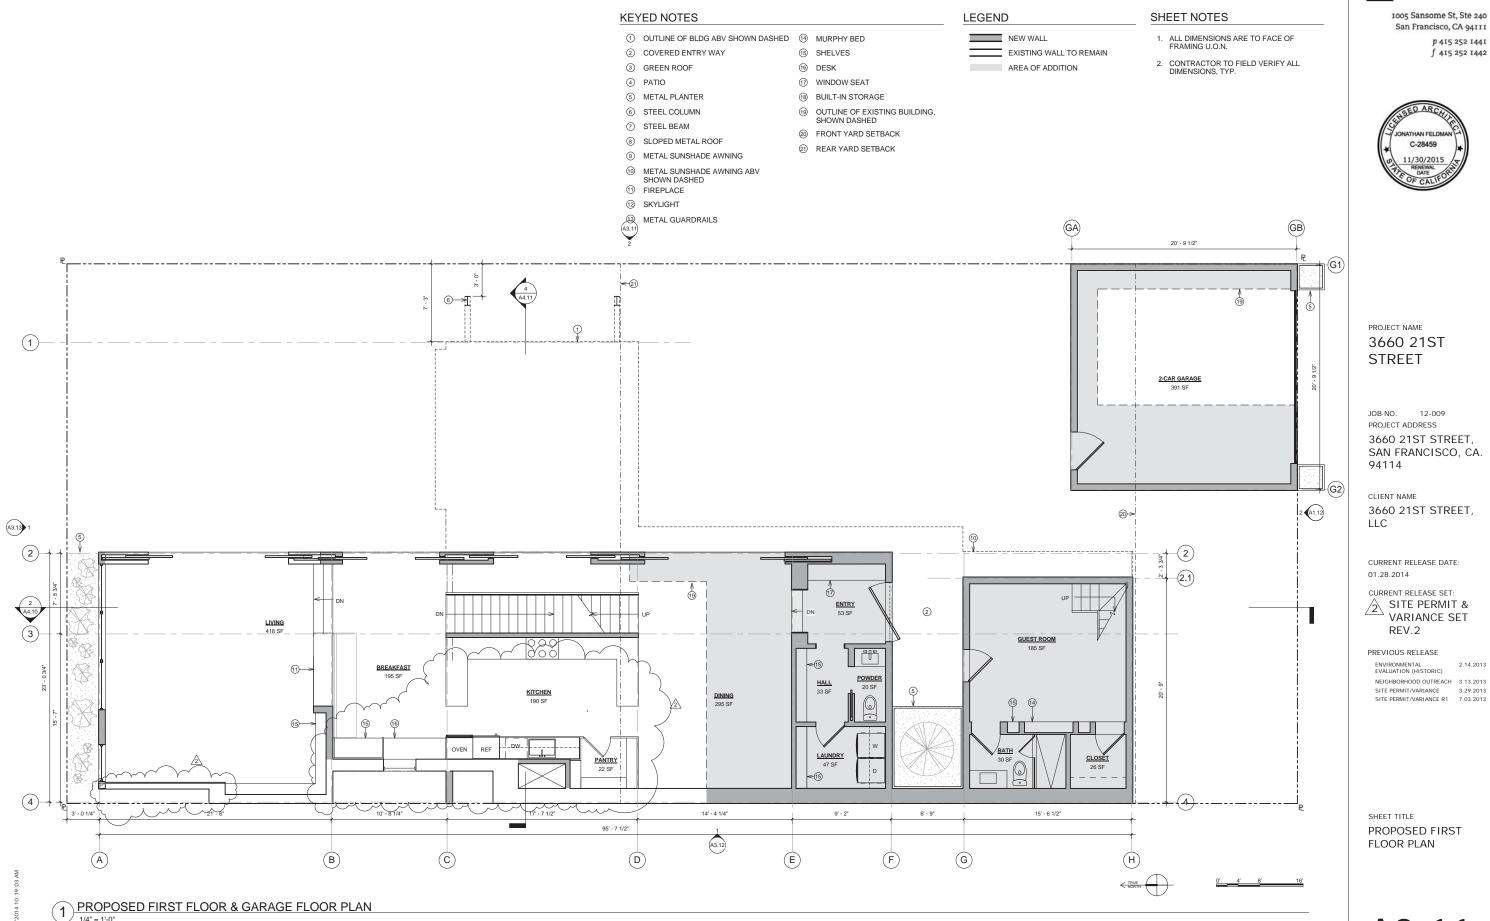
PREVIOUS RELEASE

ENVIRONMENTAL EVALUATION (HISTORIC) NEIGHBORHOOD OUTREACH 3.13.2013

SITE PERMIT/VARIANCE 3.29.2013 SITE PERMIT/VARIANCE R1 7.03.2013

SHEET TITLE PROPOSED BASEMENT FLOOR PLAN



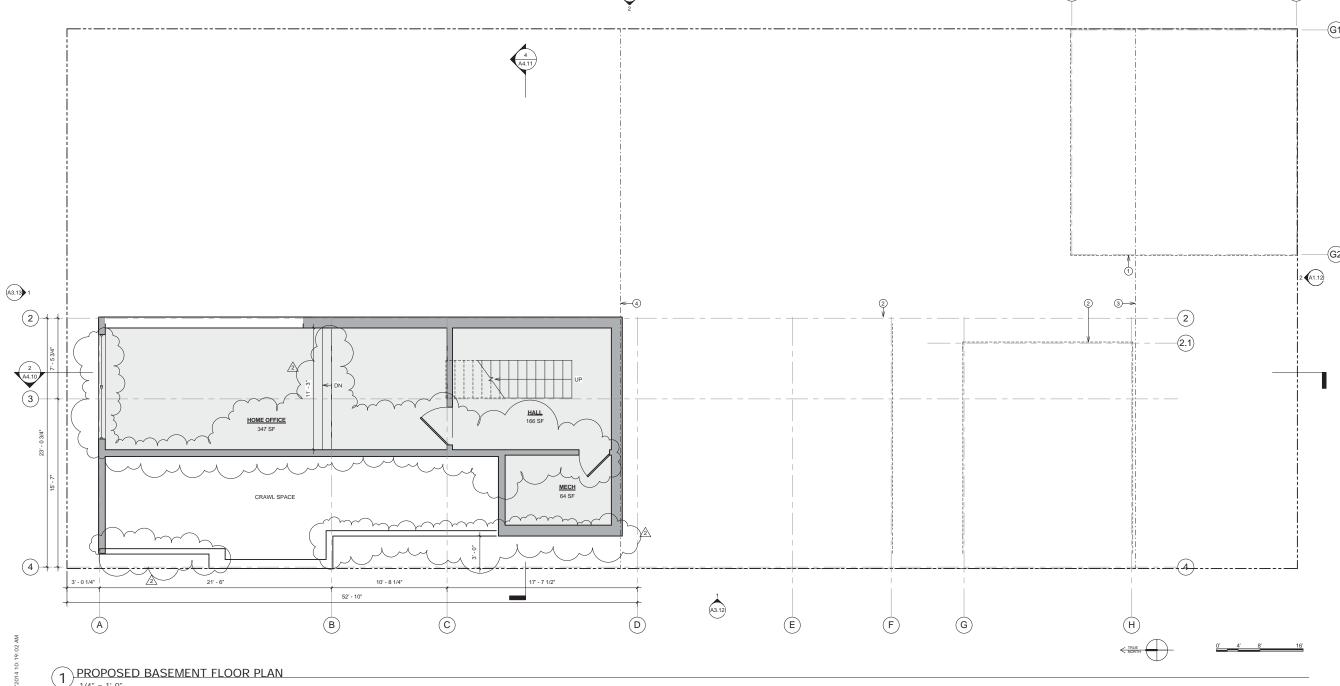


FELDMAN ARCHITECTURE

San Francisco, CA 94111 p 415 252 1441 f 415 252 1442

SAN FRANCISCO, CA.

NEIGHBORHOOD OUTREACH 3.13.2013 SITE PERMIT/VARIANCE 3.29.2013 SITE PERMIT/VARIANCE R1 7.03.2013

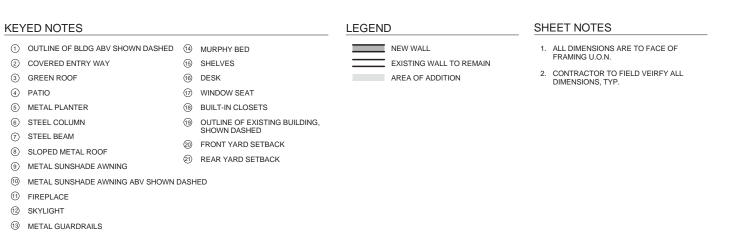



1005 Sansome St, Ste 240 San Francisco, CA 94111 p 415 252 1441 f 415 252 1442





JOB NO. 12-009 PROJECT ADDRESS 3660 21ST STREET, SAN FRANCISCO, CA. 94114

CLIENT NAME
3660 21ST STREET,
LLC

CURRENT RELEASE DATE: 01.28.2014


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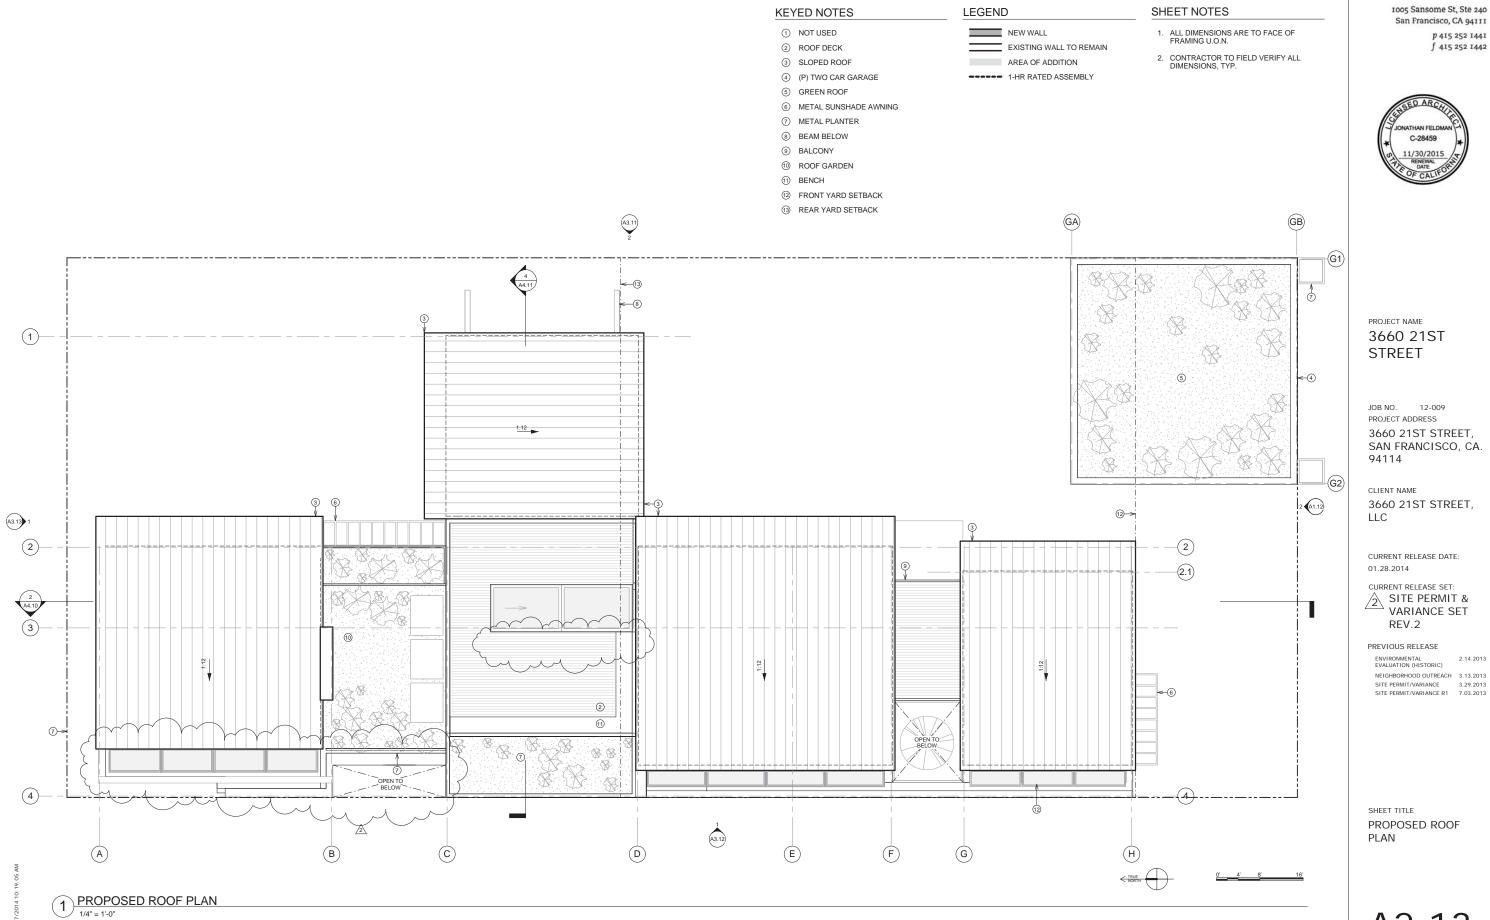
SITE PERMIT & VARIANCE SET REV.2

PREVIOUS RELEASE

| ENVIRONMENTAL | 2.14.2013 | EVALUATION (HISTORIC) | NEIGHBORHOOD OUTREACH | 3.13.2013 | SITE PERMIT/VARIANCE | 3.29.2013 | SITE PERMIT/VARIANCE | 7.03.2013 |

SHEET TITLE
PROPOSED SECOND
FLOOR PLAN



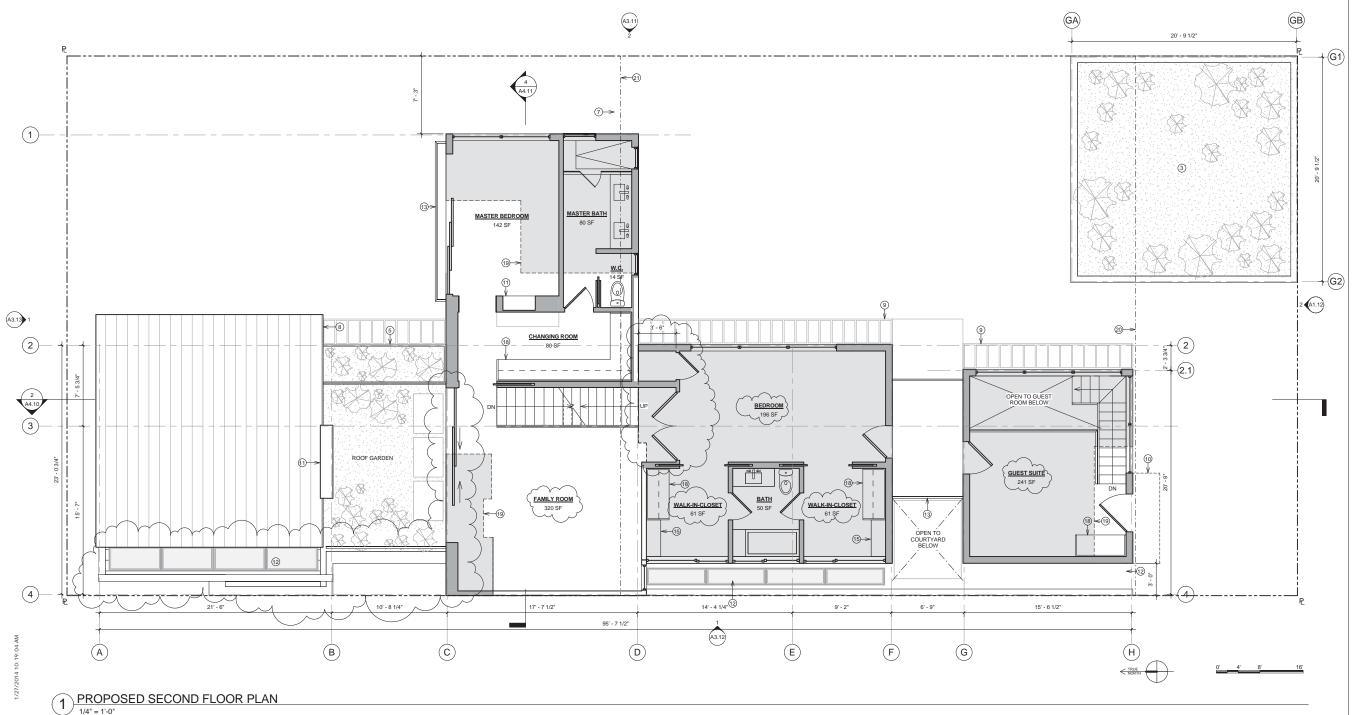

FELDMAN ARCHITECTURE


San Francisco, CA 94111 p 415 252 1441 f 415 252 1442



3660 21ST STREET, SAN FRANCISCO, CA.

3660 21ST STREET,

NEIGHBORHOOD OUTREACH 3.13.2013 SITE PERMIT/VARIANCE 3.29.2013 SITE PERMIT/VARIANCE R1 7.03.2013

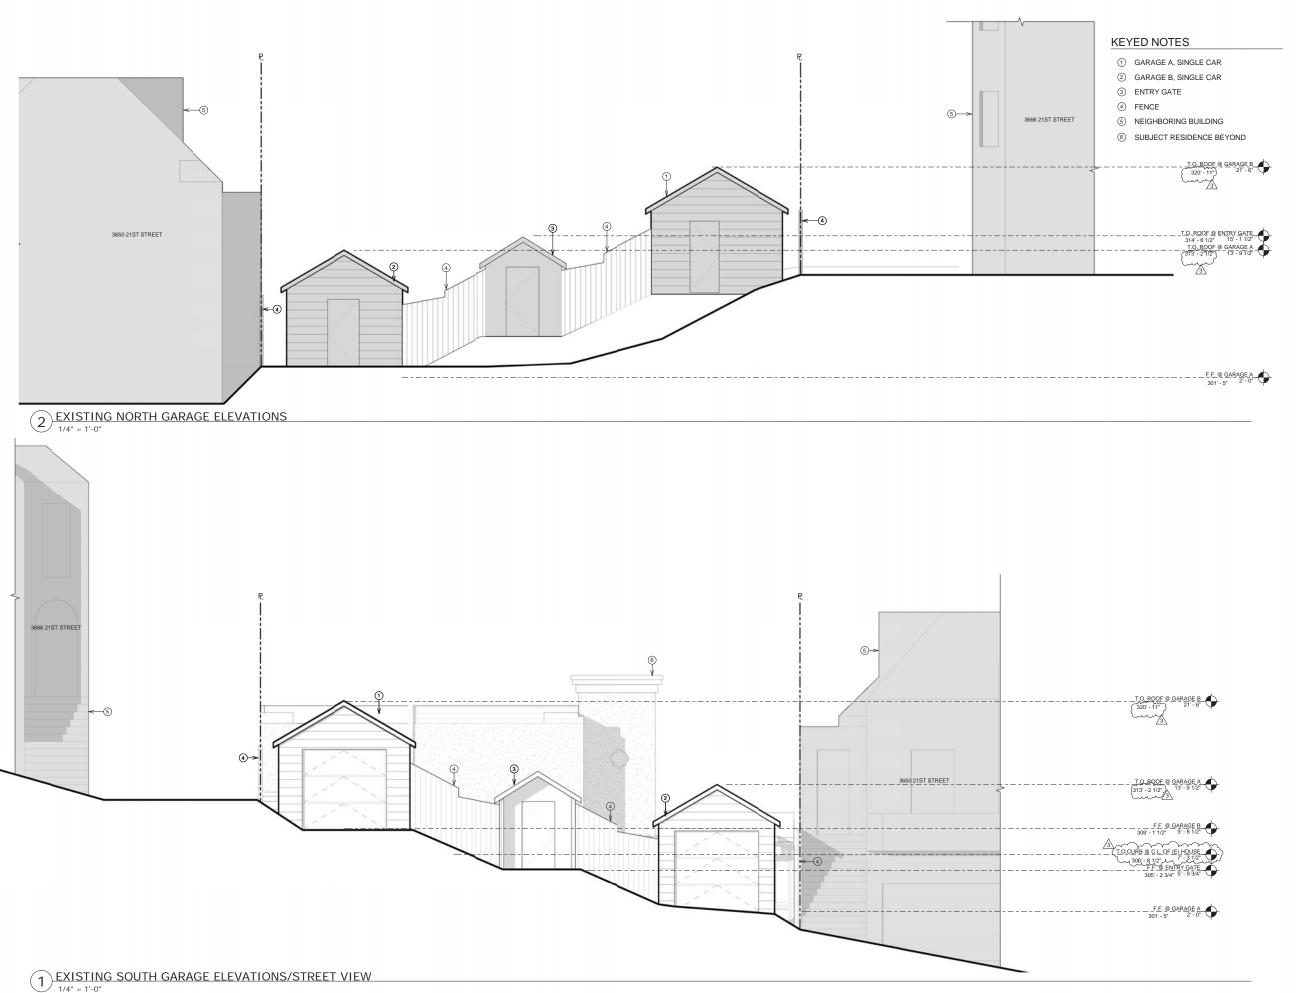



1005 Sansome St, Ste 240 San Francisco, CA 94111 p 415 252 1441 f 415 252 1442



PROJECT NAME
3660 21ST
STREET

JOB NO. 12-009 PROJECT ADDRESS 3660 21ST STREET, SAN FRANCISCO, CA. 94114

CLIENT NAME 3660 21ST STREET, LLC

CURRENT RELEASE DATE: 02.26.2014

CURRENT RELEASE SET:

SITE PERMIT & VARIANCE SET REV.3

PREVIOUS RELEASE

SHEET TITLE

EXISTING GARAGE

ELEVATION/STREET

VIEW

- ① GREENHOUSE
- ② COVERED BREEZEWAY
- ③ WOOD TRELLIS
- OUTLINE OF NEIGHBORING BUILDING BEHIND, SHOWN DASHED
- ⑤ GRADE @ P.L. BEYOND
- BALCONY TO BE REMOVED
- 7 GARAGE A, SINGLE CAR 8 NEIGHBORING BUILDING
- GRADE BEYOND
- ① FENCE



FELDMAN

1005 Sansome St, Ste 240

San Francisco, CA 94111

p 415 252 1441

f 415 252 1442

PROJECT NAME 3660 21ST STREET

JOB NO. 12-009 PROJECT ADDRESS 3660 21ST STREET, SAN FRANCISCO, CA. 94114

CLIENT NAME 3660 21ST STREET, LLC


CURRENT RELEASE DATE: 01.28.2014



PREVIOUS RELEASE

ENVIRONMENTAL EVALUATION (HISTORIC) NEIGHBORHOOD OUTREACH 3.13.2013 SITE PERMIT/VARIANCE 3.29.2013 SITE PERMIT/VARIANCE R1 7.03.2013

SHEET TITLE **EXISTING SOUTH** ELEVATION

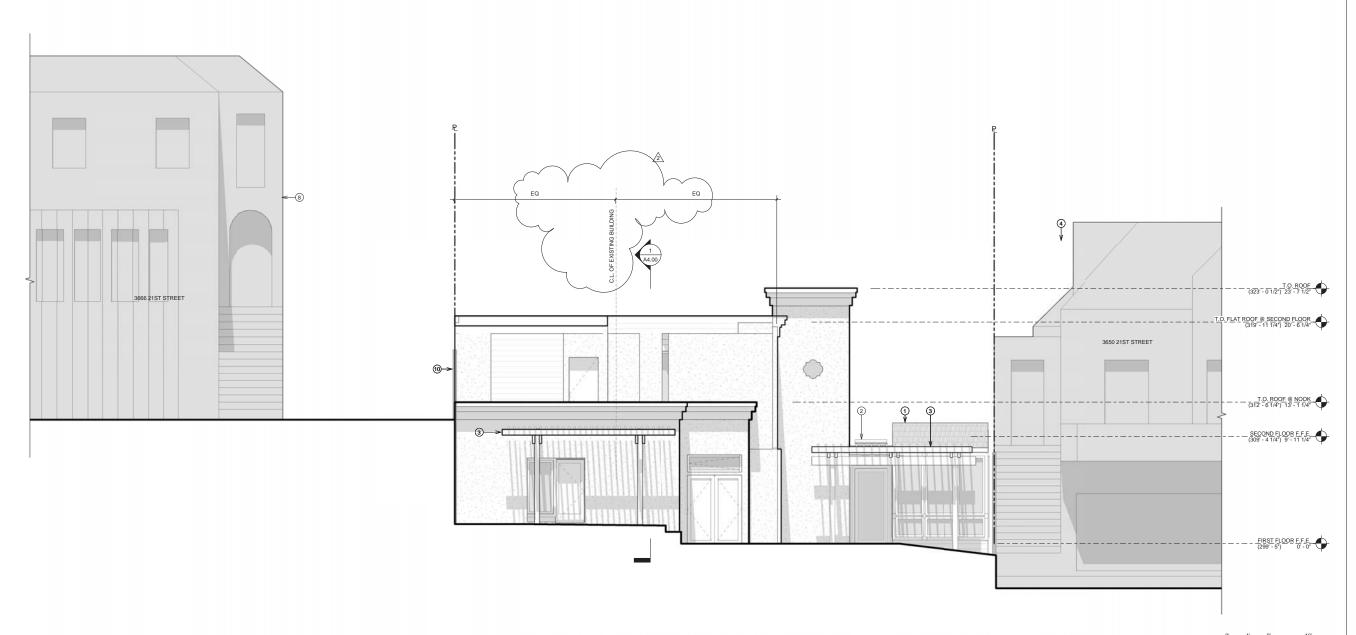

- ① GREENHOUSE
- ② COVERED BREEZEWAY
- ③ WOOD TRELLIS
- OUTLINE OF NEIGHBORING BUILDING BEYOND
- 5 GRADE @ P.L. BEYOND
- BALCONY TO BE REMOVED
- ⑦ GARAGE A, SINGLE CAR
- 8 FENCE



1005 Sansome St, Ste 240 San Francisco, CA 94111 p 415 252 1441 f 415 252 1442



PROJECT NAME 3660 21ST STREET

JOB NO. 12-009 PROJECT ADDRESS 3660 21ST STREET, SAN FRANCISCO, CA. 94114

CLIENT NAME 3660 21ST STREET, LLC


CURRENT RELEASE DATE: 01.28.2014

CURRENT RELEASE SET: SITE PERMIT & VARIANCE SET REV.2

PREVIOUS RELEASE

ENVIRONMENTAL EVALUATION (HISTORIC) 2.14.2013 NEIGHBORHOOD OUTREACH 3.13.2013 SITE PERMIT/VARIANCE 3.29.2013 SITE PERMIT/VARIANCE R1 7.03.2013

SHEET TITLE **EXISTING EAST** ELEVATION

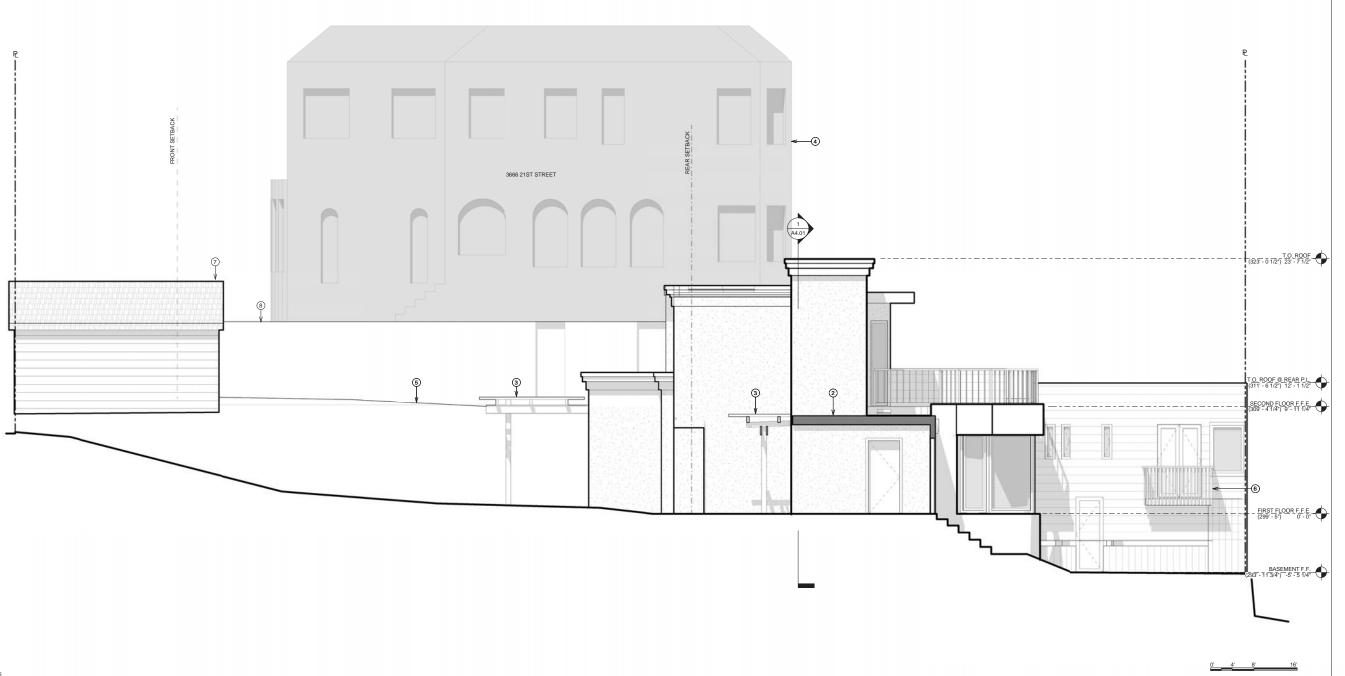


- ① GREENHOUSE
- ② COVERED BREEZEWAY
- ③ WOOD TRELLIS
- 4 OUTLINE OF NEIGHBORING BUILDING BEYOND
- ⑤ GRADE @ P.L. BEYOND
- BALCONY TO BE REMOVED
- 7 GARAGE A, SINGLE CAR
- 8 FENCE



1005 Sansome St, Ste 240 San Francisco, CA 94111 p 415 252 1441 f 415 252 1442



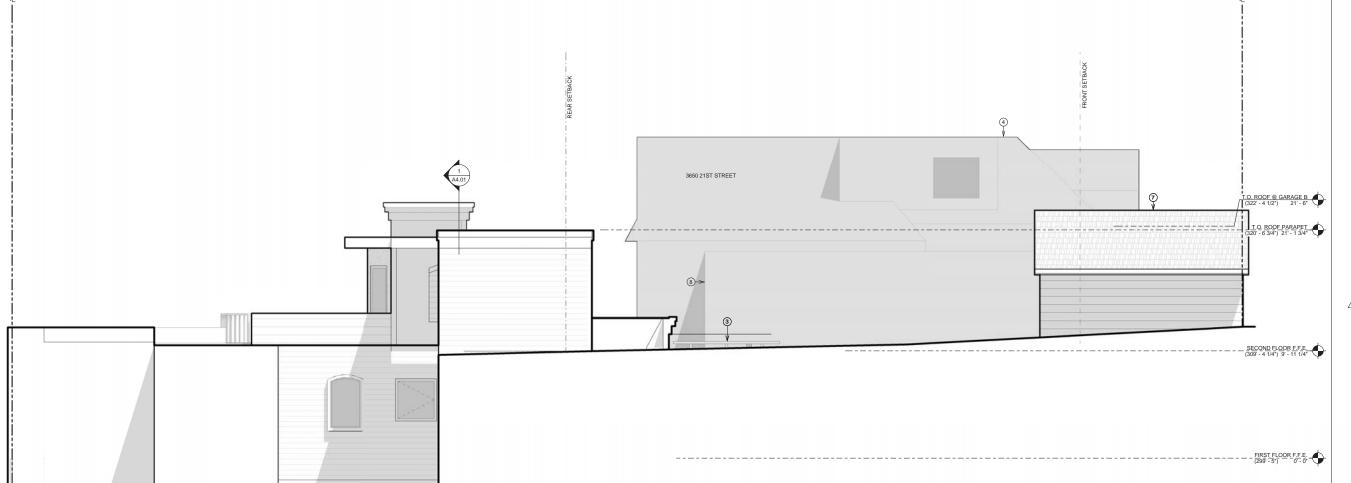

PROJECT NAME
3660 21ST
STREET

JOB NO. 12-009 PROJECT ADDRESS 3660 21ST STREET, SAN FRANCISCO, CA. 94114

CLIENT NAME 3660 21ST STREET, LLC

CURRENT RELEASE DATE: 01.28.2014

CURRENT RELEASE SET:

SITE PERMIT & VARIANCE SET REV.2

PREVIOUS RELEASE

| ENVIRONMENTAL | 2.14.2013 | EVALUATION (HISTORIC) | NEIGHBORHOOD OUTREACH | 3.13.2013 | SITE PERMIT/VARIANCE | 3.29.2013 | SITE PERMIT/VARIANCE | 7.03.2013 |

SHEET TITLE
EXISTING WEST
ELEVATION

A3.03

1) EXISTING WEST ELEVATION

1/4" = 1'-0"

7/2014 10: 19: 24


- ① GREENHOUSE
- ② COVERED BREEZEWAY
- ③ WOOD TRELLIS
- 4 OUTLINE OF NEIGHBORING BUILDING
- 5 GRADE @ P.L. BEYOND
- BALCONY TO BE REMOVED
- ⑦ GARAGE A, SINGLE CAR
- 8 GRADE BEYOND





1005 Sansome St, Ste 240 San Francisco, CA 94111 p 415 252 1441 f 415 252 1442



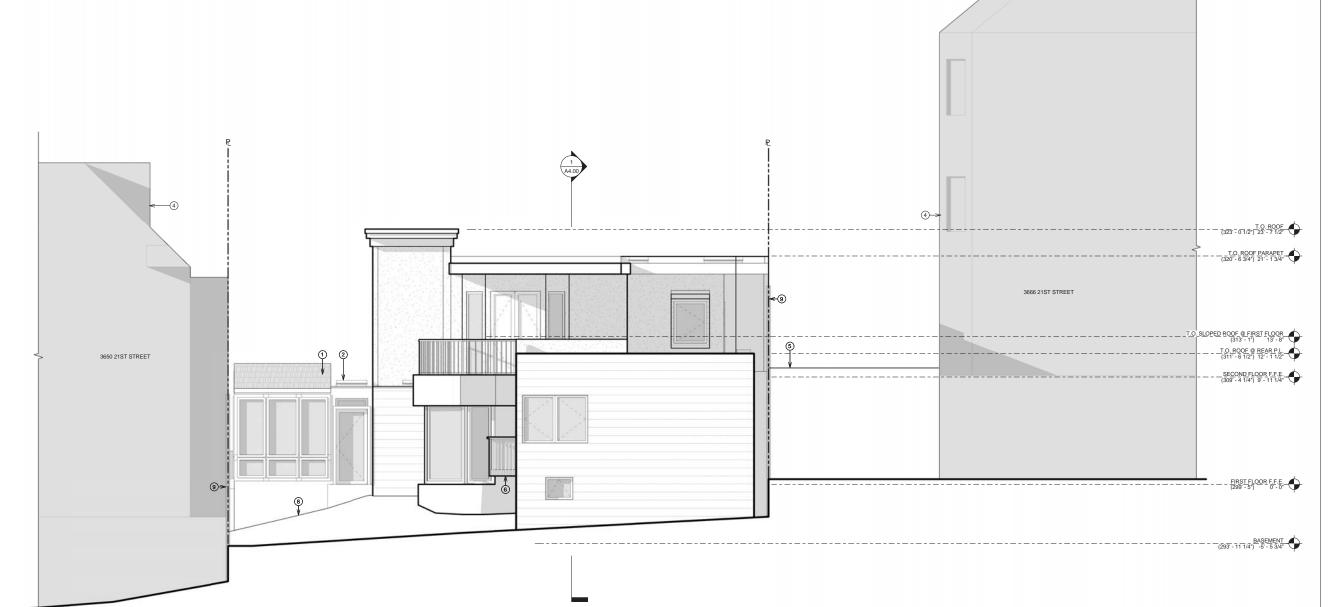

PROJECT NAME 3660 21ST STREET

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CLIENT NAME 3660 21ST STREET, LLC

CURRENT RELEASE DATE: 01.28.2014

CURRENT RELEASE SET:

SITE PERMIT & VARIANCE SET REV.2

PREVIOUS RELEASE

| ENVIRONMENTAL | 2.14.2013 | EVALUATION (HISTORIC) | NEIGHBORHOOD OUTREACH | 3.13.2013 | SITE PERMIT/VARIANCE | 3.29.2013 | SITE PERMIT/VARIANCE | 7.03.2013 |

SHEET TITLE
EXISTING NORTH
ELEVATION

A3.04

1) EXISTING NORTH ELEVATION

- ① GREEN ROOF ABOVE 2-CAR GARAGE
- ② METAL PLANTER
- ③ PAINTED METAL SUNSHADE AWNING
- 4 SLOPED METAL ROOF
- 5 GRADE @ P.L. BEYOND
- 6 METAL GUARDRAILS
- 7 OUTLINE OF NEIGHBORING BUILDING
- 8 (E) FENCE
- WINDOWS BEHIND WOOD SLATS
- (1) STAINED WOOD SIDING
- 11 GLASS GUARDRAIL
- 12 METAL CLAD OR WOOD WINDOWS AND DOORS
- ③ WOOD FASCIA



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PROJECT NAME 3660 21ST STREET

JOB NO. 12-009 PROJECT ADDRESS 3660 21ST STREET, SAN FRANCISCO, CA. 94114

CLIENT NAME 3660 21ST STREET, LLC


CURRENT RELEASE DATE: 02.26.2014



PREVIOUS RELEASE

EVALUATION (HISTORIC)	2.14.2013
NEIGHBORHOOD OUTREACH	3.13.2013
SITE PERMIT/VARIANCE	3.29.2013
SITE PERMIT/VARIANCE R1	7.03.2013
SITE PERMIT/VARIANCE R2	1.28.2014

SHEET TITLE PROPOSED SOUTH ELEVATION

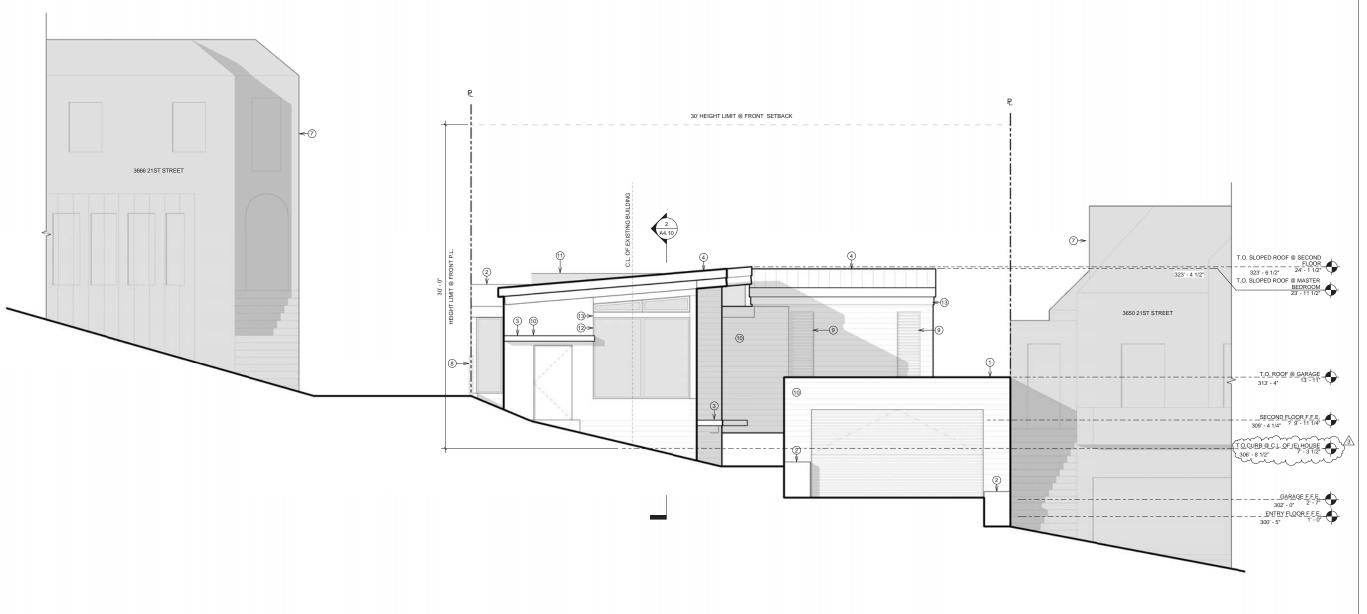



② METAL PLANTER

8 (E) FENCE

SLOPED METAL ROOFGRADE @ P.L. BEYONDMETAL GUARDRAIL

10 STAINED WOOD SIDING

① GREEN ROOF AT GARAGE BEYOND

③ PAINTED METAL SUNSHADE AWNING

OUTLINE OF NEIGHBORING BUILDING BEYOND

WINDOWS BEHIND STAINED WOOD SLATS

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3660 21ST STREET

JOB NO. 12-009 PROJECT ADDRESS 3660 21ST STREET, SAN FRANCISCO, CA. 94114

CLIENT NAME
3660 21ST STREET,
LLC

CURRENT RELEASE DATE: 02.26.2014


CURRENT RELEASE SET:

SITE PERMIT & VARIANCE SET REV.3

PREVIOUS RELEASE

| ENVIRONMENTAL | 2.14.2013 | EVALUATION (HISTORIC) | NEIGHBORHOOD OUTREACH | 3.19.2013 | SITE PERMIT/VARIANCE R1 | 7.03.2013 | SITE PERMIT/VARIANCE R2 | 1.28.2014 | 1.28.2014 | 1.28.201

SHEET TITLE
PROPOSED EAST
ELEVATION

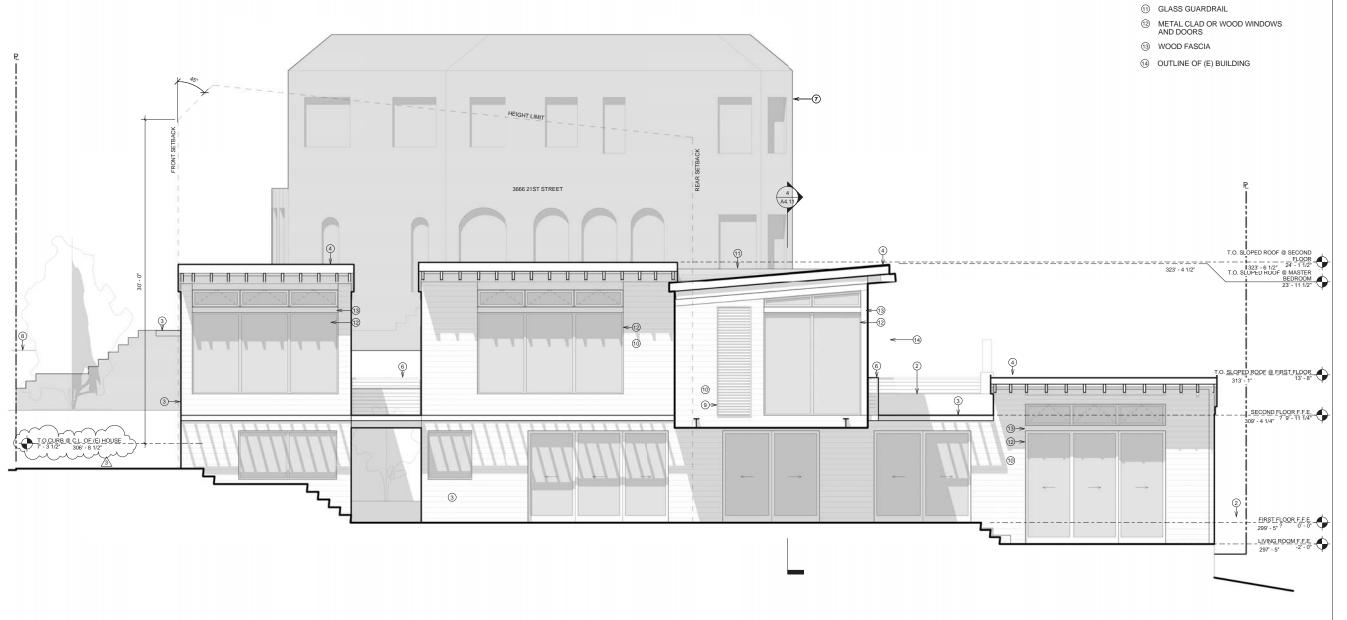

- ① GREEN ROOF
- ② METAL PLANTER
- ③ PAINTED METAL SUNSHADE AWNING
- 4 SLOPED METAL ROOF
- 5 GRADE @ P.L. BEYOND
- 6 METAL GUARDRAIL
- OUTLINE OF NEIGHBORING BUILDING BEYOND
- 8 (E) FENCE
- WINDOWS BEHIND STAINED WOOD SLATS
- 10 STAINED WOOD SIDING
- 11 GLASS GUARDRAIL
- 12 METAL CLAD OR WOOD WINDOWS AND DOORS
- (3) WOOD FASCIA



1005 Sansome St, Ste 240 San Francisco, CA 94111 p 415 252 1441 f 415 252 1442





JOB NO. 12-009 PROJECT ADDRESS 3660 21ST STREET, SAN FRANCISCO, CA. 94114

CLIENT NAME 3660 21ST STREET, LLC

CURRENT RELEASE DATE: 02.26.2014




PREVIOUS RELEASE

ENVIRONMENTAL EVALUATION (HISTORIC)	2.14.2013
NEIGHBORHOOD OUTREACH	3.13.2013
SITE PERMIT/VARIANCE	3.29.2013
SITE PERMIT/VARIANCE R1	7.03.2013
SITE PERMIT/VARIANCE R2	1.28.2014


SHEET TITLE PROPOSED WEST ELEVATION

A3.12

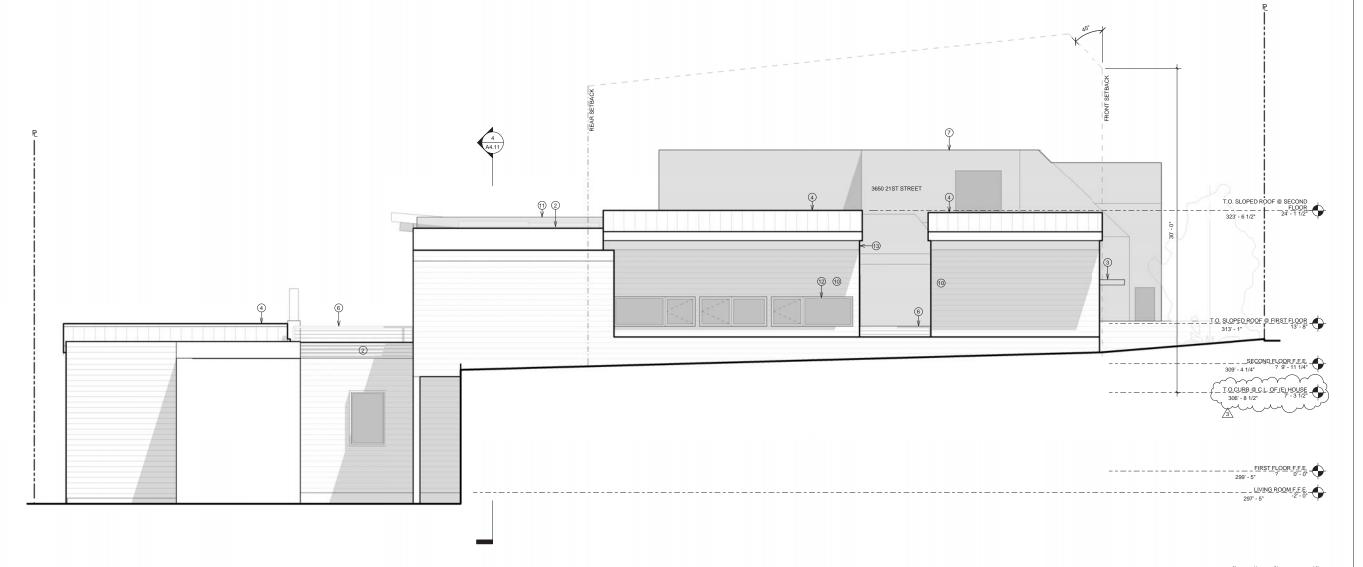

1) PROPOSED WEST ELEVATION

- ① GREEN ROOF ABOVE 2-CAR GARAGE
- ② METAL PLANTER
- ③ PAINTED METAL SUNSHADE AWNING
- 4 SLOPED METAL ROOF
- ⑤ GRADE @ P.L. BEYOND
- 6 METAL GUARDRAIL
- ① OUTLINE OF NEIGHBORING BUILDING
- 8 (E) FENCE
- WINDOWS BEHIND STAINED WOOD SLATS
- ① STAINED WOOD SIDING
- ① GLASS GUARDRAIL
- 12 METAL CLAD OR WOOD WINDOWS AND DOORS
- (3) WOOD FASCIA

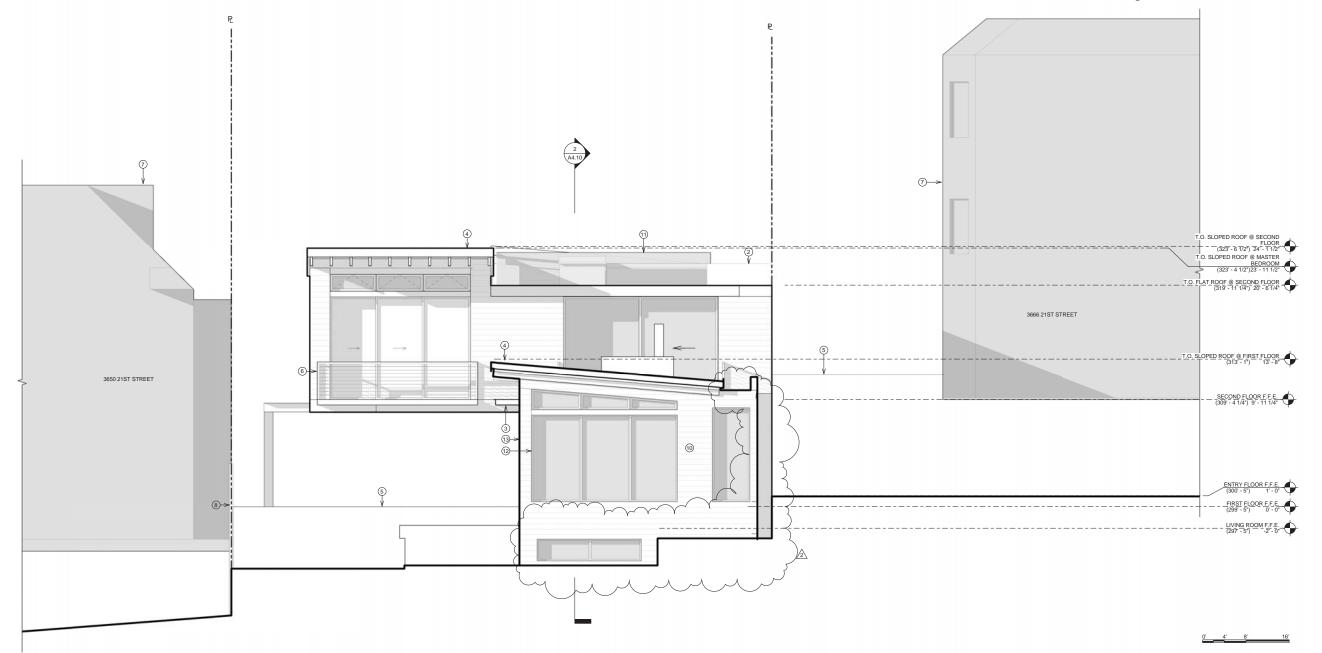

1) PROPOSED NORTH ELEVATION





1005 Sansome St, Ste 240 San Francisco, CA 94111 p 415 252 1441 f 415 252 1442



PROJECT NAME 3660 21ST STREET

JOB NO. 12-009 PROJECT ADDRESS 3660 21ST STREET, SAN FRANCISCO, CA. 94114

CLIENT NAME 3660 21ST STREET, LLC

CURRENT RELEASE DATE: 01.28.2014

CURRENT RELEASE SET: SITE PERMIT & VARIANCE SET REV.2

PREVIOUS RELEASE

ENVIRONMENTAL EVALUATION (HISTORIC) NEIGHBORHOOD OUTREACH 3.13.2013 SITE PERMIT/VARIANCE 3.29.2013 SITE PERMIT/VARIANCE R1 7.03.2013

SHEET TITLE PROPOSED NORTH ELEVATION

- ① GREENHOUSE
- ② COVERED BREEZEWAY
- ③ WOOD TRELLIS
- OUTLINE OF NEIGHBORING BUILDING BEYOND
- 5 GRADE @ P.L. BEYOND
- BALCONY TO BE REMOVED
- GARAGE A, SINGLE CAR
- 8 ROOF DECK
- GRADE BEYOND
- ① FENCE



1005 Sansome St, Ste 240 San Francisco, CA 94111 p 415 252 1441 f 415 252 1442



PROJECT NAME 3660 21ST STREET

JOB NO. 12-009 PROJECT ADDRESS 3660 21ST STREET, SAN FRANCISCO, CA. 94114

CLIENT NAME 3660 21ST STREET, LLC

CURRENT RELEASE DATE: 01.28.2014




PREVIOUS RELEASE

ENVIRONMENTAL EVALUATION (HISTORIC) NEIGHBORHOOD OUTREACH 3.13.2013 SITE PERMIT/VARIANCE 3.29.2013 SITE PERMIT/VARIANCE R1 7.03.2013

SHEET TITLE EXISTING BUILDING SECTIONS

A4.00

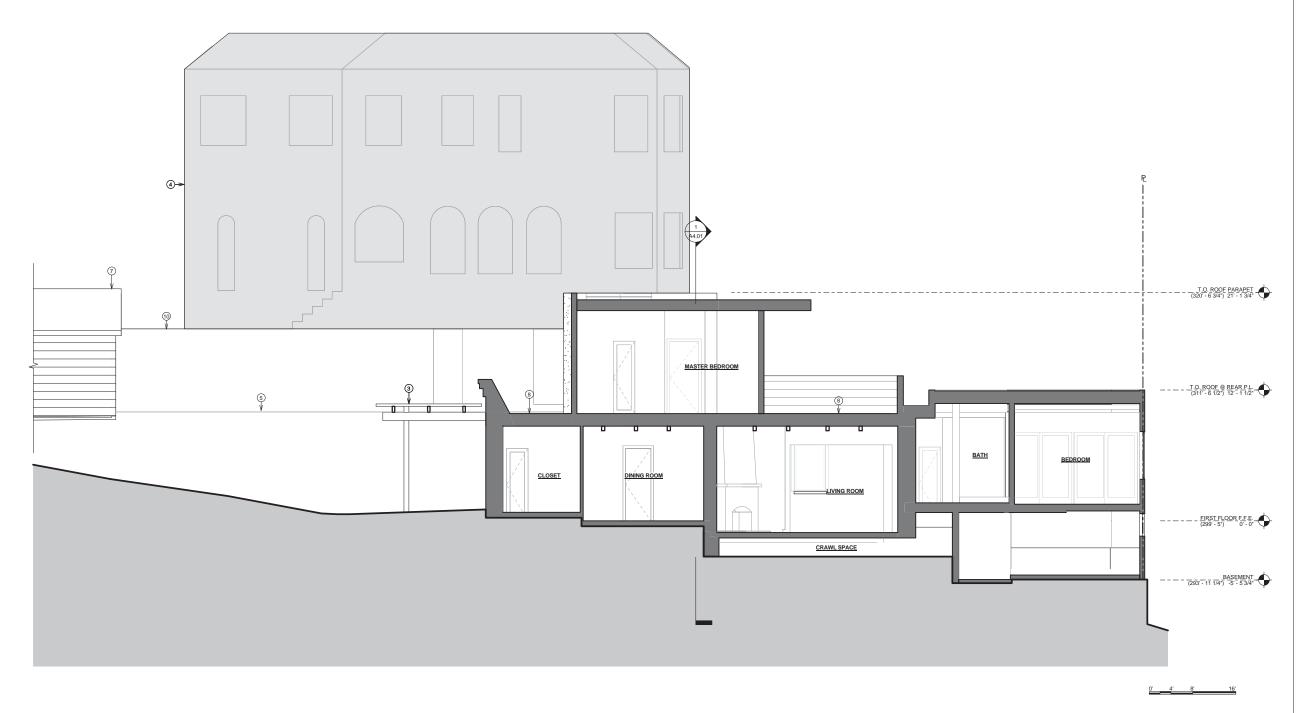

- ① GREENHOUSE
- ② COVERED BREEZEWAY
- ③ WOOD TRELLIS
- OUTLINE OF NEIGHBORING BUILDING BEHIND, SHOWN DASHED
- 5 GRADE @ P.L. BEYOND
- BALCONY TO BE REMOVED
- GARAGE A, SINGLE CAR
- 8 ROOF DECK
- GRADE BEYOND
- 10 NEIGHBORING BUILDING
- 11 FENCE



1005 Sansome St, Ste 240 San Francisco, CA 94111 p 415 252 1441 f 415 252 1442



PROJECT NAME 3660 21ST STREET

JOB NO. 12-009 PROJECT ADDRESS 3660 21ST STREET, SAN FRANCISCO, CA. 94114

CLIENT NAME 3660 21ST STREET, LLC

CURRENT RELEASE DATE: 01.28.2014


CURRENT RELEASE SET: SITE PERMIT & VARIANCE SET REV.2


PREVIOUS RELEASE

ENVIRONMENTAL EVALUATION (HISTORIC) NEIGHBORHOOD OUTREACH 3.13.2013 SITE PERMIT/VARIANCE 3.29.2013 SITE PERMIT/VARIANCE R1 7.03.2013

SHEET TITLE EXISTING BUILDING SECTIONS

A4.01

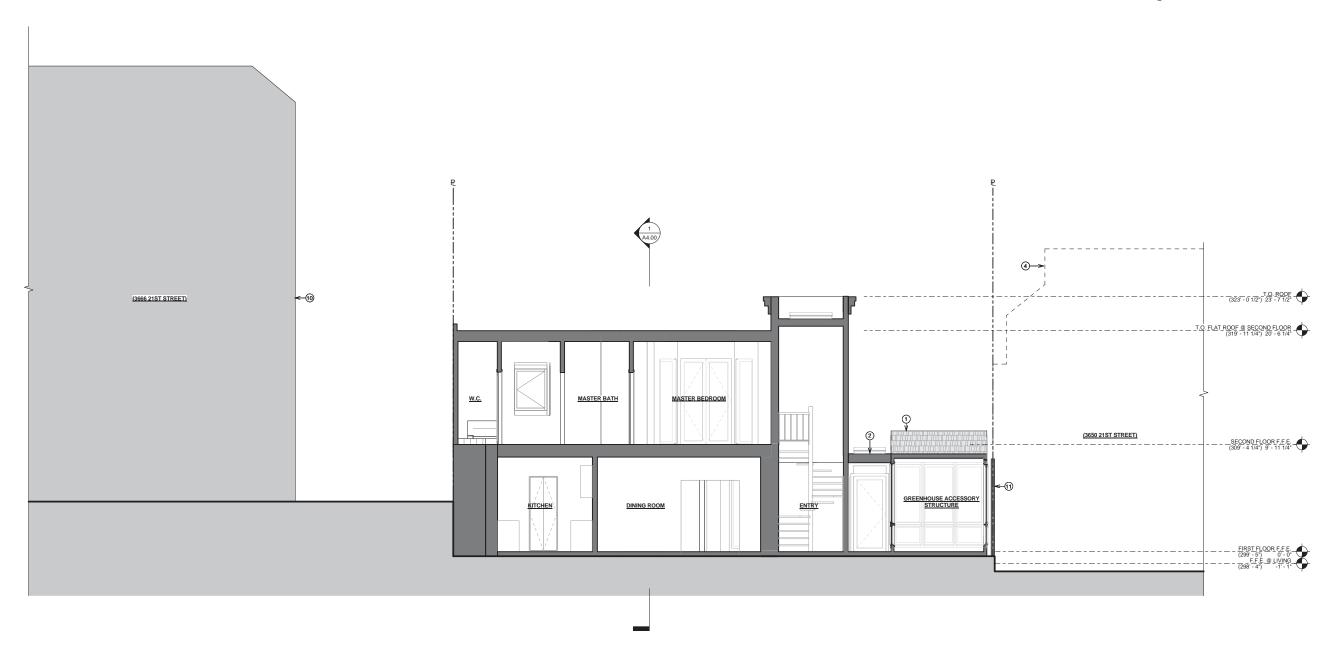

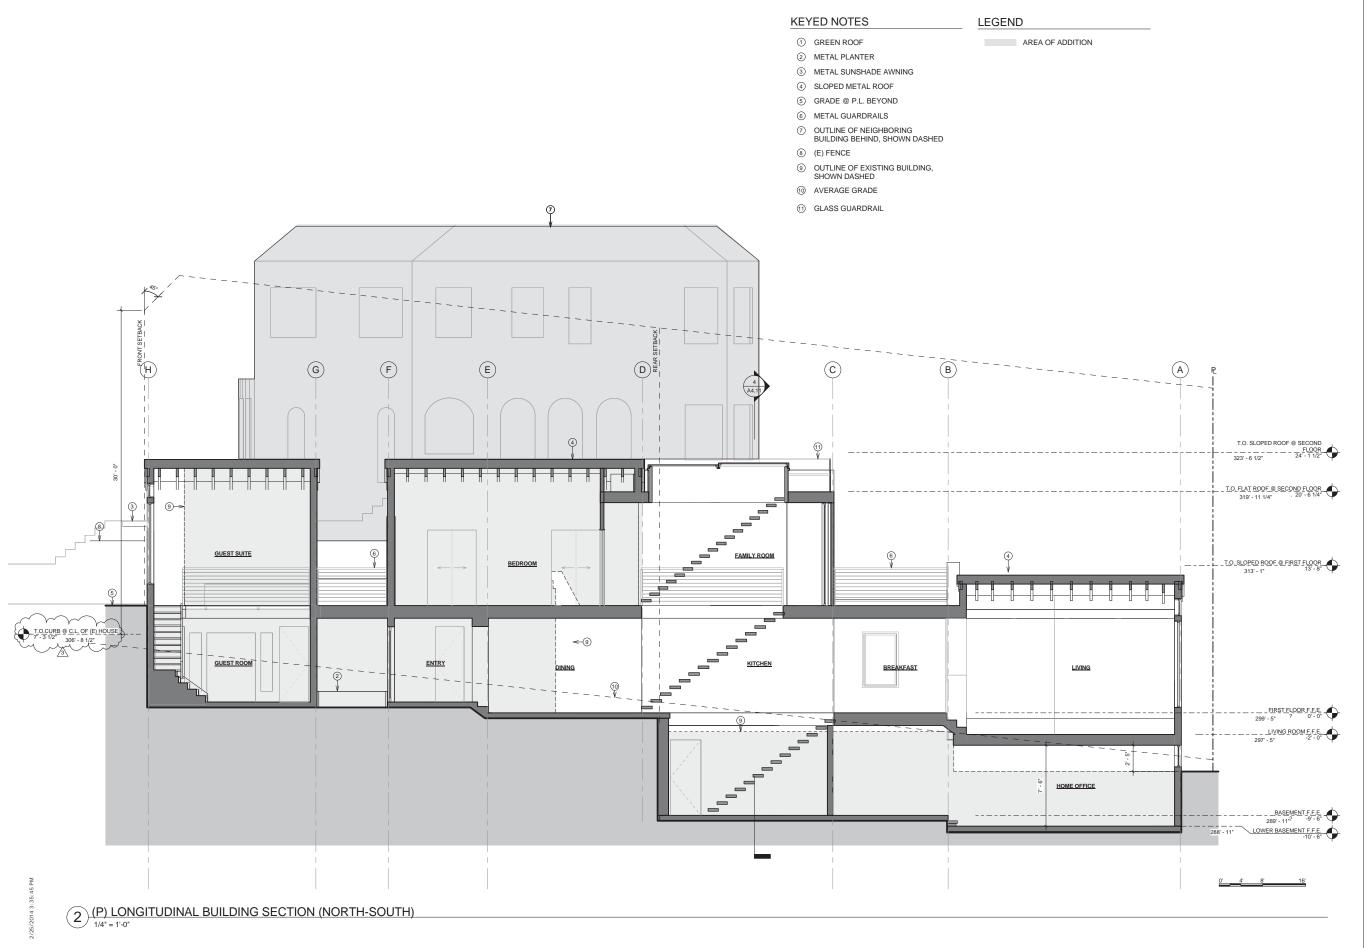



1005 Sansome St, Ste 240 San Francisco, CA 94111 p 415 252 1441 f 415 252 1442



PROJECT NAME 3660 21ST STREET

JOB NO. 12-009 PROJECT ADDRESS 3660 21ST STREET, SAN FRANCISCO, CA. 94114

CLIENT NAME
3660 21ST STREET,
LLC

CURRENT RELEASE DATE: 02.26.2014

CURRENT RELEASE SET:

SITE PERMIT & VARIANCE SET REV.3

PREVIOUS RELEASE

EVALUATION (HISTORIC)	2.14.201
NEIGHBORHOOD OUTREACH	3.13.2013
SITE PERMIT/VARIANCE	3.29.2013
SITE PERMIT/VARIANCE R1	7.03.2013
SITE PERMIT/VARIANCE R2	1.28.2014

SHEET TITLE
PROPOSED BUILDING
SECTIONS

A4.10

AREA OF ADDITION

FRAMING U.O.N.

1. ALL DIMENSIONS ARE TO FACE OF

2. CONTRACTOR TO FIELD VEIRFY ALL DIMENSIONS, TYP.

T.O. SLOPED ROOF @ MASTER BEDROOM - (323' - 4 1/2")23' - 11 1/2"

__SECOND FLOOR F.F.E. (309' - 4 1/4") 9' - 11 1/4"

T.O. FLAT ROOF @ SECOND FLOOR (319' - 11 1/4'') 20' - 6 1/4'

(3650 21ST STREET)

FELDMAN



PROJECT NAME 3660 21ST STREET

JOB NO. 12-009 PROJECT ADDRESS 3660 21ST STREET, SAN FRANCISCO, CA. 94114

CLIENT NAME 3660 21ST STREET, LLC

CURRENT RELEASE DATE: 01.28.2014

CURRENT RELEASE SET: SITE PERMIT & VARIANCE SET REV.2

PREVIOUS RELEASE

ENVIRONMENTAL 2.14.2013 EVALUATION (HISTORIC) NEIGHBORHOOD OUTREACH 3.13.2013 SITE PERMIT/VARIANCE 3.29.2013 SITE PERMIT/VARIANCE R1 7.03.2013

SHEET TITLE PROPOSED BUILDING SECTIONS

A4.11

① GREEN ROOF

② METAL PLANTER

③ METAL SUNSHADE AWNING

4 SLOPED METAL ROOF

5 GRADE @ P.L. BEYOND 6 METAL GUARDRAILS

OUTLINE OF NEIGHBORING BUILDING BEHIND, SHOWN DASHED

STEEL COLUMN

9 NEIGHBORING BUILDING

(E) FENCE

① OUTLINE OF EXISTING BUILDING, SHOWN DASHED

② GLASS GUARDRAIL

MASTER BEDROOM

8—

10-

(3666 21ST STREET

FAMILY ROOM

MECH 64 SF

KITCHEN

(4) (P) TRANSVERSE BUILDING SECTION (EAST-WEST)

RAINSCREEN DRAINAGE MAT 2 LAYERS S.A.S.M., SEE 1/- FOR INSTALLATION INSTRUCTIONS MTL. HEAD FLASHING 5/8" GYP. BD. 1" WD. TRIM WD. WINDOW WD. SUBSILL 2X SILL PLATE 1/4" BACKER ROD AND SEALANT

1) TYP. WINDOW HEAD & SILL

2 LAYERS S.A.S.M., SEE 1/- FOR INSTALLATION INSTRUCTIONS 2 LAYERS OF 15 LB BLDG FELT LAP OVER HEAD FLASHING

STEP 1: SILL, JAMB & HEAD FLASHING


(1-A)
CONSTRUCT ROUGH OPENING PER WINDOW
MANUFACTURER INSTRUCTIONS. VERIFY
SHEATHING CUT FLUSH WITH ROUGH OPENING AT
ALL EDGES

(1-B) INSTALL SHEATHING PAPER AT SILL, CUT IT SUFFICIENTLY LONG TO PROJECT BEYOND
THE VERTICAL S.A.S.M. TO BE APPLIED AT
STEP 1-D. NOTCH SHEATHING PAPER TO
ACCOMODATE WINDOW.

(1-C; 1-CA)
INSTALL SELF ADHERING SHEET MEMBRANE
(S.A.S.M.) AT SILL WITH 9" BELOW AND 3" BEYOND
INTO THE ROUGH OPENING, EXTEND S.A.S.M. 3"
BEYOND VERTICAL S.A.S.M. TO BE APPLIED AT
STEP 1-D. SEE DIAGRAM 1-CA FOR ADDTL INFO.

(1-D)
APPLY S.A.S.M. AT JAMB SIMILAR TO STEP 1-C.
CUT SUFFICIENTLY LONG TO PROJECT 4" BEYOND
VERTICAL S.A.S.M. TO BE APPLIED AT STEP 1-E

(1-E) APPLY S.A.S.M. AT HEAD SIMILAR TO STEP 1-C.

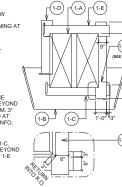

3" S.A.S.M. OF 1'-0" WIDE PANEL CUT, SEALED AND FOLDED INTO ROUGH OPENING. CONTINUOUS BEAD OF SEALANT(DIAGRAM N.T.S)

STEP 2: WINDOW INSTALLATION

(2-A)
APPLY CONT. ELASTOMERIC SEALANT BEAD TO THE
INTERIOR SIDE OF WINDOW NAIL FINS. APPLY
ADDITIONAL SEALANT AT MITER CORNERS OF
WINDOW FRAME (BACKSIDE). INSPECT WINDOW FINS
FOR DAMAGE. INSTALL WINDOW PER
MANUFACTURER'S INSTRUCTIONS UNLESS
OTHERWISE NOTED BY MANUFACTURER, INSTALL AS
FOLLOWS.

-DO NO FASTEN THROUGH HEAD FIN. NAIL 1/2" ABOVE FINS. BEND NAIL DOWN OVER HEAD FIN TO ALLOW FOR MOVEMENT. TAP DOWN SHARP EDGE OF NAIL HEAD TO AVIOD DAMAGE TO FLASHING PAPER

-MIN. 3 FASTENERS EACH SIDE AT 16" O.C. MAX, TYP.


-NO FASTENERS TO BE WITH 3" OF OUTSIDE CORNER OF FINS

STEP 3: HEAD AND POST FLASHING

(3-A)
WHERE OCCURS, APPLY VERTICAL STRIP OF
MODIFIED BITIMINOUS SHEET WATERPROOFING
MEMBRANE TO MULLIONS BETYMEN ADJACENT
WINDOWS, OVERLAP JAMB FLANGES COMPLETELY,
EXTEND 4" BEYOND TOP OF HEAD FLANGE AND 4"
BEYOND BOTTOM OF SILL FLANGE.

(3-B)
WHERE HEAD TRIM OCCURS, INSTALL SHEET
METAL HEAD FLASHING WITH SOLDERED END
CAPS, TYP. SEE DIAGRAM 3-C. INSTALL SHEET
METAL FLASHING TO HAVE 2.º MIN. VERTICAL
LEG, A HORIZONTAL LEG 1.8° DEEPER THAN HEAD
TRIM, AND A VERTICAL 1.4° HEMMED BOTTOM
EDGE. INSTALL S.A. S.M. OVER VERTICAL LEG OF
SHEET METAL FLASHING. EXTEND SHT. METAL
FLASHING 4° BEYOND JAMB ROUGH OPENING.

SOLDERED END CAPS @ SHT.MTL. HEAD FLASHING

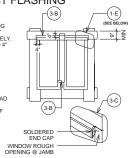


STEP 4: 2ND S.A.S.M. APPLICATION

(4-A)
APPLY 6"WIDE STRIP S.A.S.M. AT SILL TO
LAP NAIL FIN. CUT SUFFICIENTLY LONG TO
PROJECT 3" BEYOND THE VERTICAL
S.A.S.M TO BE APPLIED AT STEP 4-B

(4-B)
CONTINUE INSTALLING 6" WIDE S.A.S.M.
AT JAMB TO OVERLAP NAIL FIN. AND
EXTEND 3" BEYOND SILL S.A.S.M.


(4-C) INSTALL 6" S.A.S.M. AT HEAD TO OVERLAP SHT. MTL. HEAD FLASHING, EXTEND 3" GEYOND EDGE OF S.A.S.M. AT JAMB

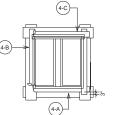

STEP 5:BUILDING PAPER APPLICATION

(5-A)
INSTALL BUILDING PAPER. OVERLAP
WEATHERBOARD FASHION FROM
BOTTOM TO TOP OP WALL PER
MANUFACTURER'S INSTRUCTIONS.

NOTE: DO NOT PENETRATE THE WINDOW NAIL FINS WITH FASTENERS FOR SIDING OR TRIM

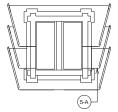

3 WINDOW FLASHING



1005 Sansome St, Ste 240 San Francisco, CA 94111 p 415 252 1441 f 415 252 1442



PROJECT NAME 3660 21ST STREET

JOB NO. 12-009 PROJECT ADDRESS 3660 21ST STREET, SAN FRANCISCO, CA. 94114

CLIENT NAME 3660 21ST STREET, LLC

CURRENT RELEASE DATE: 02.26.2014

CURRENT RELEASE SET: SITE PERMIT & VARIANCE SET REV.3

PREVIOUS RELEASE

ENVIRONMENTAL EVALUATION (HISTORIC) NEIGHBORHOOD OUTREACH 3.13.2013 SITE PERMIT/VARIANCE 3.29.2013 SITE PERMIT/VARIANCE R1 7.03.2013 SITE PERMIT/VARIANCE R2

SHEET TITLE

WINDOW DETAILS

A8.40

	Application for Variance
CASE NUMBER For Staff Use only	

AMENDED APPLICATION FOR Variance from the Planning Code

 Owner/Applicant Information PROPERTY OWNER'S NAME: 3660 21st Street LLC PROPERTY OWNER'S ADDRESS: TELEPHONE 537 Liberty Street San Francisco, CA 94114 EMAIL: APPLICANT'S NAME: Same as Above APPLICANT'S ADDRESS: TELEPHONE: EMAIL: CONTACT FOR PROJECT INFORMATION: Alice Barkley Same as Above ADDRESS: TELEPHONE: McKenna Long & Aldridge LLP (415) 356-4635 One Market Plaza, Spear Tower, 24th Floor San Francisco, CA 94105 abarkley@mckennalong.com 2. Location and Classification STREET ADDRESS OF PROJECT: ZIP CODE: 3660 21st Street 94114 CROSS STREETS: 21st Street & Sanchez Street ASSESSORS BLOCK/LOT: LOT DIMENSIONS: LOT AREA (SQ FT): ZONING DISTRICT: HEIGHT/BULK DISTRICT: 3605 / 019 50' x 114' 5,700 sq. ft. RH-1 40-X 3. Project Description PRESENT OR PREVIOUS USE: (Please check all that apply) ADDITIONS TO BUILDING: Change of Use Rear ☐ Change of Hours ☐ Front PROPOSED USE: ☐ New Construction Height X Alterations ☐ Side Yard BUILDING APPLICATION PERMIT NO.: Demolition DATE FILED: Other Please clarify:

4. Project Summary Table

If you are not sure of the eventual size of the project, provide the maximum estimates.

	EXISTING USES:	EXISTING USES TO BE RETAINED:	NET NEW CONSTRUCTION AND/OR ADDITION:	PROJECT TOTALS:
	•	PROJECT FEATURES		
Dwelling Units	1	1_	0	1
Hotel Rooms	N/A	N/A	N/A	N/A
Parking Spaces	2	2	0	2
Loading Spaces	0	0	0	0
Number of Buildings	1	1	0	1
Height of Building(s)	23' - 7½"	23' - 7½"	6"	24' - 1½"
Number of Stories	2 + Basement	Same	2 + Basement	2 + Basemen
Bicycle Spaces	See Note *	Same	0	See Note *
	GROSS	SQUARE FOOTAGE (GS	F)	
Residential	2,547	2,547	1,651	4,198
Retail				
Office				
Industrial/PDR Production, Distribution, & Repair				
Parking	430	430	11	441
Other (Specify Use)	119 (Greenhouse)	0		,
TOTAL GSF	3,096	2,977	1,662	4,639

Please describe what the variance is for and include any additional project features that are not included in this table. Please state which section(s) of the Planning Code from which you are requesting a variance. - (Attach a separate sheet if more space is needed)

^{*} Bicycle spaces in garage.

Variance Findings

Pursuant to Planning Code Section 305(c), before approving a variance application, the Zoning Administrator needs to find that the facts presented are such to establish the findings stated below. In the space below and on separate paper, if necessary, please present facts sufficient to establish each finding.

- That there are exceptional or extraordinary circumstances applying to the property involved or to the intended use of the property that do not apply generally to other property or uses in the same class of district;
- That owing to such exceptional or extraordinary circumstances the literal enforcement of specified provisions of this Code would result in practical difficulty or unnecessary hardship not created by or attributable to the applicant or the owner of the property;
- That such variance is necessary for the preservation and enjoyment of a substantial property right of the subject property, possessed by other property in the same class of district;
- 4. That the granting of such variance will not be materially detrimental to the public welfare or materially injurious to the property or improvements in the vicinity; and
- That the granting of such variance will be in harmony with the general purpose and intent of this Code and will not adversely affect the Master Plan.

See Attachment to Variance Application.

Priority General Plan Policies Findings

Proposition M was adopted by the voters on November 4, 1986. It requires that the City shall find that proposed projects and demolitions are consistent with eight priority policies set forth in Section 101.1 of the City Planning Code. These eight policies are listed below. Please state how the project is consistent or inconsistent with each policy. Each statement should refer to specific circumstances or conditions applicable to the property. Each policy must have a response. IF A GIVEN POLICY DOES NOT APPLY TO YOUR PROJECT, EXPLAIN WHY IT DOES NOT.

1.	 I nat existing neighborhood-serving retail uses be preserved and enhanced and future opportunities for resident employment in and ownership of such businesses enhanced;
	See Attachment to Variance Application.
-	
-	
2.	That existing housing and neighborhood character be conserved and protected in order to preserve the cultural and economic diversity of our neighborhoods; See Attachment to Variance Application.
3.	That the City's supply of affordable housing be preserved and enhanced; See Attachment to Variance Application.
١.	That commuter traffic not impede Muni transit service or overburden our streets or neighborhood parking; See Attachment to Variance Application.

	these sectors be enhanced;
	See Attachment to Variance Application.
_	
6.	That the City achieve the greatest possible preparedness to protect against injury and loss of life in an earthquake;
	See Attachment to Variance Application.
7.	That landmarks and historic buildings be preserved; and See Attachment to Variance Application.
7.	
7.	
7.	
7.	
	See Attachment to Variance Application.
	See Attachment to Variance Application. That our parks and open space and their access to sunlight and vistas be protected from development.
	See Attachment to Variance Application.
	See Attachment to Variance Application. That our parks and open space and their access to sunlight and vistas be protected from development.
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	See Attachment to Variance Application. That our parks and open space and their access to sunlight and vistas be protected from development.

Estimated Construction Costs

TYPE OF APPLICATION:
Variance
OCCUPANCY CLASSIFICATION:
R-3
BUILDING TYPE:
Type V-B

TOTAL GROSS SQUARE FEET OF CONSTRUCTION:

4,639 sq. ft.	Single Family Residence
ESTIMATED CONSTRUCTION COST. \$1.5m	
ESTIMATE PREPARED BY: Feldman Architecture	
FEE ESTABLISHED.	
Applicant's Affidavit	
Under penalty of perjury the following declarates: The undersigned is the owner or authorized b: The information presented is true and correct: The other information or applications may be	l agent of the owner of this property. ct to the best of my knowledge.
Signature: Fordett Blub	Date: 1.10.14
(() (
Print name, and indicate whether owner, or authorize	zed agent:
BPIDGETT SHANK	
	zed agent:

BY PROPOSED USES:

	Application for Variance
CASE NUMBER: For Staff Use only	

Amended Application Submittal Checklist

APPLICATION MATERIALS

Applications listed below submitted to the Planning Department must be accompanied by this checklist and all required materials. The checklist is to be completed and **signed by the applicant or authorized agent and a department staff person.**

CHECKLIST

Application, with all blanks completed	X	** All other items previously submitte
300-foot radius map, if applicable		
Address labels (original), if applicable	: 🗆	•
Address labels (copy of the above), if applicable		
Site Plan	X	
Floor Plan	X	
Elevations	X	
Section 303 Requirements		
Prop. M Findings		
Historic photographs (if possible), and current photographs		NOTES:
Check payable to Planning Dept		Required Material. Write "N/A" if you believe the item is not applicable, (e.g. letter of
Original Application signed by owner or agent	×	authorization is not required if application is signed by property owner.)
Letter of authorization for agent		Typically would not apply. Nevertheless, in a specific case, staff may require the item.
Other: Section Plan, Detail drawings (ie. windows, door entries, trim), Specifications (for cleaning, repair, etc.) and/or Product cut sheets for new elements (ie. windows, doors)		 Two sets of original labels and one copy of addresses of adjacent property owners and owners of property across street.
After your case is assigned to a planner, you will be contacted a application including associated photos and drawings. Some applications will require additional materials not listed about needed for Planning review of a building permit. The "Application those materials. No application will be accepted by the Department unless the application will be accompanying application, and required mains file for the proposed project. After the file is established it will be assigned will review the application to determine whether it is correquired in order for the Department to make a decision on the proposed.	ove. The aboon Packet" for propriate columns the columns assigned to complete or who were assigned	ve checklist does not include material or Building Permit Applications lists umn on this form is completed. Receipt Department serves to open a Planning a planner. At that time, the planner
For Department Use Only		
Application received by Planning Department:		



FOR MORE INFORMATION: Call or visit the San Francisco Planning Department

Central Reception

1650 Mission Street, Suite 400 San Francisco CA 94103-2479

TEL: **415.558.6378** FAX: **415.558-6409**

WEB; http://www.sfplanning.org

Planning Information Center (PIC) 1660 Mission Street, First Floor

San Francisco CA 94103-2479

TEL: 415.558.6377

Planning staff are available by phone and at the PIC counter. No appointment is necessary.

AMENDED ATTACHMENT TO VARIANCE APPLICATION (3660 21st Street, San Francisco)

PREAMBLE

The applicant is the owner of an existing 2,415 sq. ft. single-family home with two detached single-car garages with a total of 430 sq. ft. located at 3660 21st Street, San Francisco that is a lawful non-complying structure. The proposed project includes vertical and horizontal expansion and requires front set back and rear yard variances. The existing single family home is located almost entirely in the required rear yard and the two garages are located mostly in the required front set back. Copies of the existing and proposed plans are attached hereto as **Exhibit 1**.

PROJECT SITE

The 50' x 114' (5,700 sq. ft.) site is located mid-block on the north side of 21st Street between Church and Sanchez Streets. The site is in a 40-X height and bulk district and in an R-1 zoning district. The site has a cross slope in that it slopes downhill approximately 6' to 10' to the rear property line and uphill approximately 11.75' between east and west side of the front property line, and less than 3' between the east and west side of the rear property line.

The site is improved with two one-car garages and a two-story single family-home with a partial basement, which were constructed in 1923. The entrance to the house, which is located at the rear of the lot, is through a gate between the two garages. For Photographs of the existing home, the site and its vicinity see Exhibit 1, Sheet G0.00 and G0.01.

The existing home and both garages are lawful non-complying structures. The garages are located within the 15' required front set back with 4'-4" in the buildable area. Except for a maximum of 9'-7", the single family is located within the 45% (or 51'- 3 ½") required rear yard. Open space is located between the garages and the house and in the northeast corner of the site. See Exhibit 1, Sheet A1.10.

PROJECT DESCRIPTION

The project involves demolition of the west garage, expansion of the east one-car garage to a two-car garage, renovation of and vertical and horizontal additions to the existing single family home. Specifically, the proposed project includes:

- Demolition of the western one-car garage and expansion of the other one-car garage into a two-car garage at the suggestion of the Planning Department;
- Demolition of the home's rear façade to create a 3' open space between the new rear façade and the rear property line;

Attachment to Amended Front Set Back and Rear Yard Variance Application 3660 21st Street, San Francisco, CA Page 2 of 6

- Demolition of the front façade to facilitate horizontal expansion of the existing home towards the street;
- Demolition of portions of the east elevation of the home;
- Addition of a new master bedroom on the second floor toward the east property line.
- The area below the new master bedroom will be opened on three sides and will be used as a covered open space;
- The usable open space in the required rear yard will be connected to the open space on the south side of the site via the area covered by the master bedroom;
- Extensive interior renovation;
- Seismically upgrade the existing foundation; and
- Expansion the basement level to create a mechanical room and a storage room and crawl space.

See Exhibit 1, Sheet A1.11 for proposed site plan and Sheets A2.10 through A2.13 for the proposed floor plans.

Because the project will involve demolition of 100% of the front and rear façade, 48% of all of the exterior walls, and 48.8% of the floor and roof, the Planning Department has determined that the proposed project is a de-factor demolition. When completed, the project will be far below the allowable height limit and the adjacent buildings in order to preserve most of the uphill neighbor's view to the west. See **Exhibit 2** for the east elevation of the proposed project overlaid with the existing building outline, the adjacent uphill neighbor and the outline of the permissible Planning Code envelope.

REQUESTED VARIANCE

This variance application from the rear yard and front set back requirements.

THE REQUIREMENTS OF PLANNING CODE SECTION 305 ARE MET:

1. That there are exceptional or extraordinary circumstances applying to the property involved or to the intended use of the property that do not apply generally to other property or uses in the same class of district;

The existing buildings are lawful non-complying structure in that the existing $19^{\circ}-4^{\circ}$ deep x $10^{\circ}-9^{\circ}$ (east) / $11^{\circ}-10^{\circ}$ (west)' garages are located within the 15° front set back area and all but $9^{\circ}-7^{\circ}$ of the existing $60^{\circ}-10^{\circ}$ ' deep home is located in the required rear yard. The existing home is on the north side of 21^{st} Street and has been designed to maximize sunlight

Attachment to Amended Front Set Back and Rear Yard Variance Application 3660 21st Street, San Francisco, CA Page 3 of 6

access by locating the usable open space on the south side of the lot behind the garages.

The project is a substantial alteration and addition to the existing single family home and is a "de-facto" demolition under the Planning Code. The proposed project will reduce the intrusion into the rear yard by 3' and place the majority of the addition in the permissible buildable footprint of the site. The existing garages are located on the east and west end of the front set back area due to the 20%+ grade between the east and west property line. By expanding the existing garage at the east side of the front set back area to accommodate two cars, the project will regain the front set back area on the east side to provide transition from the 25'-2" front set back of 3666 21st Street building to the west and the 3650 21st Building to the east that has no front set back.

On this block and the opposition block face, majority of the building are constructed to the front property line. Therefore, usual circumstances or extraordinary circumstances that do not apply generally to other properties or uses in the same class of district and this requirement has been met.

2. That owing to such exceptional or extraordinary circumstances the literal enforcement of specified provisions of this Code would result in practical difficulty or unnecessary hardship not created by or attributable to the applicant or the owner of the property;

The exceptional and extraordinary circumstances described above were not created by and cannot be attributed to the applicants and current owners of the property. Thus, literal enforcement of the Planning Code provision would require abandonment of the single family home with a low profile and construction of a new building, which would result in an unnecessary hardship not created by the applicants.

3. That such variance is necessary for the preservation and enjoyment of a substantial property right of the subject property, possessed by other property in the same class of district;

The front set back variance request is necessary to preserve the right to maintain the two offstreet parking spaces. The proposed project will reduce the degree of the non-compliance in the front set back area. As noted before, many of the existing homes along this block face are constructed to the front property line.

The rear yard variance is necessary to allow expansion of the existing home which is already in the required rear yard area. Expansion of an existing home is a right possessed by other properties located in this zoning district.

4. That the granting of such variance will not be materially detrimental to the public welfare or materially injurious to the property or improvements in the vicinity; and

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The granting of a rear yard variance will allow a building that is far below the allowable height limit. Because of the slope of the site, the project, when complete will appear as a one-story building from the street. The siting of the project will preserve most of the view corridor of the 3660 21st Street home and the homes on the opposite block face. The granting of the requested variances will have no detrimental effect on public welfare and will have not be injurious to the homes in the project site vicinity.

5. That the granting of such variance will be in harmony with the general purpose and intent of this Code and will not adversely affect the Master Plan.

The requested variance is consistent with the following objectives and policies of the City's General Plan:

Housing Element

Objective 2: Retain existing units, and promote safety and maintenance standards, without jeopardizing affordability

Policy 2.4: Promote improvements and continued maintenance to existing units to ensure long term habitation and safety.

The existing single family home will be seismically and structurally upgraded to ensure long term habitation and safety for the owner occupants.

Objective 4: Foster a housing stock that meets the needs of all residents across lifecycles. Objective 5: Ensure that all residents have equal access to available units.

Policy 5.4: Provide a range of unit types for all segments of need, and work to move residents between unit types as their needs changed.

The proposed renovation is designed to accommodate a family with children and to meet the changing needs of the family members during their lifecycles including a multi-generation extended family that would include aging parents.

Objective 11: Support and respect the diverse and distinct character of San Francisco's neighborhoods.

The renovation including the requested front yard and rear yard variances is designed to maintain the visual appearance of an one-story home from the street and will not detract from nor change the diverse and distinct character of the Dolores Heights Special Use District where the Site is located.

Objective 13: Prioritize sustainable development in Planning for and constructing new housing.

Policy 13.4: Promote the highest feasible level of "green" development in both private and municipally-supported housing.

Although the project is an extensive renovation and not new housing, the renovation includes improvements that would meet or exceed the standards of the San Francisco Green Building Code. The project is/will be designed to meet LEED Platinum certification, and has been approved for Priority Processing under San Francisco's DBI AB-004 and Planning Department Bulletin #02. Renovations include a Healthy Homes agenda that would eliminate all toxic materials, glues and solvents from the existing building and any proposed construction work. The home will have windows providing natural cross-ventilation to improve indoor air quality. To maximize energy conservation, the home will have improved insulation in the exterior walls and roof, and many Green Building features planned, including:

- Reduce irrigation demand by 65% or more
- Rainwater & Gray water systems for irrigating the landscape
- Green Roof over garage
- Low-flow plumbing fixtures
- Exceed T-24 Energy Calculations by 15% or more
- Solar PV to provide 40% or more of annual electricity consumption
- Solar thermal to assist domestic hot water & radiant heating
- Extensive high-efficacy LED lighting
- Energy Star appliances
- Reuse as much existing framing as possible & use FSC framing for all new framing
- Use efficient framing techniques
- Aquatherm green pipe for all domestic water supply lines
- Recycled glass batt insulation
- Divert 75% or more of the construction waste

Recreation and Open Space Element

Objective 4 – Provide opportunities for recreation and the enjoyment of open space in every San Francisco Neighborhood.

Policy 4.5 – Require usable outdoor open space in new residential development

The new master bedroom is mostly in the allowable building envelope. While the new bedrooms are located in the required rear yard, they are in an area where the existing building is already in the rear yard and would involved minor increase in the building envelope. The project design will allow ample sunlight to the open space on the south side of the lot and allow three different type of open space for different recreational activities, both active and passive. The rear yard variance area is off-set by the creating of an open area between the rear façade and the rear property line. The proposed project will reduced the ground level usable open space area by 135 sf from 3,425 sf to 3,290 sf.

Urban Design Element

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Objective 4 – Improvement of the neighborhood environment to increase personal safety, comfort, pride and opportunity

Policy 4.10 - Encourage or require the provision of recreation space in private development.

The proposed project will provide different types of open space that can be used during different types of weather. As proposed, the project will plant three (3) new street trees to replace the one tree proposed to be removed. See Exhibit 1, Sheet A1.11. landscaping in the front set back area, and the private usable open space. The proposed project will preserve the neighborhood environment.

Policy 4.12 – Install, promote and maintain landscaping in public and private areas

The front set back area will be landscaped. The interior private open space will be landscaped and paved to provide both active and passive recreational area for the occupants. Additional street trees will be planted.

Environmental Protection Element

Objective 13 - Enhance the energy efficiency of housing in San Francisco

Policy 13.1 – Improve the energy efficiency of existing homes and apartment buildings

The house will be upgraded to meet or exceed the standards of the San Francisco Green Building Code by exceeding the requirements of Title 24, improved envelope insulation that include insolation of the existing walls and domestic hot water supply pipes will be insulated, new energy-efficient appliances and lighting. Windows and doors will be replaced with Low-E2 insulated glass windows.

Objective 17 – Support Federal, State and PG&E energy programs that are equitable, and encourage conservation and renewable energy use.

The project will include Energy Star appliances, low-flow plumbing fixtures, FSC or reclaimed wood materials, and will exceed the current T-24 standards by at least 15%. See also discussion under Objective 13 above.

EXHIBIT E

3660 21ST STREET 3660 21ST STREET, SAN FRANCISCO, CA. 94114

PROJECT

01/10/141/16" = 1'-0"

DATE SCALE

FELDMAN 1005 Sansome St, Ste 240 San Francisco, CA 94111

SETBACKS & BULK & HEIGHT LIMIT, SHOWN DASHED OUTLINE OF EXISTING RESIDENCE, SHOWN IN RED PROPOSED RESIDENCE 3666 21ST STREET P ļ † 1 1 1 <-- 21ST STREET Ы