
		T	7 [
GENERAL NOTES	DRAWING INDEX	D.A. CHECKLIST	SHATARA
1. CONTRACTOR SHALL ADHERE TO ALL CODES, RULES, AND REGULATIONS GOVERNING	A0.0 COVER SHEET	THE ADDRESS OF THE PROJECT IS <u>1100 THOMAS AVENUE</u> FOR ALL TENANT IMPROVEMENT PROJECTS IN COMMERCIAL USE SPACES, THIS CHECKLIST IS REQUIRED TO BE REPRODUCED ON THE PLAN SET AND SIGNED	ARCHITECTURE
CONSTRUCTION, BUILDING ACCESS AND THE USE OF FACILITIES AS SET BY LOCAL BUILDING DEPARTMENT AGENCY AND THE BUILDING OWNERS. TITLE 24 C.A.C ESPECIALLY	A0.1 DISABLED ACCESS GUIDELINES A0.2 ADA REQUIREMENTS & ENLARGED PLANS	1. THE PROPOSED USE OF THE PROJECT <u>AGRICULTURAL F—1 OCCUPANCY</u> 2. DESCRIBE THE AREA OF THE REMODEL, INCLUDING WHICH FLOOR GROUND FLOOR CONTROL OF THE PROPOSED USE OF THE REMODEL, INCLUDING WHICH FLOOR GROUND FLOOR CONTROL OF THE PROPOSED USE OF THE PROJECT OF THE PROJECT OF THE PROPOSED USE OF THE PROJECT OF THE	INC.
THOSE ABSTRACTS DEALING WITH ENERGY AND HANDICAPPED ACCESS REQUIREMENTS. ANYTHING SHOWN ON THESE DRAWINGS, NOT IN ACCORDANCE WITH THESE RULES AND		3. THE CONSTRUCTION COST OF THE PROJECT EXCLUDING DISABLED ACCESS UPGRADES IS TO THE PATH OF TRAVEL IS \$30,000.00, WHICH IS (CHECK ONE) \(\sum \text{MORE THAN} \) \(\sum \text{LESS THAN} \) THE ACCESSIBILITY THRESHOLD AMOUNT OF \(\frac{\pmathrm{1}}{\pmathrm{1}}\) (CHECK ONE) \(\sum \text{MORE THAN} \) \(\sum \text{LESS THAN} \) THE ACCESSIBILITY THRESHOLD AMOUNT OF \(\frac{\pmathrm{1}}{\pmathrm{1}}\) (CHECK ONE) \(\sum \text{MORE THAN} \) \(\sum \text{LESS THAN} \) THE ACCESSIBILITY THRESHOLD AMOUNT OF \(\frac{\pmathrm{1}}{\pmathrm{1}}\) (CHECK ONE) \(\sum \text{MORE THAN} \) \(\sum \text{LESS THAN} \) THE ACCESSIBILITY THRESHOLD AMOUNT OF \(\frac{\pmathrm{1}}{\pmathrm{1}}\) (CHECK ONE) \(\sum \text{MORE THAN} \) \(\sum \text{LESS THAN} \) THE ACCESSIBILITY THRESHOLD AMOUNT OF \(\frac{\pmathrm{1}}{\pmathrm{1}}\) (CHECK ONE) \(\sum \text{MORE THAN} \) \(\sum \text{MORE THAN} \) \(\sum \text{LESS THAN} \) THE ACCESSIBILITY THRESHOLD AMOUNT OF \(\frac{\pmathrm{1}}{\pmathrm{1}}\) (CHECK ONE) \(\sum \text{MORE THAN} \) \(\sum \text{MORE THAN} \) \(\sum \text{LESS THAN} \) THE ACCESSIBILITY THRESHOLD AMOUNT OF \(\frac{\pmathrm{1}}{\pmathrm{1}}\) (CHECK ONE) \(\sum \text{MORE THAN} \) \(\sum \text{MORE THAN} \) \(\sum \text{LESS THAN} \) THE ACCESSIBILITY THRESHOLD AMOUNT OF \(\frac{\pmathrm{1}}{\pmathrm{1}}\) (CHECK ONE) \(\sum \text{MORE THAN} \) \(\sum \	890 7TH ST.
REGULATIONS, SHALL BE BROUGHT TO THE ATTENTION OF THE DESIGNER BEFORE PROCEEDING WITH ANY WORK.	A1.0 EXISTING & PROPOSED SITE PLANS	"2013"ENR CONSTRUCTION COST INDEX"(THE COST INDEX & THRESHOLD ARE UPDATED ANNUALLY). 4. IS THIS A CITY PROJECT AND/OR DOES IT RECEIVE ANY FORM OF PUBLIC FUNDING? CHECK ONE: YES / NO	SAN FRANCISCO
2. DRAWINGS SHALL NOT BE SCALED FOR DIMENSIONAL INFORMATION.	A1.1 EXISTING AS APPROVED FLOOR PLANS & SECTION	NOTE: IF YES, THEN SEE STEP 3 ON THE INSTRUCTIONS PAGE FOR ADDITIONAL FORMS REQUIRED	CA 94107
3. THE CONTRACTOR AND SUBCONTRACTORS SHALL VERIFY ALL CONDITIONS AND	A1.1.1 AS BUILT FLOOR PLANS & SECTION A2.1 PROPOSED FLOOR PLANS & SECTIONS	CONDITIONS BELOW MUST BE FULLY DOCUMENTED BY ACCOMPANYING DRAWINGS 5. READ "A" THROUGH "D" BELLOW CAREFULLY AND CHECK THE MOST APPLICABLE BOX (ONE BOX ONLY)	TEL (415) 512-7566 suheil@shataraarch.com
DIMENSIONS IN THE FIELD. IT SHALL BE THE RESPONSIBILITY OF THE CONTRACTOR TO NOTIFY THE DESIGNER OF ANY CONFLICTS HEREIN, EITHER APPARENT OR OBVIOUS PRIOR	A2.2 OCCUPANT LOAD FACTOR & MEANS OF EGRESS	A: ALL EXISTING CONDITIONS SERVING THE AREA OF REMODEL FULLY COMPLY WITH ACCESS REQUIREMENTS. NO FURTHER UPGRADES ARE REQUIRED.	
TO START OF WORK ON THAT ITEM OR BEAR THE RESPONSIBILITY OF CORRECTING SUCH WORK AS DIRECTED BY THE ARCHITECT.		FILL OUT PAGE 2 OF D.A. CHECKLIST B: PROJECTS ADJUSTED COST OF CONSTRUCTION IS GREATER THAN THE CURRENT VALUATION THRESHOLD:	DRAWINGS AND SPECIFICATIONS, AS INSTRUMENTS OF PROFESSIONAL SERVICE, ARE AND SHALL REMAIN THE PROPERTY OF THE ARCHITECT.
4. ALL WORK SHALL BE DONE IN A FIRST CLASS WORKMANLIKE MANNER BY MECHANICS	S-1 FRAMING PLAN & SECTION DETAIL	FILL OUT AND ATTACH PAGE 2 OF D.A. CHECKLIST AND ANY OTHER REQUIRED FORMS TO PLANS. C: PROJECT ADJUSTED COST OF CONSTRUCTION IS LESS THAN OR EQUAL TO THE CURRENT VALUATION THRESHOLD: LIST ITEMS THAT WILL BE UPGRADED ON FORM C. ALL	1 1
SKILLED IN THEIR RESPECTIVE TRADES.	SCOPE OF WORK	OTHER ITEMS SHALL BE CHECKED ON PAGE 2 OF THE D.A. CHECKLIST IN THE "NOT REQUIRED BY CODE" COLUMN.	THESE DOCUMENTS ARE NOT TO BE USED, IN WHOLE OR IN PART, FOR ANY PROJECTS OR PURPOSES WHATSOEVER, WITHOUT THE PRIOR SPECIFIC WRITTEN AUTHORIZATION OF SHATARA ARCHITECTURE INC
5. THE CONTRACTOR SHALL REVIEW PLANS AND THE AREA OF CONSTRUCTION CAREFULLY TO INSURE FULL UNDERSTANDING OF EXACT SCOPE OF WORK. THE ARCHITECT WILL BE	SCOLE OF WORK	D: PROPOSED PROJECT CONSISTS ENTIRELY OF BARRIER REMOVAL: FILL OUT AND ATTACH BARRIER REMOVAL FORM TO PLANS	PROJECT
AVAILABLE TO REVIEW ALL WORK ON SITE AND RESOLVE ANY UNCLEAR ITEMS	COMPLY WITH COMPLAINT NO. 2017-27-251 OF EXCEEDING WORK BEYOND	E: PROPOSED PROJECT IS MINOR REVISION TO PREVIOUSLY APPROVED PERMIT DRAWINGS ONLY. (NOTE: THIS SHALL NOT BE USED FOR NEW OR ADDITIONAL WORK) PROVIDE PREVIOUSLY APPROVED PERMIT APPLICATION HERE:	TENANT IMPROVEMEN
6. THE CONTRACTOR SHALL CONTACT THE BUILDING MANAGEMENT TO BE ADVISED OF THE		DESCRIPTION OF REVISION: CHECK ALL APPLICABLE BOXES AND SPECIFY WHERE ON THE DRAWINGS THE DETAILS ARE SHOWN:	ADDRESS 1100 THOMAS AVE
RULES OF THE BUILDING WITH RESPECT TO CONSTRUCTION, WHEN AND HOW DELIVERIES AND/OR REMOVALS CAN BE DONE ON REGULAR OR OVERTIME AND IN GENERAL, ANY	 ADD NEW WALLS AT FIRST LEVEL ADD NEW STAIRS AT UPPER LEVEL (2ND MEANS OF EGRESS) 	NOTE: UPGRADES BELOW ARE EXISTING WILL BE EQUIVALENT COMPLIANCE APPROVED IN NOT REQUIRDE NON-COMPLIANT LOCATION OF DETAIL(S)-INCLUDE DETAIL NO.&	SAN FRANCISCO, CA
BUILDING REQUIREMENTS WHICH WILL AFFECT THEIR WORK.	MODIFY EXISTING STAIRS	LISTED IN PRIORITY BASED FULLY UPGRADE TO FACILITATION IS COMPLIANCE BY CODE REQUEST DRAWING ON CBC-11B-202.4 Ex 8 COMPLYING FULL WILL PROVIDE TECHNICALLY WITH AND OR NONF URH MUST SHEET (DO NOT LEAVE THIS PART BLANK)	BLOCK: 4793 LOT: 001B
7. THE CONTRACTOR SHALL SUBMIT TO THE ARCHITECT ALL FABRICATION SHOP DWGS. AND FIXTURE CUTS FOR APPROVAL AFTER HAVING CHECKED AND APPROVED THEM FIRST,		COMPLIANCE FULL ACCESS INFEASIBLE IMMEDIATELY PRECEDING CODE EXISTING BE RATIFIED BY AAC BE RATIFIED BY AAC STILL (DO NOT LEAVE MISS FAIT BEANK). ALSO CLARIFICATION COMMENTS CAN BE WRITTEN HERE	
WHERE APPLICABLE		A. ONE ACCESSIBLE ENTRANCE INCLUDING: APPROACH WALK, VERTICAL	PROJECT DIRECTOR'
8. THE CONTRACTOR SHALL FURNISH A SYSTEM OF TEMPORARY LIGHTS AND WATER THROUGHOUT THE SPACE UNDER CONSTRUCTION, IF REQUIRED.		ACCESS, PLATFORM (LANDING), DOOR/GATE AND HARDWARE FOR A0.1 & A0.2	OWNER
9. THE CONTRACTOR SHALL REMOVE FROM THE BUILDING ALL RUBBISH AND WASTE		DOOR/GATE	ARCHITECT SHATARA ARCHITECTURE INC.
MATERIALS, FOR HIS OWN SUBCONTRACTING. IF REQUIRED.		B. AN ACCESSIBLE ROUTE TO THE AREA OF REMODEL INCLUDING	890 7TH STREET SAN FRANCISCO, CA 94107 TEL: 415-512-7566
10. NO WORK DEPENDING ON PARTITION LOCATIONS SHALL BE DONE UNTIL THE CONTRACTOR HAS MARKED PARTITION LOCATIONS ON THE FLOOR SLAB IN THE FIELD AND THE	BUILDING INFORMATION	PARKING/ACCESS AISLES AND CURB RAMPS	CONTACT: SUHEIL SHATARA
ARCHITECT HAS APPROVED THEM.	BUILDING DESCRIPTION: EXISTING: 2 STORIES TYPE III — N.R.	CURB RAMPS AND WALKS CORRIDORS, HALLWAYS, FLOORS CORRIDORS	
11. THE CONTRACTOR SHALL LEAVE THE PREMISES IN A CLEAN AND ORDERLY MANNER.	PROPOSED: 2 STORIES — NO CHANGE	RAMPS ELEVATORS, LIFTS	
12. THE CONTRACTOR'S PRICE IS TO BE COMPLETE IN ALL WAYS INCLUDING TAXES,	(E) OCCUPANCY CLASS: F-1 OCCUPANCY	C. AT LEAST ONE ACCESSIBLE RESTROOM FOR EACH SEX OR A SINGLE LUNISEY RESTROOM SERVING THE AREA	
OVER-TIME, SHIPPING, ETC.	PROPOSED OCCUP. CLASS: F-1 OCCUPANCY	UNISEX RESTROOM SERVING THE AREA	
13. ALL MATERIALS AND INSTALLATIONS SHALL BE IN ACCORDANCE WITH MANUFACTURER'S LATEST PRINTED SPECIFICATIONS AND WITH CODE REQUIREMENTS.		D. ACCESSIBLE PUBLIC PAY PHONE.	
14. THE WORK INCLUDED UNDER THIS CONTRACT SHALL BE DONE IN ACCORDANCE WITH AIA	(E) # OF DWELLING UNITS: O — NO CHANGE	E. ACCESSIBLE DRINKING	
GENERAL CONDITIONS DOCUMENT A-201, 1991 EDITION.	(N) # OI DWELLING GIVITS.	FOUNTAINS(HI-LOW). F. SIGNAGE.	
15. CONTRACTORS, SUBCONTRACTORS AND SUPPLIERS SHALL GUARANTEE THAT THE WORK IS FREE FROM ANY DEFECTS IN WORKMANSHIP AND MATERIALS FOR A PERIOD OF ONE	PLANNING INFORMATION	G. VISUAL ALARM, STORAGE, STORAGE CONTROL CONT	
YEAR FROM DATE OF COMPLETION AND BE RESPONSIBLE FOR REPAIR OR REPLACEMENT AT NO ADDITIONAL CHARGE.	TEANNING IN ORMATION	SEE THE REQUIREMENTS FOR ADDITIONAL FORMS LISTED BELOW 1. 2. 3. 4. 5. 6. 7.	BUILDING 06.13.2016
	ZONING: PDR-2 - PRODUCTION, DISTRIBUTION, REPAIR	1. NO ADDITIONAL FORMS REQUIRED.	BUILDING 08.31.2016 BUILDING 09.21.2016
16. CONTRACTORS TO CARRY EMPLOYER'S LIABILITY INSURANCE OF NOT LESS THAN \$1,000,000 PER OCCURRENCE, AND COMPREHENSIVE GENERAL LIABILITY OF AT LEAST	HEIGHT LIMIT: 40-X	2. NO ADDITIONAL FORMS REQUIRED. 3. FILL OUT REQUEST FOR APPROVAL OF EQUIVALENT FACILITATION FORM FOR EACH ITEM CHECKED AND ATTACH TO PLAN.	BUILDING 06.01.2018
\$2,000,000 COMBINED SINGLE LIMIT FOR BODILY INJURY, DEATH, OR PROPERTY DAMAGE THE POLICIES TO ALSO COVER LANDLORD AND TENANT AS ADDITIONAL INSURED.	EXISTING NUMBER OF UNITS: 1	4. FILL OUT REQUEST FOR APPROVAL OF TECHNICAL INFEASIBILITY FORM FOR EACH ITEM CHECKED AND ATTACH TO PLAN. 5. PROVIDE DETAILS FROM A SET OF CITY APPROVED REFERENCE DRAWINGS, PROVIDE ITS PERMIT APPLICATION NUMBER HERE: AND LIST REFERENCE DRAWING NUMBER ON PLANS	BUILDING 06.21.2018
	PROPOSED NUMBER OF UNITS: 1	6. NO ADDITIONAL FORMS REQUIRED 7. FILL OUT REQUEST FOR AN UNREASONABLE HARDSHIP FORM FOR EACH ITEM CHECKED AND ATTACH TO PLAN. ALL UHR MUST BE RATIFIED BY THE ACCESS APEALS COMMISSION	BUILDING 12.05.2018
		(SEE UHR FORM FOR DETAILS)	
SYMBOLS	ABBREVIATIONS	Form C: DISABLED ACCESS 20% RULE	
		THIS FORM IS ONLY REQUIRED FOR PROJECTS EQUAL TO OR UNDER THE VALUATION THRESHOLD WHEN BOX "C" IS	1
SECTION DRAWING SECTION EQUIPMENT SYMBOL EQUIPMENT TYPE	& AND CTR. Center F.O.S. Face of L ANGLE DBL. Double FPRF. Fireproof @ AT DEPT. Department F.S. Full Siz	f Studs M.O. Masonry Opening SHT. Sheet CHECKED OFF ON THE D.A. CHECKLIST AND IS FOR PROVIDING AN ITEMIZED LIST OF THE ESTIMATED COSTS FOR THE EXPENDITURES USED FOR DISABLED ACCESS UPGRADES FOR THIS PROJECT. REPRODUCE THIS FORM ALONG WITH THE D.A. CHECKLIST AND ANY REQUIRED FORM(S) ON THE PLANS.	
DRAWING SHEET NUMBER EQUIPMENT TYPE EQUIPMENT GROUP	(E) EXISTING DET. Detail FT. Foot or	Feet (N) New SQ. Square N. North S.ST. Stainless Steel BASED ON CBC SECTION 11B-202.4 EXCEPTION 8, ONLY PROJECTS WITH A CONSTRUCTION COST LESS THAN OR	
	A.D. AFRA DRAIN DIM. Dimension FURR. Furring	N.I.C, Not In Contract S.SK. Service Sink EQUAL TO THE VALUATION THRESHOLD (CURRENT ENR CONSTRUCTION INDEX AMOUNT) ARE ELIGIBLE FOR THE 20%	
ELEVATION 1 REVISION DRAWING	ADJ. ADJUSTABLE DISP. Dispenser FUT. Future AGGR. AGGREGATE DN. Down GA. Gauge AL. ALUMINUM D.O. Door Opening GALV. Galvaniz APPROX. APPROXIMATE DR. Door G.B. Grab Brown GALV.	O.C. On Center SIOR. Storage IN GENERAL, PROJECTS VALUED OVER THE THRESHOLD ARE NOT ELIGIBLE FOR THE 20% RULE (SEE CBC TIB-202.4	SED ARCHIELIAS SILLIAS
SHEET NUMBER 1 WALL TYPE	ARCH. ARCHITECTURAL DWR. Drawer GI Glass	OPP. Opposite SUSP. Suspended CRC SECTION 11B-2024 EXCEPTION 9 (ABBREVIATED). IN ALTERATION PROJECTS INVOLVING BUILDINGS & FACILITIES	No.C24700
DETAIL FINISH SYMBOL	ASB. ASBESTOS DS. Downspout GND. Ground ASPH. ASPHALT D.S.P Dry Standpipe GR. Grade BD. BOARD DWG. Drawing GYP. Gypsum BITUM. BITUMINOUS E. East H.B. Hose B	PL. Plate I.B. Towel Bar PREVIOUSLY APPROVED & BUILT WITHOUT ELEVATORS, AREAS ABOVE & BELOW THE GROUND FLOOR ARE SUBJECT	REN 10/31/19
SHEET NUMBER		P.LAM. Plastic Laminate T.C. Top Of Curb ibb PLAS. Plaster TEL. Telephone Exceeds the valuation threshold in exception 8, even if the value of the project care PLYWD. Plywood TER. Terrazzo FACILITIES THAT QUALIFIES FOR THIS 20% DISPROPORTIONALITY PROVISIONS WHEN PROJECT VALUATION IS OVER THE PROJECT VALUA	
UP INTERIOR ELEVATION MATCH LINE SHADED PORTION IS SIDE CONSIDERED.	BLDG. BUILDING BLK. BLOCK BLKG. BLOCKING BM. BEAM BOT. Bottom CAB. Cabinet C.B. Catch Basin EA. Each E.J. Expansion Joint HDWD. Hardwo HOWD. HARDWO	Metal PT. Point Groove THK. Thick A)Cost of construction: (Excluding accessibility upgrade) O. T. Ougrry Tile T.&G. Tongue And THRESHOLD. A)Cost of construction: (Excluding accessibility upgrade) B) 20% of A): List the Upgrade Expanditures and their respective. P	
LEFT A3 RIGHT SHEET NUMBER DRAWING NUMBER	CAB. Cabinet EMER. Emergency HGT. Height	Q.T. Quarry Tile 1.P. Top Of Pavement Some Resident Struction cost below: Construction cost below:	
DOWN DATUM POINT	CEM. Cement EQ. Equal INT. Interior	RAD. Radius T.W. Top Of Wall R.D. Roof Drain TYP. Typical	
ROOM IDENTIFICATION	C.G. Corner Guard EXPO. Exposed JT. Joint CLG. Ceiling EXP. Expansion KIT. Kitchen	REF. Refrence UNF. Unfinished REFR. Refrigerator U.O.N. Unless Otherwise RGTR. Register Noted 2.	
ROOM NAME ROOM NUMBER COLUMN GRID	CLKG. Calking EXT. Exterior LAB. Labotor CLO. Closet F.A. Fire Alarm LAM. Lamina CLR. Clear	RGTR. Register Noted Y REINF. Reinforced UR. Urinal Te REQ. Required VERT Vertical 4.	
	C.O. Cased Opening F.B. Flat Bar LAV. Lavator	Γ	COVER SHEET
DOOR NUMBER TOP OF WALL	COL. Column FDN. Foundation MAX. Maximu CONC. Concrete F.E. Fire Extinguisher MECH. Mechan CONSTR. Construction FI. Floor MET. Metal.	ical R.W.L. Rain Water Leader W/C Water Closet Total Upgrade Expenditures	
WINDOW NUMBER	CONT. Continuous FLASH. Flashing MFR. Manufa CORR. Corridor FLLIOR Fluorescent	S.C. Solid Care W/O Without cturer SCHED. Schedule WP Waterproof	A0.0
	CTSK. Countersunk FOC Face of Concrete MIN. Minimur		

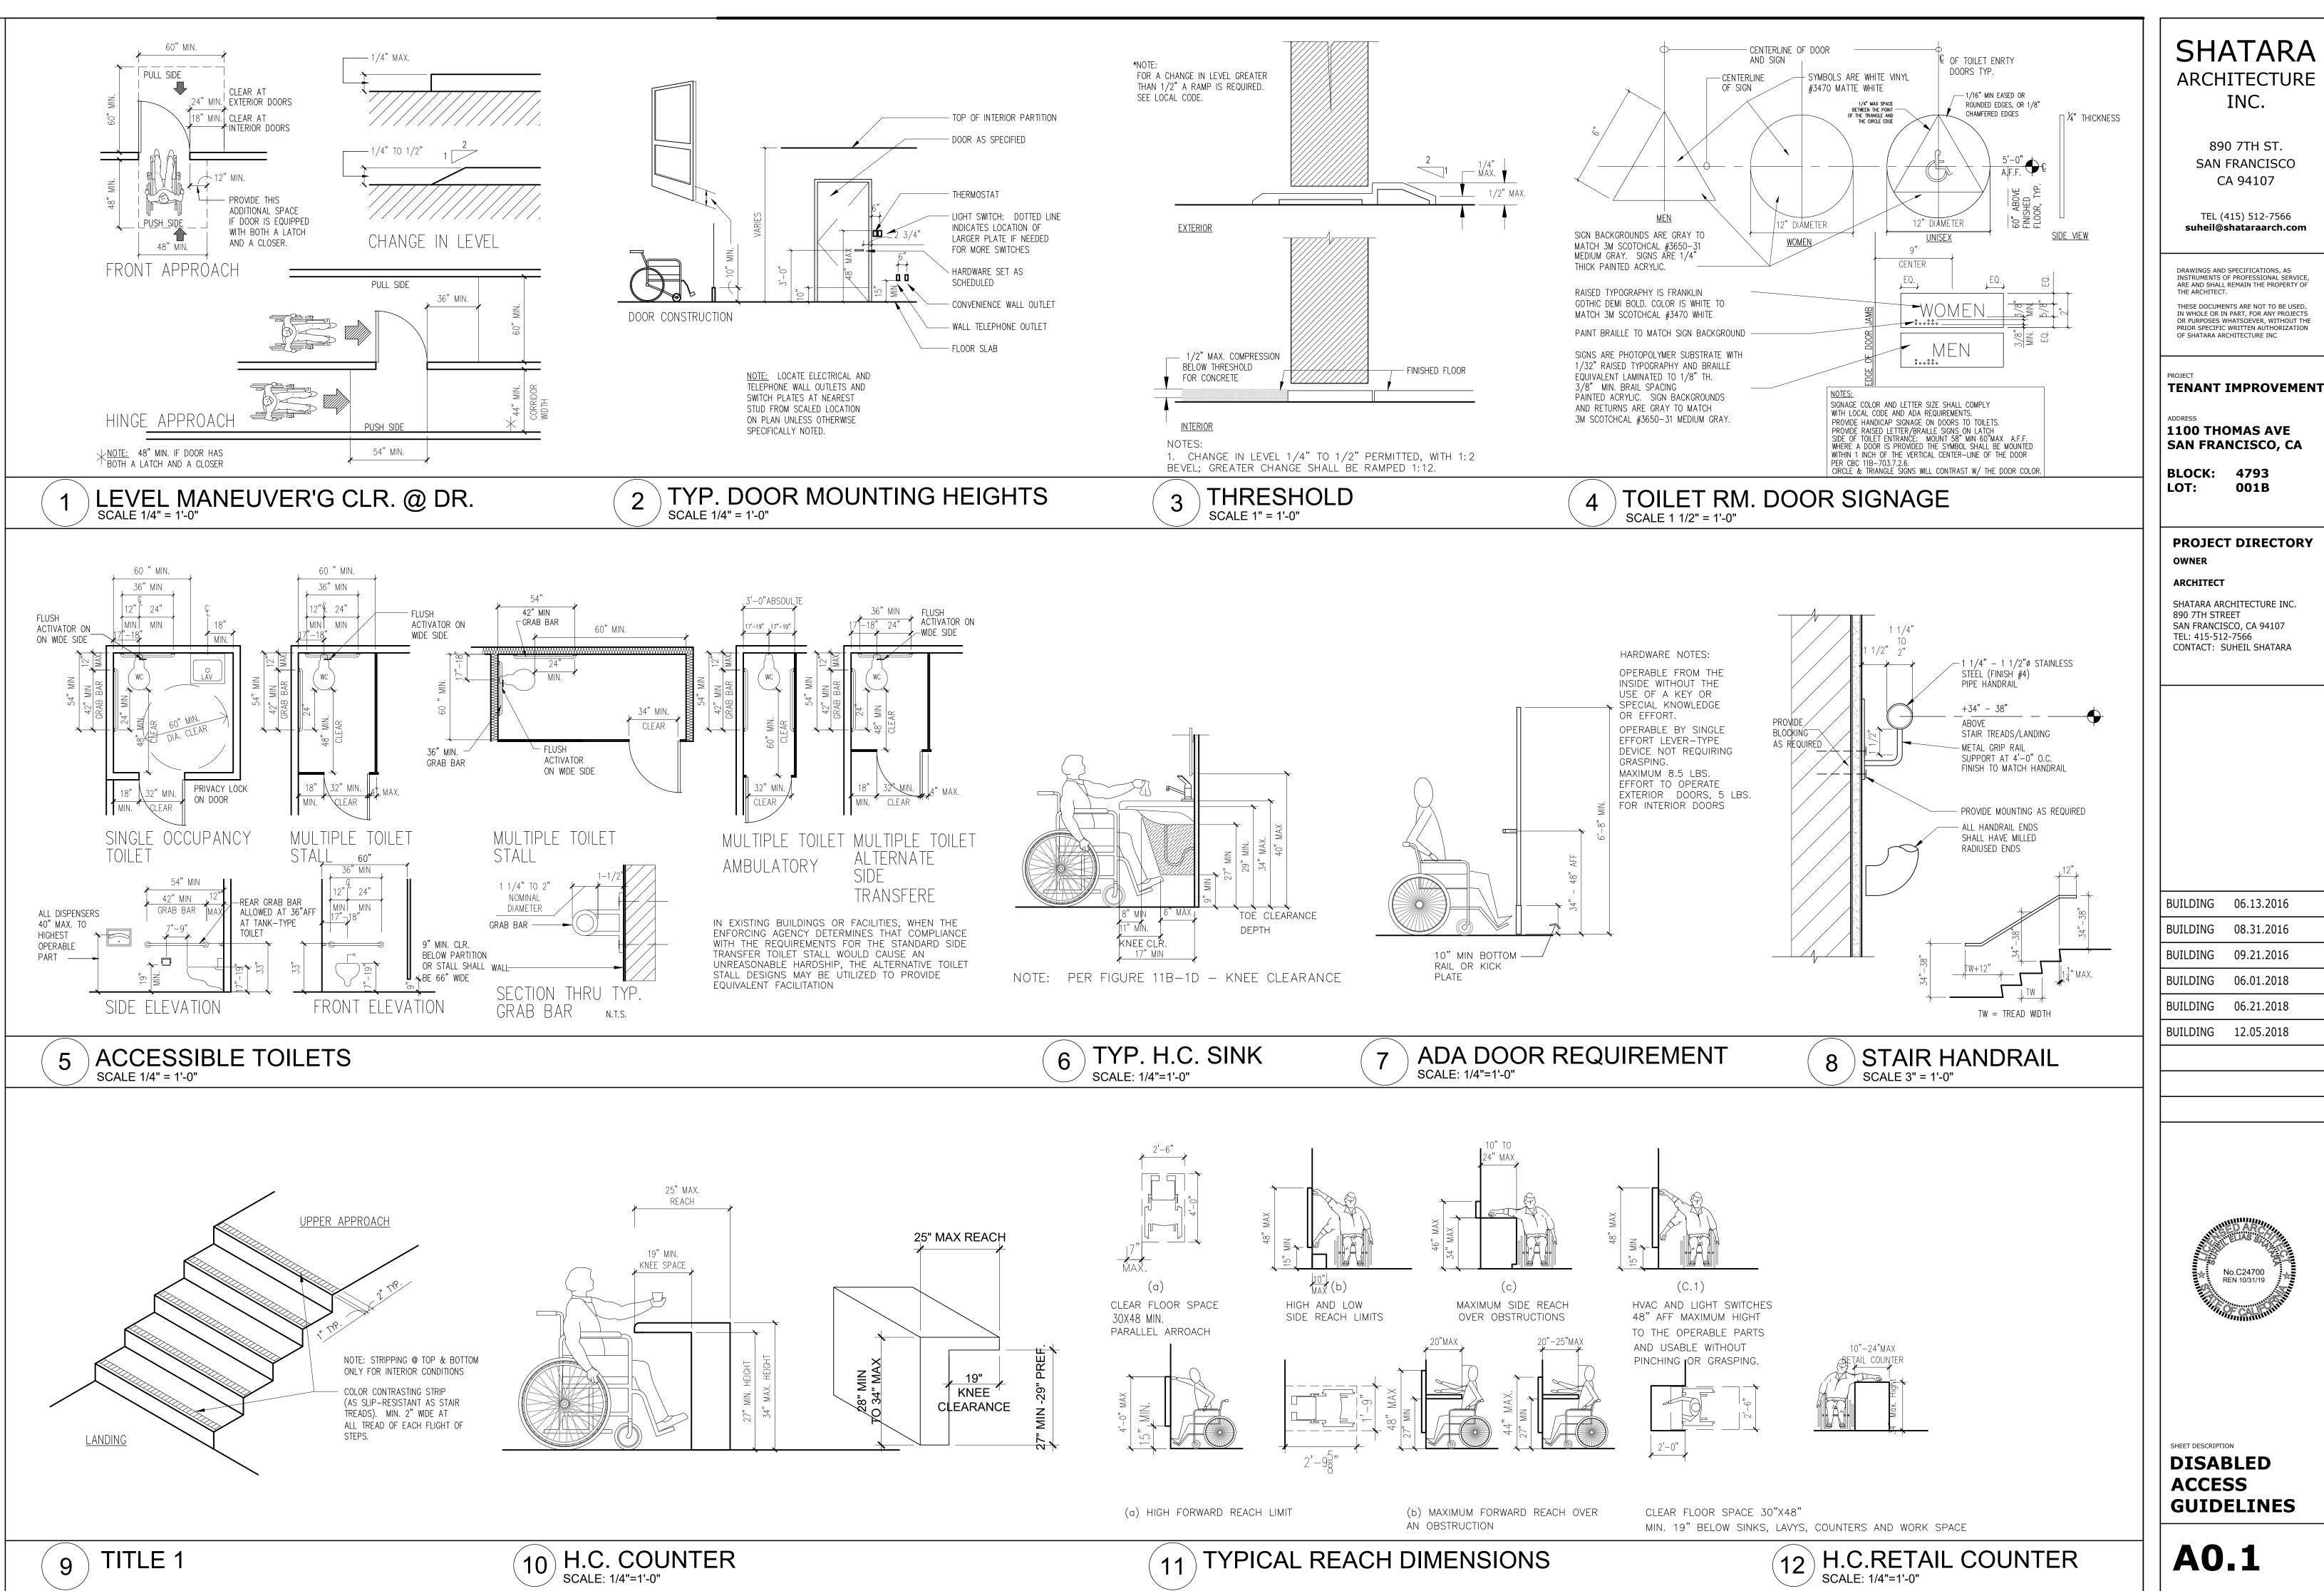

SHATARA ARCHITECTURE INC.

890 7TH ST. SAN FRANCISCO CA 94107

TEL (415) 512-7566 suheil@shataraarch.com

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OR PURPOSES WHATSOEVER, WITHOUT THE

1100 THOMAS AVE SAN FRANCISCO, CA

BLOCK: 4793 001B

PROJECT DIRECTORY

OWNER

SHATARA ARCHITECTURE INC. 890 7TH STREET SAN FRANCISCO, CA 94107 TEL: 415-512-7566

BUILDING 06.13.2016 BUILDING 08.31.2016

BUILDING 06.01.2018


BUILDING 06.21.2018

BUILDING 12.05.2018


No.C24700 REN 10/31/19


SHEET DESCRIPTION **DISABLED ACCESS GUIDELINES**


A0.1

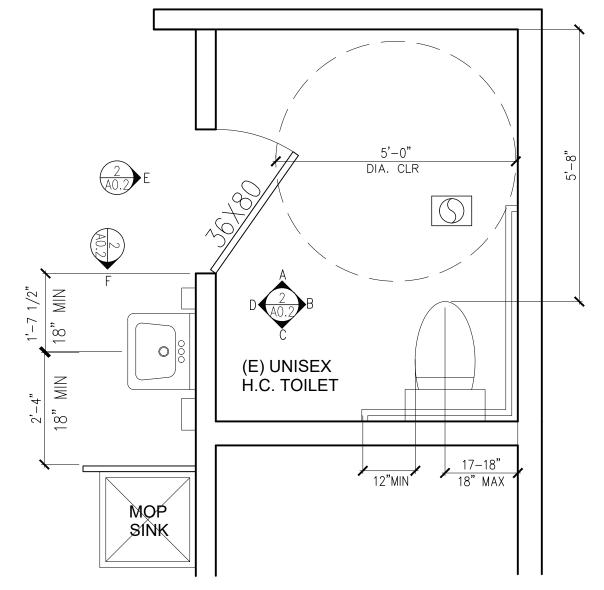



EXISTING ENLARGED H.C. TOILET PLAN SCALE: 1/2"=1'-0"

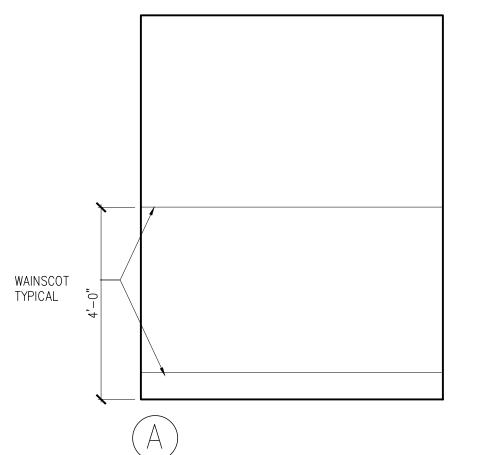

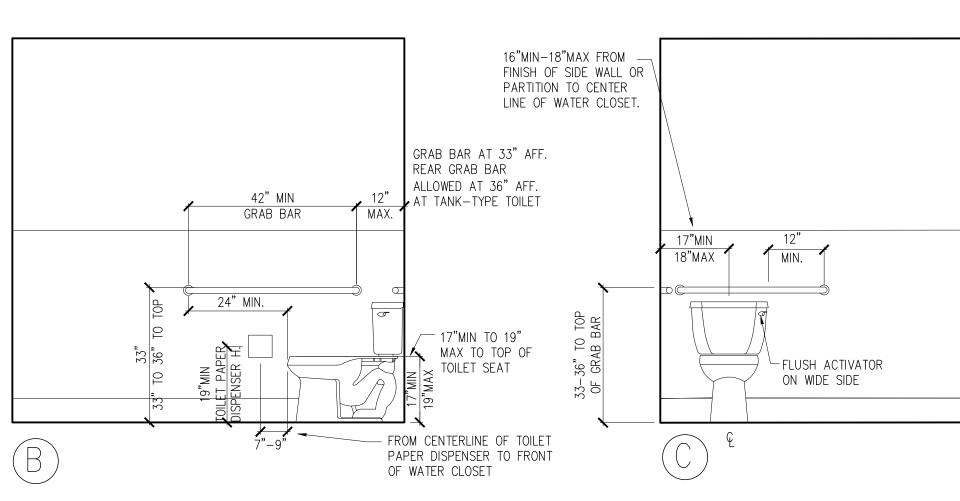

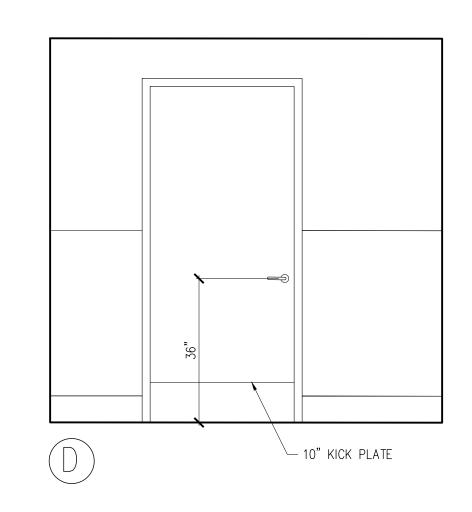


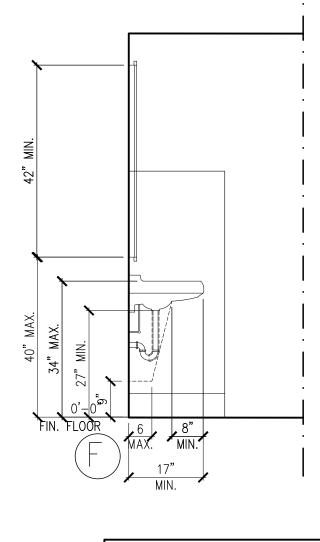


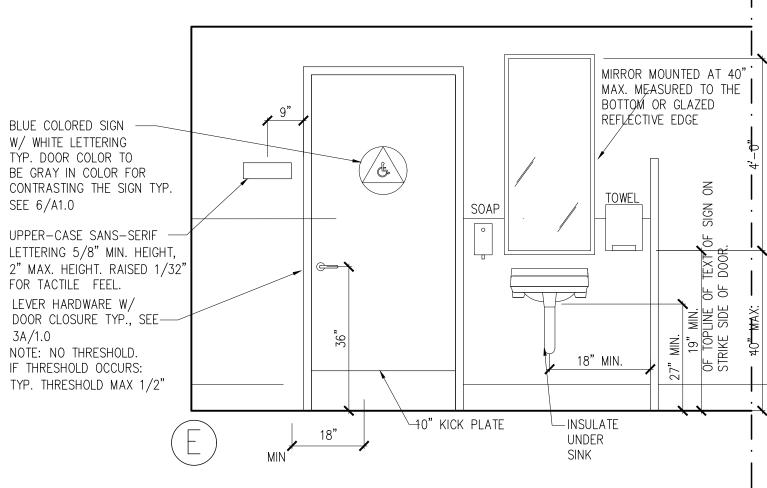

TOILET ELEVATIONS SCALE: 1/2"=1'-0"

"EXIT" SIGN

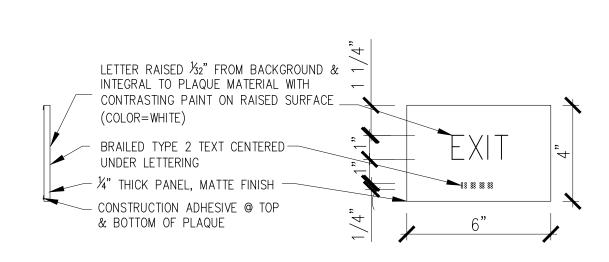

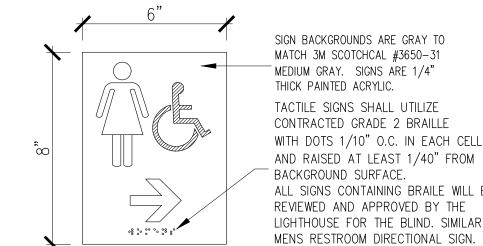

SIGN BACKGROUNDS ARE GRAY TO MATCH 3M SCOTCHCAL #3650-31 MEDIUM GRAY. SIGNS ARE 1/4" THICK PAINTED ACRYLIC. TACTILE SIGNS SHALL UTILIZE CONTRACTED GRADE 2 BRAILLE WITH DOTS 1/10" O.C. IN EACH CELL, AND RAISED AT LEAST 1/40" FROM BACKGROUND SURFACE. ALL SIGNS CONTAINING BRAILE WILL BE REVIEWED AND APPROVED BY THE LIGHTHOUSE FOR THE BLIND. SIMILAR FOR

PAINT BRAILLE TO MATCH SIGN BACKGROUND

\DIRECTIONAL SIGNAGE

LATCH SIDE 3/8 LOCATE 4" FROM EDGE OF GLASS ON LATCH SIDE OF THE DOOR - WHITE EDGE (NO BLACK BODER) WHITE I.S.A. (INTERNATIONAL SYMBOL OF ACCESSIBILITY) USE INDUSTRY STANDARD. BLUE BACKGROUND -USE INDUSTRY STANDARD - FOR ACCESSIBILITY SIGNAGE PROVIDE REVERSE PRINTED DECAL-APPLY TO INSIDE SURFACE OF GLASS, FACINGS OUTSIDE.

ISA DECAL (TACTILITY NOT REQUIRED

TYPICAL SIGNAGE NOTES

1. ALL SIGN COMPONENTS SHALL BE INSTALLED WITH PERMANENT ADHESIVE TO PROVIDE DURABLE SIGNANGE WITH NO DELAMINATION.

2. WALL MOUNTED SIGNS SHALL BE INSTALLED WITH THE CENTERLINE OF SIGN AT 60 A.F.F. U.O.N

3. ROOM IDENTIFICATION SIGNS SHALL BE MOUNTED ON THE LATCH SIDE OF THE DOOR, UNLESS IF THERE IS INSUFFICIENT SPACE, IN WHICH CASE SIGN MAY BE MOUNTED ON THE HINGE SIDE.

4. TACTILE SIGNS SHALL COMPLY WITH A.D.A RECOMMENDATIONS. TEXT SHALL BE SANS-SERIF UPPERCASE CHARACTERS AT LEAST 5/8" HIGH AND RAISED 1/32" FROM BACKGROUND SURFACE.

5. TACTILE SIGNS SHALL UTILIZE CONTRACTED GRADE 2 BRAILLE WITH DOTS 1/10" O.C. IN EACH CELL, AND RAISED AT LEAST 1/40" FROM BACKGROUND SURFACE.

6. PICTORGRAM'S BORDER DIMENSION SHALL BE AT LEAST 6" HIGH AND EACH DIRECTLY SHALL BE ACCOMPANIED BY THE EQUIVALENT VERBAL DESCRIPTION PLACED DIRECTLY BELOW THE PICTOGRAM.

7. FONT FOR ALL TEXT SHALL BE UNIVERSE 57 CONDESED AS SHOWN IN DETAILS .

8. ARCHITECT TO PROVIDE DIGITAL FILES AS REQUIRED BY SIGNAGE FABRICATOR

9. SAMPLES AND VERIFICATION OF SIGNAGE SHALL BE REQUIRED TO ENSURE COMPLIANCE

10. ALL SIGNS CONTAINING BRAILE WILL BE REVIEWED AND APPROVED BY THE LIGHTHOUSE FOR THE BLIND.

11. ALL SIGNS TO BE CLEAR NON-GLARE AND CONTRASTING ON COLOR.

SHATARA ARCHITECTURE INC.

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OR PURPOSES WHATSOEVER, WITHOUT THE

OF SHATARA ARCHITECTURE INC.

TENANT IMPROVEMENT

1100 THOMAS AVE SAN FRANCISCO, CA

BLOCK: 4793 LOT: 001B

PROJECT DIRECTORY

OWNER **ARCHITECT**

SHATARA ARCHITECTURE INC. 890 7TH STREET SAN FRANCISCO, CA 94107 TEL: 415-512-7566 CONTACT: SUHEIL SHATARA

BUILDING 06.13.2016

BUILDING 08.31.2016 BUILDING 09.21.2016

BUILDING 06.01.2018

BUILDING 12.05.2018


BUILDING 06.21.2018

No.C24700 REN 10/31/19

SHEET DESCRIPTION **ACCESSIBILITY REQUIREMENTS**

A0.2



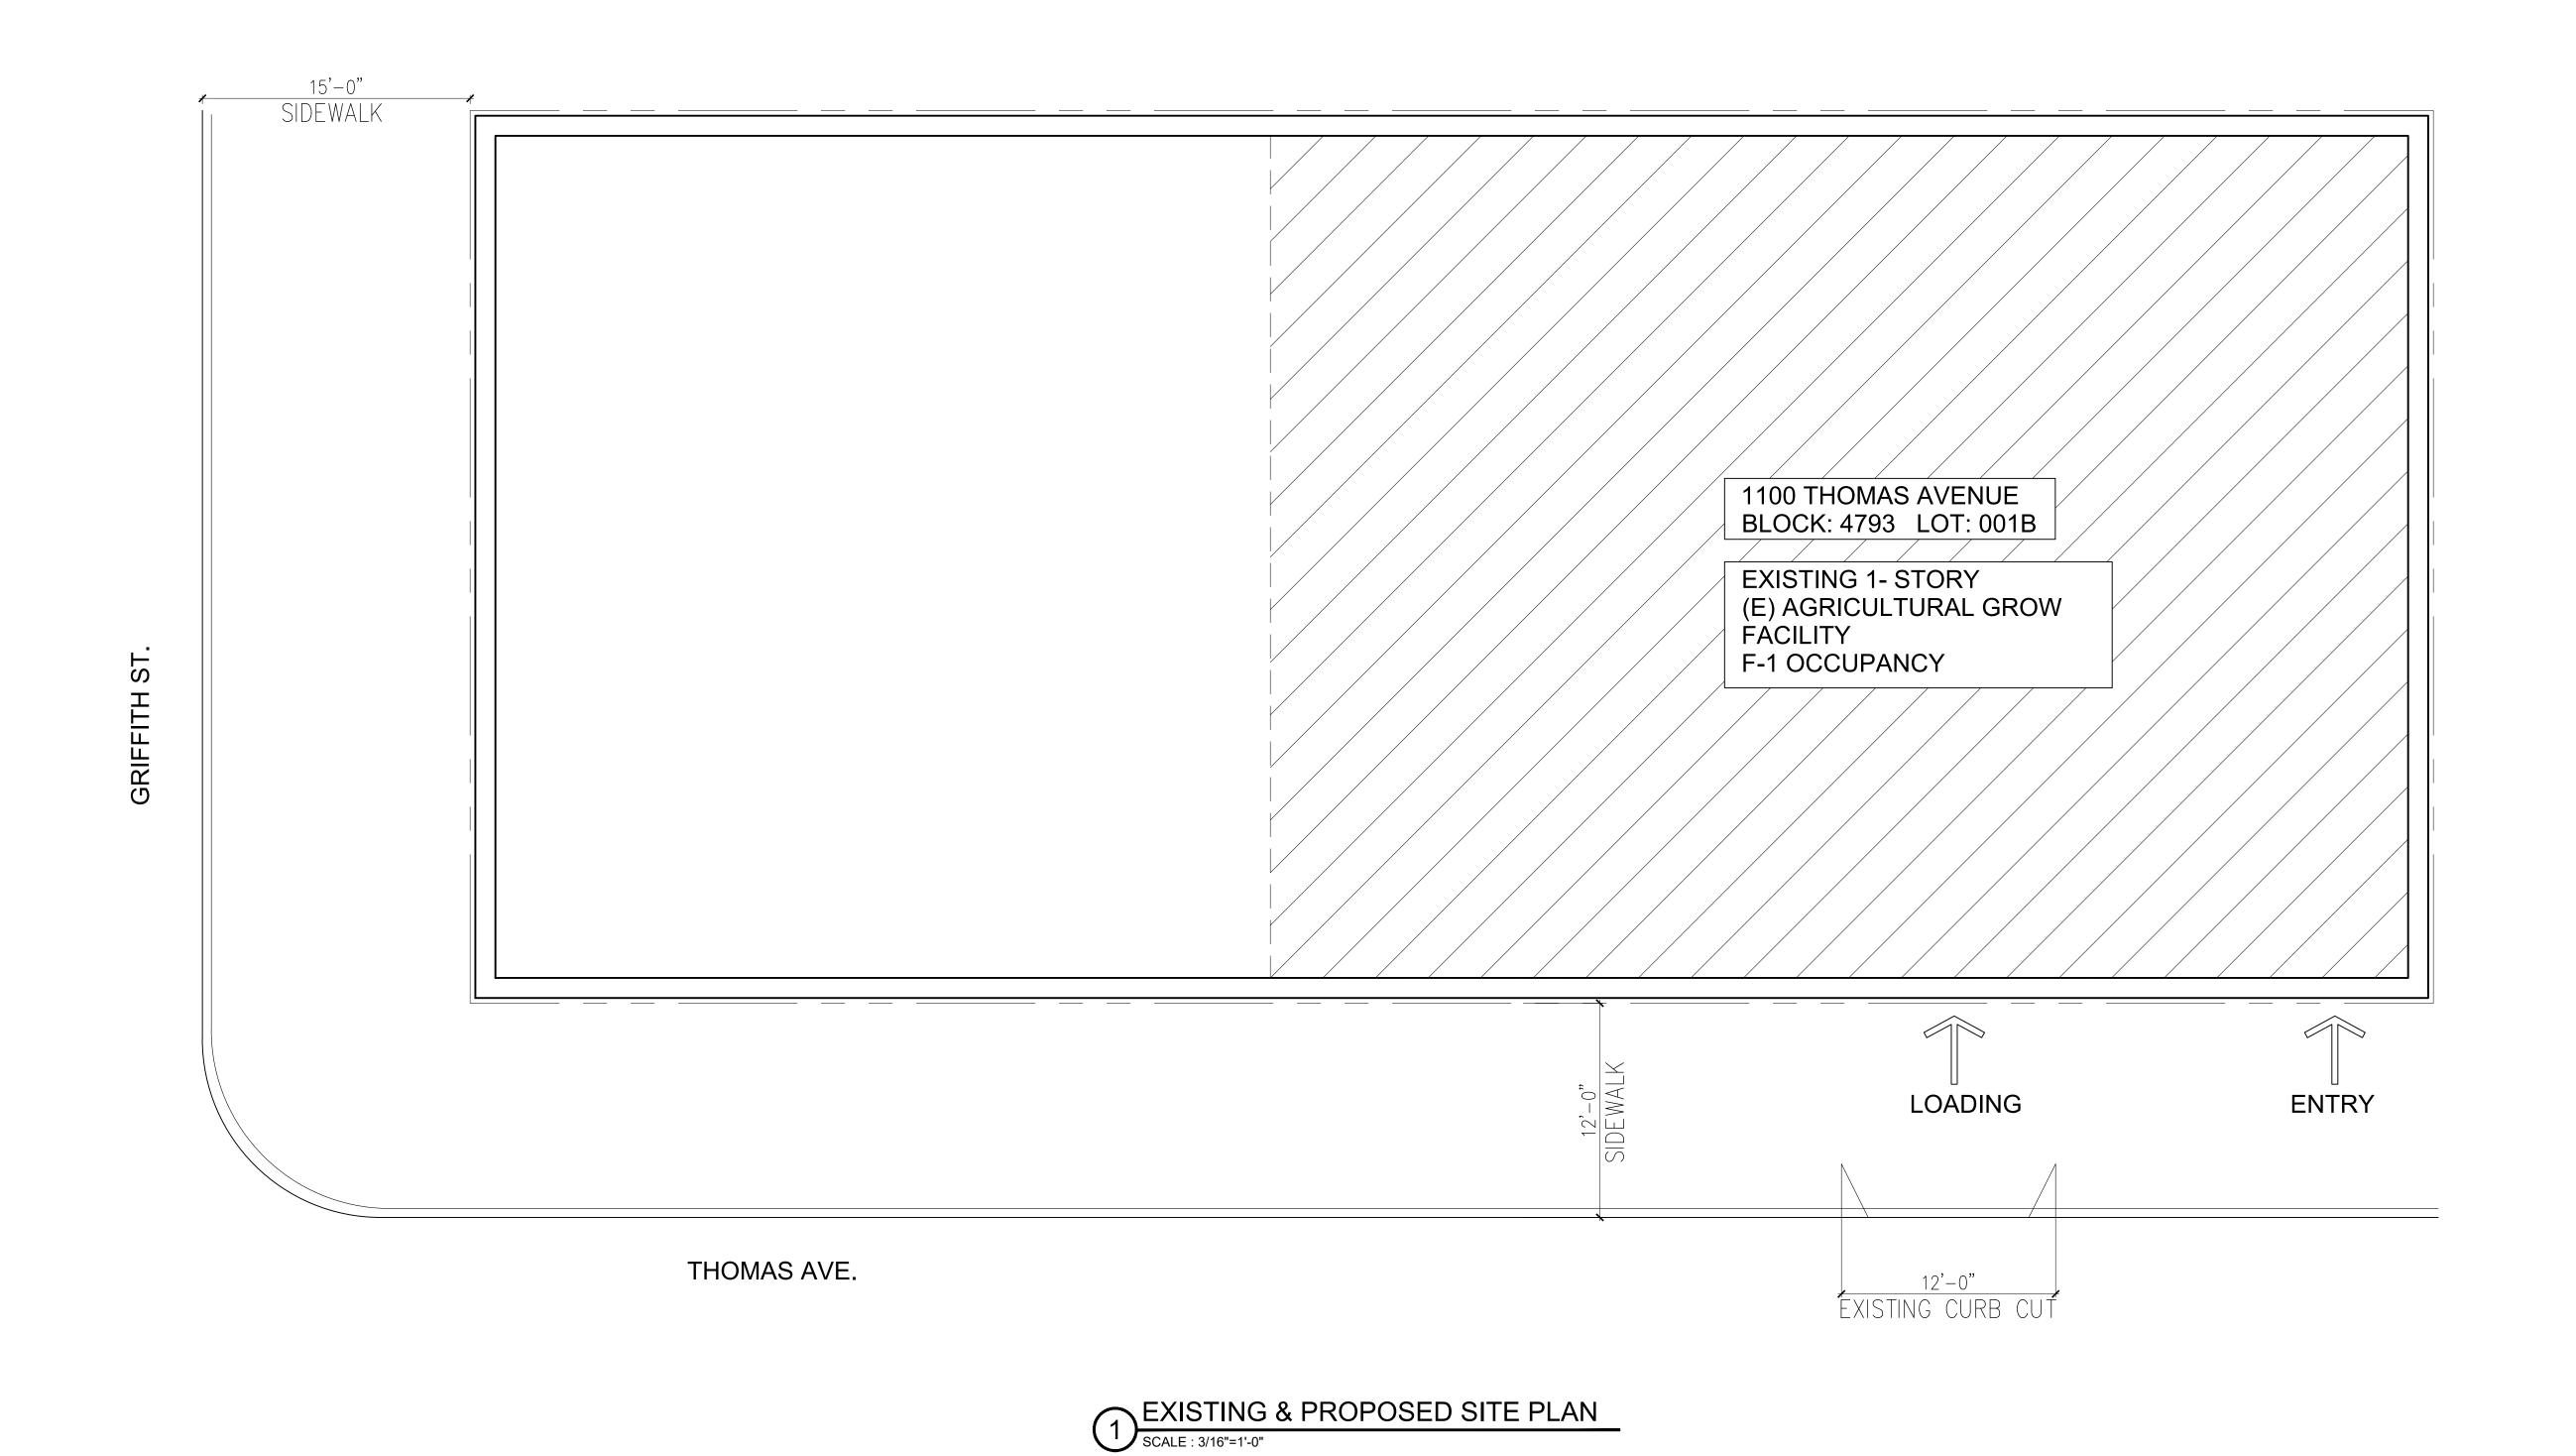

SHATARA ARCHITECTURE

> 890 7TH ST. SAN FRANCISCO CA 94107

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TENANT IMPROVEMENT

1100 THOMAS AVE SAN FRANCISCO, CA

BLOCK: 4793 LOT: 001B

PROJECT DIRECTORY

OWNER ARCHITECT

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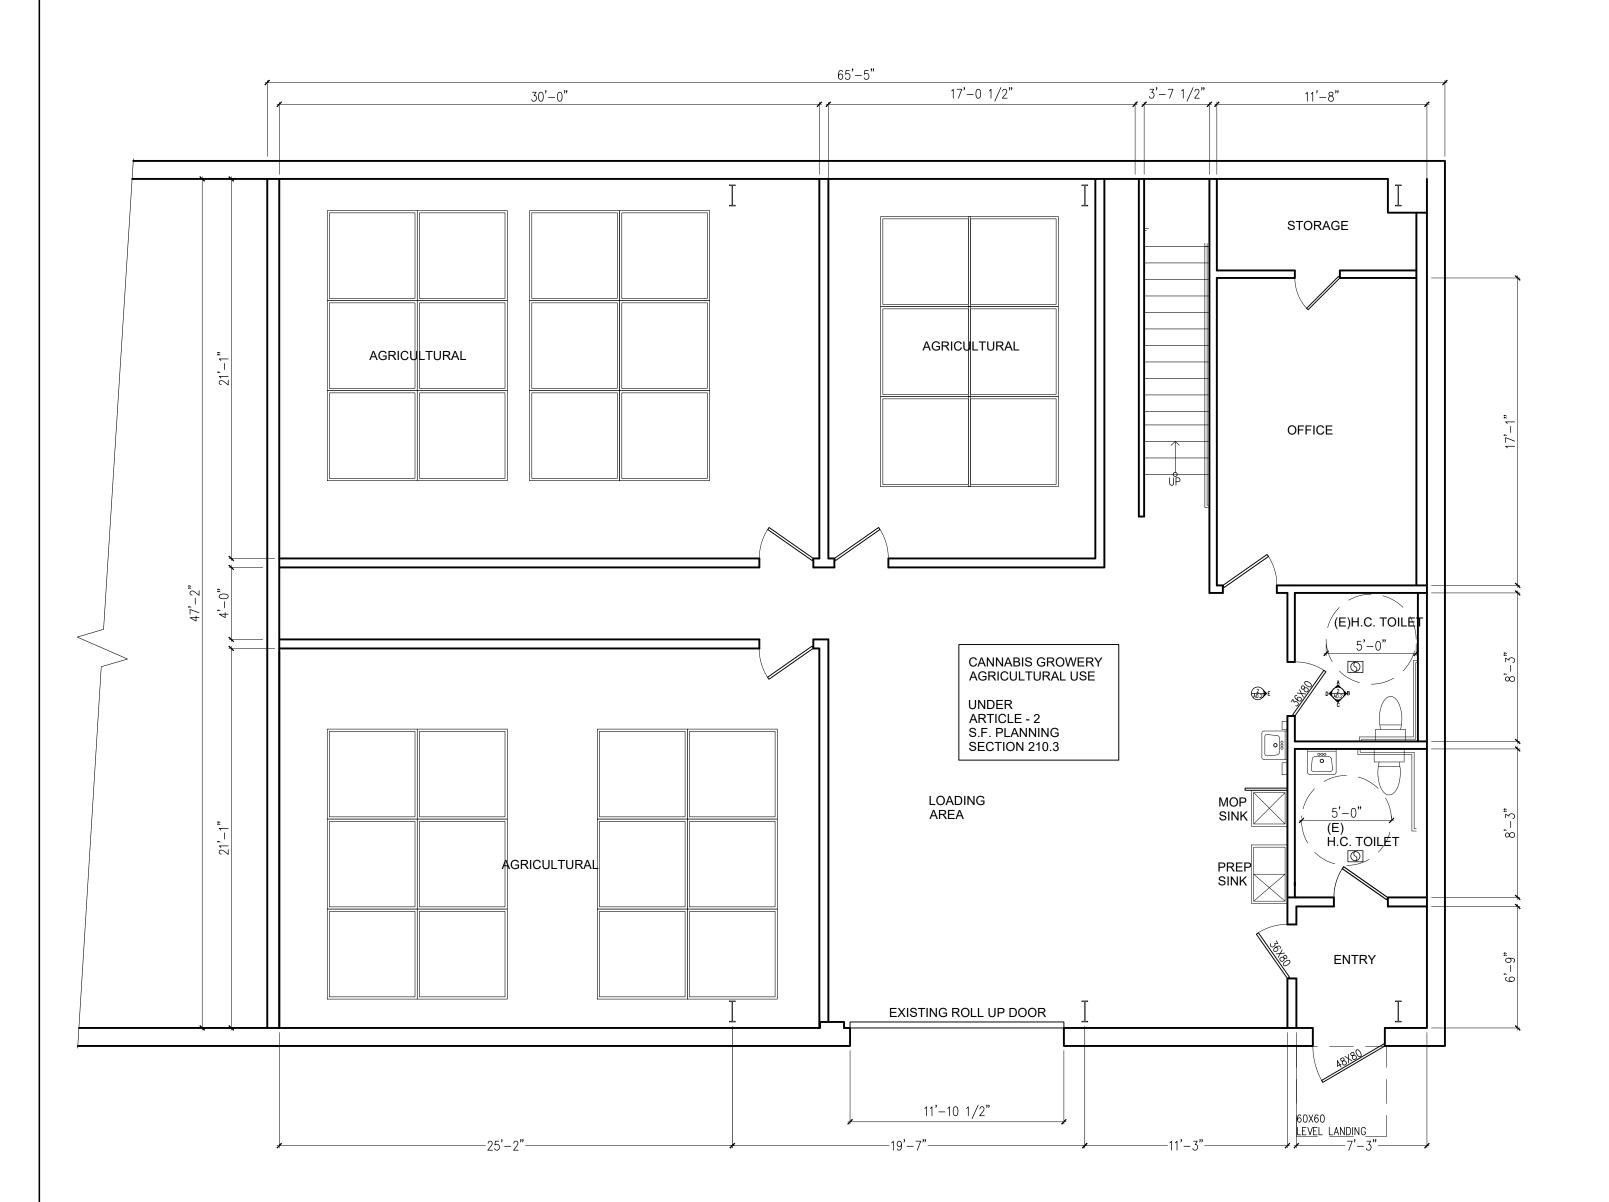
BUILDING 12.05.2018


No.C24700
REN 10/31/19

EXISTING /
PROPOSED SITE
PLANS


A1.0





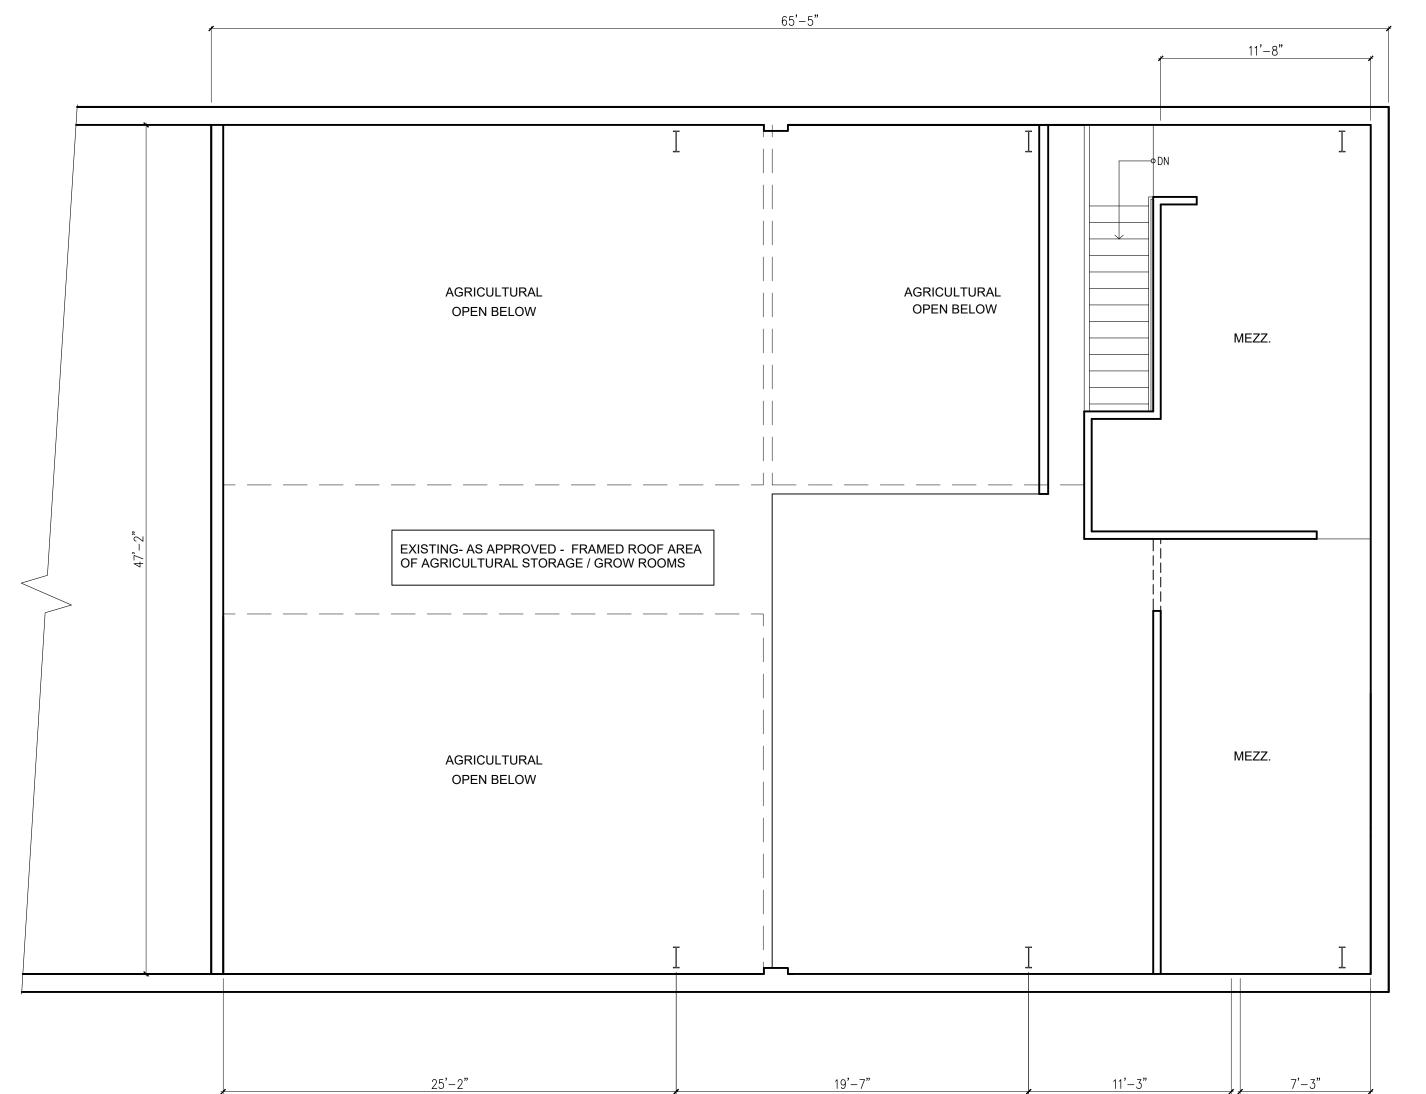

EXISTING AS APPROVED FIRST FLOOR PLAN SCALE: 3/16"=1'-0"

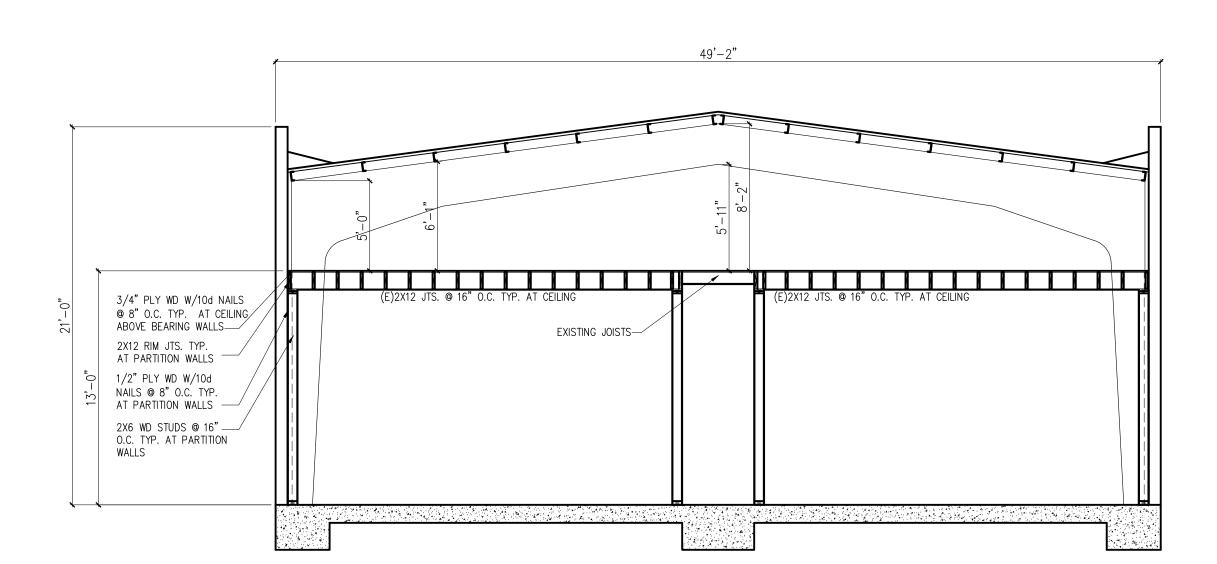

EXISTING AS APPROVED WIDE SECTION

SCALE: 3/16"=1'-0"

EXISTING AS APPROVED MEZZANINE FLOOR PLAN SCALE: 3/16"=1'-0"

1) WALL TYPES DWGS DO NOT CONVEY STRUCTURAL (SHEAR) REQUIREMENTS. SEE STRUCT. DWGS.


(2) FLOOR CEILING ASSEMBLIES DO NOT CONVEY STRUCTURAL REQUIREMENTS. SEE STRUCT. DWGS.

SHEET NOTES

DETAILS SHEET NOTES

- ALL PLAN DIMENSIONS TO FACE OF ROUGH FRAMING, FACE OF CONCRETE, OR CENTER LINE OF STEEL, U.O.N.
- 2. ALL SECTION AND ELEVATION DIMENSIONS TO FINISH FLOOR.
- 3. ALL WOOD FRAMED EXTERIOR WALLS TO BE FRAMED WITH 2X6 U.O.N. INTERIOR WALLS TO BE FRAMED WITH 2X4 U.O.N. REFER TO WALL TYPES TAGS FOR EXCEPTIONS.



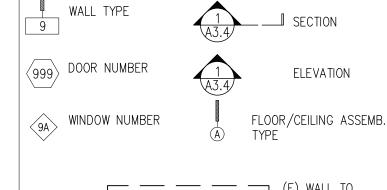

BÉ DEMOLISHED (E) WALL TO REMAIN

----- PROPERTY LINE

A1.1

SHATARA ARCHITECTURE INC.

890 7TH ST. SAN FRANCISCO CA 94107

TEL (415) 512-7566 suheil@shataraarch.com

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TENANT IMPROVEMENT

1100 THOMAS AVE

BLOCK: 4793 001B LOT:

SAN FRANCISCO, CA

PROJECT DIRECTORY

ARCHITECT

OWNER

SHATARA ARCHITECTURE INC. 890 7TH STREET SAN FRANCISCO, CA 94107 TEL: 415-512-7566 CONTACT: SUHEIL SHATARA


BUILDING 06.13.2016

BUILDING 08.31.2016 BUILDING 09.21.2016


BUILDING 06.01.2018

BUILDING 12.05.2018

BUILDING 06.21.2018

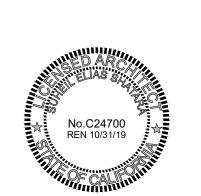

SHEET DESCRIPTION **EXISTING AS APPROVED FLOOR PLANS & SECTION**

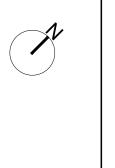

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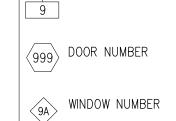
No.C24700 REN 10/31/19

BUILDING 12.05.2018

1) WALL TYPES DWGS DO NOT CONVEY STRUCTURAL (SHEAR) REQUIREMENTS. SEE STRUCT. DWGS.

3. ALL WOOD FRAMED EXTERIOR WALLS TO BE FRAMED WITH 2X6 U.O.N. INTERIOR WALLS TO BE FRAMED WITH 2X4 U.O.N. REFER TO WALL TYPES TAGS FOR EXCEPTIONS.

LEGEND



 $\frac{1}{A3.4}$ SECTION


ELEVATION FLOOR/CEILING ASSEMB.

BÉ DEMOLISHED (E) WALL TO REMAIN

SHEET DESCRIPTION

AS BUILT

FLOOR PLANS

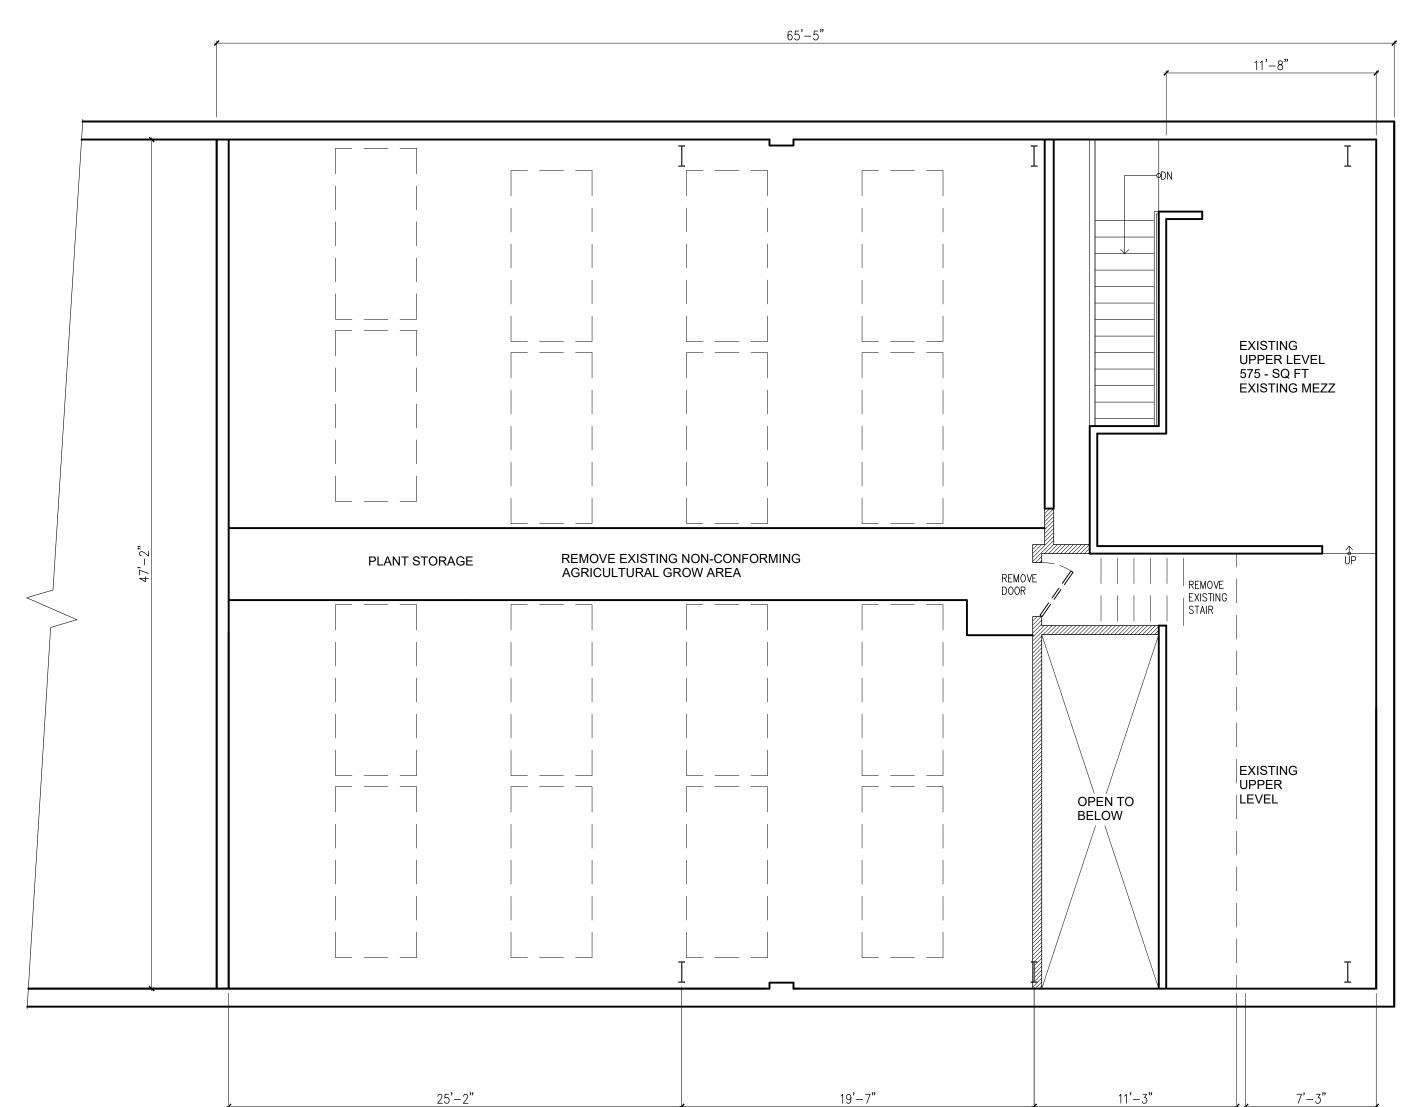

AS BUILT FIRST FLOOR PLAN W/O BENEFIT OF PERMIT

30'-0 1/2"

AGRICULTURAL

AGRICULTURAL

—25'-2 1/2"—

GROW AREA

PLANT STORAGE

14'-1 1/2"

AGRICULTURAL

CO2 NEW 36X80 STORAGE 1-HR DOOR

TANKS

LOADING

CANNABIS GROWERY

EXISTING ROLL UP DOOR

11'-10 1/2"

AGRICULTURAL USE F-1 OCCUPANCY

UNDER ARTICLE - 2 S.F. PLANNING

_19'-6 1/2"<u>—</u>

SECTION 210.3

GROW AREA

6'-6"

SENSOR

---WATER RESERVOIR

NUTRIENT

RACK

SINK

NEW 2X6 SINK

PARTITION

11'-8"

STORAGE

OFFICE

/ H.C. TOILET

(E) H.C. TOILET

ENTRY

LEVEL LANDING

49'-2" 3/4" PLY WD W/10d NAILS @ 8" O.C. TYP. AT CEILING 2X6 LEDGER W/5/8" DIA. M.B. @ 32"O.C.— ABOVE PARTITION WALLS..... W/2X6 FLOOR JTS. W/ JTS. HANGERS TYP. 2X12 RIM JTS. TYP. PROVIDE 3/4" PLY WD & 5/8" GYP. BD. AT PARTITION WALLS 1/2" PLY WD W/10d NAILS @ 8" O.C. TYP. AT PARTITION WALLS 2X6 WD STUDS @ 16" — O.C. TYP. AT PARTITION WALLS

AS BUILT WIDE SECTION W/O BENEFIT OF PERMIT

SCALE: 3/16"=1'-0"




DETAILS SHEET NOTES


2 FLOOR CEILING ASSEMBLIES DO NOT CONVEY STRUCTURAL REQUIREMENTS. SEE STRUCT. DWGS.


SHEET NOTES


ALL PLAN DIMENSIONS TO FACE OF ROUGH FRAMING, FACE OF CONCRETE, OR CENTER LINE OF STEEL, U.O.N.


2. ALL SECTION AND ELEVATION DIMENSIONS TO FINISH FLOOR.

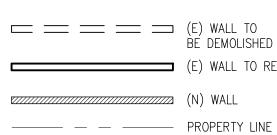

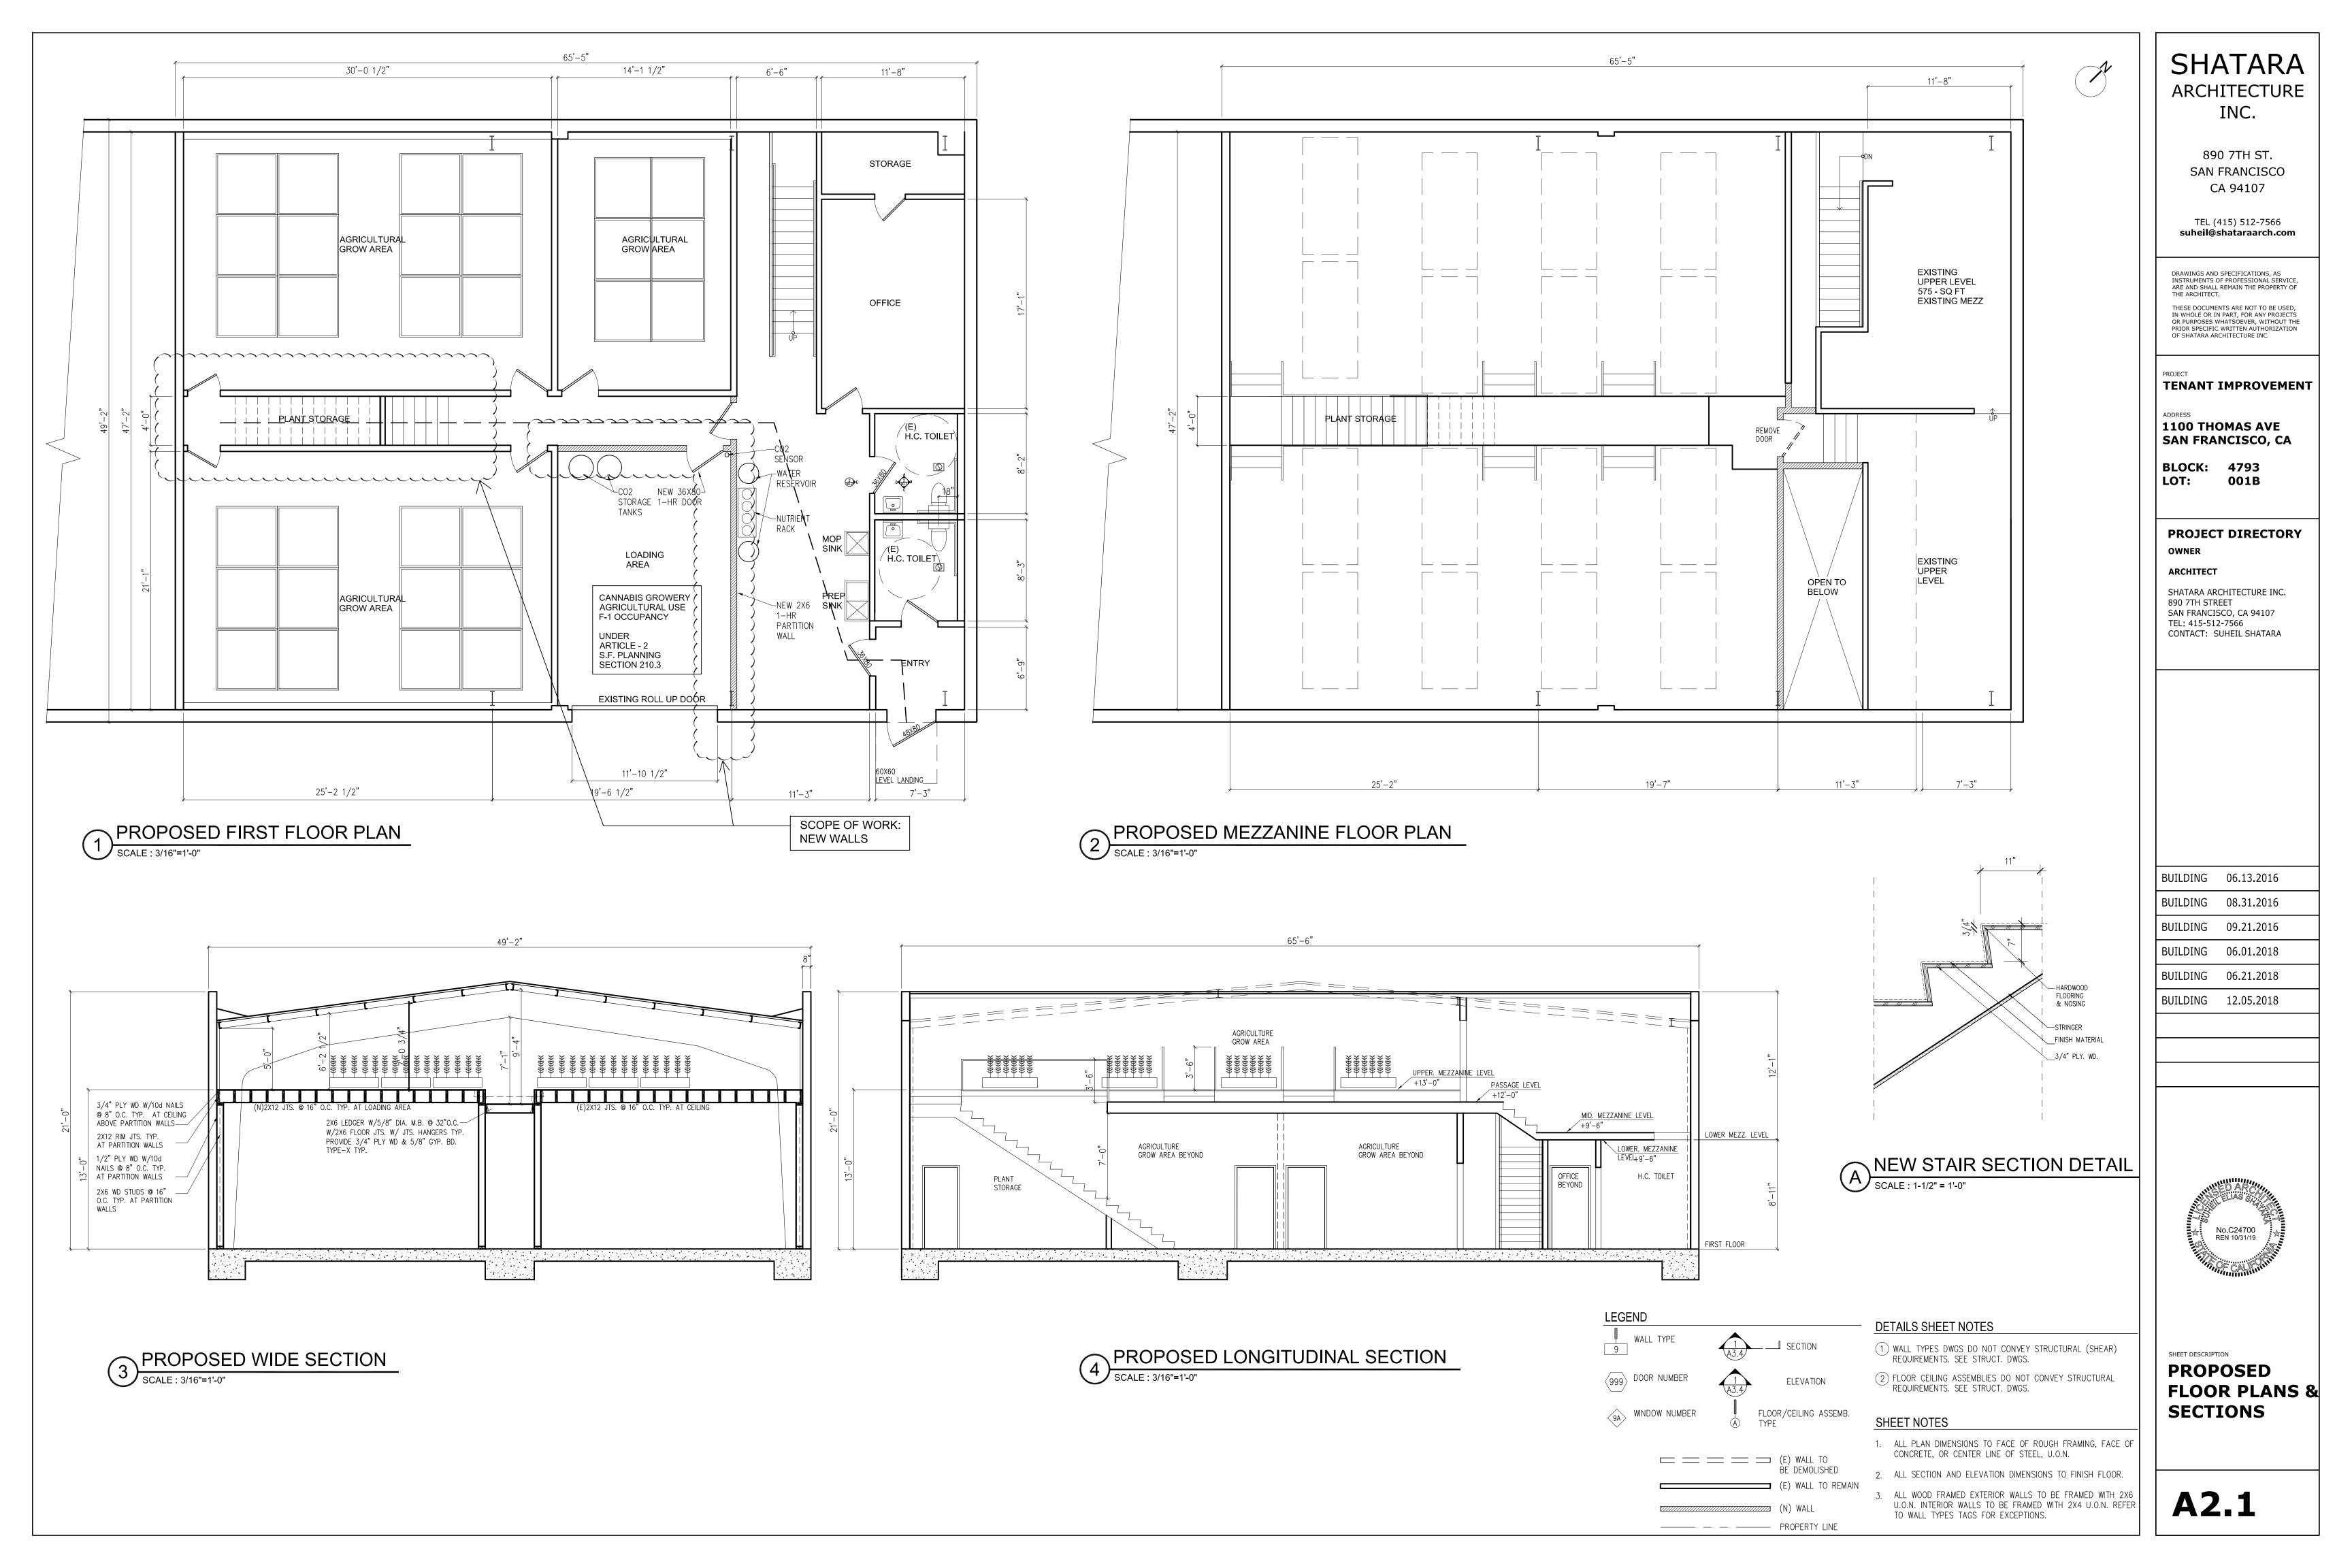

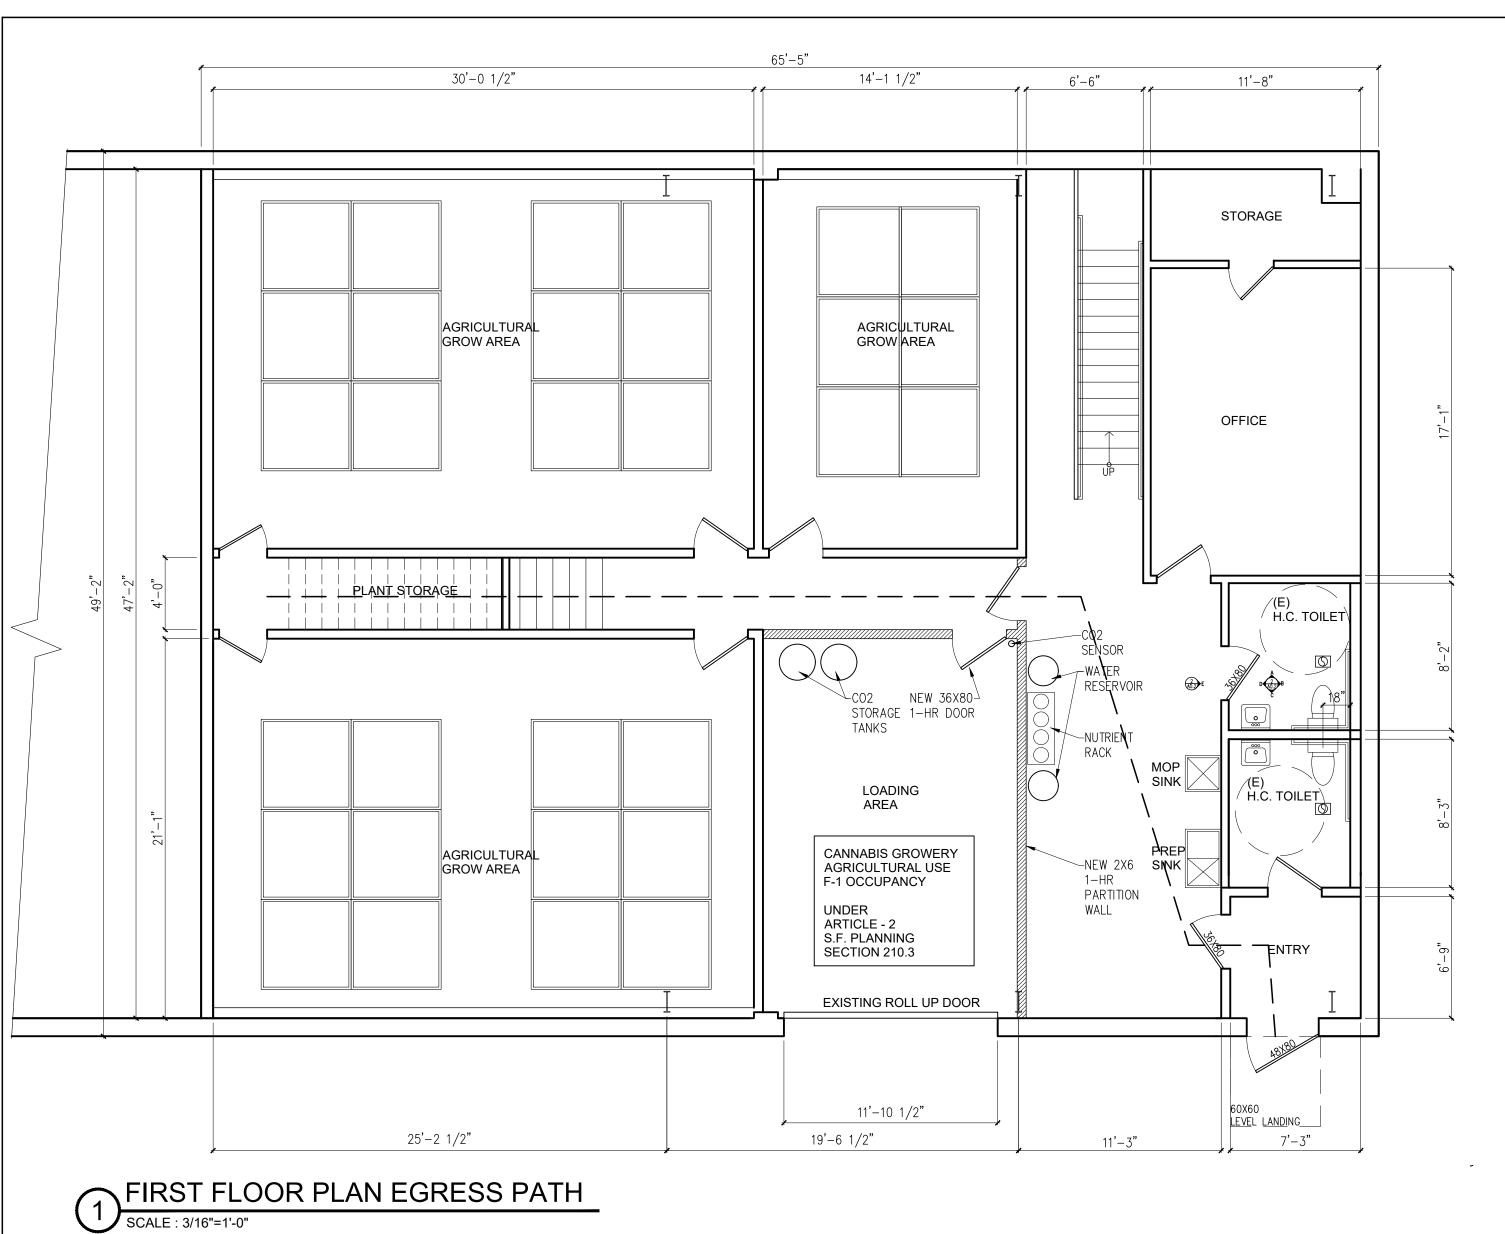


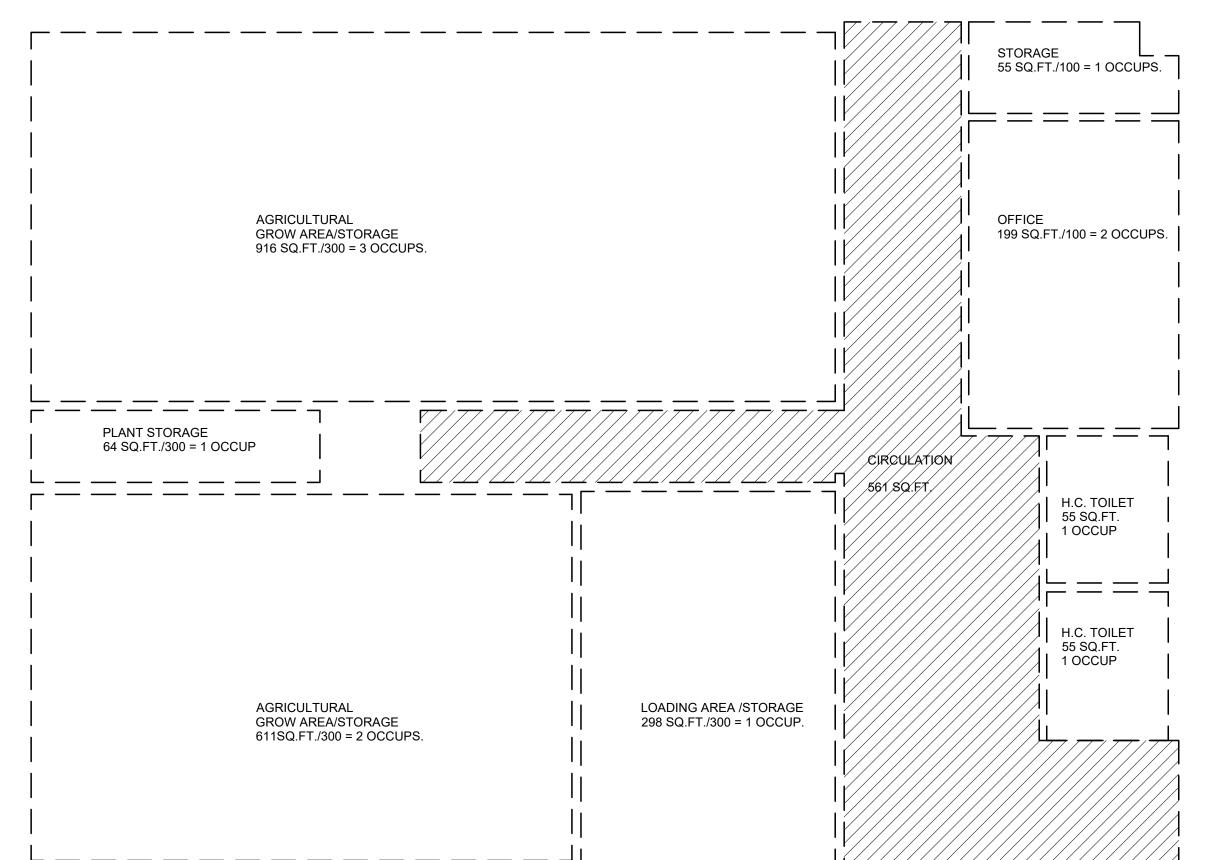

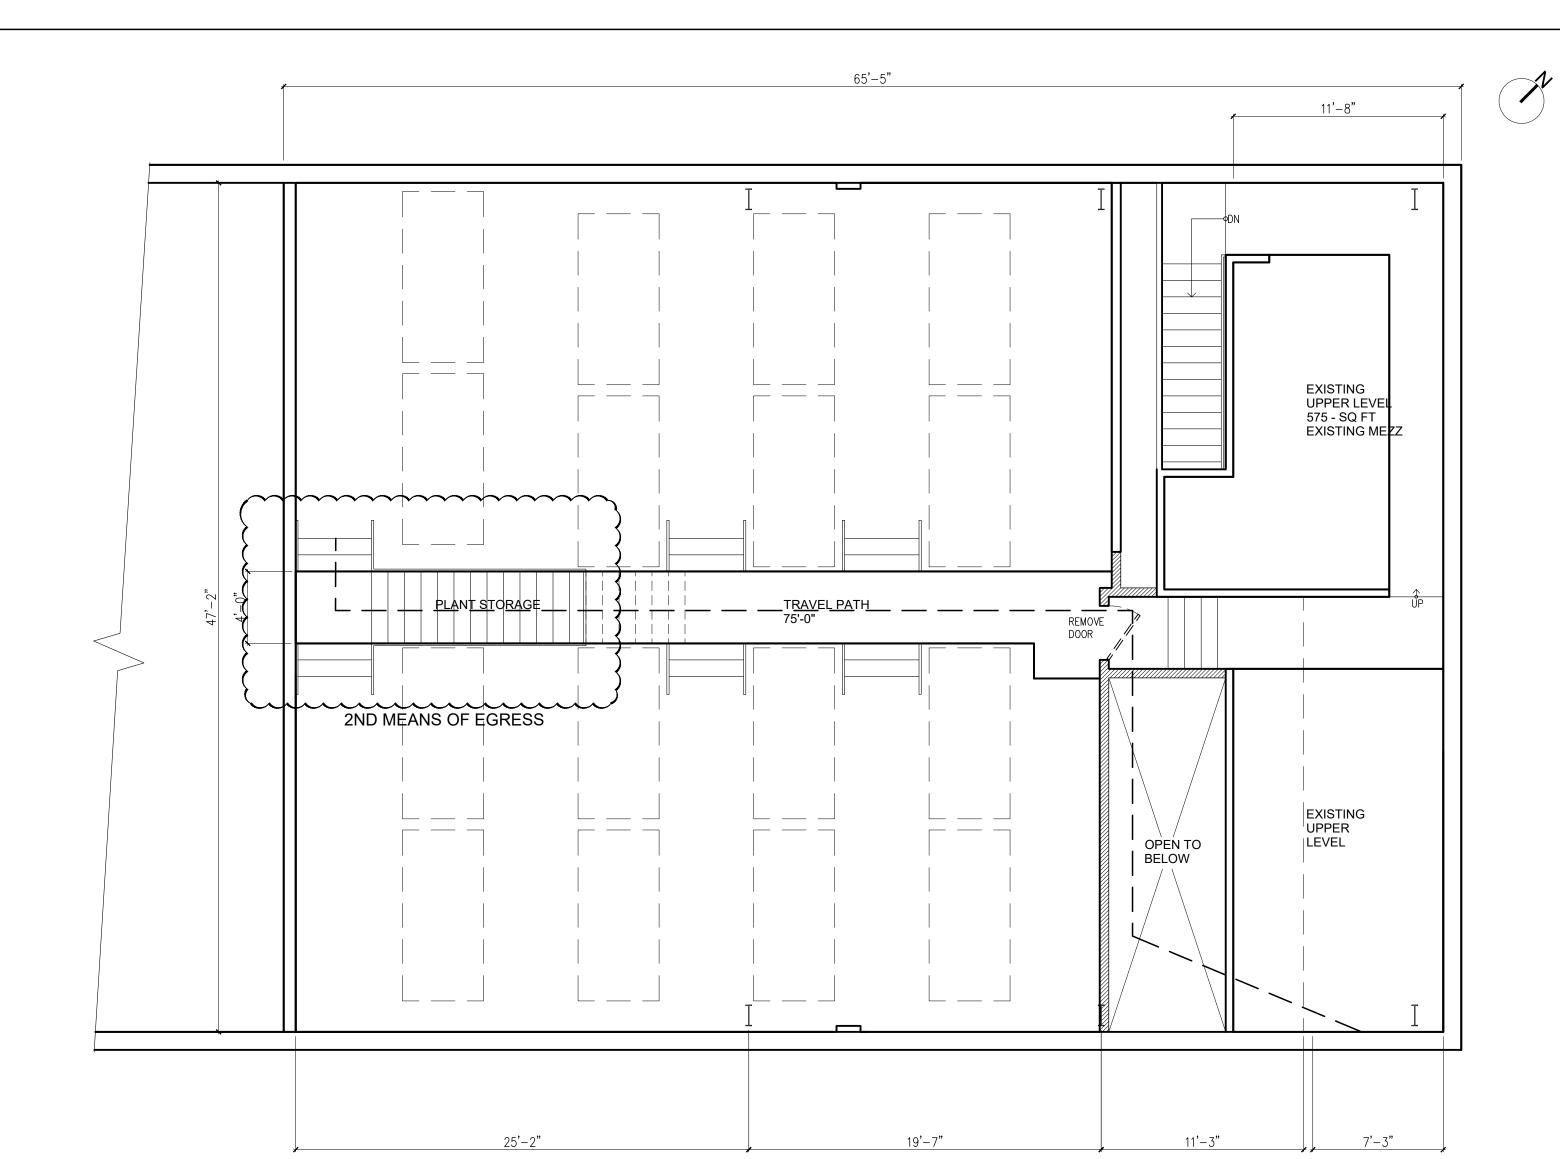

MEZZANINE FLOOR PLAN EGRESS PATH

SCALE: 3/16"=1'-0"

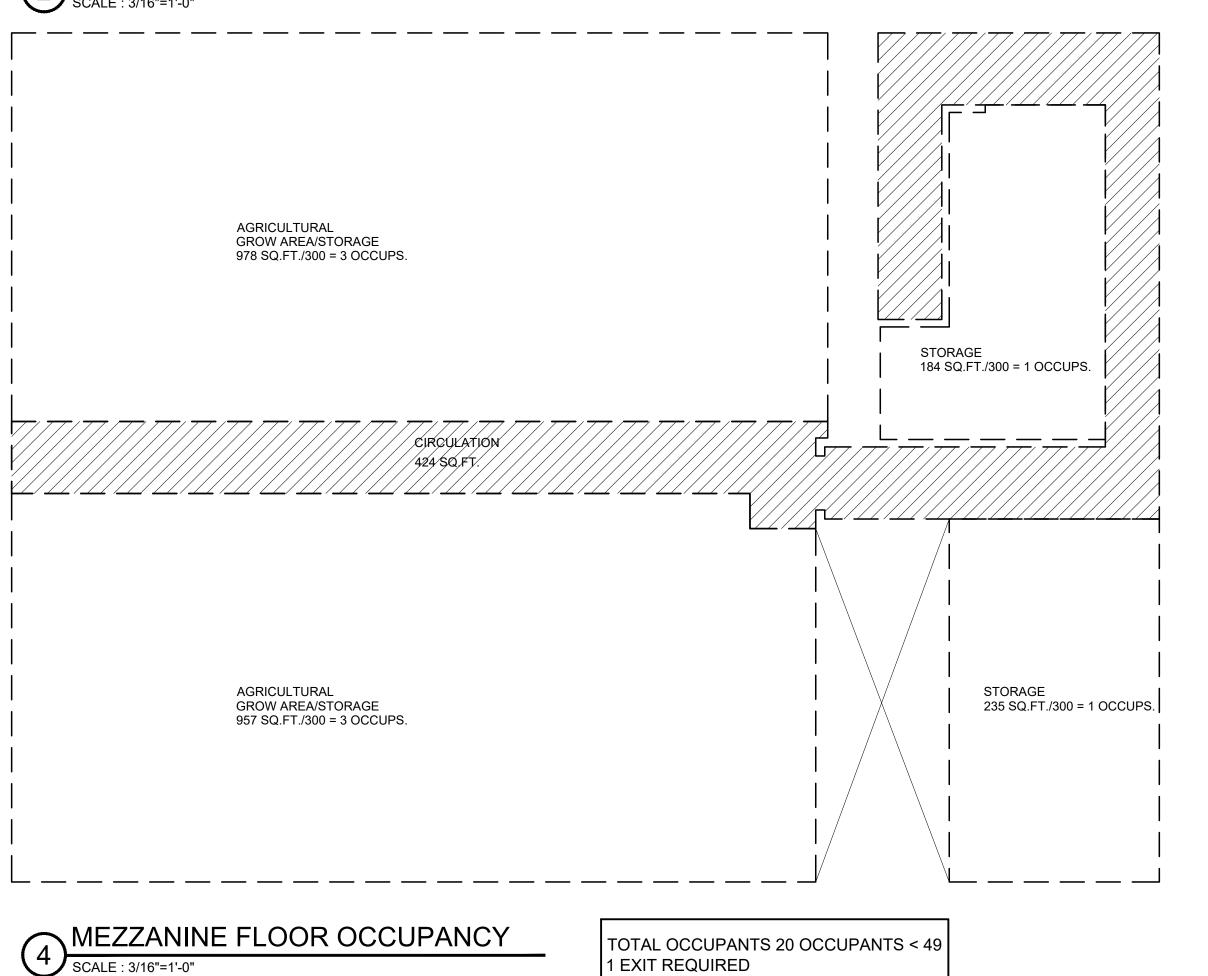

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No.C24700 REN 10/31/19

OCCUPANT LOAD FACTOR & MEANS OF **EGRESS**


A2.2

MEZZANINE FLOOR OCCUPANCY

SCALE: 3/16"=1'-0"

FIRST FLOOR OCCUPANCY

SCALE: 3/16"=1'-0"

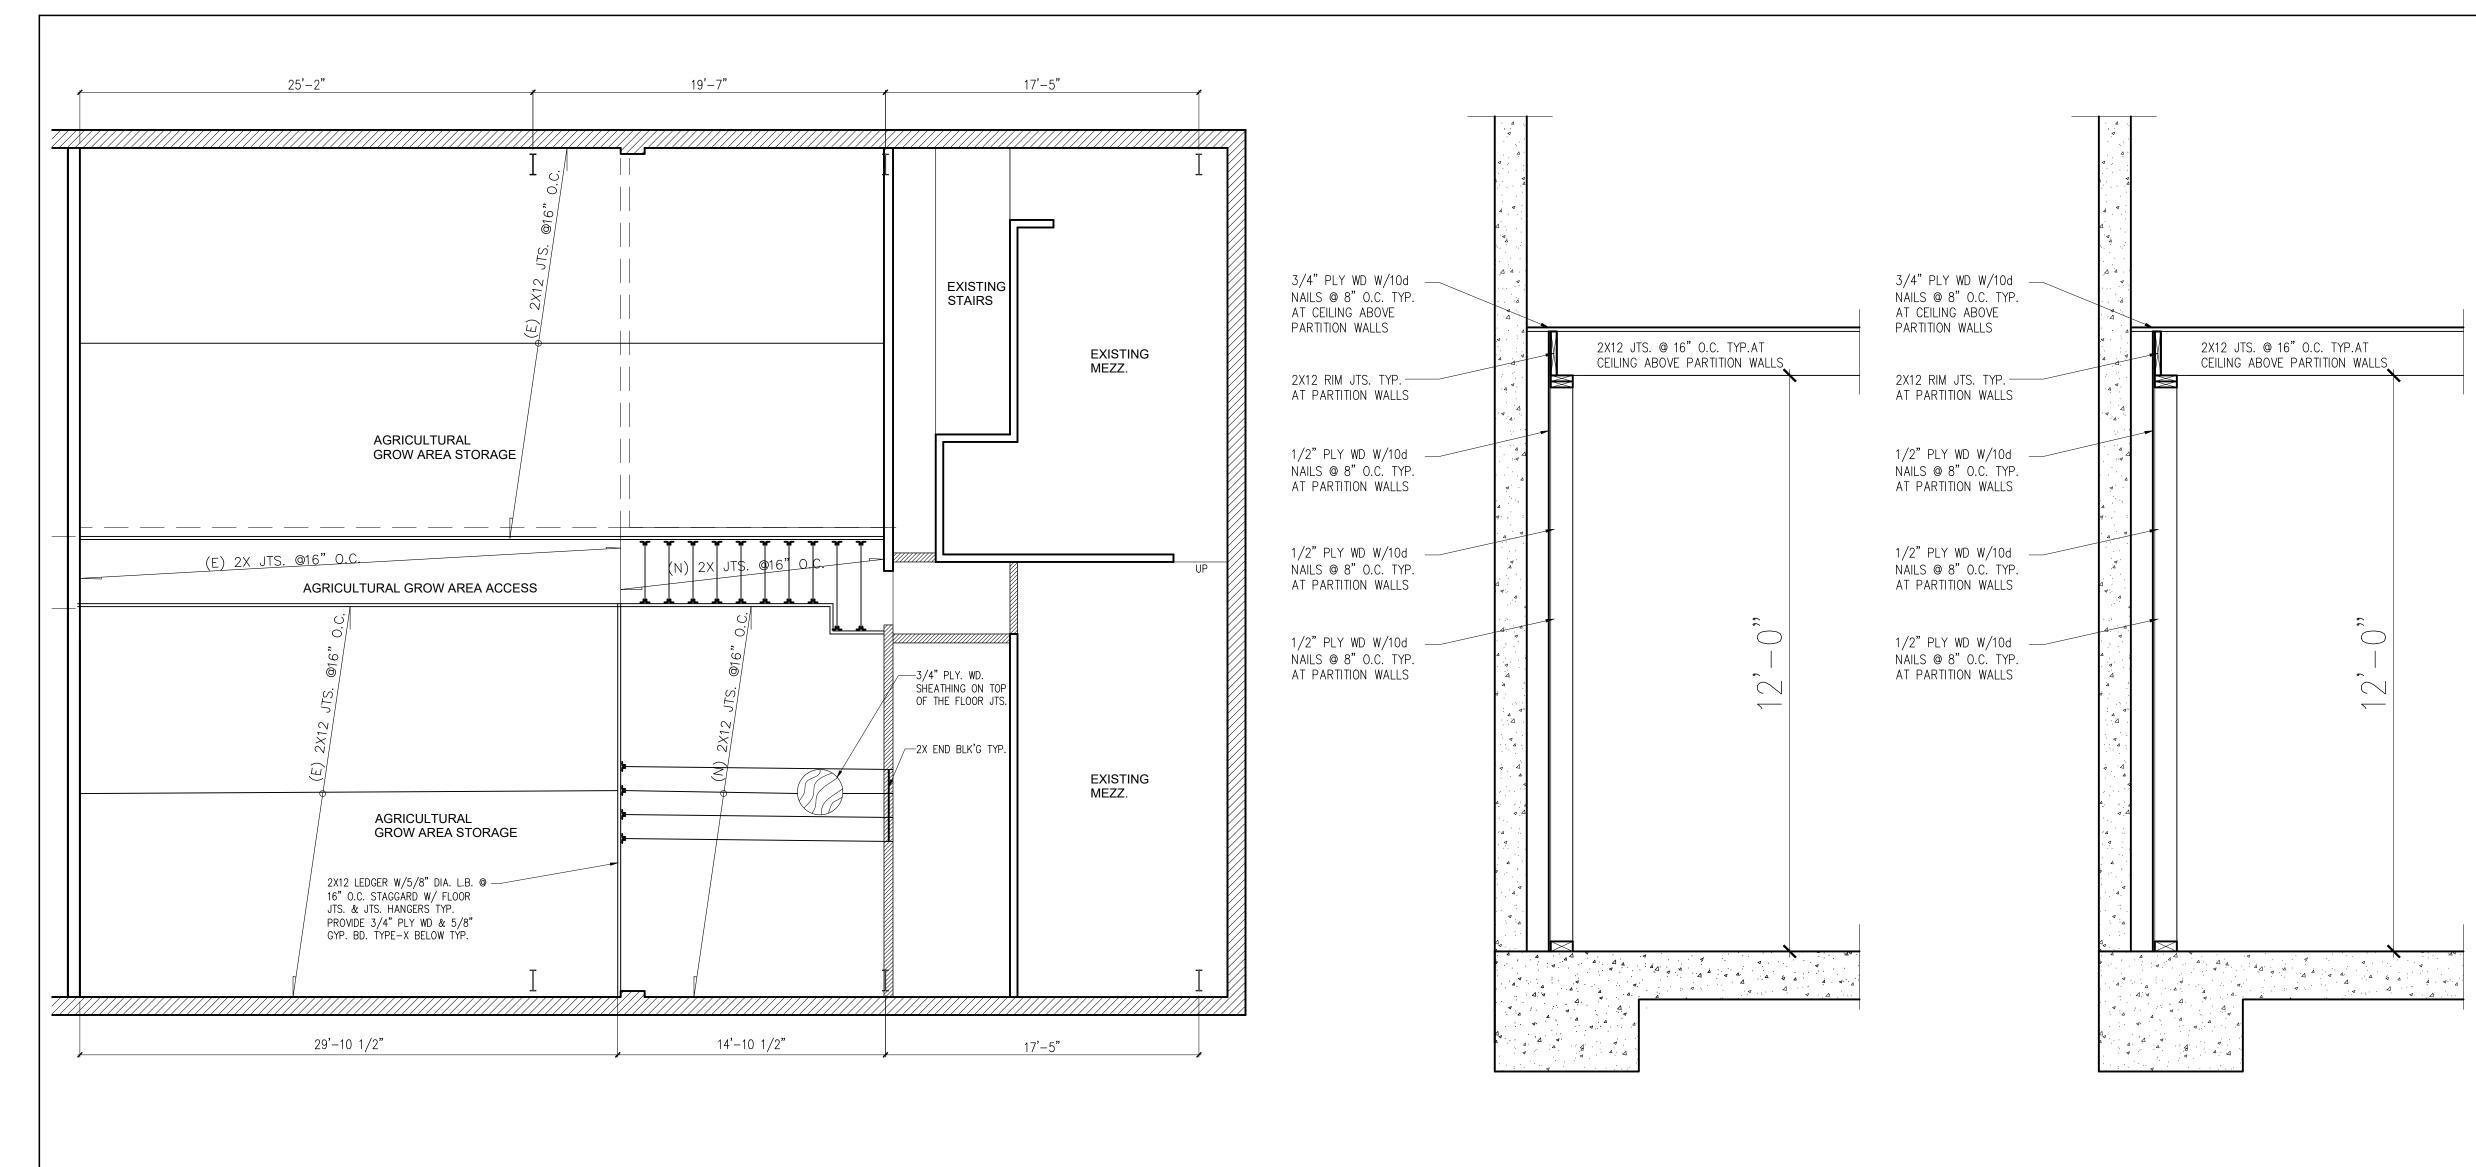

STRUCTURAL NOTES

NOTES & SPECIFICATIONS

1) CONCRETE

a. SELECTION OF MATERIALS, MIXING AND PLACING OF CONCRETE SHALL BE IN ACCORDANCE WITH THE LOCAL BUILDING CODE AND ACI REQUIREMENTS.

b. CONCRETE STRENGTH. CONCRETE SHALL BE NORMAL WEIGHT READY MIX CONCRETE AND SHALL DEVELOP THE COMPRESSIVE STRENGHTS LISTED BELOW, UNLESS OTHERWISE NOTED IN SPECIAL INSPECTION CHECKLIST:

FOOTINGS: 2,500 PSI 4" SLUMP 3/4" AGGREGATE 3,000 PSI 4" SLUMP 3/4" AGGREGATE WALLS: SLAB ON GRADE: 2,500 PSI 4" SLUMP 3/4" AGGREGATE

NOTE: 3/8" PEA GRAVEL MAY BE SUBSTITUTED FOR 3/4" AGGREGATE WHERE NEEDED FOR PUMPING.

c. MINIMUM CONCRETE COVER FOR REINFORCING STEEL: SURFACE POURED AGAINST GROUND: 3"

FRAMED SURFACES BELOW GRADE: 2" SURFACES EXPOSED TO WEATHER: 2"

CONCRETE BEAM BARS: 1-1/2" ALL OTHERS: 1"

d. REINFORCING STEEL. USE ASTM A615, GRADE 40 FOR #4 BARS AND SMALLER, GRADE 60 FOR #5 BARS AND LARGER. TACK WELDING HEATING OR CUTTING OF BARS IS NOT PERMITTED. STAGGER ALL SPLICES A MINIMUM OF 5 FEET.

e. ANCHOR BOLTS SHALL CONFORM TO ASTM-A36 FOR HOOKED ANCHOR BOLTS. HEADED ANCHOR BOLTS SHALL CONFORM TO ASTM A-307.

f. CONSTRUCTION JOINTS SHALL BE PREPARED BY WIRE BRUSHING AND CLEANING PREVIOUS POUR. PROVIDE 1/4 INCH AMPLITUDE MINIMUM OR KEYED JOINTS, ADD A PASTE OF CEMENT MORTAR IMMEDIATELY PRIOR TO POURING . ALL EXISTING CONCRETE SURFACES WHICH ARE TO RECEIVE NEW CONCRETE SHALL BE ROUGHENED AND WASHED CLEAN OF DUST PRIOR TO CONCRETE PLACEMENT. WAIT 48 HOURS BETWEEN POURS.

g. ALL CONCRETE SHALL BE CONSOLIDATED WITH MECHANICAL VIBRATORS TO ASSURE THE ABSENCE OF VOIDS IN STRUCTURAL ELEMENTS.

h. SLABS ON GRADE SHALL BE A MINIMUM OF 5 INCHES THICK WITH #4 BARS AT 12 INCHES ON CENTER AT MID HEIGHT UNLESS OTHERWISE NOTED ON THE PLANS. PROVIDE 2 INCHES OF SAND BELOW SLAB WITH PLASTIC VAPOR BARRIER OVER 6 INCHES OF CLASS B CRUSHED ROCK COMPACTED TO 95% RELATIVE COMPACTION.

i. EPOXY TO BE SIMPSON SET EPOXY BASED ANCHORING ADHESIVE. FOLLOW MANUFACTURER'S INSTALLATION DIRECTIONS. ALL HOLES TO BE BRUSHED CLEAN AND BLOWN OUT PRIOR TO EPOXY INSTALLATION.

j. LAP LENGTHS. ALL REINFORCING BARS #6 AND SMALLER TO BE LAPPED 44 TIMES THE DIAMETER OF THE BAR. ALL BARS #7 AND LARGER TO BE LAPPED 55 TIMES THE DIAMETER OF THE BAR.

a. FRAMING LUMBER SHALL BE DOUGLASS FIR LARCH WITH A MAXIMUM MOISTURE CONTENT OF 19% AT TIME OF PLACEMENT. HEADERS, PLATES, JOISTS: NO. 1

POSTS AND BEAMS: NO. 1 STUDS AND BLOCKING: NO. 2

b. SILLS OR LEDGERS IN CONTACT WITH CONCRETE OR MASONRY, AND ANY WOOD EXPOSED TO WEATHER SHALL BE PRESSURE TREATED DOUGLASS FIR OR CALIFORNIA REDWOOD. NEWLY EXPOSED SURFACES RESULTING FROM FIELD CUTTING, BORING OR HANDLING SHALL BE FIELD TREATED. ALL NAILS AND BOLTS INTO PRESSURE TREATED FRAMING TO BE HOT-DIPPED GALVANIZED. ALL HARDWARE AND HANGERS IN CONTACT WITH PRESSURE TREATED FRAMING TO BE TRIPLE ZINC COATED OR GALVANIZED.

c. PLYWOOD SHEATHING

ROOF SHEATHING 5/8" CD EXTERIOR APA RATED 32/16, PS1 FLOOR SHEATHING: 3/4" CD EXTERIOR APA RATED 48/24, PS1 WALL SHEATHING: 1/2" EXTERIOR APA RATED PS1

EXISTING AS APPROVED & PROPOSED FRAMING PLAN


SCALE: 3/16"=1'-0"

EXISTING AS APPROVED SECTION DETAIL

SCALE: 1/2"=1'-0"

PROPOSED SECTION DETAIL

SCALE:1/2"=1'-0"

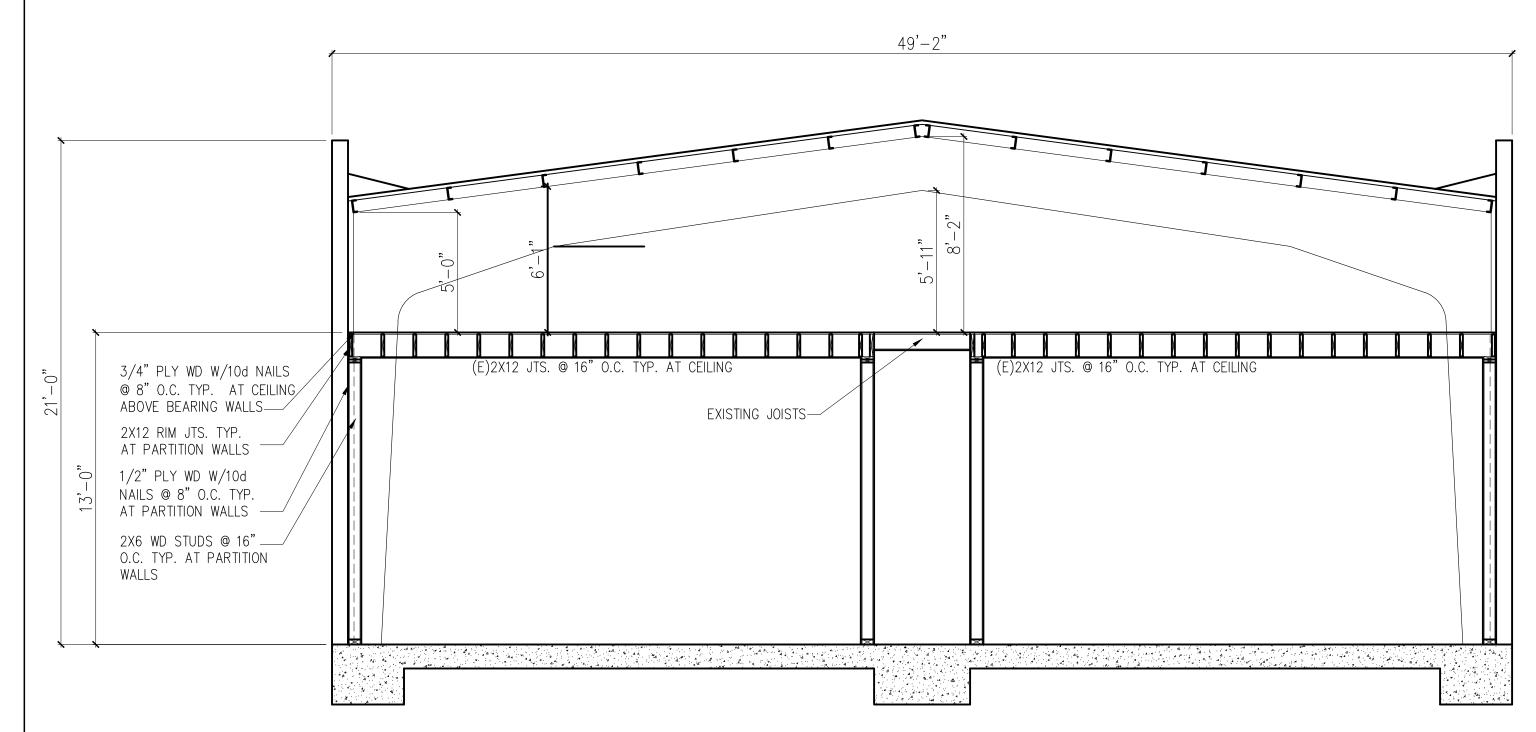

EXISTING AS APPROVED & PROPOSED SECTION

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STRUCTURAL FRAMING AND SECTION DETAIL

S-1